MEMO

Disclaimer for Review of Plans

The San Francisco Planning Code requires that the plans of certain proposed projects be provided to members of the public prior to the City's approval action on the project. Accordingly, any images of plans featured on this website are provided for the primary purpose of facilitating public input prior to the City's action. The City and County of San Francisco does not own the copyright to these images. Please be aware that the unauthorized reproduction, distribution, or alteration of these images may result in a violation of Federal Copyright Law (17 U.S.C.A. Sections 101 et seq.) and that any party who seeks to reproduce or alter these images does so at his or her own risk.

Additionally, plans provided on this website are limited to site plans, elevations and/or section details (floor plans and structural details may not be included). These are DRAFT PLANS being provided for public review PRIOR to the City's approval action on the project. Final plans may differ from those that are currently available for review.

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DADVAND/GHADAKSAZ RESIDENCE ACCESSORY STRUCTURE

PROIECT DATA:

591 CLIPPER STREET, SAN FRANCISCO, CA 94114 - BLOCK 6556 / LOT 019A

DRAWING INDEX:

02 A0.01 SITE PHOTOGRAPHS

01 A0.00 PROJECT TITLE SHEET & DATA

03 A0.02 SITE PLANS - EXISTING & PROPOSED

04 A1.01 BASEMENT & IST FLOOR PLANS - EXISTING (NO WORK) 05 AL 02 ACCESSORY STRUCTURE FLOOR PLAN - EXISTING/DEMO & PROPOSED 06 A3.01 EXTERIOR ELEAVTIONS - FRONT & REAR - EXISTING/DEMO & PROPOSED IAMES BARKER DESIGN

+1 (415) 420 9437

Sahar Dadvand & Kamra

Residency Y Structure

Ory Franc **SS**(San Acce. Street, S

BLOCK / LOT:

Ghadaksaz Clipper advand/

05 14 2019

Project Title Sheet & Data

SHEET NO.

A0.00

GENERAL NOTES: AIA DOCUMENT 201, "GENERAL CONDITIONS FOR THE PERFORMANCE OF A CONTRACT", ARE HEREBY INCORPORATED INTO THESE DRAWINGS AND SHALL BE CONSIDERED AS PART OF THE REQUIREMENTS FOR THE COMPLETION OF WORK. SUPPLEMENTARY CONDITIONS TO THE CONTRACT ALSO APPLY.

ABBREVIATIONS:

FINISHED FLOOR FINISHED FLOOR ELEV

FINISH FACE OF CONCRETE

ON CENTER

RADIUS RETURN AIR

SINGLE POLE SQUARE STAINLESS STEEL

THICK TOP OF PLATE

TOWEL RACK

VERTICAL VERIFY IN FIELD

WATER CLOSET

TOP OF WALL TOILET PAPER HOLDER

VARIES VERIFY DURING CONSTRUCTION

SEE STRUCTURAL DRAWINGS

- THE GENERAL CONTRACTOR IS RESPONSIBLE FOR CHECKING CONTRACT DOCUMENTS FIELD CONDITIONS, AND DIMENSIONS FOR ACCURACY AND CONFIRMING THE WORK CAN BE BUILT OR DEMOLISHED AS SHOWN BEFORE PROCEEDING WITH THE WORK. IF THERE ARE ANY QUESTIONS REGARDING THESE OR OTHER COORDINATION QUESTIONS
- ANY ERRORS OMISSIONS OR CONFLICTS FOUND IN THE VARIOUS PARTS OF TH ARCHITECT, BEFORE PROCEEDING WITH THE WORK.
- CONTRACTOR SHALL THOROUGHLY EXAMINE THE PREMISES AND SHALL BASE HIS BID ON THE EXISTING CONDITIONS, NOTWITHSTANDING ANY INFORMATION SHOWN OR NOT SHOWN ON THE DRAWINGS.
- SUBSTITUTIONS, REVISIONS, OR CHANGES MUST HAVE PRIOR APPROVAL OF THE
- DURING THE BIDDING AND NEGOTI INTO PERIOD IT BE GENERAL CURIN RAC LOR AND SUBCONTRACTOR(S) SHALL CONFIRM IN WRITING APPROX ON-SITE DELIVERY DATES FOR ALL CONSTRUCTION MATERIALS AS REQUIRED BY THE CONSTRUCTION DOCUMENTS AND SHALL NOTIFY THE ARCHITECT IN WRITING OF ANY POSSIBLE CONSTRUCTION DELAYS AFFECTING OCCUPANCY THAT MAY ARISE DUE TO THE AVAILABILITY OF THE
- CONTRACTOR SHALL TAKE MEASURES TO PROTECT ADJACENT PROPERTIES. USE VISQUEEN, PLYWOOD, ETC. TO MINIMIZE NOISE, DUST, ETC.
- IN THE EVENT THAT FOUNDATION EXCAVATION MIGHT AFFECT ADIACENT PRO THE CONDITION, AND TO ADEQUATELY PROTECT THE ADJACENT STRUCTURE
- DIMENSIONS ARE TO TOP OF FIN FLOOR, SLAB OR DECK IN SECTION OR ELEVATION, UNLESS OTHERWISE NOTED
- "SIM." OR "SIMILAR" MEANS COMPARABLE CHARACTERISTICS FOR THE ITEM NOTED. VERIFY DIMENSIONS AND ORIENTATION ON PLAN.
- DIMENSIONS NOTED "CLR" OR "CLEAR" ARE MINIMUM REQUIRED DIMENSIONS AND CLEARANCES MUST BE ACCURATELY MAINTAINED.
- CONTRACTOR TO VERIFY DIMENSIONS AND CONDITIONS IN FIELD. IF CONDITIONS ARE SIGNIFICANTLY DIFFERENT THAN REPRESENTED IN DRAWINGS, VERIFY CONDITIONS WITH ARCHITECT.
- ALL MATERIALS AND EQUIPMENT TO BE NEW UNLESS OTHERWISE NOTED.
- ALL MATERIALS AND EQUIPMENT TO BE INSTALLED PER MANUFACTURER'S INSTRUCTIONS.
- WHERE LOCATIONS OF WINDOWS AND DOORS ARE NOT DIMENSIONED THEY SHA CENTERED IN THE WALL OR PLACED TWO STUD WIDTHS FROM ADJACENT WALL AS INDICATED ON DRAWINGS, UNLESS OTHERWISE NOTED.
- SEALANT CALLKING FLASHING ETC LOCATIONS SHOWN ON DRAWINGS ARE INTENDED TO BE INCLUSIVE. FOLLOW MANUFACTURER'S INSTALLATION RECOMMENDATIONS AND STANDARD INDUSTRY AND BUILDING PRACTICES.
- ALL ATTICS, RAFTER SPACES, SOFFITS, CRAWL SPACES, ETC. TO BE FULLY VENTILATED PER APPLICABLE CODE.
- PROVIDE WOOD BLOCKING FOR ALL TOWEL BARS, ACCESSORIES, ETC.
- MEET ALL CALIFORNIA ENERGY CONSERVATION REQUIREMENTS INCLUDING BUT NOT IMITED TO

 A MINIMUM ROOF/CELLING INSULATION R-19
 B MINIMUM WALL INSULATION IN FRAMED EXTERIOR WALLS R-13.
 C MINIMUM HOOF INSULATION OVER CRAWL OR UNOCCUPIED SPACES R-13
 D ALL INSULATION TO MEET CEC QUALITY STANDARDS.
 E INFILITATION CONTROL

 I DOORS AND WINDOWS WEATHER-STRIPPED.

 2 EXHAUST SYSTEMS DAMPENED.


 3 DOORS AND WINDOWS WEATHER-STRIPPED.

 4 DOORS AND WINDOWS WEATHER-STRIPPED AND LABELED.

 4 DOORS AND WINDOWS WEATHER-STRIPPED AND LABELED.

 5 DILCTS CONTRIBUTED AND INSTALLED PART OF THE CONTRIBUTED OF THE CONTRIBUT

 - F. DUCTS CONSTRUCTED AND INSTALLED PER UMC. G ELECTRICAL OUTLET PLATEGASKETS SHALL BE INSTALLED ON ALL RECEPTACLES. ITCHES AND ELECTRICAL BASES ON EXTERIOR WALLS.
- SMOKE ALARMS ARE TO BE INSTALLED IN ALL SLEEPING ROOMS SMOKE ALARMS SHALL BE HARDWIRED TO I TO HOUSE WIRING AND WIRED TOGETHER IN SERIES. MINIMUM ONE ALARM PER STORY. REF PLANS FOR LOCATIONS.
- GENERAL CONTRACTOR IS TO COORDINATE INSTALLATION OF N.I.C. ITEMS WITH OTHER
- LOCATION/SPECIFICATION OF SAFETY GLAZING (TEMPERED GLASS) ARE SOLE RESPONSIBILITY OF CONTRACTOR ALL DOORS W/ GLAZING AND ALL GLAZING OF WINDOWS WITHIN 24" OF EDGE OF ANY DOOR SHALL BE WITH TEMPERED GLASS (UBC SECTION 2460

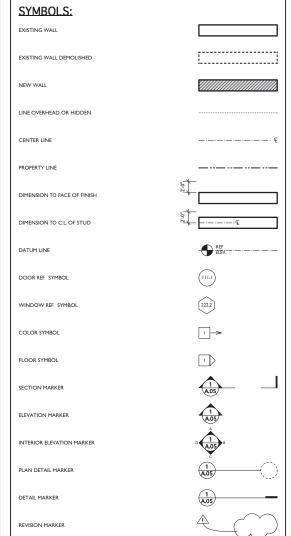

TO LEGALIZE (E) NON-CONFORMING ACCESSORY STRUCTURE IN REAR YARD OF (E) SINGLE ZONING / PRESERVATION / HEIGHT / BULK / AREA SPECIAL USE DISTRICT HEIGHT-BULK: PRESERVATION: B - UNKNOWN, AGE ELIGIBLE NO. OF STORIES MAIN DWELLING: I STORY OVER BASEMENT LOT AREA: 2,736 SO. FT. OCCUPANCY GROUP: OCCUPANCY: GROUP R. DIVISION 3 CONSTRUCTION TYPE (TABLE 5-B) TYPE V-B FLOOR AREA CALCULATIONS: MAIN DWELLING: (E) IST FLOOR 821 SQ.FT. (HABITABLE) (E) TOTAL: 1,668 SQ.FT. ACCESSORY STRUCTURE: (N) IST FLOOR: (N) TOTAL: 142 SQ.FT. NET CHANGE + 15 SQ.FT.

PROIECT PARTICIPANTS: OWNERS: SAHAR DADVAND & KAMRAN GHADAKSAZ PERMIT EXPEDITOR LINDA BEATTIE - B&B CONTRACTOR'S SERVICES 1060 MANZANITA DRIVE PACIFICA, CA 94044 GENERAL CONTRACTOR

DESIGNER/AGENT: IAMES BARKER - IAMES BARKER DESIGN 397 PRENTISS STREET SAN FRANCISCO, CA 94110 STRUCTURAL ENGINEER

ISSUE SCHEDULE: DATE: ISSUE:

VICINITY	MAP:			(T)
ITE: ————————————————————————————————————				
	II.	95 Data 59		
				25th St
		25th St	25th St	60
5th St	25th St MKG Capital 610 CLIS Management Apartm	PPER 92		Damond St
			Clipper St	Clipper St
Clipper St	Clipper St	Clipper St		plamend St.
		Douglass	26th St	2617
		Playground 26th St		Diamon











Dadvand/Ghadaksaz Residence
Accessory Structure
591 Clipper Street, San Francisco, CA 94114

JAMES BARKER JAMES BARKER DESIGN

+1 (415) 420 9437

BLOCK / LOT: 6556 / 019A

 Date
 05.14.2019

 Scale
 nts

 Drawn
 jb

 Issue/Revisions
 By

06.19.2019 Site Permit Submittal


DWG TITLE

Site Photographs

A0.01

SHEET NO.

I SITE PHOTOGRAPHS - EXISTING
Scale: 1/8" = 1'-0"

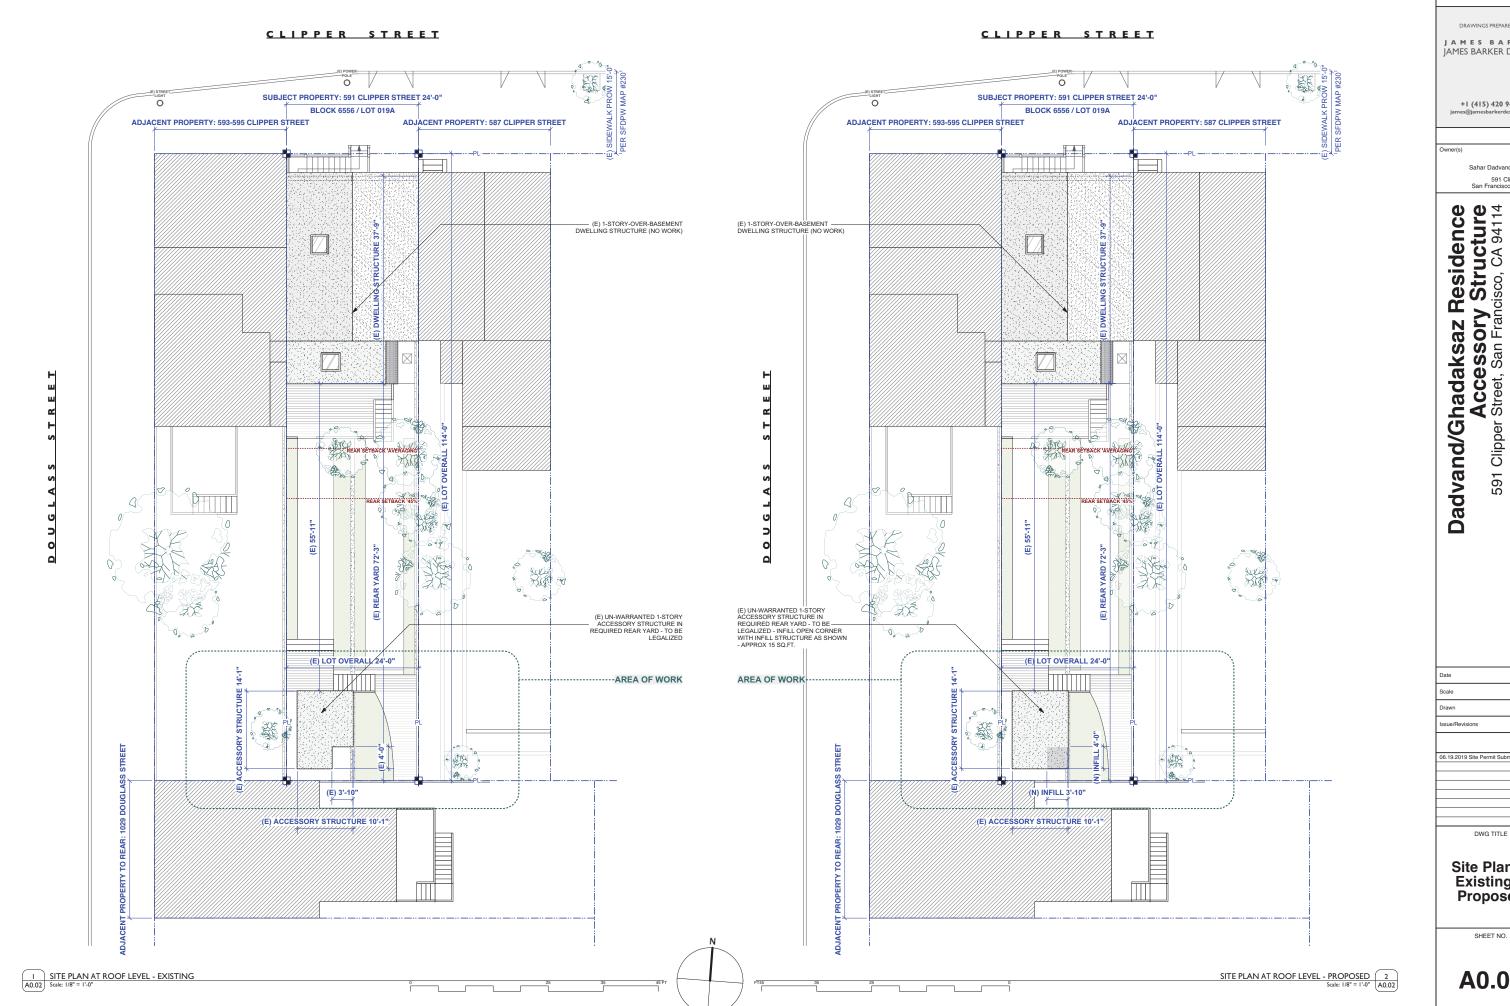

JAMES BARKER DESIGN

+1 (415) 420 9437

Sahar Dadvand & Kamran Ghadaksaz 591 Clipper Street San Francisco, CA 94114

BLOCK / LOT: 6556 / 019A

05 14 2019

1/8" = 1'-0"


06.19.2019 Site Permit Submittal JB

DWG TITLE

Site Plans -Existing & Proposed

SHEET NO.

A0.02

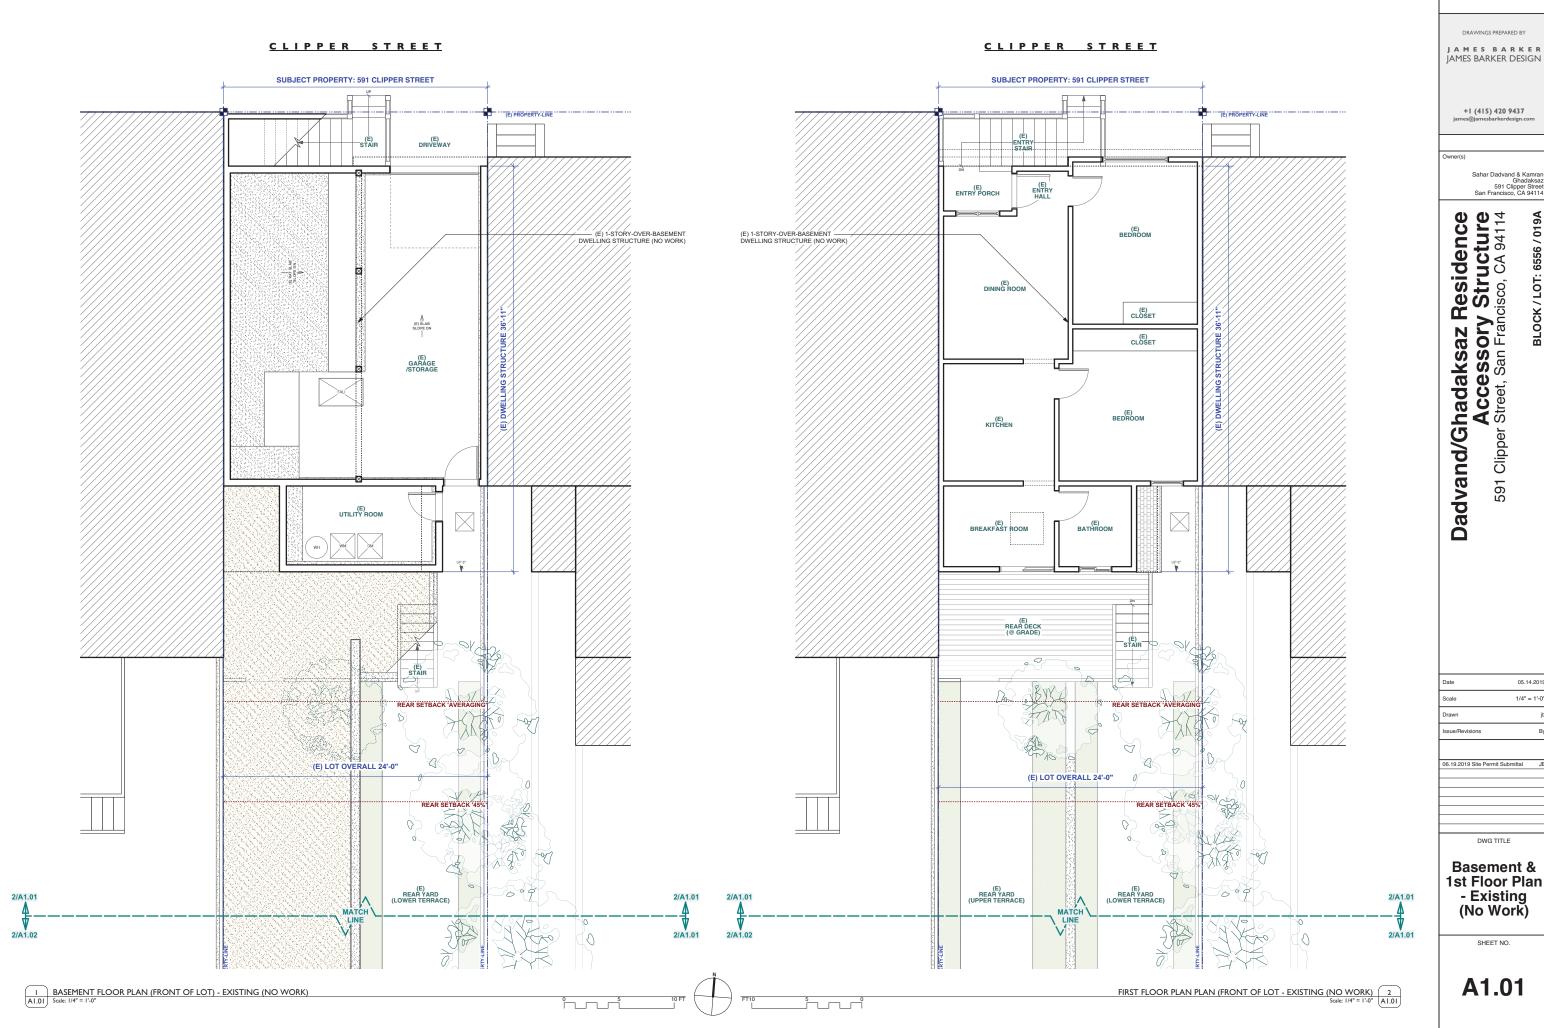

BLOCK / LOT: 6556 / 019A

05.14.2019 1/4" = 1'-0"



