MEMO

Disclaimer for Review of Plans

The San Francisco Planning Code requires that the plans of certain proposed projects be provided to members of the public prior to the City's approval action on the project. Accordingly, any images of plans featured on this website are provided for the primary purpose of facilitating public input prior to the City's action. The City and County of San Francisco does not own the copyright to these images. Please be aware that the unauthorized reproduction, distribution, or alteration of these images may result in a violation of Federal Copyright Law (17 U.S.C.A. Sections 101 et seq.) and that any party who seeks to reproduce or alter these images does so at his or her own risk.

Additionally, plans provided on this website are limited to site plans, elevations and/or section details (floor plans and structural details may not be included). These are DRAFT PLANS being provided for public review PRIOR to the City's approval action on the project. Final plans may differ from those that are currently available for review.

1650 Mission St. Suite 400 San Francisco, CA 94103-2479

Reception: 415.558.6378

Fax: 415.558.6409

Planning Information: 415.558.6377

NOTICE OF PUBLIC HEARING

Hearing Date: Wednesday, March 25, 2020

Time: Not before 9:30 AM

Location: City Hall, 1 Dr. Carlton B. Goodlett Place, Room 408

Case Type: Variance

Hearing Body: Zoning Administrator

PROJECT INFORMATION		APPLICANT INFORMATION		
Project Address: Cross Street(s): Block /Lot No.: Zoning District(s): Area Plan: Record No.:	780 KANSAS ST 20th Street 4074 / 013A RM-1 / 40-X Showplace Square/Potrero 2018-002825VAR	Applicant: Company: Applicant Address: City, State: Telephone: E-Mail:	Andy Rodgers Rodgers Architecture 156 South Park San Francisco, CA (415) 309-9612 ardesign@att.net	

PROJECT DESCRIPTION

The proposal is to construct a vertical and horizontal addition on an existing two-dwelling unit building and to add a garage at the ground floor. The subject lot is irregularly shaped and is approximately 600 square feet smaller that the required minimum lot area of 2,500 square feet. The subject lot measures 25 feet wide and has an average lot depth on approximately 78 feet. The existing building is non-conforming in that it extends into the required rear yard and exceeds the permitted 12 floor projection.

PLANNING CODE SECTION 134 requires the subject property to maintain a rear yard of 36 feet 8 inches. The existing building is located within the required rear yard (to within 30 feet from the rear property line) and the proposed addition would result in additional encroachment (to 29 feet 11 inches to the rear property line). Therefore, a rear yard variance is required.

ADDITIONAL INFORMATION

ARCHITECTURAL PLANS: The site plan and elevations of the proposed project are available on the Planning Department's website at: http://notice.sfplanning.org/2018-002825VAR.pdf

Members of the public are not required to provide personal identifying information when they communicate with the Commission or the Department. All written or oral communications, including submitted personal contact information, may be made available to the public for inspection and copying upon request and may appear on the Department's website or in other public documents.

FOR MORE INFORMATION, PLEASE CONTACT PLANNING DEPARTMENT STAFF:

Planner: Linda Ajello Hoagland Telephone: 415-575-6823 E-Mail: Linda.AjelloHoagland@sfgov.org

GENERAL INFORMATION ABOUT PROCEDURES

HEARING INFORMATION

You are receiving this notice because you are either a property owner or resident that is adjacent to the proposed project or are an interested party on record with the Planning Department. You are not required to take any action. For more information regarding the proposed work, or to express concerns about the project, please contact the Applicant or Planner listed on this notice as soon as possible. Additionally, you may wish to discuss the project with your neighbors and/or neighborhood association, as they may already be aware of the project.

Persons who are unable to attend the public hearing may submit written comments regarding this application to the Planner listed on the front of this notice, Planning Department, 1650 Mission Street, Suite 400, San Francisco, CA 94103, by 5:00 pm the day before the hearing. These comments will be made a part of the official public record and will be brought to the attention of the person or persons conducting the public hearing.

Comments that cannot be delivered by 5:00 pm the day before the hearing may be taken directly to the hearing at the location listed on the front of this notice. Comments received at 1650 Mission Street after the deadline will be placed in the project file, but may not be brought to the attention of the Zoning Administrator at the public hearing.

BUILDING PERMIT APPLICATION INFORMATION

Pursuant to Planning Code Section 311, the Building Permit Application for this proposal may also be subject to notification of property owners and residents within 150-feet of the subject property. On September 16, 2019, the Department issued the required Section 311 notification for this project, which expired on October 16, 2019.

APPEAL INFORMATION

An appeal of the Zoning Administrator's action on a **Variance** may be made to the **Board of Appeals within 10 calendar days** after the Variance Decision Letter is issued by the Zoning Administrator.

An appeal of the approval (or denial) of a **building permit application** by the Planning Commission may be made to the **Board of Appeals within 15 calendar days** after the building permit is issued (or denied) by the Director of the Department of Building Inspection.

Appeals must be submitted in person at the Board's office at 1650 Mission Street, 3rd Floor, Room 304. For further information about appeals to the Board of Appeals, including current fees, contact the Board of Appeals at (415) 575-6880.

CONTRACTOR SHALL BE RESPONSIBLE FOR COORDINATION BETWEEN ARCHITECTURAL, STRUCTURAL, LANDSCALE, CIVIL, MECHANICAL, PLUMBING, ELECTRICAL AND FIRE PROTECTION. THIS INCLUDES REVIEWING RQUIREMENTS OF INDIVIDUAL SYSTEMS BEFORE ORDERING AND INSTALLATION OF ANY WORK. VERIFY ALL ARCHITECTURAL DETAILS AND ALL FINISH CONDITIONS (WHETHER DEPICTED IN DRAWINGS OR NOT)

ANY ERRORS, OMISSIONS, OR CONFLICTS FOUND IN THE VARIOUS PARTS OF THE CONSTRUCTION DOCUMENTS SHALL BE BROUGHT TO THE ATTENTION OF THE ARCHITECT AND THE OWNER BEFORE PROCEEDING WITH THE WORK.

DO NOT SCALE DRAWINGS. WRITTEN DIMENSION GOVERN.

WITH SAME DISCIPLINES.

ALL CLEAR DIMENSIONS ARE NOT TO BE ADJUSTED WITHOUT APPROVAL OF THE ARCHITECT.

WHEN SHOWN IN PLAN, ALL DIMENSIONS ARE TO FACE OF GYPSUM BOARD, CONCRETE, CENTERLINE OF COLUMNS, OR CENTERLINE OF STUD WITHIN WALL ASSEMBLIES, UNLESS OTHERWISE NOTED.

WHEN SHOWN IN SECTION OR ELEVATION, ALL DIMENSIONS ARE TO TOP OF PLATE OR TOP OF CONCRETE UNLESS OTHERWISE NOTED.

DETAILS SHOWN ARE TYPICAL, SIMILAR DETAILS APPLY IN SIMILAR CONDITIONS.

THE CONTRACTOR SHALL BE RESPONSIBLE FOR APPLYING AND OBTAINING ALL REQUIRED INSPECTIONS TO CONFIRM WITH LOCAL BUILDING AND FIRE CODES.

PROVIDE AND INSTALL 2x FLAT WOOD BLOCKING FOR ALL BATH ACCESSORIES, HANDRAILS, CABINETS, TOWEL BARS, WALL MOUNTED FIXTURES AND ANY OTHER ITEMS ATTACHED TO WALLS.

ALL CHANGES IN FLOOR MATERIALS OCCUR AT CENTERLINE OF DOOR OR FRAMED OPENINGS UNLESS OTHERWISE INDICATED ON THE DRAWINGS.

INSTALL ALL FIXTURES, EQUIPMENT, AND MATERIALS PER MANUFACTURER'S RECOMMENDATIONS AND THE REQUIREMENTS OF THE CODES. ALL APPLIANCES, FIXTURES, AND EQUIPMENT ASSOCIATED WITH PLUMBING, ELECTRICAL, AND MECHANICAL SYSTEMS SHALL BE LISTED BY A NATIONALLY RECOGNIZED AND APPROVED AGENCY.

VERIFY CLEARANCES FOR FLUES, VENTS, CHASES, SOFFITS, FIXTURES, FIREPLACES, ETC., BEFORE ANY CONSTRUCTION, ORDERING OF, OR INSTALLATION OF ANY ITEM OF WORK.

PROVIDE FIRE-BLOCKING AND DRAFTSTOPPING AT ALL CONCEALED DRAFT OPENINGS (VERTICAL & HORIZONTAL). AS PER 2013 CBC SECTION 718, FIREBLOCKING & DRAFTSTOPS SHALL BE PROVIDED IN THE FOLLOWING LOCATIONS:

1) IN CONCEALED SPACES OF STUD WALLS AND PARTITIONS, INCLUDING FURRED SPACES, AT THE CEILING AND FLOOR LEVELS AND AT 10-FOOT INTERVALS BOTH VERTICAL AND HORIZONTAL.

2) IN CONCEALED SPACES BETWEEN STAIR STRINGERS AT THE TOP AND BOTTOM OF THE RUN AND BETWEEN STUDS ALONG AND IN LINE WITH THE RUN OF STAIRS IF THE WALLS UNDER THE STAIRS ARE UNFINISHED.

3) IN OPENINGS AROUND VENTS, PIPES, DUCTS, CHIMNEYS, FIREPLACES AND SIMILAR OPENINGS WHICH AFFORD A PASSAGE FOR FIRE AT CEILING AND FOOR LEVELS, WITH NONCOMBUSTIBLE MATERIALS.

WINDOW SIZES ON DRAWINGS ARE NOMINAL DIMENSIONS. REFER TO MANUFACTURER FOR ACTUAL ROUGH OPENING SIZES.

MECHANICAL, PLUMBING, ELECTRICAL, AND OTHER PENETRATIONS OF FLOORS, WALLS AND CEILINGS SHALL BE SEALED AIRTIGHT WITH ACOUSTICAL SEALANT AND FIRESAFING AS REQUIRED.

ALL EXTERIOR DOORS AND WINDOWS ARE TO BE WEATHERSTRIPPED PER TITLE 24 REQUIREMENTS.

ALL WALL, FLOOR, ROOF, AND SHAFT CONSTRUCTION TO BE RATED, U.O.N.

DISCREPANCIES: WHERE A CONFLICT IN REQUIREMENTS OCCURS BETWEEN THE SPECIFICATIONS AND DRAWINGS, OR ON THE DRAWINGS, AND A RESOLUTION IS NOT OBTAINED FROM THE ARCHITECT BEFORE THE BIDDING DTAE, THE MORE STRINGENT ALTERNATE WILL BECOME THE CONTRACTUAL REQUIREMENTS.

CONTRACTOR SHALL ENSURE THAT GUIDELINES SET FORTH ON SHEET AO.1 ARE MAINTAINED DURING CONSTRUCTION, INSTALLATION, AND FINISHING OF ALL ASPECTS OF THIS PROJECT.

PROVIDE SAFETY GLAZING AT ALL HAZARDOUS LOCATIONS, INCLUDING, BUT NOT LIMITED TO GLAZING WITHIN 18" OF A WALKING SURFACE. GLAZING IN DOORS AND WINDOWS ADJACENT TO DOORS IN ACCORDANCE WITH SECTION 2406.4.

ALL TEMPERED GLASS SHALL BE AFFIXED WITH A PERMANENT LABEL PER CBC SECTION 2403

ALL SMOKE DETECTORS TO BE HARD WIRED.

OPENINGS IN 1, 2, OR 3-HOUR RATED ASSEMBLIES SHOULD BE PROTECTED WITH (1), (2), OR (3)-HOUR RATED ASSEMBLIES, RESPECTIVELY.

ALL ASSEMBLIES SHOULD BE APPROVED.

ALL DUCT PENETRATIONS THROUGH RATED WALLS SHOULD BE PROTECTED WITH SMOKE AND FIRE DAMPERS.

ADJACENT PROPERTY SUBJECT PROPERTY ADJ. PROP. 784 KANSAS ST. 780-782 KANSAS ST. 778 KANSAS ST. EAST ELEVATION (FRONT) SCALE: NONE ADJ. PROP. SUBJECT PROPERTY 778 KANSAS ST. 780-782 KANSAS ST.

SITE PHOTOS

ADJACENT PROPERTY

784 KANSAS ST.

HEIGHT

AND AIR CONDITIONING

HVAC.

I.D.

INT.

JAN.

JNT

JST.

KIT.

LAB.

MAX.

MECH.

MEMB.

MFR.

M.H.

MIN.

MISC.

M.O.

MTL.

MUL.

N.I.C

NO.

NOM.

N.T.S.

0.C.

0.D.

OPG.

OPP.

PCT.

P.L.

P.LAM.

PLAS.

PLYWD.

PR.

Q.T.

INSUL.

HEATING, VENTILATION,

INSIDE DIAMETER

INSULATION

INTERIOR

JANITOR

JOINT

JOIST

KITCHEN

LAMINATE

LAVATORY

MAXIMUM

MECHANICAL

MEMBRANE

MANHOLE

MINIMUM

METAL

NORTH

NEW

MULLION

NUMBER

NOMINAL

NOT TO SCALE

OUTSIDE DIAMETER

ON CENTER

OVERHEAD

OPENING

OPPOSITE

PRE-CAST

PLASTER

PLYWOOD

RISFR

QUARRY TILE

PROPERTY LINE

PLASTIC LAMINATE

MANUFACTURER

MISCELLANEOUS

MASONRY OPENING

NOT IN CONTRACT

LIGHT

LABORATORY

WEST ELEVATION (REAR)

SCALE: NONE

ELEV.

EMER.

ENCL.

EQUIP.

E.W.

W.E.C.

EXP.

EXT.

F.A.

F.D.

F.D.C.

FDN.

F.A.

F.A.C.

F.B.

F.H.C.

FLUOR.

FND.

F.O.B.

F.O.C.

F.S.

FT.

FTG.

FURR.

GALV.

G.C.

G.L.

GYP.

GYP. BD.

HDWD.

HDWE.

FIN.

EQ.

ELEVATION

EMERGENCY

ENCLOSURE

EQUIPMENT

EACH WAY

EXPANSION

FIRE ALARM

FLOOR DRAIN

FOUNDATION

FIRE EXTINQUISHER

FIRE HOSE CABINET

FINISH FLOOR

FLOW LINE

FLUORESCENT

FOUNDATION

FULL SIZE

FOOTING

FURRING

GAUGE

GLASS

GRADE

GYPSUM

GYPSUM BOARD

HOLLOW CORE

HANDICAPPED

HOLLOW METAL

HARDWOOD

HARDWARE

HOUR

HOSE BIBB

GALVINIZED

FACE OF BRICK

FOOT OR FEET

FACE OF CONCRETE

GENERAL CONTRACTOR

FI OOR

EXTERIOR

ELECTRIC WATER COOLER

FIRE DEPARTMENT CONNECTION LAM.

FIRE EXTINGUISHER CABINET

EQUAL

ABBREVIATIONS

A.F.F.

AGGR.

APPROX

ARCH.

BLDG.

BLK.

BOT.

B.U.R.

CLG.

CLKG.

C.M.U.

COL.

CONC.

CONSTR.

CONT.

C.T.

DEG.

D.F.

DIAG.

DN.

DWG

E.I.F.S.

ELEC.

NOT LISTED

FINISH SYSTEM

DIA. Ø

DET./DTL

BLK'G.

BD.

ANCHOR BOLT

AGGREGATE

ALUMINUM

ALTERNATE

BOARD

BUILDING

BI OCKING

BLOCK

BEAM

BOTTOM

BFTWFFN

CFILING

COLUMN

CONCRETE

CONNECTION

CONSTRUCTION

CONTINUOUS

CERAMIC TILE

DRINKING FOUNTAIN

DEGREE

DIAGONAL

DIAMETER

DOWNSPOUT

DRAWING

EXISTING

ELEVATION

ELECTRICAL

EXPANSION JOINT

EXTERIOR INSULATION AND

NOTE: CLARIFY WITH ARCHITECT - ALL ABBREVIATIONS

DOWN

DETAIL

CAULKING

BOTH WAYS

CONTROL JOINT

BUILT UP ROOFING

CONCRETE MASONRY UNIT

APPROXIMATE

ARCHITECTURAL

ABOVE FINISHED FLOOR

SUBJECT PROPERTY 780-782 KANSAS ST.





WEST ELEVATION (REAR FACADE)

SCALE: NONE

R.D.

REINF.

REQ'D

RM

R.D.

SCHED.

SECT.

S.F.

SHT.

SIM.

S.S.

STAGG.

STD.

STIFF.

STRUC.

SUSP.

T & B

T & G

TER.

THK.

TYP.

U.O.N.

VCT.

VER.

VERT.

STL.

SPEC.

SQ. OR 中

REMODELED OR RELOCATED

ROOF DRAIN

REFER TO ...

REINFORCED

SOLID CORE

SQUARE FOOT

SPECIFICATION

STAINLESS STEEL

SCHEDULE

SECTION

SHEET

SIMILAR

SQUARE

STAGGERED

STANDARD

STIFFENER

STRUCTURAL

SUSPENDED

TERRAZZO

TOP AND BOTTOM

TONGUE AND GROOVE

UNLESS OTHERWISE NOTED

VINYL COMPOSITION TILE

STEEL

TREAD

THICK

TOP OF

TYPICAL

VERIFY

WEST

WITH

WOOD

WITHOUT

VERTICAL

WATER CLOSET

PROPERTY LINE

CENTERLINE

REQUIRED

ROOM

SOUTH

REFRIGERATOR

ROUGH OPENING

EAST ELEVATION (FRONT FACADE)

SCALE: NONE




SECTION LETTER SHEET NUMBER

SYMBOLS LEGEND

3 DETAIL:
A38 DETAIL NUMBER SHEET NUMBER **ELEVATION:** A ELEVATION LETTER A451 SHEET NUMBER

2)14 DOOR NUMBER WINDOW TYPE SHEET LAYOUT DESIGNATION VIEW NUMBER SHEET NUMBER

NORTH DESIGNATION

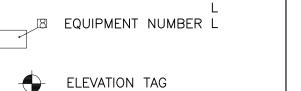

SPOT ELEVATION

PROPERTY LINE

CENTER LINE

SHEET INDEX

AO.1 PROJECT INFO, GEN. NOTES

A1.1 EXISTING/PROPOSED GROUND FLOOR

A1.2 EXISTING/PROPOSED 2ND FLOOR

A1.3 EXISTING/PROPOSED 3RD FLOOR

A1.4 EXISTING/PROPOSED ROOF PLAN

A2.1 EXISTING EAST (FRONT) ELEVATION

A2.5 EXISTING WEST (REAR) ELEVATION

A2.6 PROPOSED WEST (REAR) ELEVATION

A2.3 EXISTING SOUTH ELEVATION

A2.4 PROPOSED SOUTH ELEVATION

A2.7 EXISTING NORTH ELEVATION

A2.8 PROPOSED NORTH ELEVATION

A3.2 PROPOSED BUILDING SECTION

A3.1 EXISTING BUILDING SECTION

A2.2 PROPOSED EAST (FRONT) ELEVATION

ARCHITECTURAL

A1.0 SITE PLAN

PLAN

PLAN

PLAN

FLOORS. VERTICAL ADDITION FOR A FOURTH FLOOR WITH ROOF DECK ABOVE. NO ALTERATION OF FRONT FACADE. PROJECT TO INCLUDE NEW GARAGE, AND GARAGE DOOR, REMODELED

BATHROOM, CLOSET AND LIVING SPACE ON THE FIRST FLOOR. EXPANSION OF FAMILY ROOM, RELOCATION AND EXPANSION OF BATH AND KITCHEN ON SECOND FLOOR. EXPANSION OF MASTER BEDROOM AND BATH ON THIRD FLOOR. ADDITION OF SUNROOM AT NEW FOURTH FLOOR. RECONFIGURATION OF INTERNAL STAIRCASE TO ACCOMMODATE FLOOR PLAN CHANGES.

NEW WINDOWS, DOORS, ELECTRICAL AND PLUMBING WORK AS REQUIRED FOR THE ABOVE SCOPE.

<u>UNIT 1</u>

AREA CALCULATIONS:

	<u>GARAGE</u>			
EXISTING	0 SF	787 SF	2,045 SF	
(FLOOR)	(1ST)	(1ST)	(2ND & 3RD)	
	200 05	011 CF	0.007.00	
PROPOSED	269 SF	811 SF	2,623 SF	
(FLOOR)	(1ST)	(1ST)	(2ND,3RD,4TH)	
CHANGED	+269 SF	+24 SF	+578 SF	
CHANGED	+209 36	±24 3F	+3/0 35	
	<u>COMMON</u>	<u>UNIT 1 OPEN</u>	<u>UNIT 2 OPEN</u>	TOTAL GROSS
	<u>SHARED</u>	<u>PRIVATE</u>	<u>PRIVATE</u>	<u>AREA</u>
EXISTING	0 SF	0 SF	280 SF	3,112 SF
(FLOOR)	(NA)	(NA)	(2ND,3RD)	(ALL)
PROPOSED	0 SF	0 SF	559 SF	4,014 SF
(FLOOR)	(NA)	(NA)	(2ND,3RD,4TH)	(ALL)

REAR YARD: 836 SF

PROJECT LOCATION MAP

PROJECT DIRECTORY

MARK HAMPTON AND GAYLE PIGATTO : markrhampton@gmail.com

GENERAL CONTRACTOR

780 KANSAS ST. SAN FRANCISCO, CA 94107

4074/013A

35'-6"

ZONING: RM-1HEIGHT/BULK DISTRICT 40 - X

PROJECT INFORMATION

CONSTRUCTION TYPE: OCCUPANCY:

EXISTING # OF FLOORS: PROPOSED # OF FLOORS

EXISTING BUILDING HEIGHT

PROJECT ADDRESS:

BLOCK/LOT:

@ RIDGE LINE PROPOSED BUILDING HEIGHT 40'-0"

@ DECK ROOF SURFACE

PROJECT DESCRIPTION:


HORIZONTAL ADDITION TO ALL LEVELS. UTILIZING ALLOWABLE 12' EXTENSION AT FIRST FLOOR, NEW DECK AT SECOND AND FOURTH

	<u>GARAGE</u>			
EXISTING	0 SF	787 SF	2,045 SF	
(FLOOR)	(1ST)	(1ST)	(2ND & 3RD)	
PROPOSED	269 SF	811 SF	2,623 SF	
(FLOOR)	(1ST)	(1ST)	(2ND,3RD,4TH)	
CHANGED	+269 SF	+24 SF	+578 SF	
	COMMON	<u>UNIT 1 OPEN</u>	<u>UNIT 2 OPEN</u>	TOTAL GROSS
	SHARED	<u>PRIVATE</u>	<u>PRIVATE</u>	<u>AREA</u>
EXISTING	0 SF	0 SF	280 SF	3,112 SF
(FLOOR)	(NA)	(NA)	(2ND,3RD)	(ALL)
PROPOSED	0 SF	0 SF	559 SF	4,014 SF
(FLOOR)	(NA)	(NA)	(2ND,3RD,4TH)	(ALL)
-	•	•	,	
CHANGED	NA	NA	+279 SF	<u>+902 SF</u>

PROJECT ARCHITECT RODGERS ARCHITECTURE 156 SOUTH PARK SAN FRANCISCO, CA 94107

P: 415.309.9612 E: ardesign@att.net PROPERTY OWNER


780 KANSAS ST. SAN FRANCISCO, CA 94107

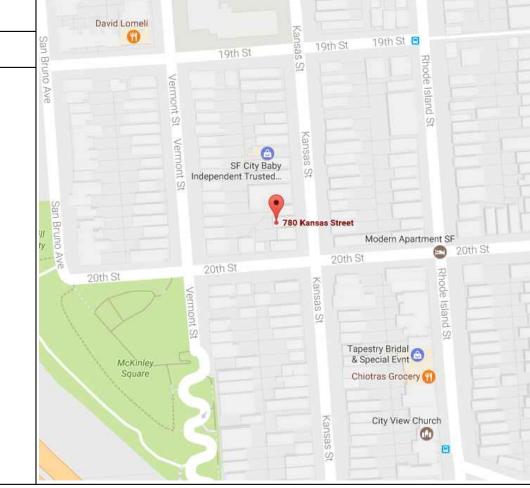

REVISIONS:

cture ger rchite 0 0

415 309 9612

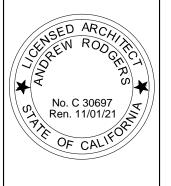

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FOR REVIEW


GENERAL NOTES, PROJECT INFORMATION

DATE 2020-03-04 SCALE NO SCALE

DRAWN SMH/AR

JOB SHEET

A0.1

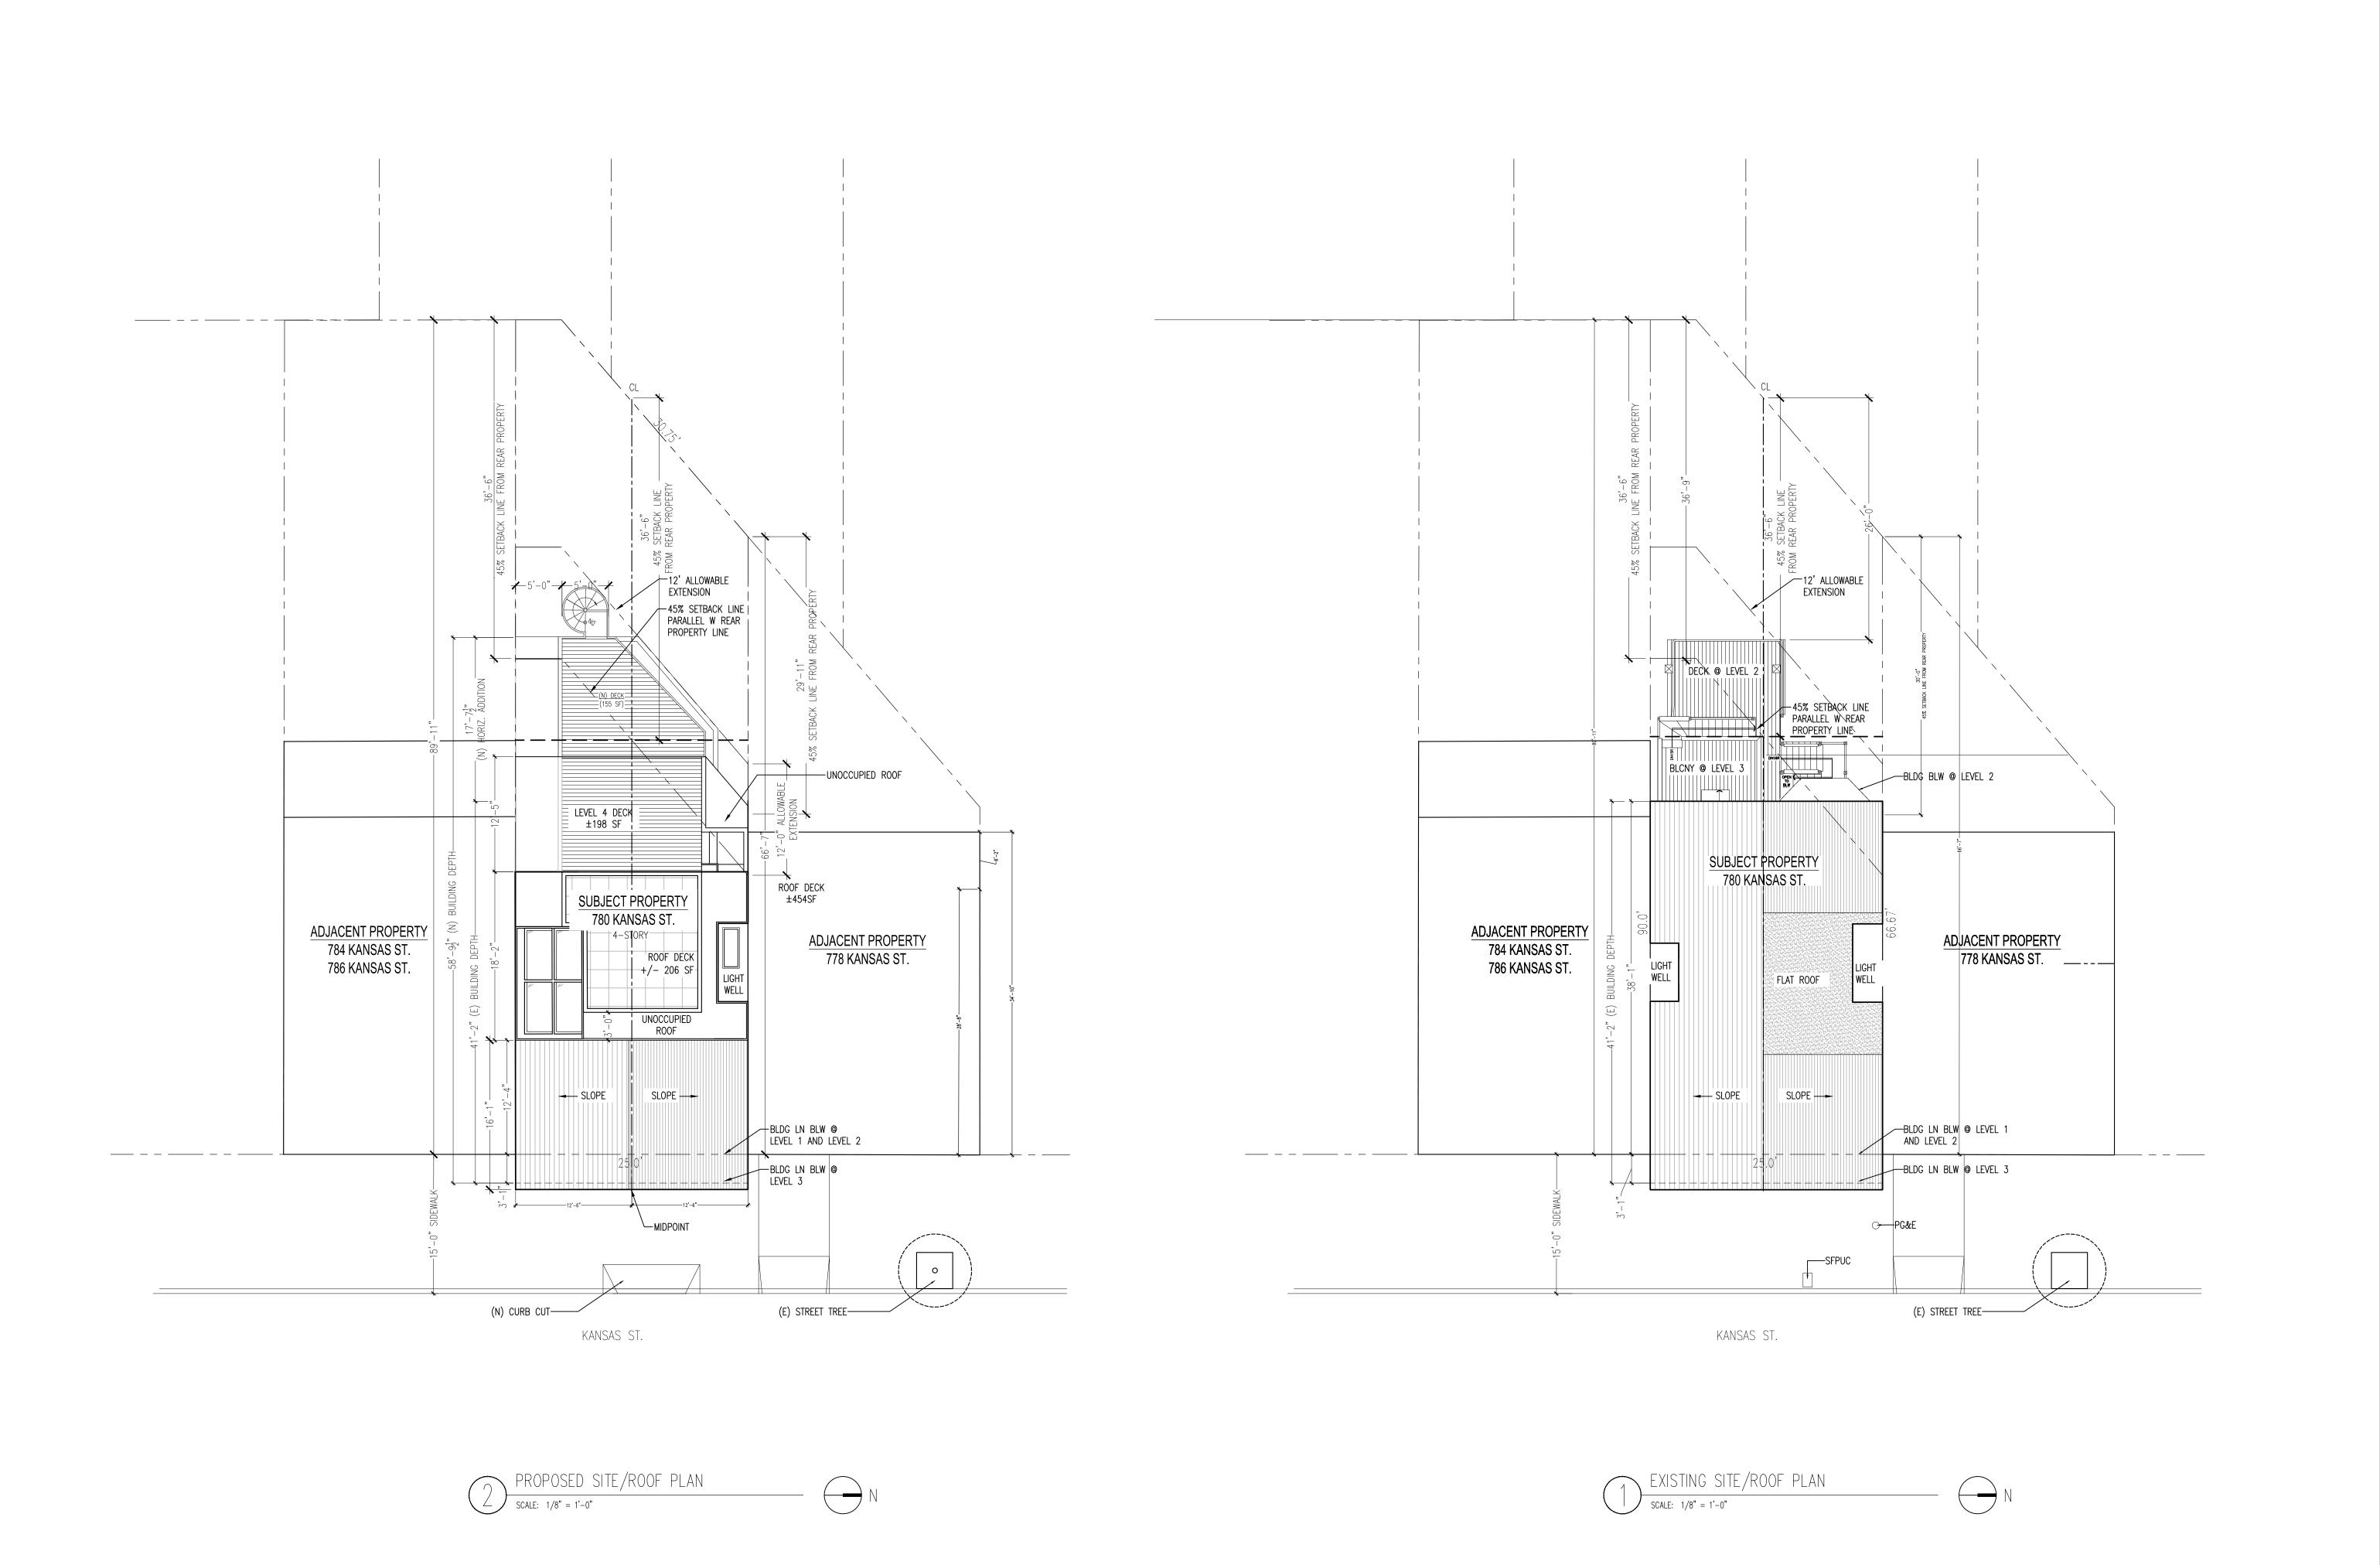

rodgers architecture

415 309 9612



ALTERATIONS TO:

80 KANSAS ST
SAN FRANCISCO, CA, 94107

FOR REVIEW

SITE PLAN


DATE 2020-03-04


SCALE 1/8" = 1'-0"

DRAWN SMH/AR
JOB

SHEET

A1.0

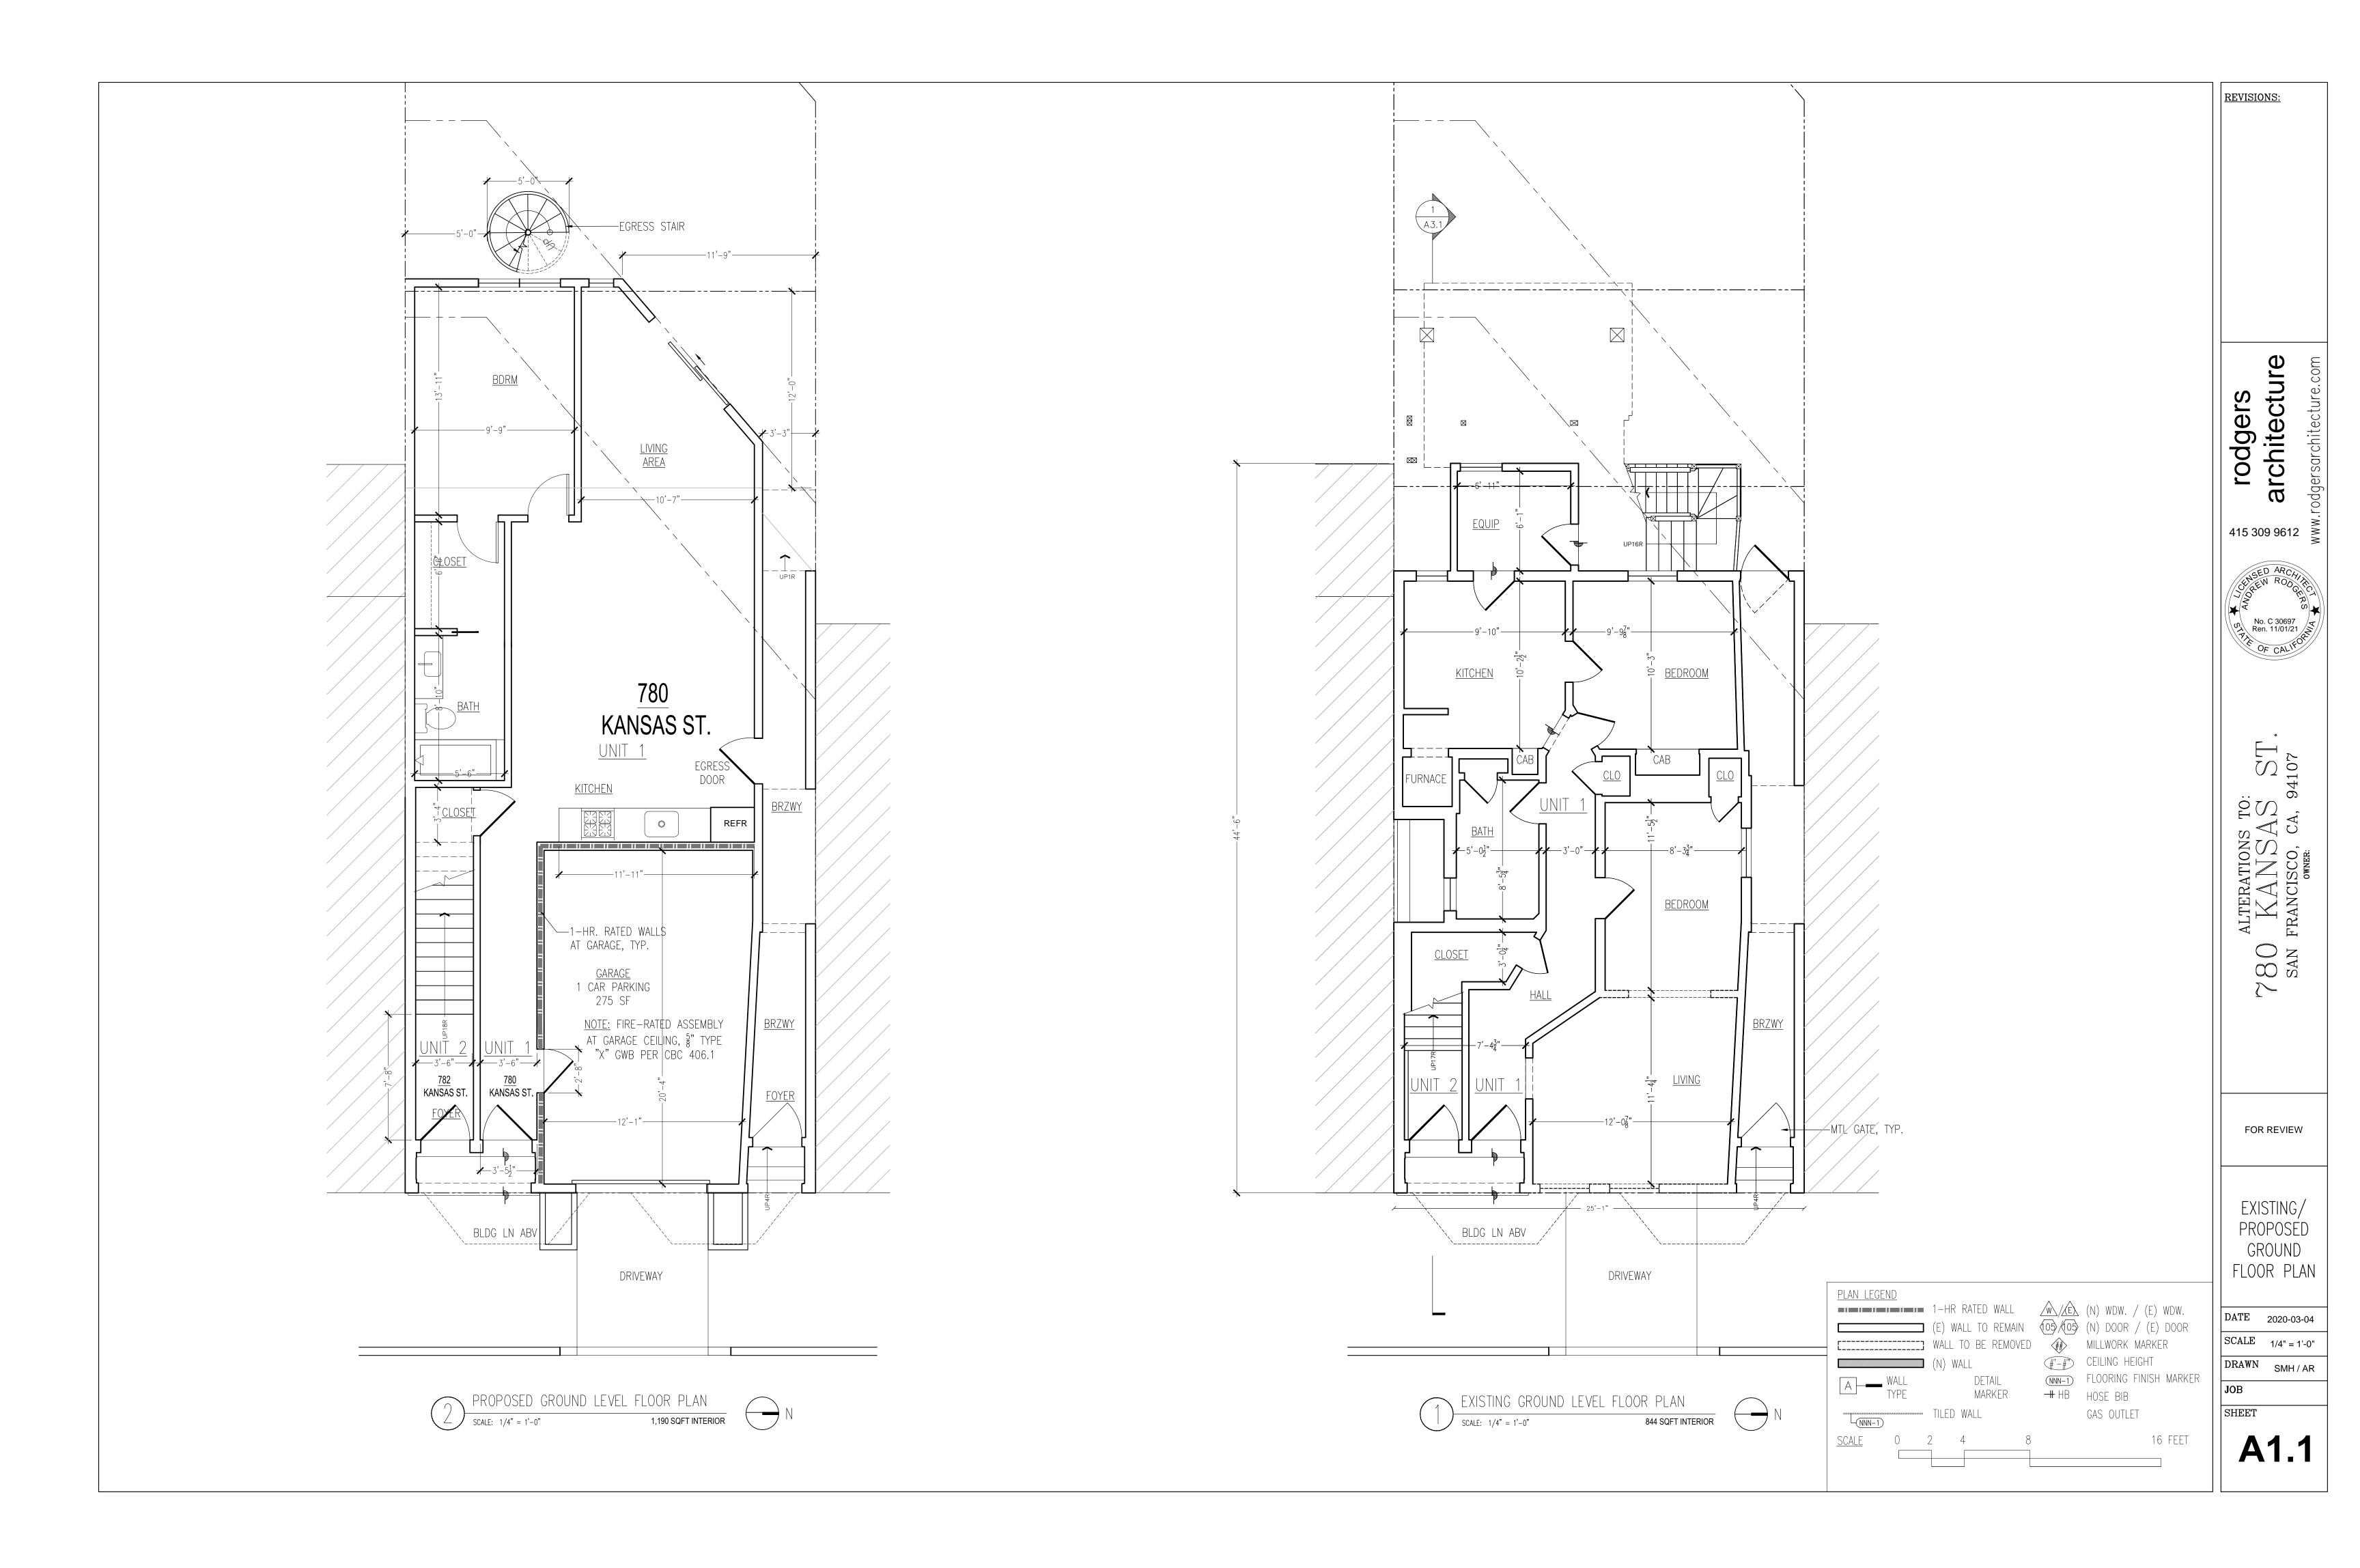

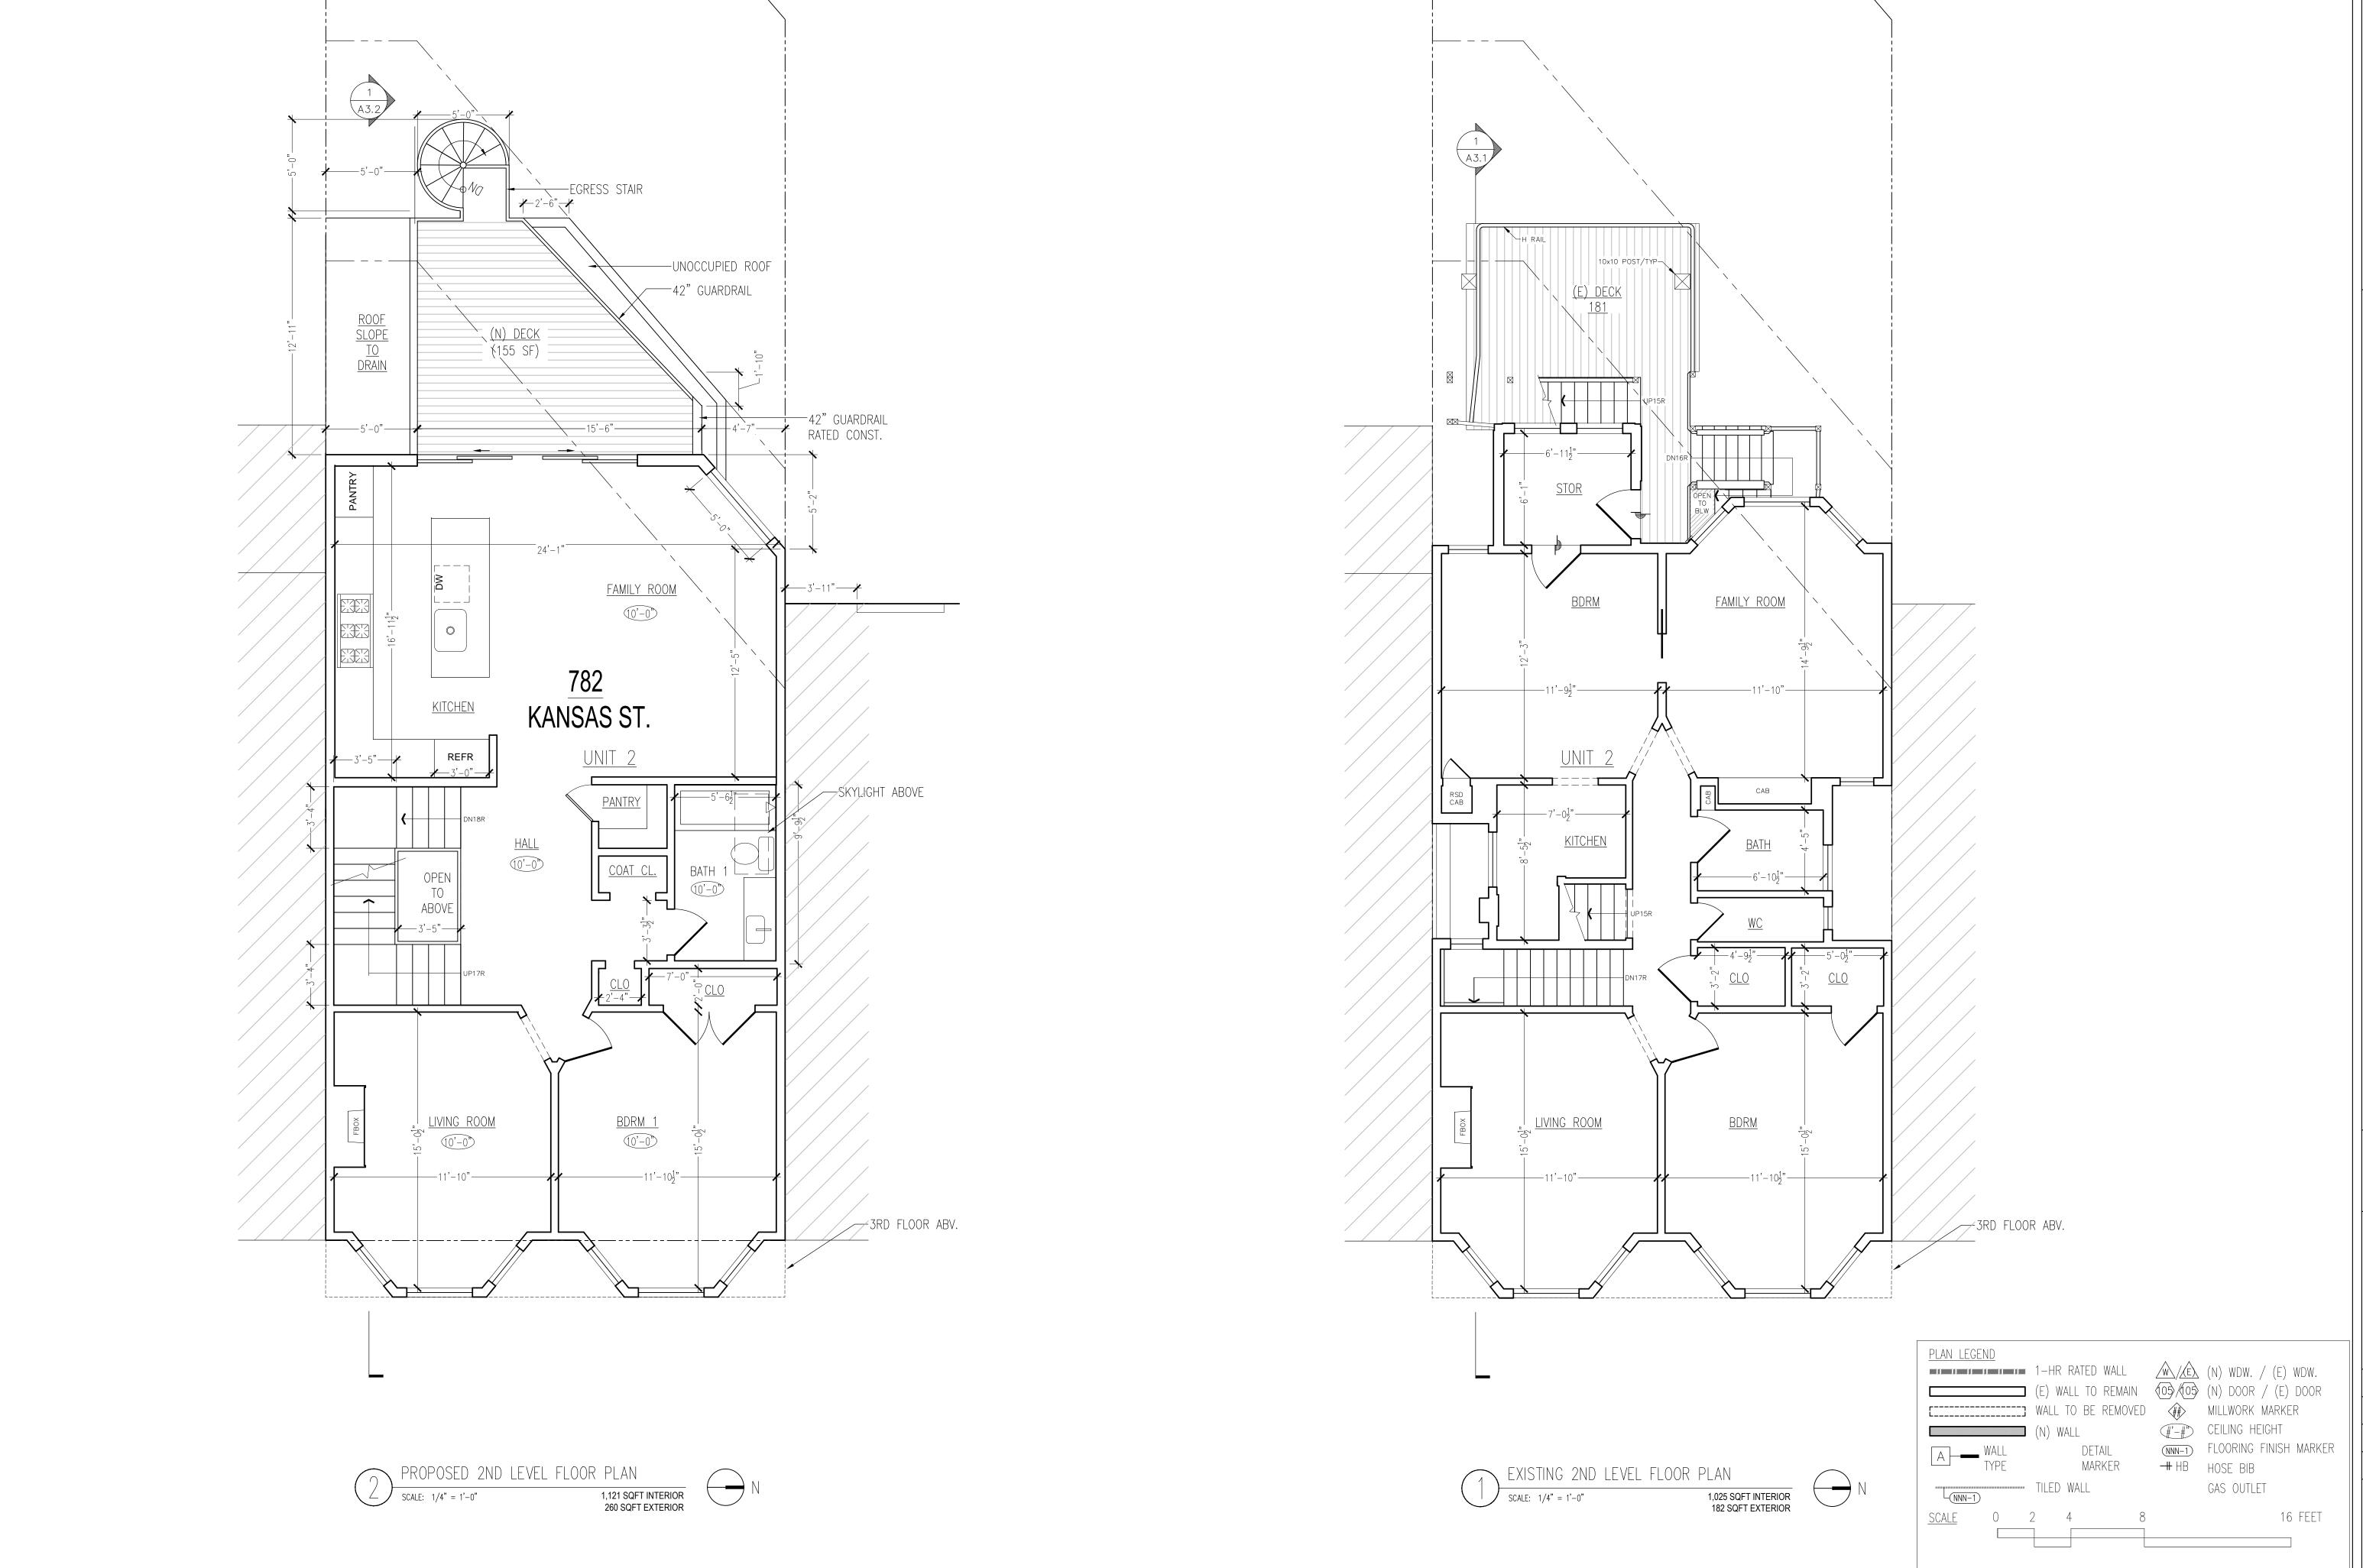

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ALTERATIONS TO:

SO KANSAS ST

SAN FRANCISCO, CA, 94107

FOR REVIEW


EXISTING/ PROPOSED 2ND FLOOR PLAN


DATE 2020-03-04


SCALE 1/4" = 1'-0"

DRAWN SMH
JOB

A1.2

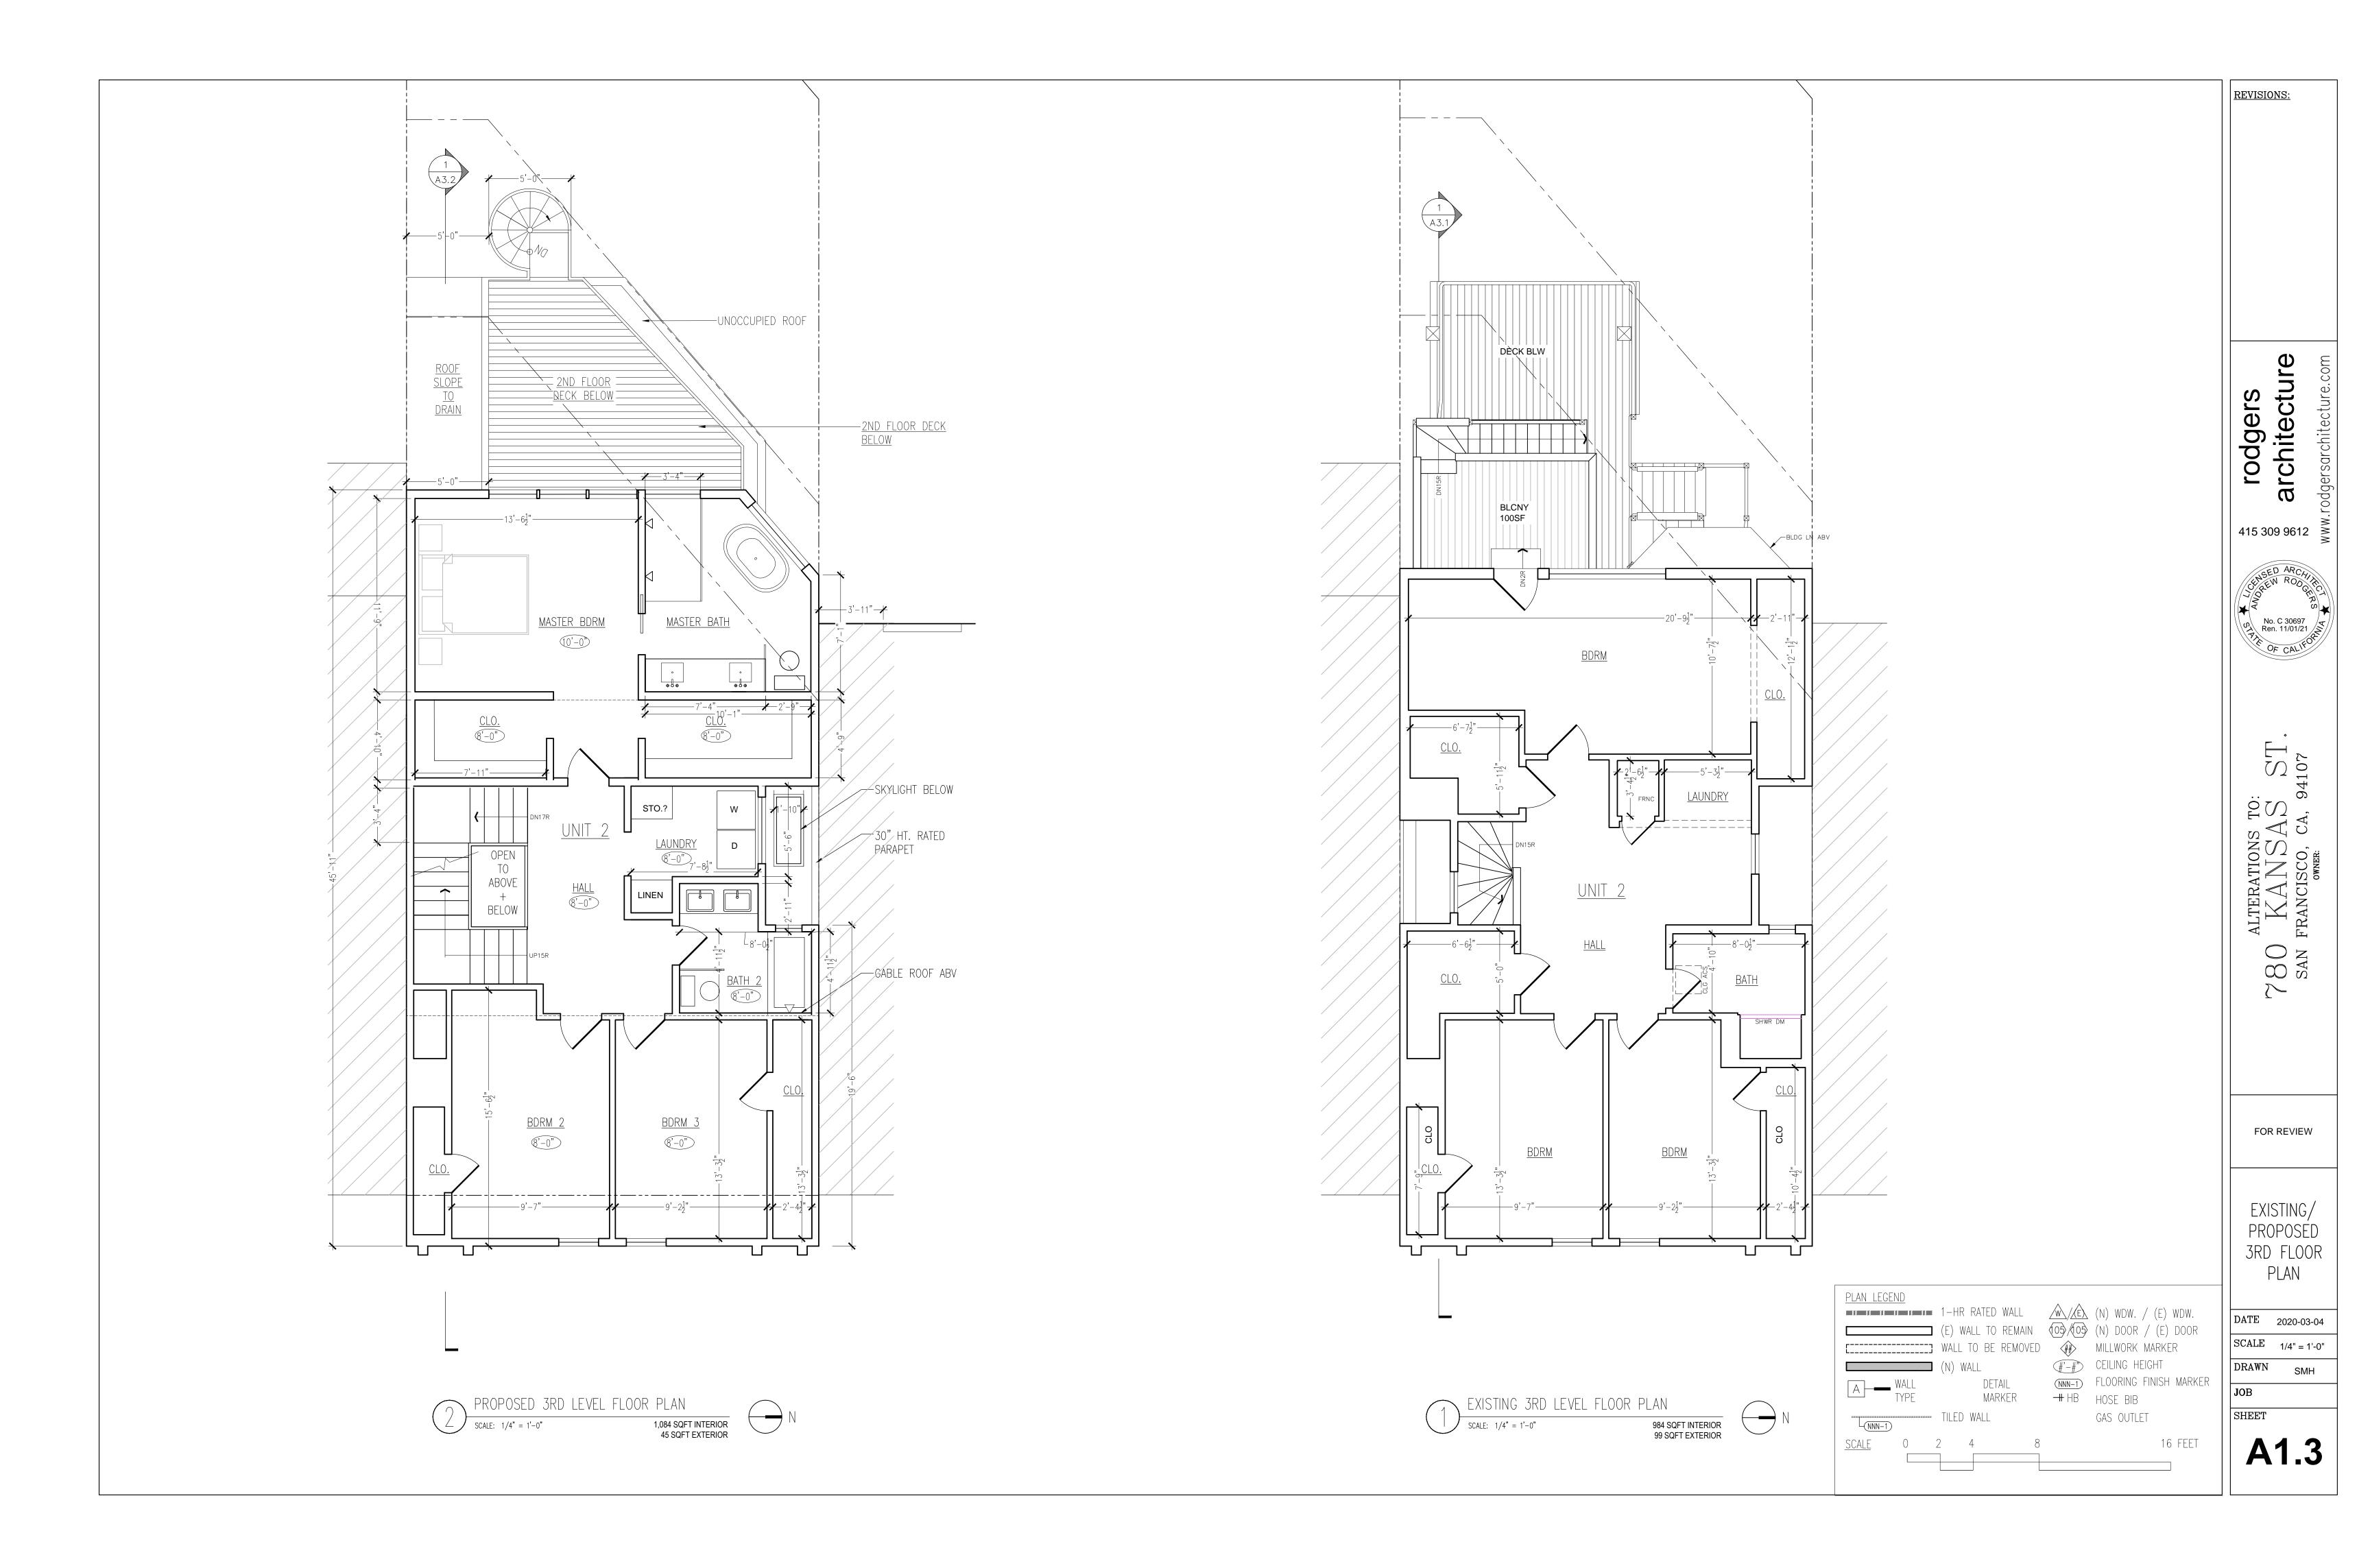

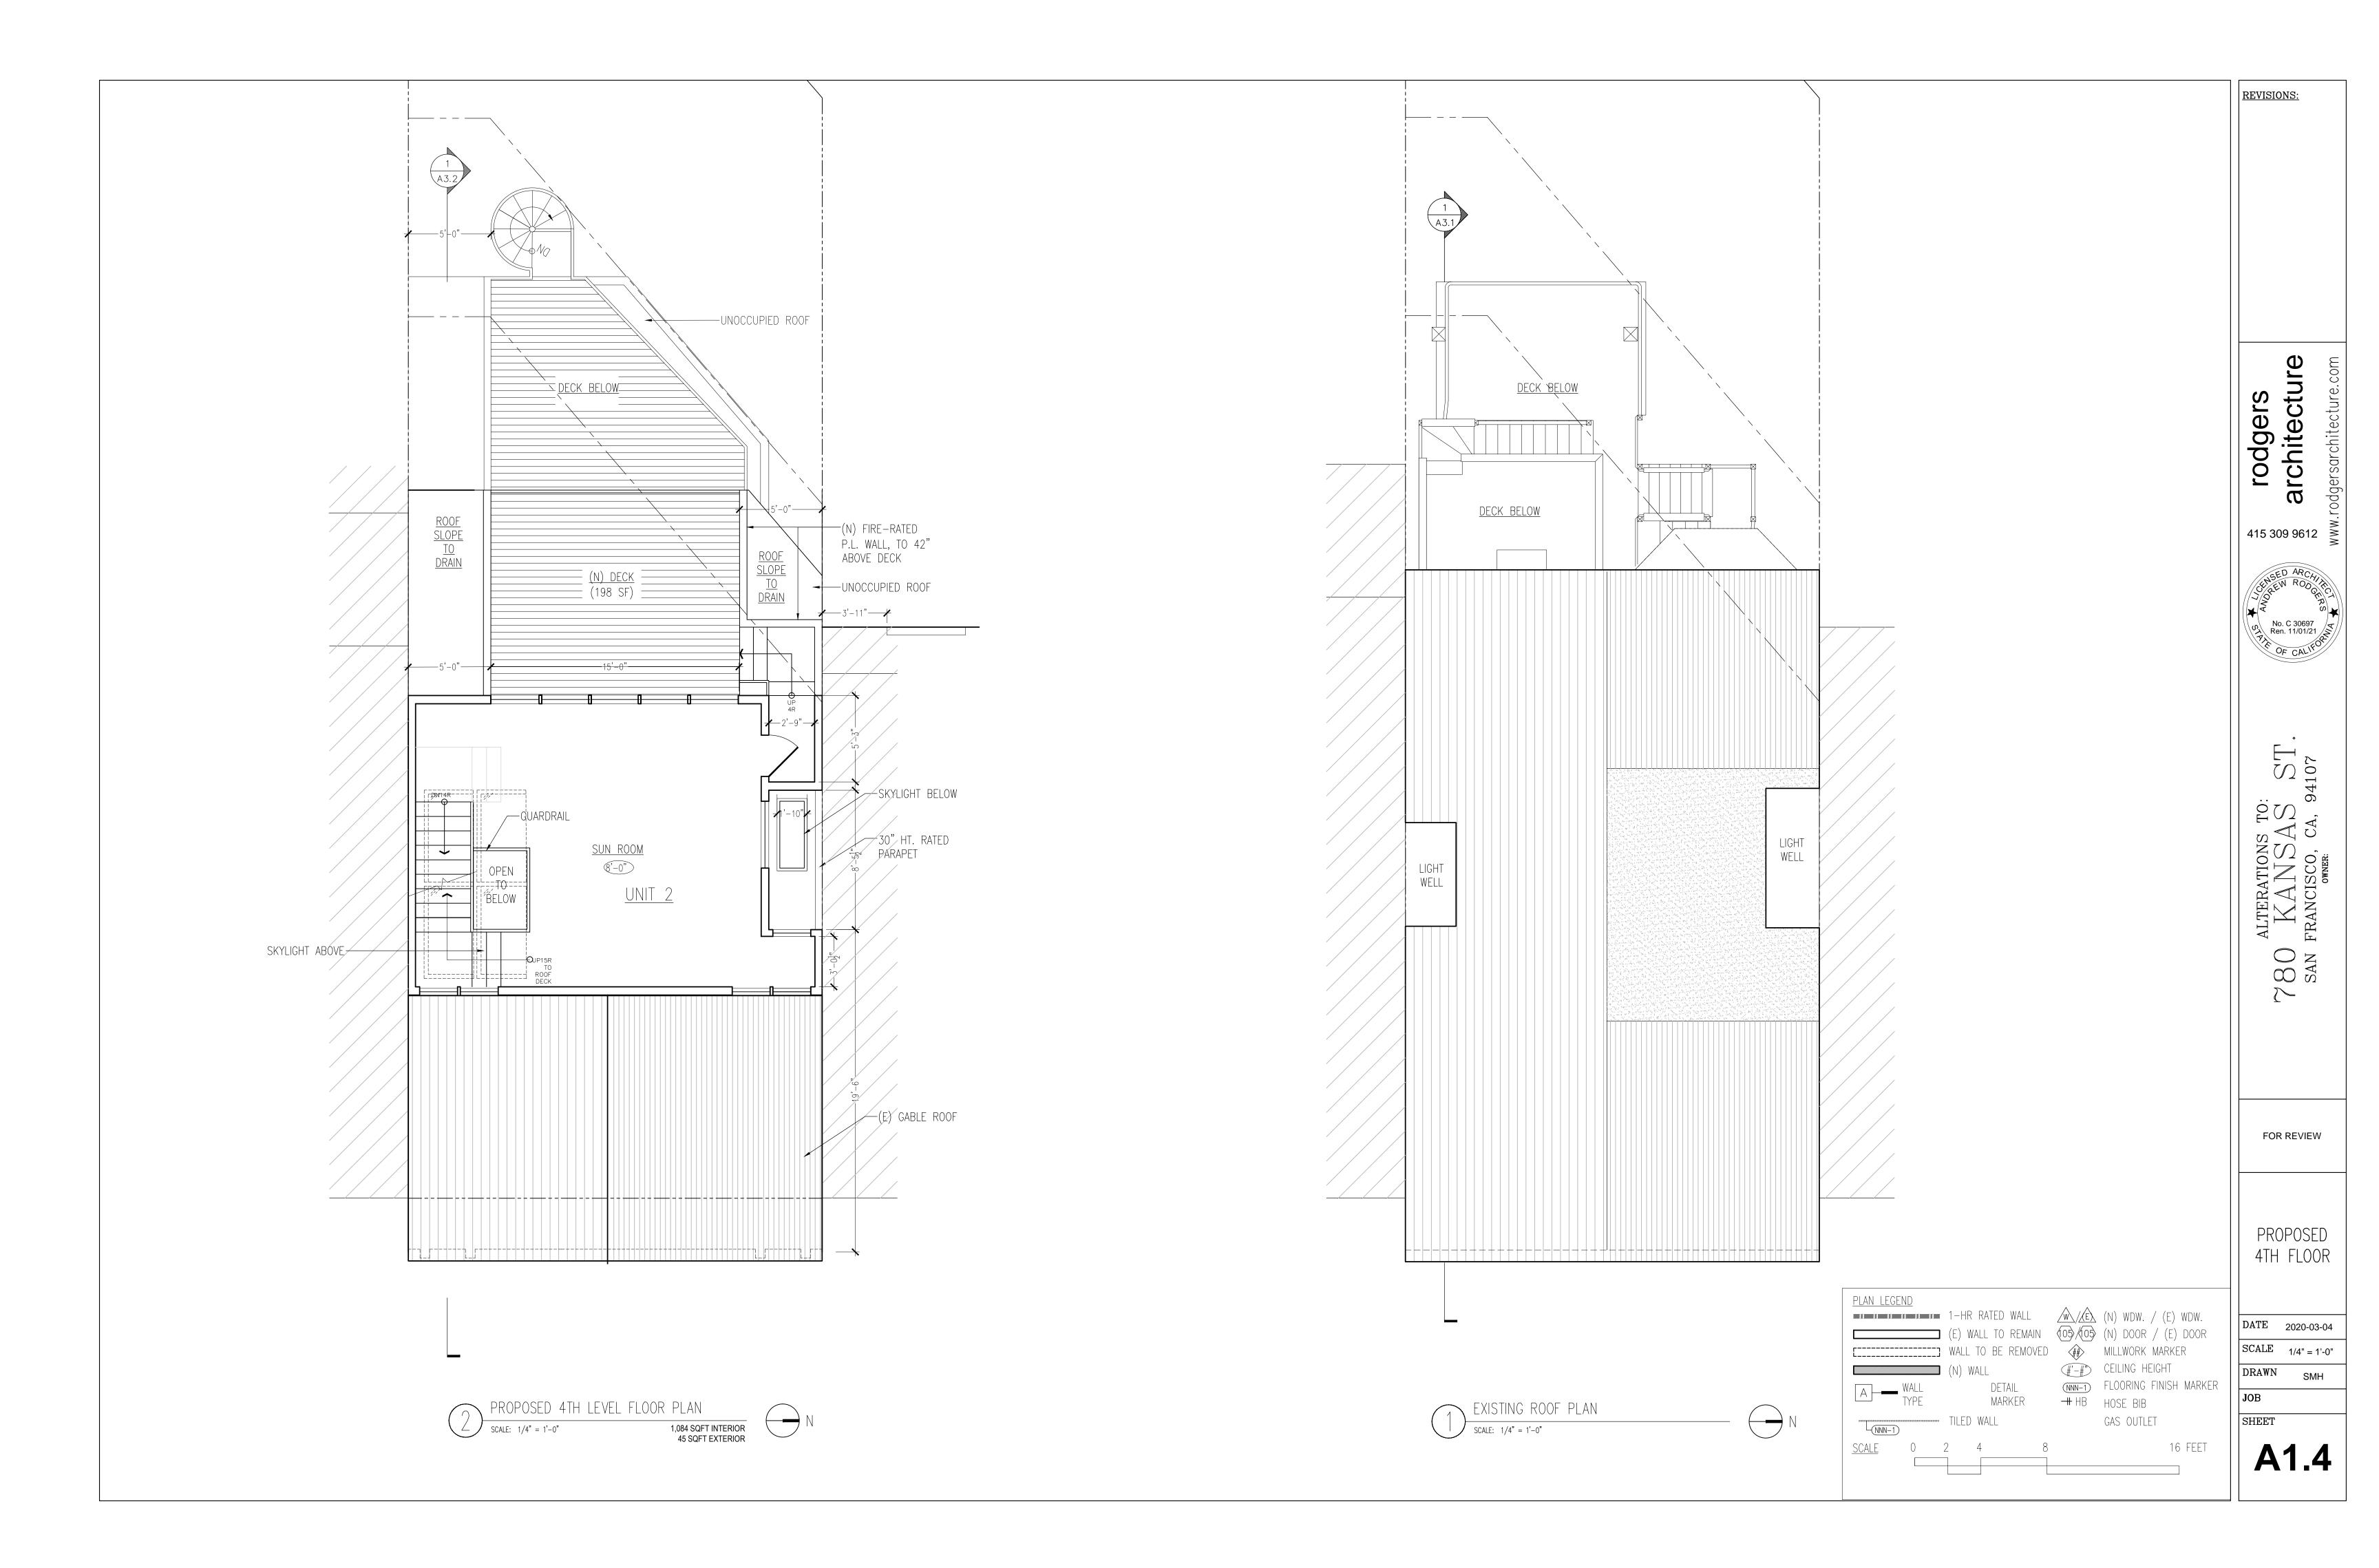

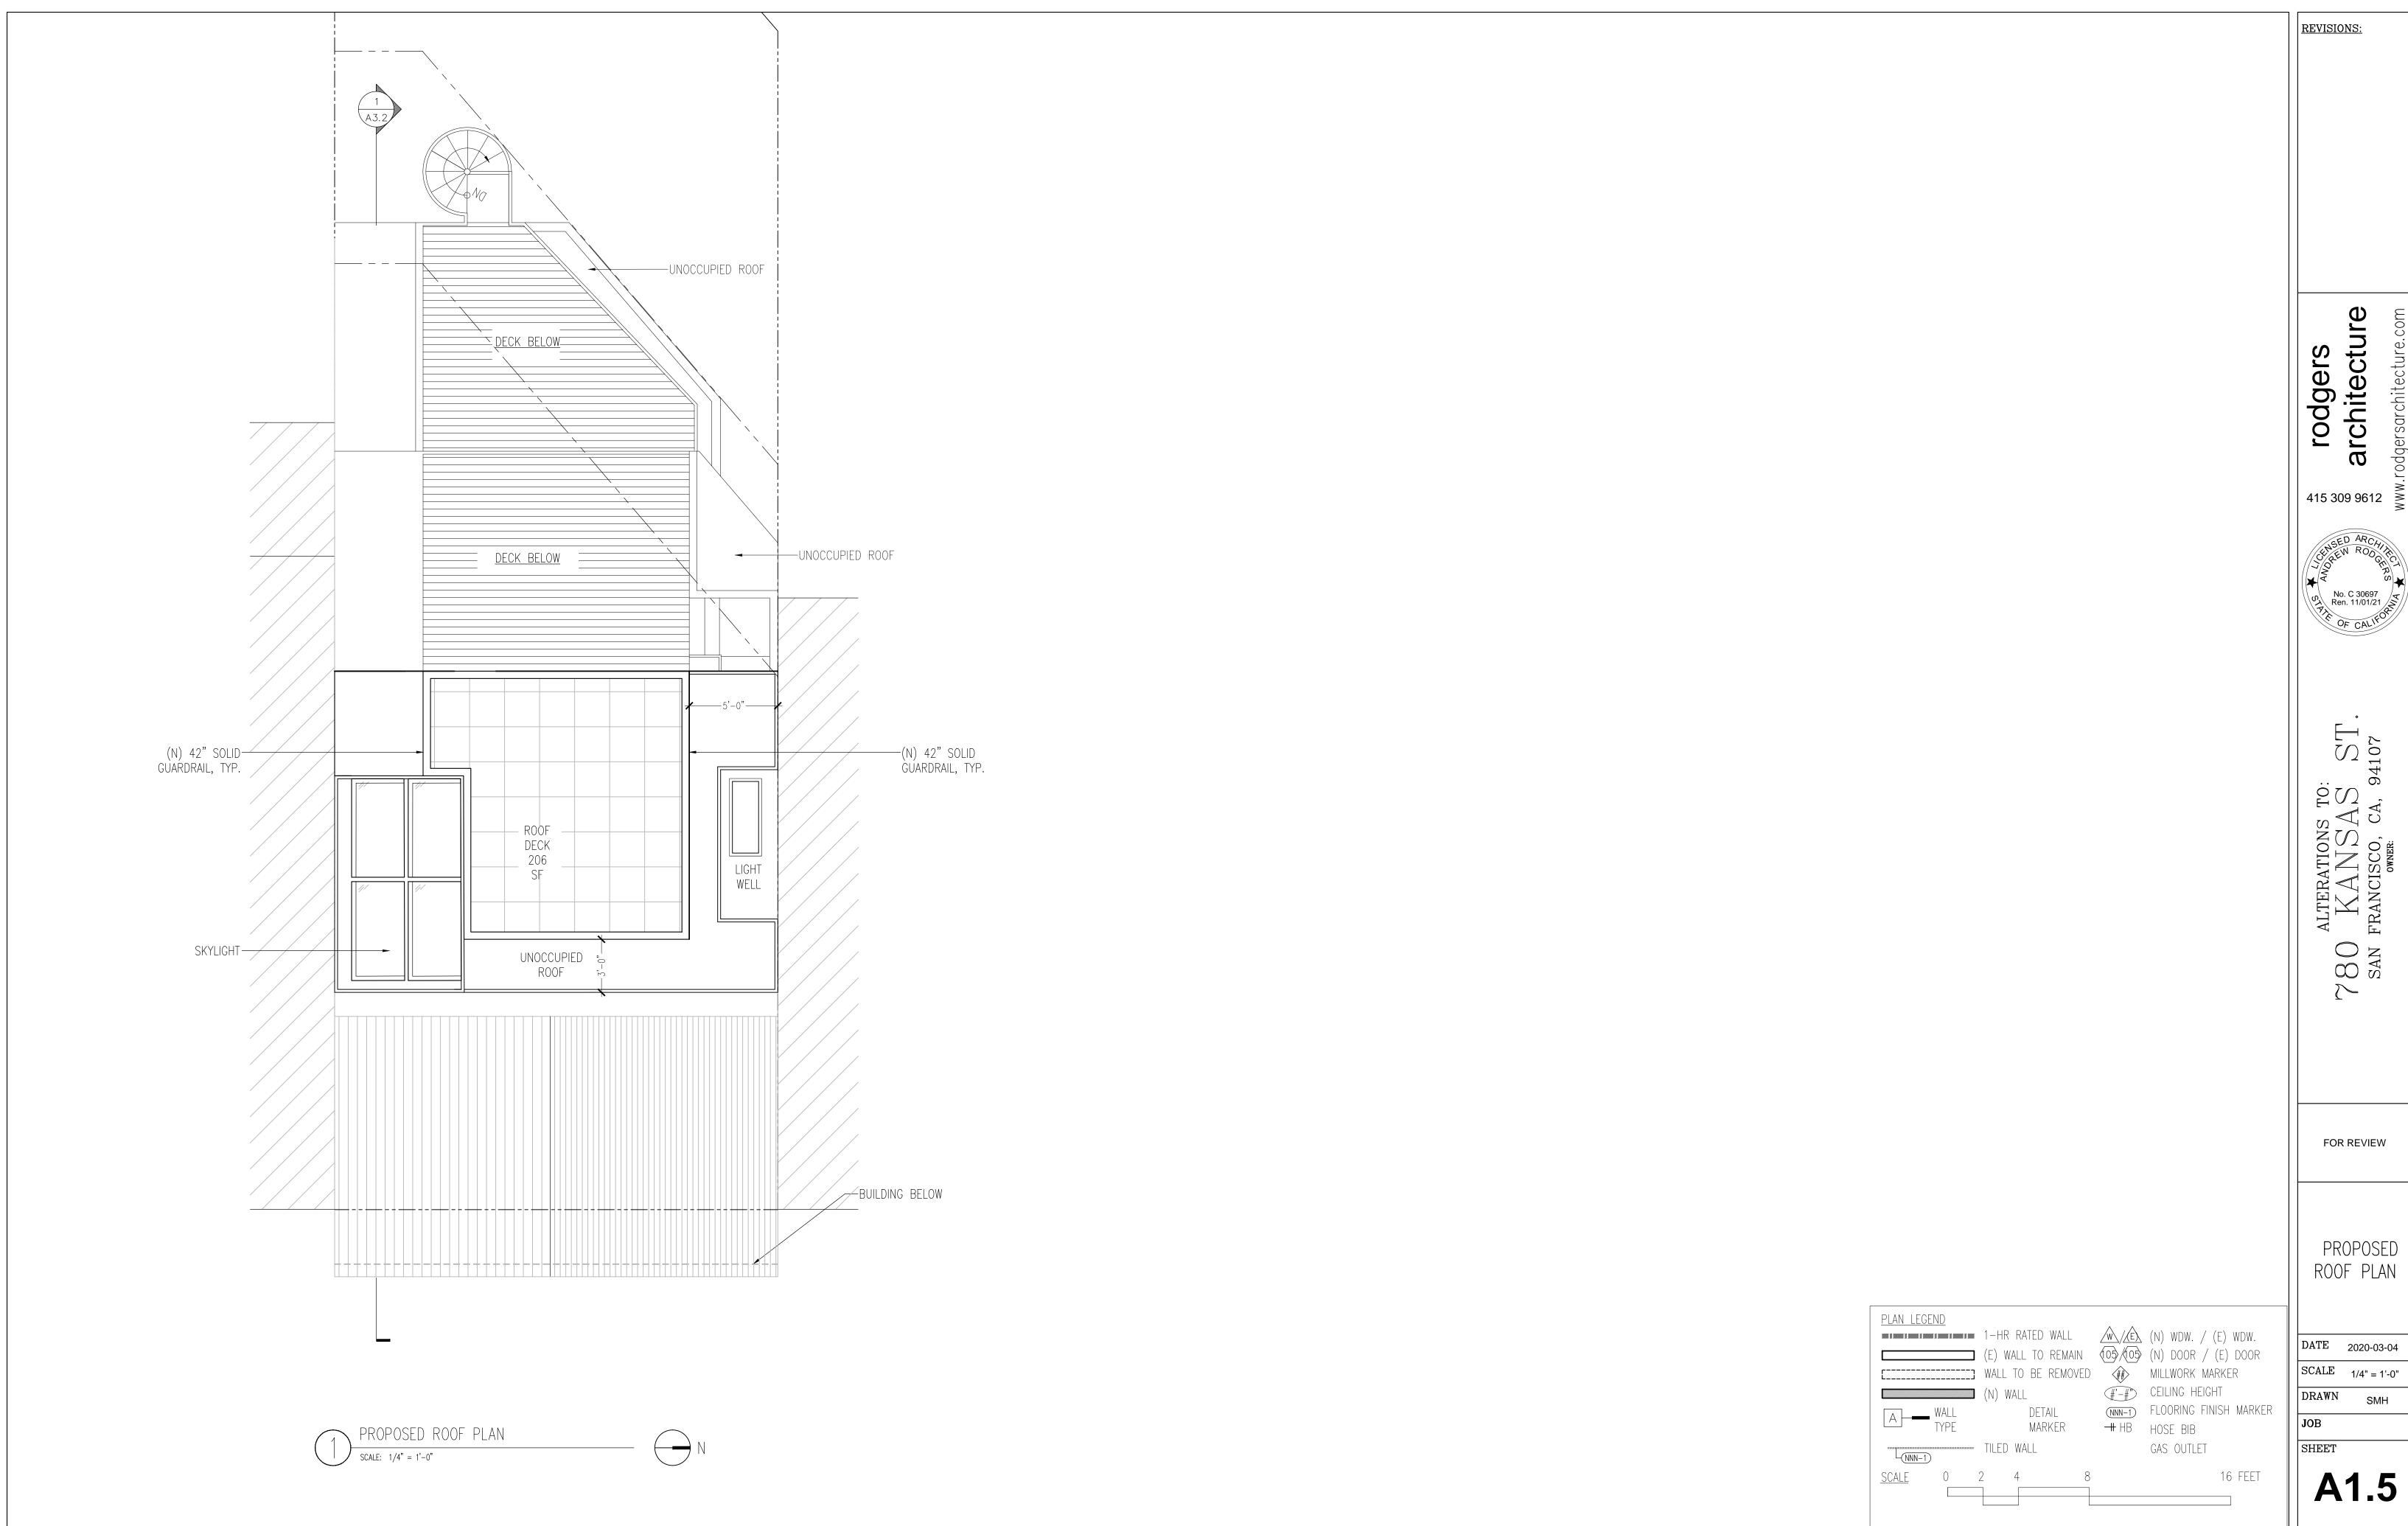

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415 309 9612



ALTERATIONS TO: 780 KANSAS ST SAN FRANCISCO, CA, 94107

FOR REVIEW

EXISTING EAST (FRONT) ELEVATION

DATE 2020-03-04

SCALE 1/4" = 1'-0"

DRAWN SMH / AR

JOB SHEET

Λ 2 1



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ALTERATIONS TO:
780 KANSAS ST
SAN FRANCISCO, CA, 94107

FOR REVIEW


PROPOSED
EAST (FRONT)
ELEVATION

DATE 2020-03-04

SCALE 1/4" = 1'-0"

DRAWN SH / AR

JOB SHEET

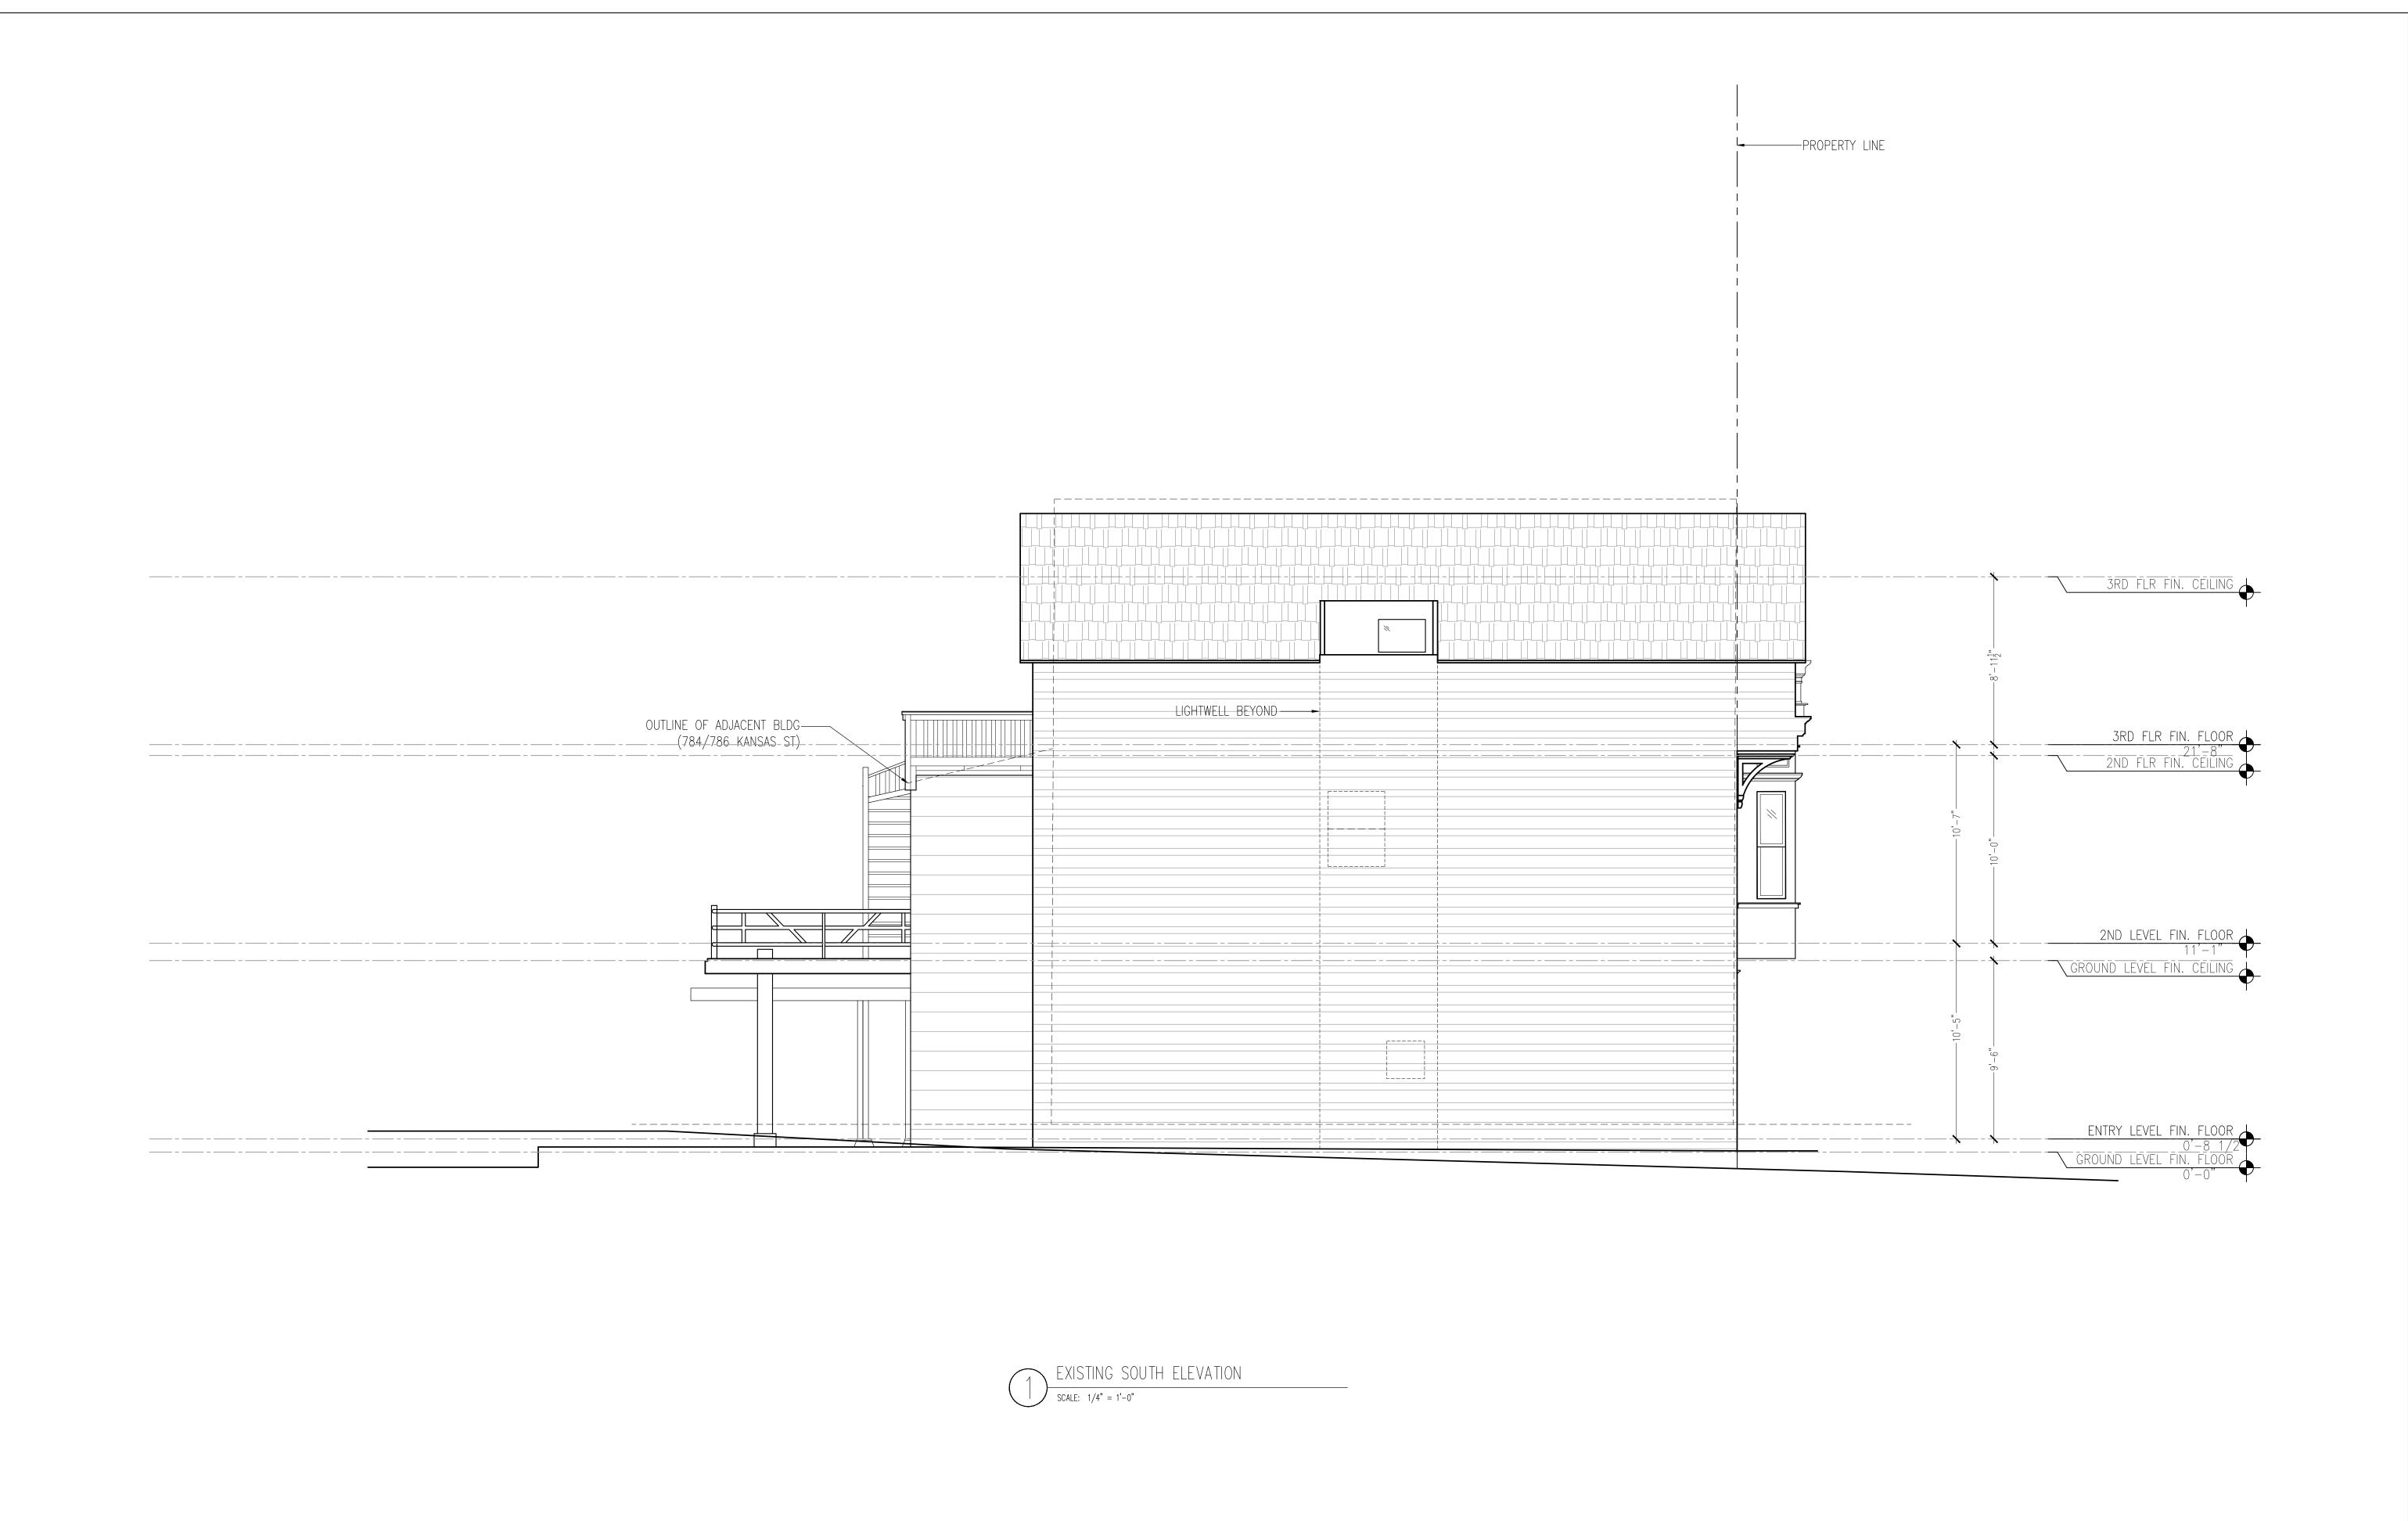

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ALTERATIONS TO:

780 KANSAS ST

SAN FRANCISCO, CA, 94107

FOR REVIEW


EXISTING SOUTH ELEVATION

DATE 2020-03-04

SCALE 1/4" = 1'-0"

DRAWN SH/AR

SHEET

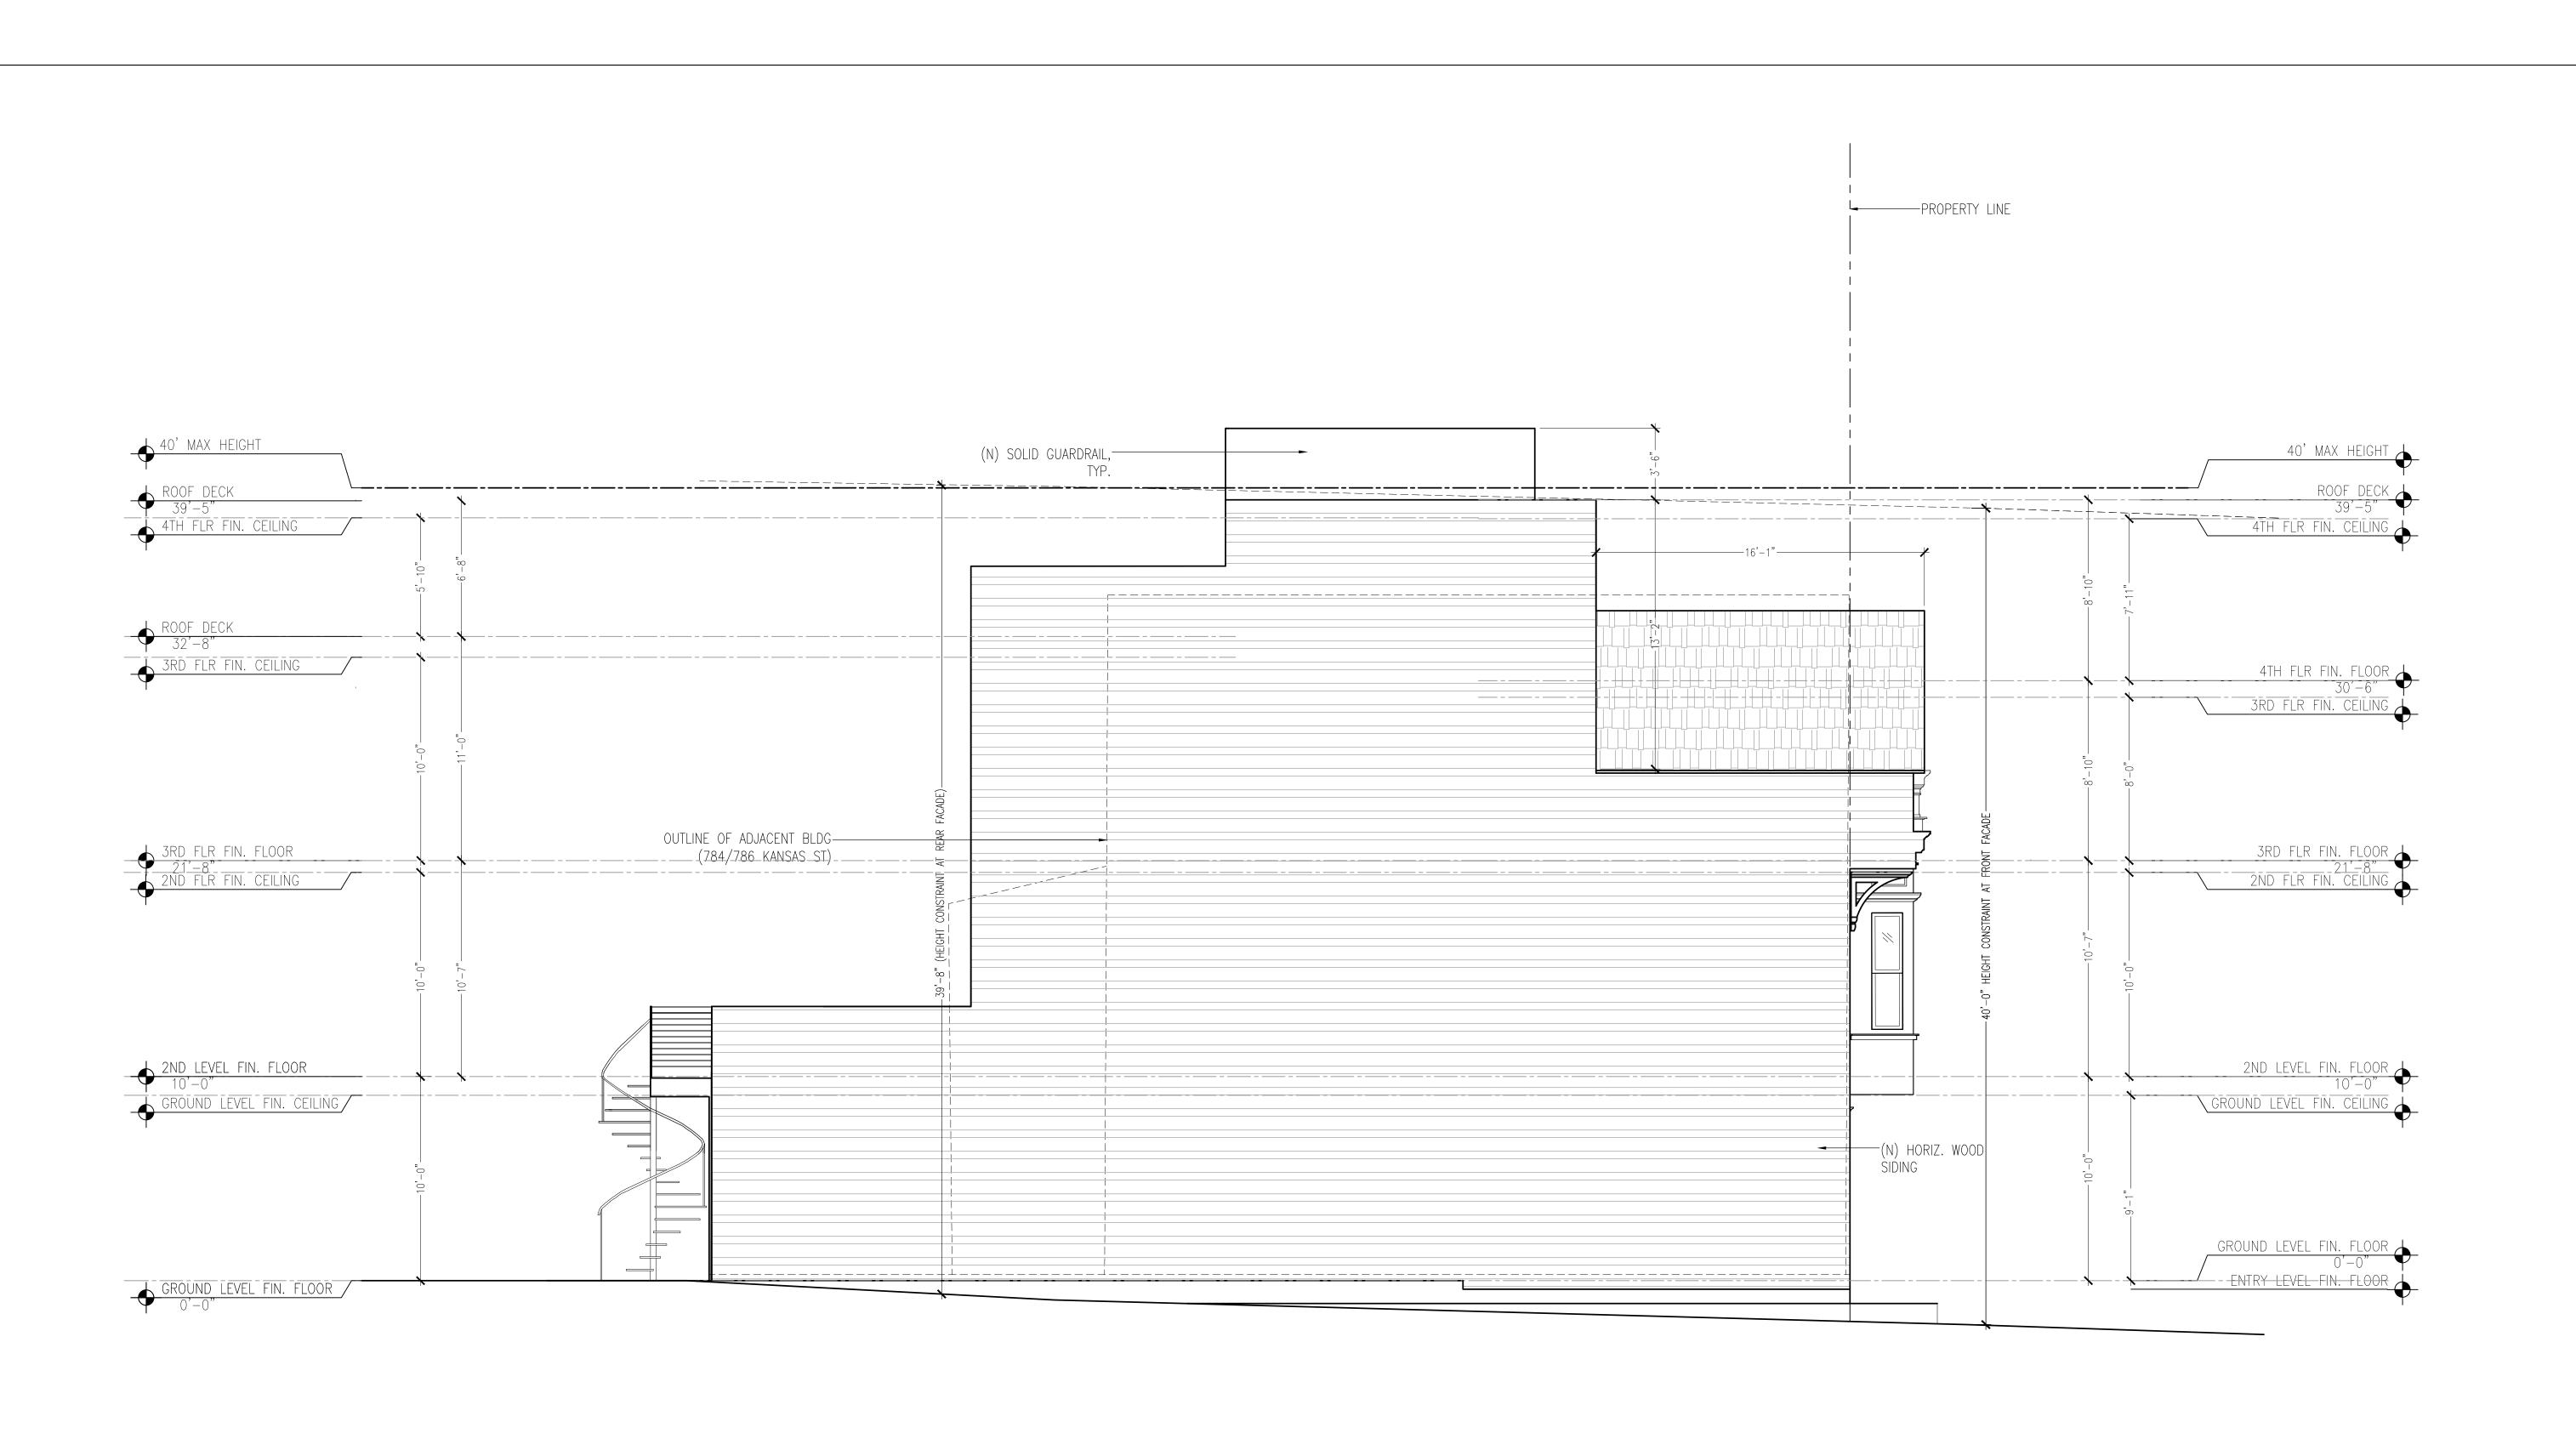

PROPOSED SOUTH ELEVATION

SCALE: 1/4" = 1'-0"

REVISIONS:

rodgers architecture

415 309 9612



ALTERATIONS TO:

780 KANSAS ST

SAN FRANCISCO, CA, 94107

FOR REVIEW

PROPOSED SOUTH ELEVATION

DATE 2020-03-04

SCALE 1/4" = 1'-0"

DRAWN SH / AR

SHEET

EXISTING WEST ELEVATION (REAR)

SCALE: 1/4" = 1'-0"

REVISIONS:

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ALTERATIONS TO:
780 KANSAS ST
SAN FRANCISCO, CA, 94107

FOR REVIEW


EXISTING WEST (REAR) ELEVATION

DATE 2020-03-04

SCALE 1/4" = 1'-0"

DRAWN SH / AR

SHEET

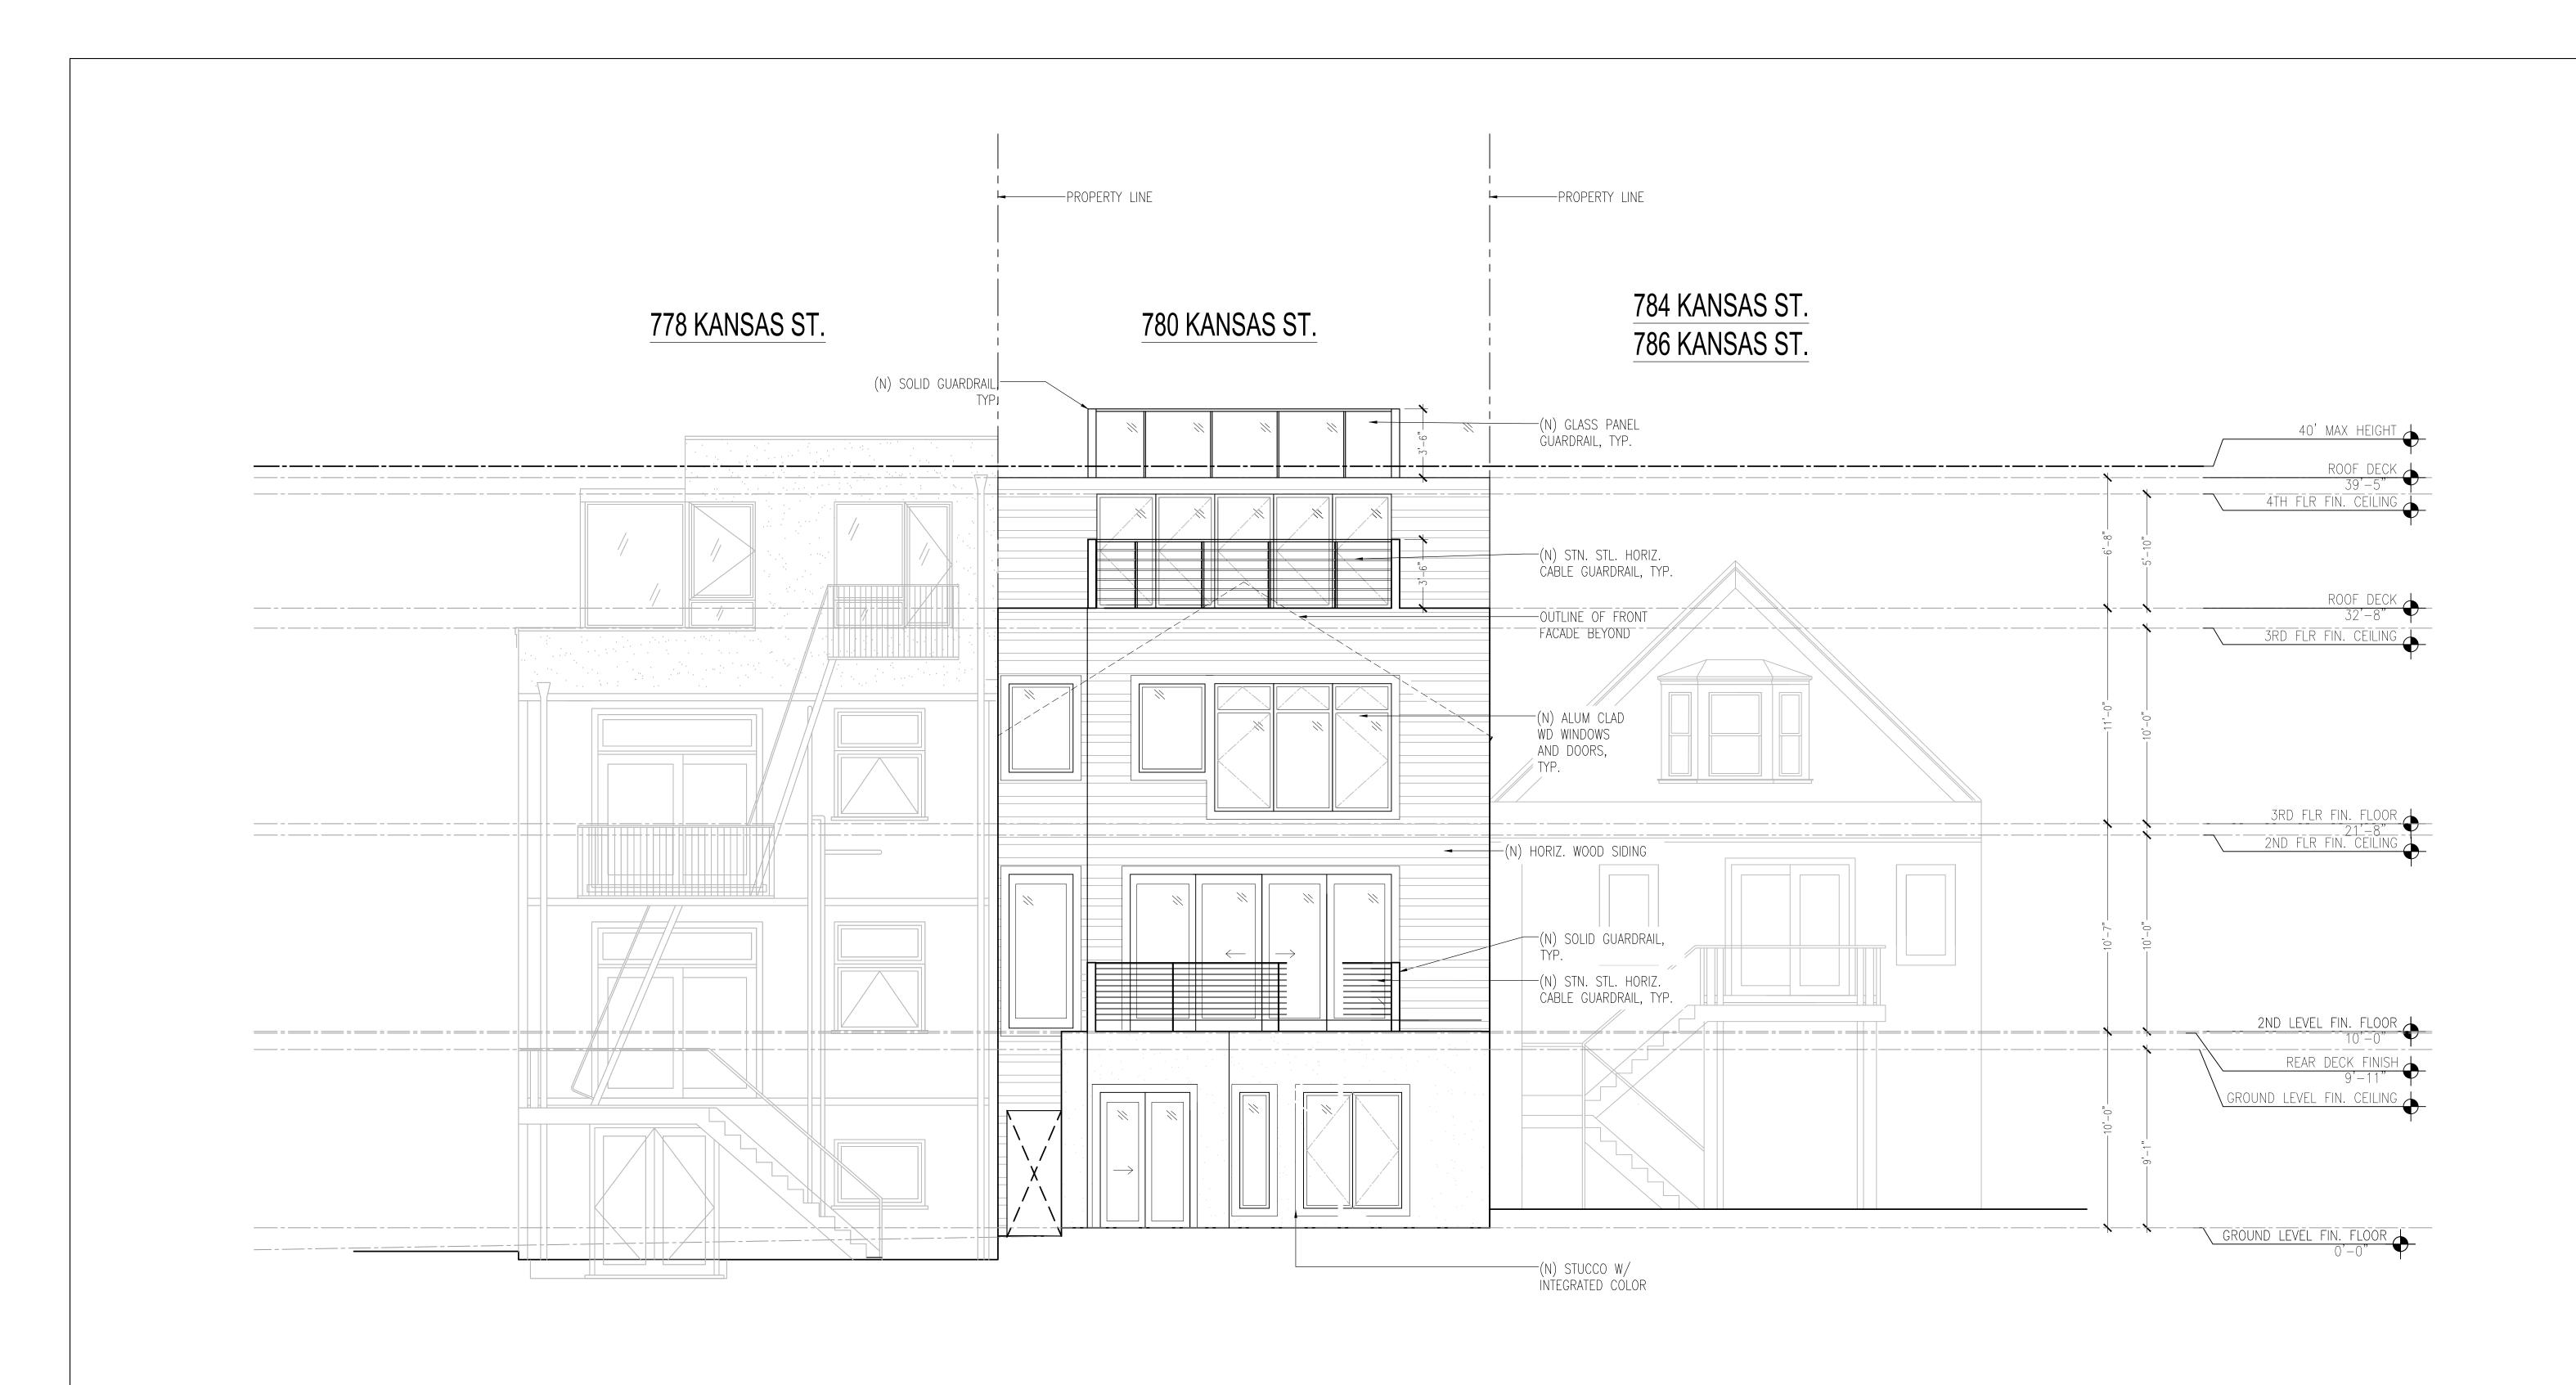

PROPOSED WEST ELEVATION (REAR)

SCALE: 1/4" = 1'-0"

REVISIONS:

rodgers architecture

415 309 9612

UNSED ARCHITECTURE ROOCKER

WAY ROOCKER

OF THE ROOCKER

OF THE

FOR REVIEW


PROPOSED WEST ELEVATION

DATE 2020-03-04

SCALE 1/4" = 1'-0"

| DRAWN | SH / AR

SHEET

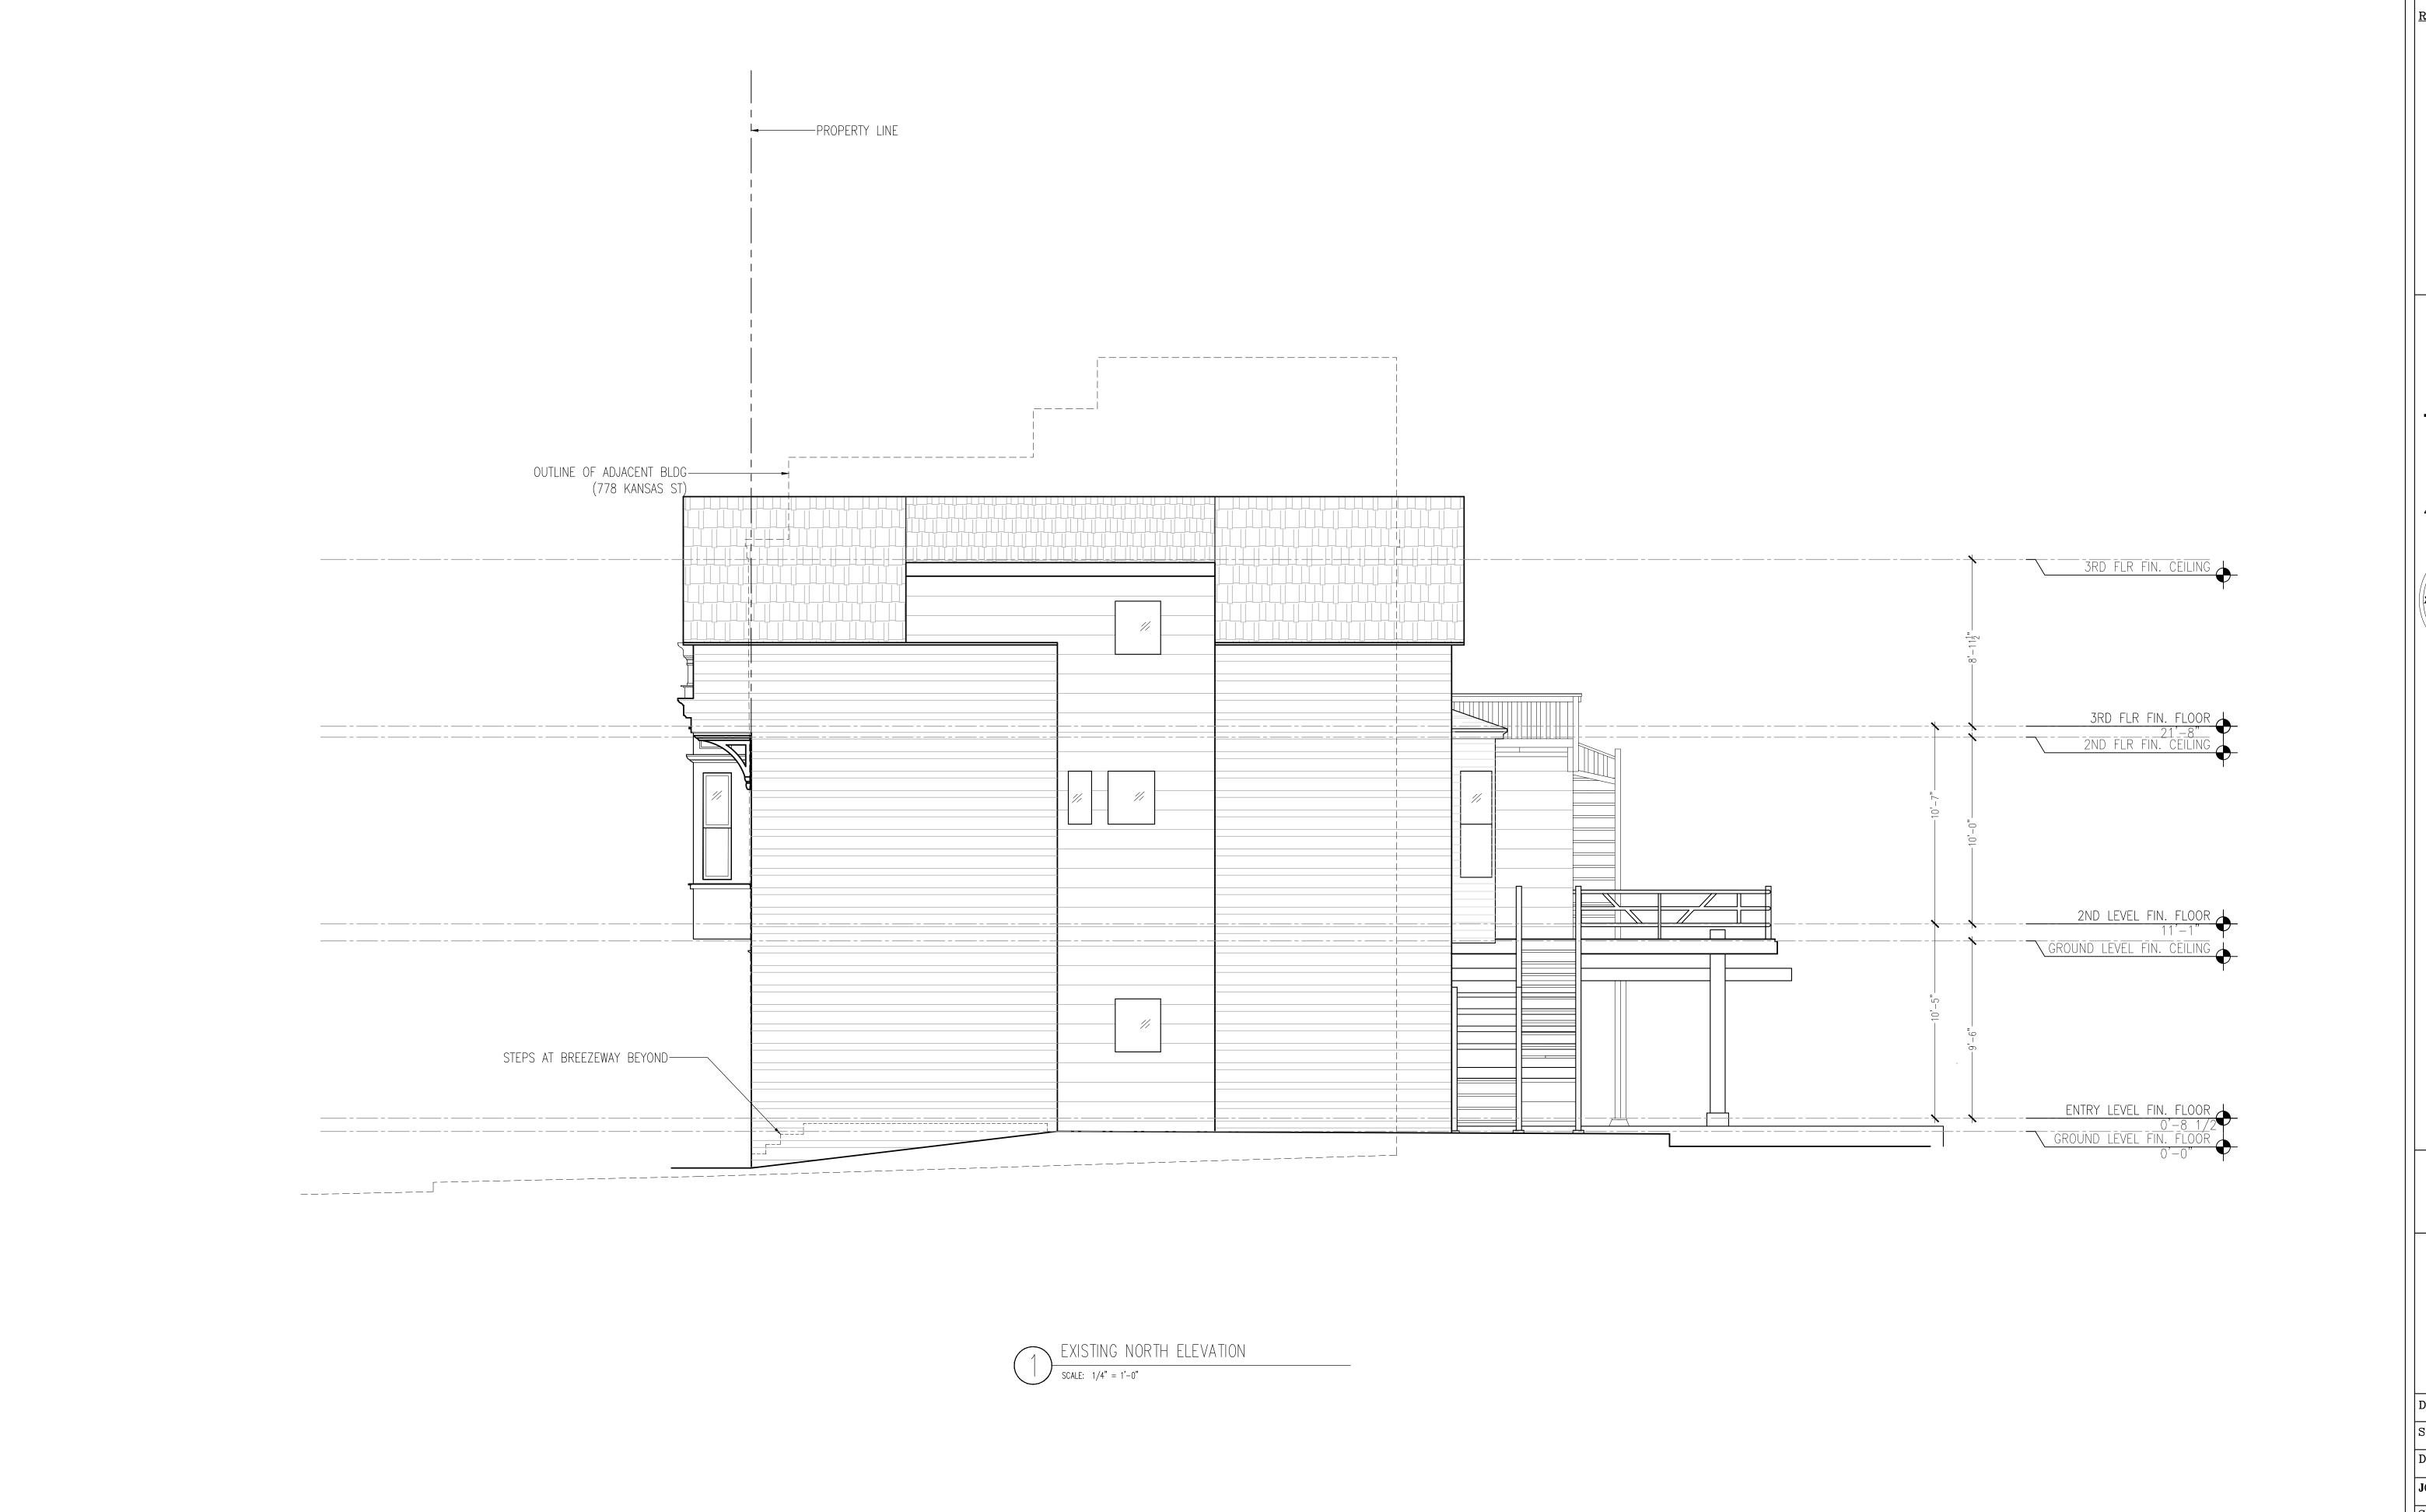

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ALTERATIONS TO:
780 KANSAS ST.
SAN FRANCISCO, CA, 94107

FOR REVIEW


EXISTING NORTH ELEVATION

DATE 2020-03-04

SCALE 1/4" = 1'-0"

DRAWN SH / AR

JOB SHEET

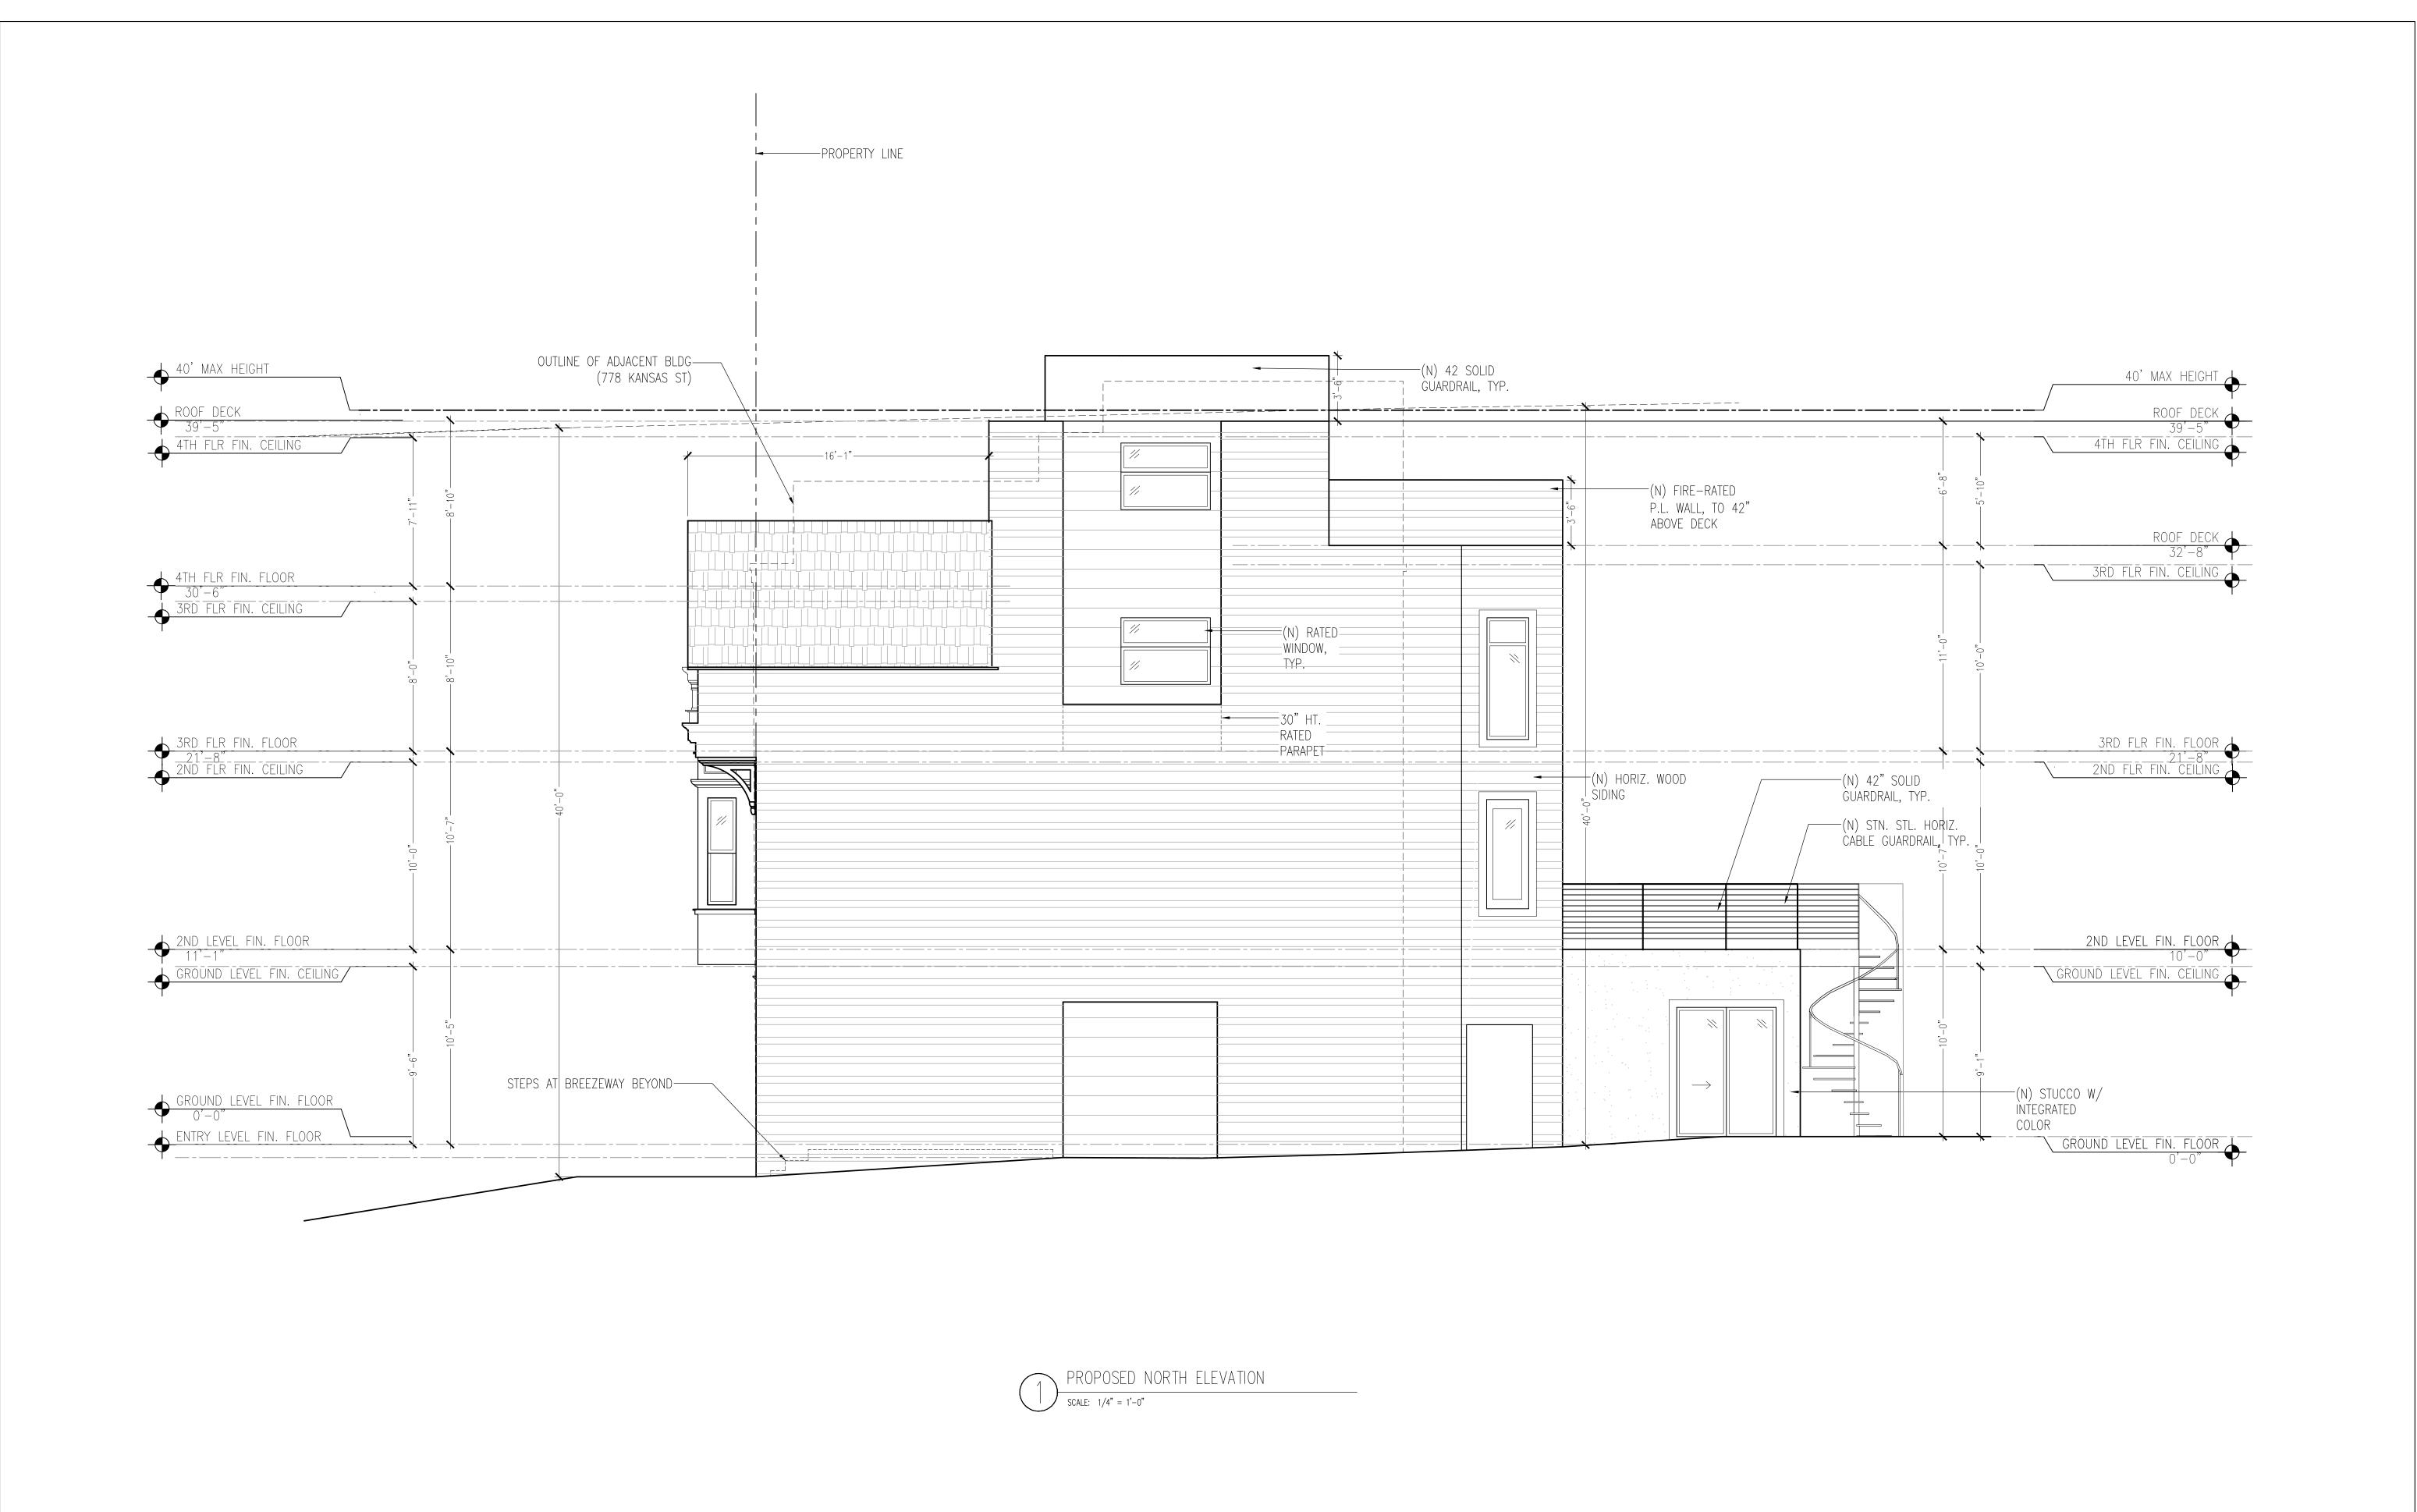

rodgers architecture

415 309 9612 ARCHITECTURE RODGER



ALTERATIONS TO:

780 KANSAS ST

SAN FRANCISCO, CA, 94107

FOR REVIEW

PROPOSED NORTH ELEVATION


DATE 2020-03-04

SCALE 1/4" = 1'-0"

DRAWN SH / AR
JOB

SHEET

16 FEET

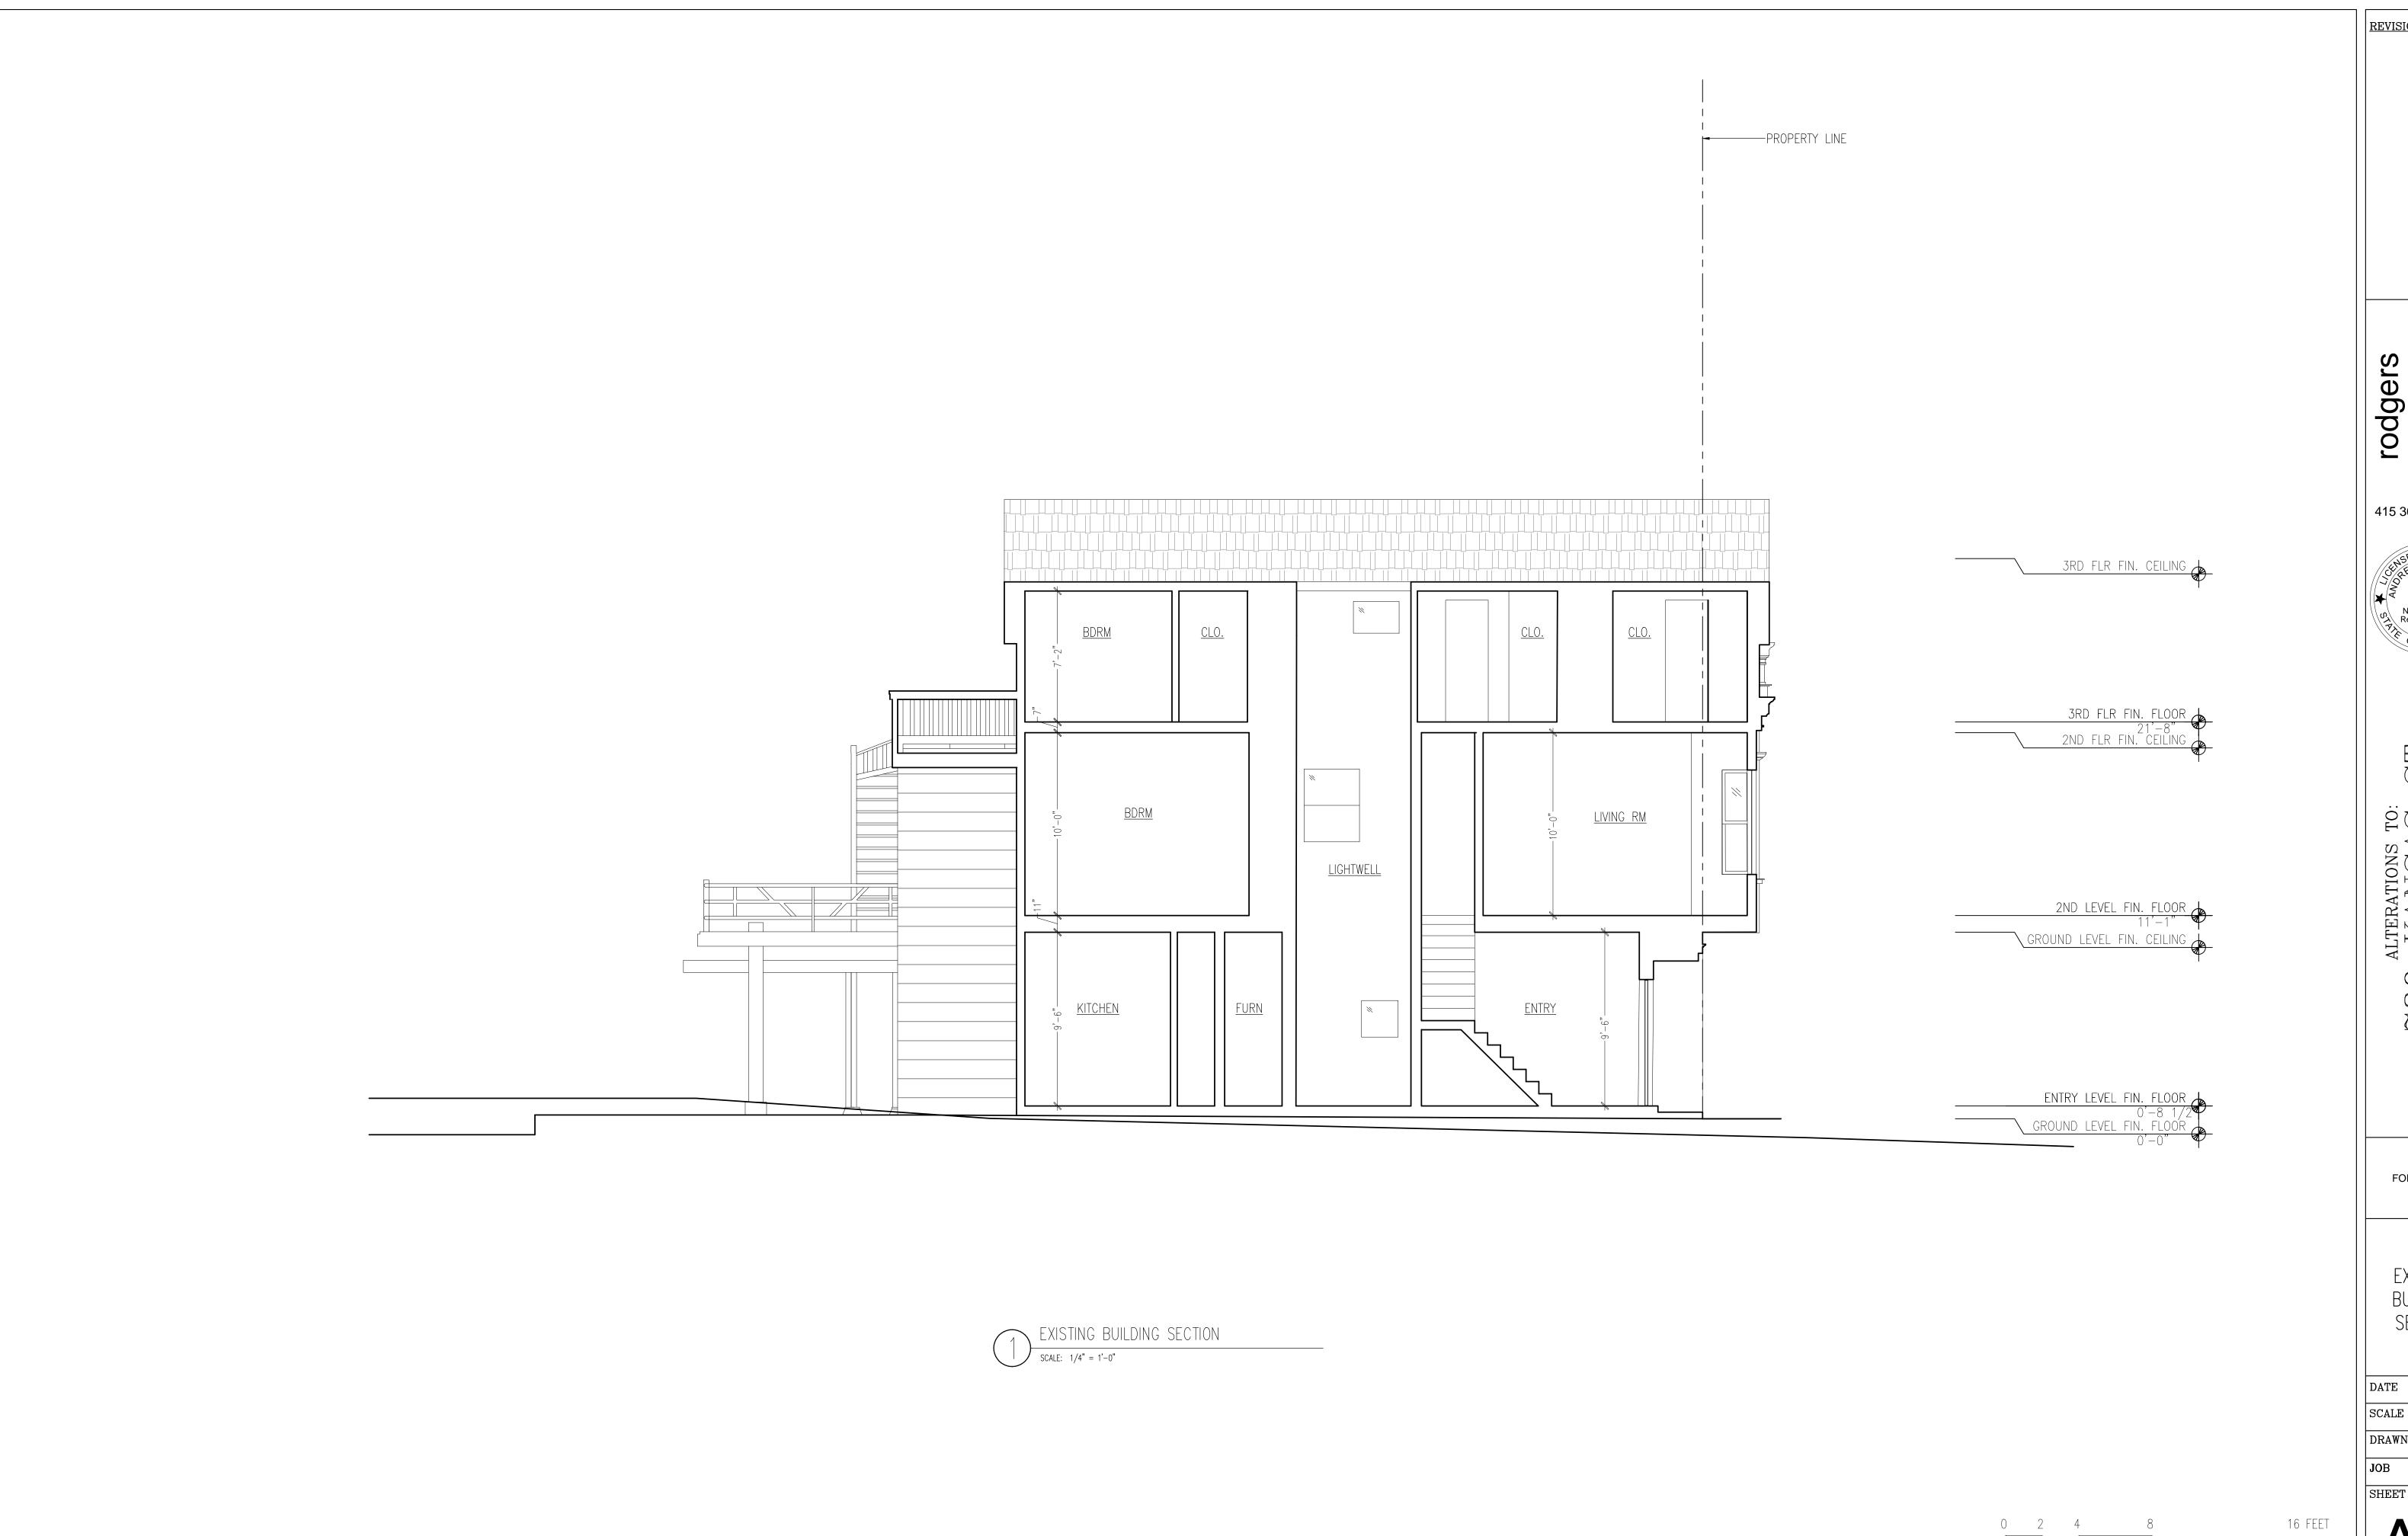

rodgers architecture

415 309 9612



ALTERATIONS TO:

KANSAS
FRANCISCO, CA, 94 780 SAN

FOR REVIEW


EXISTING BUILDING SECTION

DATE 2020-03-04

SCALE 1/4" = 1'-0" DRAWN SH/AR

SHEET

A3.1

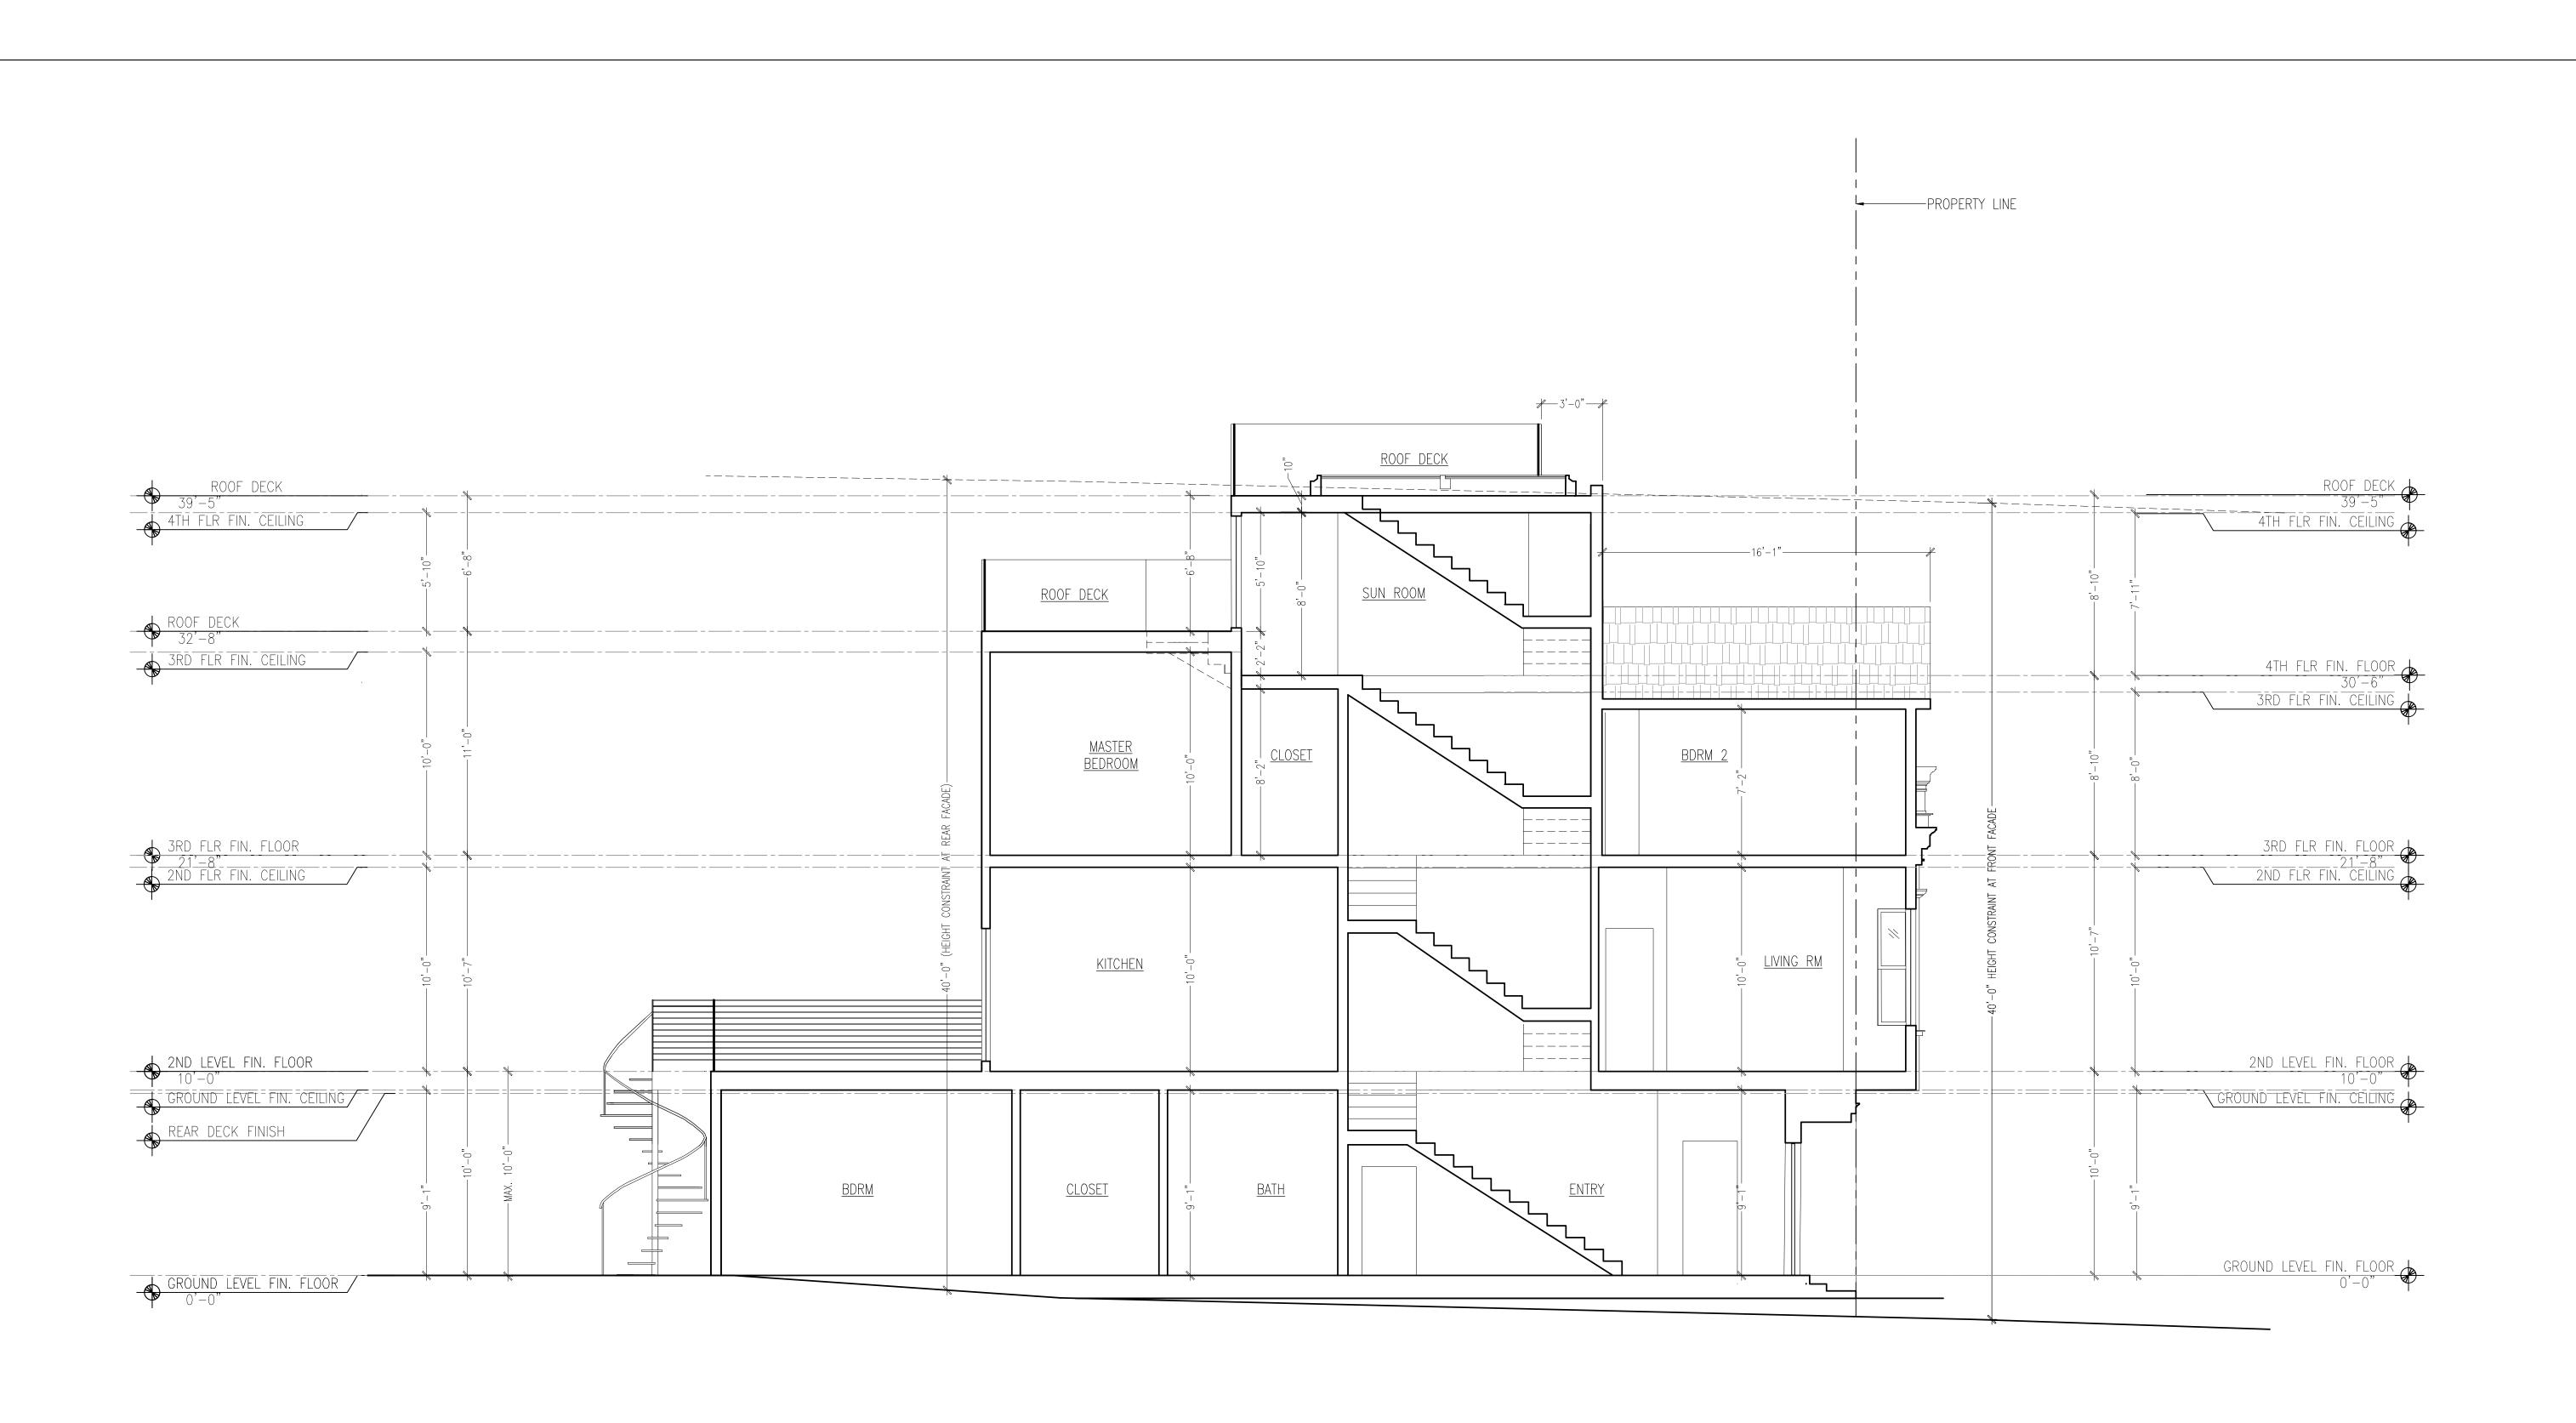

PROPOSED BUILDING SECTION

SCALE: 1/4" = 1'-0"

REVISIONS:

rodgers architecture

415 309 9612



ALTERATIONS TO:
'80 KANSAS ST
SAN FRANCISCO, CA, 94107

FOR REVIEW

PROPOSED BUILDING SECTION

DATE 2020-03-04

SCALE 1/4" = 1'-0"

DRAWN SH / AR

JOB SHEET

16 FEET

A3.2