MEMO

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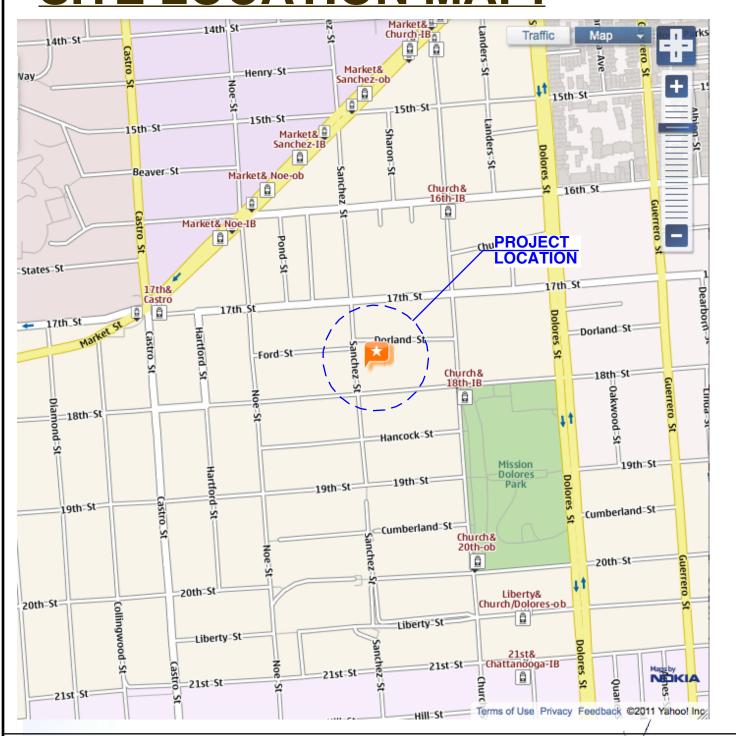
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SITE LOCATION MAP:





2 EXISTING SANCHEZ STREET ELEVATION (EAST FACING) **NO SCALE**

LEGEND:

- \$ ONE-WAY SWITCH
- \$ TWO-WAY SWITCH
- \$ DIMMER SWITCH
- OCCUPANCY SENSOR SW.
- **⊕** DUPLEX RECEPTACLE
- 240: 220/240 VOLT WP: WATERPROOF CA: ABOVE COUNTER
- → FOURPLEX RECEPT
- RECEPTACLE
- ▼ TELEPHONE RECEPT (W: WALL MTD.)
- T.V. OUTLET; VIACOM
- SMOKE DETECTOR (AC POWERED W/ BATTERY BACK-UP)

COMPATIBLE CABLE

- LIGHT FIXTURE AT WALL. PC=PULL CHAIN, LV=LOW VOLTAGE
- SURFACE-MOUNTED INCANDESCENT LIGHT FIXTURE AT CEILING. PC=PULL CHAIN, LV=LOW VOLTAGE

SURFACE-MOUNTED INCANDESCENT

- SURFACE-MOUNTED COMPACT FLUORESCENT LIGHT FIXTURE AT WALL. LV=LOW VOLTAGE
- SURFACE-MOUNTED COMPACT FLUORESCENT LIGHT FIXTURE AT CEILING. LV=LOW VOLTAGE
- RECESSED INCANDESCENT LIGHT FIXTURE AT CEILING. (H: HEAT LAMP LV: LOW VOLT.)
- RECESSED COMPACT FLUORESCENT LIGHT FIXTURE AT CEILING.
- LIGHT STRIP FLUORESCENT LIGHT FIXTURE

HALOGEN TRACK LIGHT

UNDER CABINET FLUOR.

FIXTURE

- THERMOSTAT
- DOOR BELL SECURITY ALARM
- **□A** SECURITY ALARM PANEL BOX
- (D) IN-SINK TRASH DISPOSAL EXHAUST FAN
- GAS METER ELECTRIC METER
- ELECTRIC WALL HEATER
- FLOOR SUPPLY
- FLOOR RETURN
- CEILING SUPPLY CEILING RETURN
- WALL/TOE SPACE SUPPLY WALL/TOE SPACE **RETURN**
 - ALL NEW EXTERIOR FINISHES TO BE INSTALLED OVER A MINIMUM MOISTURE

SCOPE OF WORK:

ADDITION OF NEW, ADU (ACCESSORY DWELLING UNIT) ÓN GRÒUND FLOOR IN REAR OF BUILDÍNG; NO EXPANSION OF **BUILDING FOOTPRINT**

DRAWING INDEX:

- A-0 COVER SHEET & SITE / ROOF PLAN A-0.1 PRE-APPLICATION PLAN REVIEW MEETING MINUTES
- A-1 EXISTING / DEMO & PROPOSED GROUND FLOOR PLANS
- A-1.1 EXISTING 2ND, 3RD, 4TH FLOOR PLANS EXISTING REAR & NORTH ELEVATIONS EXISTING / DEMO & PROPOSED SOUTH

GENERAL CONDITIONS:

CONTRACTORS RESPONSIBILITIES:

ELEVATIONS

- 1. CONTRACTOR TO PROVIDE ALL WORK AND MATERIALS IN ACCORDANCE WITH 2016 CALIFORNIA BUILDING CODE (CBC), & CURRENT EDITIONS OF CALIFORNIA PLUMBING, MECHANICAL, ELECTRICAL & ENERGY CODES, AS WELL AS ALL SAN FRANCISCO LOCAL AMENDMENTS & ORDINANCES.
- CONTRACTOR SHALL MAKE SITE INSPECTIONS AND BE RESPONSIBLE FOR ALL NEW AND DEMOLITION WORK, WHETHER DETAILED BY THE SPECIFICATIONS & DRAWINGS, OR IMPLIED BY EXISTING CONDITIONS.
- ANY DISCREPANCIES IN THE CONSTRUCTION DOCUMENTS, AS CONFLICTS WITH ACTUAL SITE CONDITIONS SHALL BE BROUGHT TO THE ATTENTION OF THE ARCHITECT BEFORE PROCEEDING WITH THE WORK.
- . CONTRACTOR SHALL PROVIDE ALL TEMPORARY SHORING & UNDERPINNING AS NECESSARY. THIS WORK SHALL BE PERFORMED UNDER SEPARATE PERMIT. 6. CONTRACTOR SHALL BE RESPONSIBLE TO COORDINATE AND PROVIDE ALL NECESSARY TEMPORARY UTILITY HOOK-UPS FOR ALL EQUIPMENT DURING
- E. CONTRACTOR SHALL BE RESPONSIBLE FOR DISCONNECTION / CAPPING OFF OF ALL EXISTING UTILITIES. PROVIDE RE-CONNECTION AS REQUIRED, WHERE
- CONFIRM ALL WINDOW SIZES WITH ACTUAL / EXISTING ROUGH OPENING DIMENSIONS PRIOR TO ORDERING WINDOWS.
- SLOPE ALL FLOORS / ROOFS TO DRAIN A MINIMUM OF 1/4" PER 1'-0", UNLESS SPECIFICALLY NOTED OTHERWISE.
- MECHANICAL, PLUMBING AND ELECTRICAL WORK SHOWN ON DRAWINGS IS SCHEMATIC IN NATURE: CONTRACTOR TO CONFIRM FINAL LAYOUT WITH ARCHITECT, PRIOR TO PROCEEDING WITH THE WORK.
- 10. ARCHITERCT IS NOT RESPOSIBLE FOR CONSTRUCTION MEANS AND METHODS, NOR CONSTRUCTION SEQUENCING; THIS IS THE SOLE RESPONSIBILITY OF THE GENERAL CONTRACTOR.

DO NOT SCALE DRAWINGS! ALL WRITTEN DIMENSIONS SUPERSEDE SCALED

- ALL DIMENSIONS ARE TO "FACE OF STUD" UNLESS SPECIFICALLY NOTED OTHERWISE. EXISTING DIMENSIONS DENOTED BY "(E)" ARE TO "FACE OF XISTING FINISH" UNLESS SPECIFICALLY NOTED OTHERWISE. ALL EXISTING DIMENSIONS SHALL BE FIELD VERIFIED PRIOR TO PROCEEDING WITH THE WORK
- LARGE SCALE DRAWINGS TAKE PRECEDENCE OVER SMALL SCALE DRAWINGS; WRITTEN SPECIFICATIONS TAKE PRECEDENCE OVER ALL DRAWINGS. REFER TO EXTERIOR ELEVATIONS FOR INDICATIONS OF WINDOW OPERATION

ASSEMBLIES:

SEE **LEGEND** ON FLOOR PLANS, FOR RATED WALL DESIGNATIONS, WALL TYPES & THER RATED ASSEMBLIES)

- PROVIDE MINIMUM 1-HOUR WALL DEMISING WALL BETWEEN UNITS. SEE PLANS & BUILDING SECTIONS FOR DESIGNATIONS & STANDARD DETAILS FOR COMPLETE ASSEMBLY DESCRIPTIONS. INSULATE ALL ASSEMBLIES BETWEEN HEATED AND UNHEATED AREAS: R-30 AT
- ROOFS, R-13 AT WALLS, R-19 AT FLOORS; MINIMUM, UNLESS SPECIFICALLY NOTED OTHERWISE. SEE TITLE 24, ENERGY COMPLIANCE STATEMENT & **MANDATORY MEASURES CHECKLIST** FOR SPECIFIC REQUIREMENTS. PROVIDE VENTILATION OF ALL JOIST, STUD AND RAFTER SPACES ENCLOSED BY
- BUILDING ASSEMBLIES BETWEEN HEATED & UNHEATED AREAS INCLUDING: ATTICS, BASEMENTS, ROOFS, SOFFITS, PARAPET & RAILING
- ALL DOORS BETWEEN HEATED AND UNHEATED AREAS SHALL BE PROVIDED WITH WEATHER-STRIPPING AND THRESHOLDS. PROVIDE MOISTURE RESISTANT GYPSUM WALL BOARD (M.R. GWB) ON ALL BATHROOM WALLS, U.O.N. DO NOT USE A CONTINUOUS VAPOR BARRIER BEHIND M.R. GWB. DO NOT USE M.R. GWB ON BATHROOM CEILINGS; USE 5/8"


MECHANICAL:

- 1. ALL GAS VENT TERMINATIONS SHALL MEET THE REQUIREMENTS OF CMC SEC. 802.6 & 802.8.
- 2. ALL COMBUSTION AIR SHALL MEET THE REQUIREMENTS OF CMC CHAP. 7. 8. ALL INTERIOR SPACES INTENDED FOR HUMAN OCCUPANCY SHALL BE PROVIDED
- WITH SPACE HEATING PER CBC SEC. 1204.1. . CLOTHES DRYERS EXHAUST SHALL BE A MINIMUM OF 4" DIAMETER, TERMINATE @ BUILDING EXTERIOR & BE EQUIPPED WITH A BACK-DRAFT DAMPÉR & MEET THE REQUIREMENTS OF CMC SEC. 504.4 PROVIDE A MINIMUM OF 100 SQ. IN. OF MAKE-UP AIR OPENING FOR ALL DOMESTIC DRYERS.
- 5. ALL ENVIRONMENTAL DUCTS SHALL TERMINATE 3' MINIMUM FROM PROPERTY LINES & FROM OPENINGS INTO THE BUILDING, PER CMC SEC. 504.0.
- 6. ALL DOMESTIC RANGE HOOD VENTS SHALL MEET THE REQUIREMENTS OF CMC SEC. 504.3.
- '. ALL GARAGES SHALL BE PROVIDED WITH A MINIMUM OF 200 SQ. INCHES OF NET FREE VENTILATION.

- ALL ELECTRICAL RECEPTACLES IN DAMP LOCATIONS TO BE GROUND FAULT INTERRUPTER (GFI) AS REQUIRED PER CODE.
- BEDROOMS: ALL BRANCH CIRCUITS PROVIDING 125 VOLT, SINGLE-PHASE, 15 OR 20 AMP OUTLETS SHALL BE PROTECTED BY AN ARC-FAULT CIRCUIT INTERUPTER LISTED TO PROVIDE PROTECTION FOR THE ENTIRE BRANCH CIRCUIT(S).
- 3. ALL RESIDENTIAL LIGHTING SHALL COMPLY WITH CEC SEC. 150.0(k). 4. AT LEAST 50% OF ALL KITCHEN LIGHTING SHALL BE HIGH-EFFICACY.

SEE STANDARD DETAILS FOR INSTALLATION REQUIREMENTS.

- . ALL SHEET METAL WORK TO BE IN ACCORDANCE WITH THE MOST CURRENT EDITION OF S.M.A.C.N.A. STANDARDS.
- PROVIDE GALVANIZED SHEET METAL Z-BAR FLASHING AT ALL WINDOW & DOOR HEADS: INSTALL UNDER EXTERIOR SIDING OR CEMENT PLASTER & BUILDING PAPER; & OVER HEAD FRAME OF ALL NEW DOORS AND WINDOWS, U.O.N. PROVIDE ADDITIONAL BITUMINOUS MEMBRANE WATERPROOF FLEXIBLE FLASHING (INDUSTRY STANDARD) AROUND ALL WINDOW & DOOR OPENINGS.
- PROVIDE GALVANIZED SHEET METAL FLASHING AT ALL ROOF CONDITIONS INCLUDING BUT NOT LIMITED TO: PERIMETER EDGES, VALLEYS, PARAPET CAPS, WALL / ROOF INTERSECTIONS, ROOF PENETRATIONS, ETC., U.O.N. SEE DETAILS FOR SPECIFIC REQUIREMENTS.
- BARRIER OF OF TWO LAYERS OF 15 POUND (GRADE D) BUILDING PAPER, OR APPROVED EQUAL.

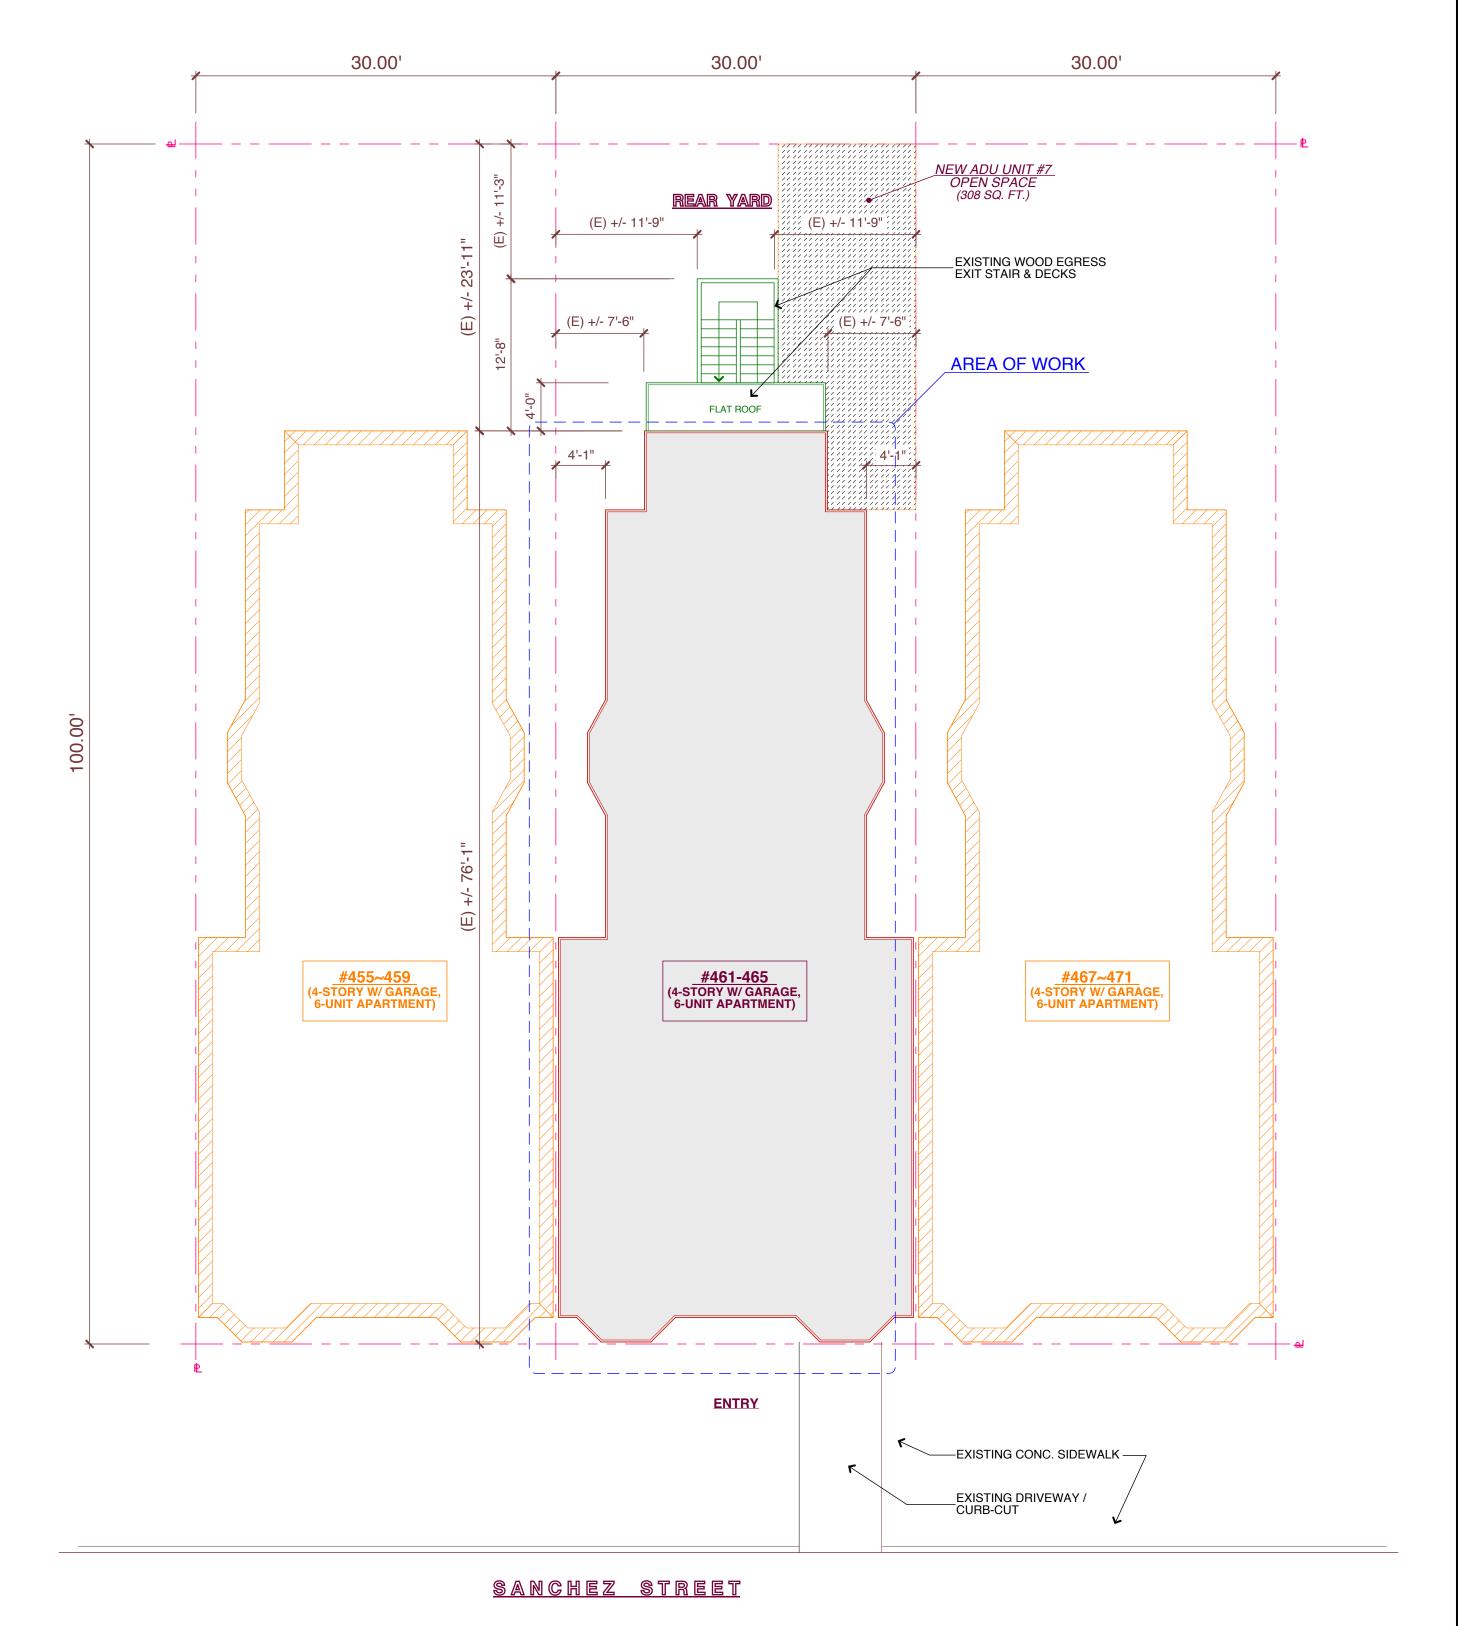

BUILDING DATA:

OCCUPANCY: CONSTRUCTION TYPE: V-B FIRE SPRINKLERS: HEIGHT:

R-2 (6-UNITS) NONE 3-STORIES (o/ GARAGE)

EXISTING

PROPOSED

R-2 (7-UNITS) V-B PARTIAL (GROUND FLOOR) 3-STORIES o/ GARAGE

1 SITE / ROOF PLAN

1/8" / FT.

SITE DATA:

0 2' 4' 6' 8' 10'

GRAPHIC SCALE:

ZONING: BLOCK: 3580 LOT: 030

30.00' x 100.00'

TR Ш -RANCISCO, (-K #3580; LOT 4 A61 MEW SAN BLOG

0

Revisions

palter / donzelli desigr

50-B Hancock St. an Francisco, CA 94114

415) 552-0802

Date: 11/01/17 Scale: AS NOTED Drawn: NP

			Cod	e issues which wer
			1.	Use of Information Legalization of D
				 Per Sec. C, as existing Groun required to har
				Correct, the e
				W
		461~465 Sanchez Pre-Application Plan R	eview	
		MEETING MIN June 30	UTES	
• Se	ec. 1029: Sleeping Area "Emergency Escape / l	Rescue" for New ADU (Accessory Dwelling Un	it):	 Per Sec. D, n in lieu of upg
	public way & the 30' minimum Rear Yar	g glass door does not front directly onto a street of requirement cannot be met, what alternate mea		Yes, the ent
	A new 1-hour fire rated Exit Corridor (discharges out to Sanchez Street sha	passage in the event of an emergency event? (along the North Property Line) which Il be provided with all doors 45 minute fire ra	ited	W
	with self-closing hardware.	Icl	2.	CBC Chapter 7:
	DBI	J& SFFD		• Table 705.8,
• Ur Dv	welling Unit)? s the building is an existing older building,	uirements for the proposed, new ADU (Accessor		o Existi Unit): sprink replac
Ui	nit) is exempt from any accessibility require	ements.	e .	Yes, i
-	DBI	SFFD		W.
	it Passageway: Is the Exit Passageway require -A; specifically:	ed to be disabled access compliant, per Chapter	3	CBC Chapter 10:
As	s the building is an existing older building,	the Exit Passageway & proposed, new Exit exempt from any accessibility requirements.		Existing Group
	My. DBI	N/A SFFD		o Are th
				Yes, t
	each Meeting Item above & notify me if there one, then please sign below & initial each Meet	are any additional changes / corrections required	d.	the No openi hardy
	etter will be attached to the Permit Submittal L	Documents for reference purposes.		In add
	ENSED ARCH	ALL ABOVE ITEMS SUBJECT TO PLAN REV	NELL)	Yard
Regards,	* No. C26379 1	302300 10 1240 /(2)	1000	
Nicholas Palter,	Architect, Certified Green Point KNEWAL			o Existin
(License #C 263	79, Exp. 02/28/2019) P. CALIFORNIA			existin PG&E
	0 -1.10			Yes, to
Vivian Linena Ci	FDBI Plan Check Date I	Fred Stump, SFFD Plan Check Date		Passa standa
viviaii riuang, Si	1 1331 FIGH CHECK DARC I	The ording, of TD Flancheck Date		\ \

			Revisions
X			
alter / donzelli design + architecture, inc.			
Hancock St. Francisco, CA 94114 5) 552-0802			
June 30, 2017		2 2 1	
Department of Building Inspection 1660 Mission Street, 2nd Floor			
San Francisco, CA 94103-2414			palter / donzelli
RE: May 24, 2017 Pre-Application Plan Review Attendees: Nick Palter, Architect; Vivian Hua 461~465 Sanchez Street New ADU Remodel / San Francisco, CA Block #3580; Lot #030	ing, DBI; Fred Stump, SFFD		50-B Hancock St. San Francisco, CA 94' (415) 552-0802
Building & Fire Department Plan Review Services:			
The project is a remodel of an existing 4-story wood-find Garage, Utility & Storage areas on the Ground Floor. ADU (accessory dwelling unit) on the Ground Floor in	The proposed work includes creating		
(Note: All drawing references are to drawings, dated	6/30/17 which accompany this le	etter for your use.)	
Based on the 2016 CBC and SF Building Code Amend Code issues which were discussed:	dments, we request confirmation	of the following	
			>
 Use of Information Sheet FS-05 (Sept. 30, 2015): Legalization of Dwelling Unit. 	: Sprinkler System Requirements	for Addition or	REVIEW
 Per Sec. C, as the building is already an R-2 of existing Ground Floor Exit Passageway & ne required to have fire sprinklers installed? 			I RE
Correct, the existing Garage & miscellane place, are not required to have fire sprink		work is taking	AN
	750		1 72

461~465 Sanchez Pre-Application Plan Review MEETING MINUTES
June 30, 2017

may the entire Ground Floor ceiling may be upgraded to 1-hour fire rated construction, pgrading the entire building to 1-hour fire rated construction?

ntire Ground Floor ceiling shall be upgraded to 1-hour fire construction, in lieu of the entire building.

- 8, Maximum Area of Exterior Wall Openings:
 - ting Ground Floor South Facing Windows in Proposed, New ADU (Accessory Dwelling): As they are approximately 4'-1" from the South Property Line & the Unit is aklered, can the (2) existing windows, one in the Kitchen & one in the Bathroom, be ced with new, non-rated, operable, dual glazed windows?

, based on Table 705.8, these windows (up to 15% maximum of the total wall area) allowed to remain un-protected & operable.

JEL___SFFD

- ound Floor Exit Passageway:
- the walls / doors of the existing Exit Passageway required to be upgraded to 1-hour fire

the walls of the existing Exit Passageway & proposed, new Exit Corridor (along North Property Line) shall be upgraded to 1-hour fire construction; all doors ning into these areas shall be upgraded to 45 minute fire rated with self-closing

dition, the existing Ground Floor rear wall of the building (adjacent to the Rear wood egress stairs) shall be upgraded to 1-hour fire construction. JES SFFD

ing Gas / Electric Meters: Are the existing utility meters allowed to remain within the ing Exit Passageway & is their current enclosure required to be upgraded to standard the existing utility meters may remain in their current location within the Exit

sageway & shall be provided with airtight, gypsum board-lined cabinets per PG&E dard requirements. - NEEDS TO RE TNSTALLED 1N

| HR FIRE RATED CLOSET.

A PRE-

STREET 461-465 SANCHEZ 9 MEW ACCESSORY DWELLING USAN FRANCISCO, CA BLOCK #3580; LOT #030

Date: 11/01/17 Scale: 1/4" / FT. Drawn: NP Sheet:

A-0.1

