

SAN FRANCISCO PLANNING DEPARTMENT

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Disclaimer for Review of Plans

The San Francisco Planning Code requires that the plans of certain proposed projects be provided to members of the public prior to the City's approval action on the project. Accordingly, any images of plans featured on this website are provided for the primary purpose of facilitating public input prior to the City's action. The City and County of San Francisco does not own the copyright to these images. Please be aware that the unauthorized reproduction, distribution, or alteration of these images may result in a violation of Federal Copyright Law (17 U.S.C.A. Sections 101 et seq.) and that any party who seeks to reproduce or alter these images does so at his or her own risk.

Additionally, plans provided on this website are limited to site plans, elevations and/or section details (floor plans and structural details may not be included). These are DRAFT PLANS being provided for public review PRIOR to the City's approval action on the project. Final plans may differ from those that are currently available for review.

1650 Mission St. Suite 400 San Francisco, CA 94103-2479

Reception: 415.558.6378

Fax: 415.558.6409

Planning Information: 415.558.6377



SAN FRANCISCO **PLANNING DEPARTMENT**

1650 Mission Street, Suite 400 • San Francisco, CA 94103 • Fax (415) 558-6409

NOTICE OF PUBLIC HEARING

- Time: Location: Case Type:
- Hearing Date: Wednesday, April 26, 2017 Not before 9:30 AM City Hall, 1 Dr. Carlton B. Goodlett Place, Room 408 Variance Hearing Body: Zoning Administrator

PROPERTY INFORMATION

Project Address: Cross Street(s): Block /Lot No.: Zoning District(s): Area Plan:

2125 Hyde Street **Greenwich/Filbert** 0095/031 RM-2/40-X N/A

APPLICATION INFORMATION

Case No.: Building Permit: Applicant: Telephone: E-Mail:

2016-014950VAR 201610140347 Matthew Mo (415) 543-5005 matt@hoodthomas.com

PROJECT DESCRIPTION

The Project proposes the conversion of one existing dwelling unit into three (3) dwelling units. The existing 3-bedroom dwelling unit is located on two floors, with an internal staircase connecting the two floors. The Project involves interior tenant improvements and does not otherwise propose any expansion of the existing building envelope.

PER SECTION 135 OF THE PLANNING CODE the subject property is required to maintain useable open space for each dwelling unit in the following amounts: 80 square feet space if private, or approximately 107 square feet if common. Additionally, any such open spaces must meet the dimensional requirements of Subsections (f) and (g). The project proposes the addition of two (2) dwelling units, therefore the amount of common open space required would be approximately 1,064 square feet. The project provides 782 square feet of common open space that meets the dimensional requirements of the Code, approximately 282 square feet short of the requirement of the Code; therefore, the proposal requires a variance.

PER SECTION 140 OF THE PLANNING CODE each dwelling unit must face directly onto a qualifying street, a Codecomplying rear yard or open area as defined by the Code. As the subject property fronts onto a Code-complying Street (Hyde Street), the existing dwelling unit meets the requirements of the Code Section related to dwelling unit exposure. However, the conversion of the existing dwelling unit into three (3) dwelling units would lead to two (2) units that meet dwelling unit exposure (the two (2) units fronting onto Hyde Street), and one (1) unit that faces onto an open area that does not meet the dimensional requirements of the Code; therefore, the proposal requires a variance.

ADDITIONAL INFORMATION

ARCHITECTURAL PLANS: The site plan and elevations of the proposed project are available on the Planning Department's website at: http://notice.sfplanning.org/2016-014950VAR.pdf

Members of the public are not required to provide personal identifying information when they communicate with the Commission or the Department, All written or oral communications, including submitted personal contact information. may be made available to the public for inspection and copying upon request and may appear on the Department's website or in other public documents.

FOR MORE INFORMATION, PLEASE CONTACT PLANNING DEPARTMENT STAFF: Planner: Nicholas Foster Telephone: (415) 575-9167 E-Mail: nicholas.foster@sfgov.org

GENERAL INFORMATION ABOUT PROCEDURES

HEARING INFORMATION

You are receiving this notice because you are either a property owner or resident that is adjacent to the proposed project or are an interested party on record with the Planning Department. You are not required to take any action. For more information regarding the proposed work, or to express concerns about the project, please contact the Applicant or Planner listed on this notice as soon as possible. Additionally, you may wish to discuss the project with your neighbors and/or neighborhood association, as they may already be aware of the project.

Persons who are unable to attend the public hearing may submit written comments regarding this application to the Planner listed on the front of this notice, Planning Department, 1650 Mission Street, Suite 400, San Francisco, CA 94103, by 5:00 pm the day before the hearing. These comments will be made a part of the official public record and will be brought to the attention of the person or persons conducting the public hearing.

Comments that cannot be delivered by 5:00 pm the day before the hearing may be taken directly to the hearing at the location listed on the front of this notice. Comments received at 1650 Mission Street after the deadline will be placed in the project file, but may not be brought to the attention of the Zoning Administrator at the public hearing.

BUILDING PERMIT APPLICATION INFORMATION

Pursuant to Planning Code Section 311 or 312, the Building Permit Application for this proposal may also be subject to notification of property owners and residents within 150-feet of the subject property.

APPEAL INFORMATION


An appeal of the approval (or denial) of a **Variance application** by the Zoning Administrator may be made to the **Board of Appeals within 10 calendar days** after the Variance Decision Letter is issued by the Zoning Administrator.

An appeal of the approval (or denial) of a **building permit application** by the Planning Commission may be made to the **Board of Appeals within 15 calendar days** after the building permit is issued (or denied) by the Director of the Department of Building Inspection.

Appeals must be submitted in person at the Board's office at 1650 Mission Street, 3rd Floor, Room 304. For further information about appeals to the Board of Appeals, including current fees, contact the Board of Appeals at (415) 575-6880.

GE	NERAL CONSTRUCTION NOTES	GE	NERAL ELE	CTRICAL NO	TES
1. 2. 3. 4. 5. 6. 7. 8.	ALL CONSTRUCTION SHALL CONFORM TO THE 2016 CALIFORNIA BUILDING CODE, AS AMENDED BY THE CITY OF SAN FRANCISCO, AND ANY OTHER GOVERNING CODES, RULES, REGULATION, ORDINANCES, LAWS, ORDER, APPROVALS, ETC. THAT ARE REQUIRED BY PUBLIC AUTHORITIES. IN THE EVENT OF A CONFLICT, THE MOST STRINGENT REQUIREMENTS SHALL APPLY. ANY ERRORS, OMISSIONS, OR CONFLICTS FOUND IN THE VARIOUS PARTS OF THE CONSTRUCTION DOCUMENTS SHALL BE BROUGHT TO THE ATTENTION OF THE ARCHITECT BEFORE PROCEEDING WITH THE WORK. VERIFY ALL DIMENSIONS IN THE FIELD. CARE HAS BEEN TAKEN TO PREPARE THESE DOCUMENTS USING ALL AVAILABLE INFORMATION PROVIDED BY THE OWNER. DIMENSIONS MARED (+/) MAY BE ADJUSTED UP TO 2" AS REQUIRED BY FIELD CONDITIONS. ADJUSTMENTS OF MORE THAN 2" SHALL BE APPROVED BY THE ARCHITECT. DO NOT SCALE DRAWINGS. USE WRITTEN DIMENSIONS IF CONFLICTS EXIST NOTIFY THE ARCHITECT BEFORE PROCEEDING WITH WORK. DIMENSIONS ARE TO FACE OF FINISH UNLESS OTHERWISE NOTED. GENERAL CONTRACTOR IS RESPONSIBLE FOR COORDINATION OF HIS/HER WORK AND THAT OF ALL SUB-CONTRACTORS. VERIFY AND COORDINATE ALL ROUTING OF MECHANICAL, ELECTRICAL AND PLUMBING ITEMS, ROUGH-IN DIMENSIONS, AND REQUIRED CLEARANCES ASSOCIATED WITH THE PROJECT WORK SUCH THAT CONDITIONS. WHERE WORK REQUIRES CUTTING INTO OR DISRUPTION OF EXISTING CONSTRUCTION, THE CONTRACTOR IS RESPONSIBLE FOR PATCHING AND REPAIRING BOTH THE AREA OF WORK AND ITS ADJACENT SURFACES TO MATCH ADJACENT EXISTING SURFACES. PATCHING INCLUDES FINISHED PAINTING OF AREA DISRUPTED. CONTRACTOR SHALL REMOVE EXISTING WALLS AND OTHER ASSOCIATED CONSTRUCTION AS INDICATED ON THE DEMOLITION PLAN BY DASHED LINES. CONTRACTOR SHALL REMOVE EXISTING WALLS AND OTHER ASSOCIATED CONSTRUCTION AS INDICATED ON THE DEMOLITION PLAN BY DASHED LINES. CONTRACTOR SHALL REMOVE EXISTING WALLS AND OTHER ADJACENT SURFACES TO MATCH ADJACENT EXISTING SURFACES. PATCHING INCLUDES FINISHED PAINTING OF AREA DISRUPTED. CONTRACTOR SHALL REMOVE EXISTING WALLS AND OTHER ADJACENT SURFACES TO MATCH ADJACENT EXISTING SURFACES. PATCHING NUCK KIN ANY AREA. DEMOLIT	1. 2. 3. 4. 5. 6. A. 7. 8. 9.	 ROOMS: PROVIDE DUPLEX RECEPTACLES TO COMPLY CURRENT CEC AS AMENDED BY LOCAL BUILDING CODE AS FOLLOWS: A. RECEPTACLES SHALL BE 6'-0" FROM DOOR OPENINGS B. RECEPTACLES SHALL BE SPACED 12'-0" MAXIMUM ALONG WALLS IN HALLWAYS AND IN ROOMS. C. ANY WALL 2'-0" OR GREATER IN LENGTH SHALL HAVE MINIMUM (1) ELECTRICAL OUTLET. D. RECEPTACLES SHALL BE PLACED +12" ABOVE TH FLOOR UNLESS NOTED OTHERWISE. 6. MINIMUM REQUIREMENTS FOR ELECTRICAL WORK AT IN REMODELED KITCHENS & BATHROOMS: PROVIDE DUPL RECEPTACLES IN COMPLIANCE WITH CURRENT CEC AN BUILDING CODE AMENDMENTS AS FOLLOWS: A. RECEPTACLES SHALL BE 4'-0" MINIMUM FORM SINK LOOB. RECEPTACLES SHALL BE 4'-0" MINIMUM FORM SINK LOOB. RECEPTACLES SHALL BE 4'-0" MINIMUM FORM SINK LOOB. RECEPTACLES SHALL BE SPACED 4'-0" MAX. ON CENTER ALONG KITCHEN & BATH COUNTERS. C. PROVIDE GFIC AT RECEPTACLES WHERE REQUINED. ALL KITCHEN COUNTERS WIDER THAN 12" TO HAV RECEPTACLE OUTLETS PER 2010 CEC. 7. KITCHENS SHALL BE PROVIDED WITH AT LEAST (2) 20 A APPLIANCE BRANCH CIRCUITS. 8. RANGES, DISHWASHERS, WASHER & DRYERS, HVAC EOG & GARAGE DOOR OPENERS WHEN INSTALLED, TO BE P WITH DEDICATED CIRCUIT AS REQUIRED BY CODE. 		
10.	LIGHT FIXTURES, FURNISHINGS, DOORS AND MISC. EQUIPMENT. CONTRACTOR SHALL PROVIDE ALL NECESSARY BARRICADES AND OTHER FORMS OF PROTECTION AS REQUIRED TO GUARD THE OWNER, OTHER TENANTS AND THE GENERAL PUBLIC FROM INJURY DUE TO DEMOLITION WORK.		FOR SLEEPING. VERIFY ACCEPTABILITY OF LOCATION MARSHALL / BUILDING INSPECTOR BEFORE INSTALLAT DETECTORS SHALL BE HARDWIRED w/ BATTERY BACK IN ALL SLEEPING ROOMS.		
12. GE 1.	CONTRACTOR SHALL ENSURE THAT DEMOLITION WORK DOES NOT INTERFERE WITH OR PROHIBIT THE CONTINUING OCCUPATION OF ADJACENT DWELLINGS WITHIN THE STRUCTURE. THIS INCLUDES BUT IS NOT LIMITED TO THE SELECTIVE DEMOLITION OF PARTITIONS, ELECTRICAL AND MECHANICAL SYSTEMS, THE CONTRACTOR SHALL INFORM OWNER 72 HOURS IN ADVANCE OF DEMOLITION ACTIVITIES THAT WILL AFFECT NORMAL OPERATION OF BUILDING. CONTRACTOR SHALL REPAIR DAMAGE CAUSED TO ADJACENT FACILITIES BY DEMOLITION WORK. NERAL ENERGY CONSERVATION NOTES EXTERIOR WALL, ROOF & RAISED FLOOR CAVITIES EXPOSED DURING DEMOLITION ARE TO BE INSULATED PER TITLE 24 ENERGY CALCULATIONS AND OR MANDATORY MEASURES PROVIDED WITHIN THIS DRAWING SET. SEE GENERAL INSULATION NOTES BELOW FOR MINIMUM INSULATION REQUIREMENTS SHOULD TITLE 24 ENERGY CALCULATION NOT BE REQUIRED FOR THIS PROJECT.				14.0
GE 1.	EDITION. SEE GENERAL LIGHTING NOTES & ELECTRICAL & LIGHTING PLANS FOR ENERGY CONSERVATION FEATURES. NERAL INSULATION NOTES PROVIDE INSULATION AT ALL EXTERIOR WALLS, FLOORS AND ROOFS WHEN EXPOSED DURING REMODELING PER MINIMUM REQUIREMENTS LISTED BELOW, UNLESS OTHERWISE NOTED IN	8		PACE REQUIREME PRIVATE, COMM	
	TITLE 24 OR SUPPLEMENTAL GREEN COMPLIANCE DOCUMENTATION.				REQUIRED
	R-15 AT 2X4 WALLS R-19 AT 2X6 WALLS AND FLOORS R-30 AT CEILING		EXISTING PROPOSED	8 UNITS 10 UNITS	851.2 SF 1,064 SF
			OPEN SPACE	I	1,102.0 SF

2125 HYDE STREET SAN FRANCISCO CALIFORNIA 94109 NTERIOR ALTERATIONS VARIANCE APPLICATION SET

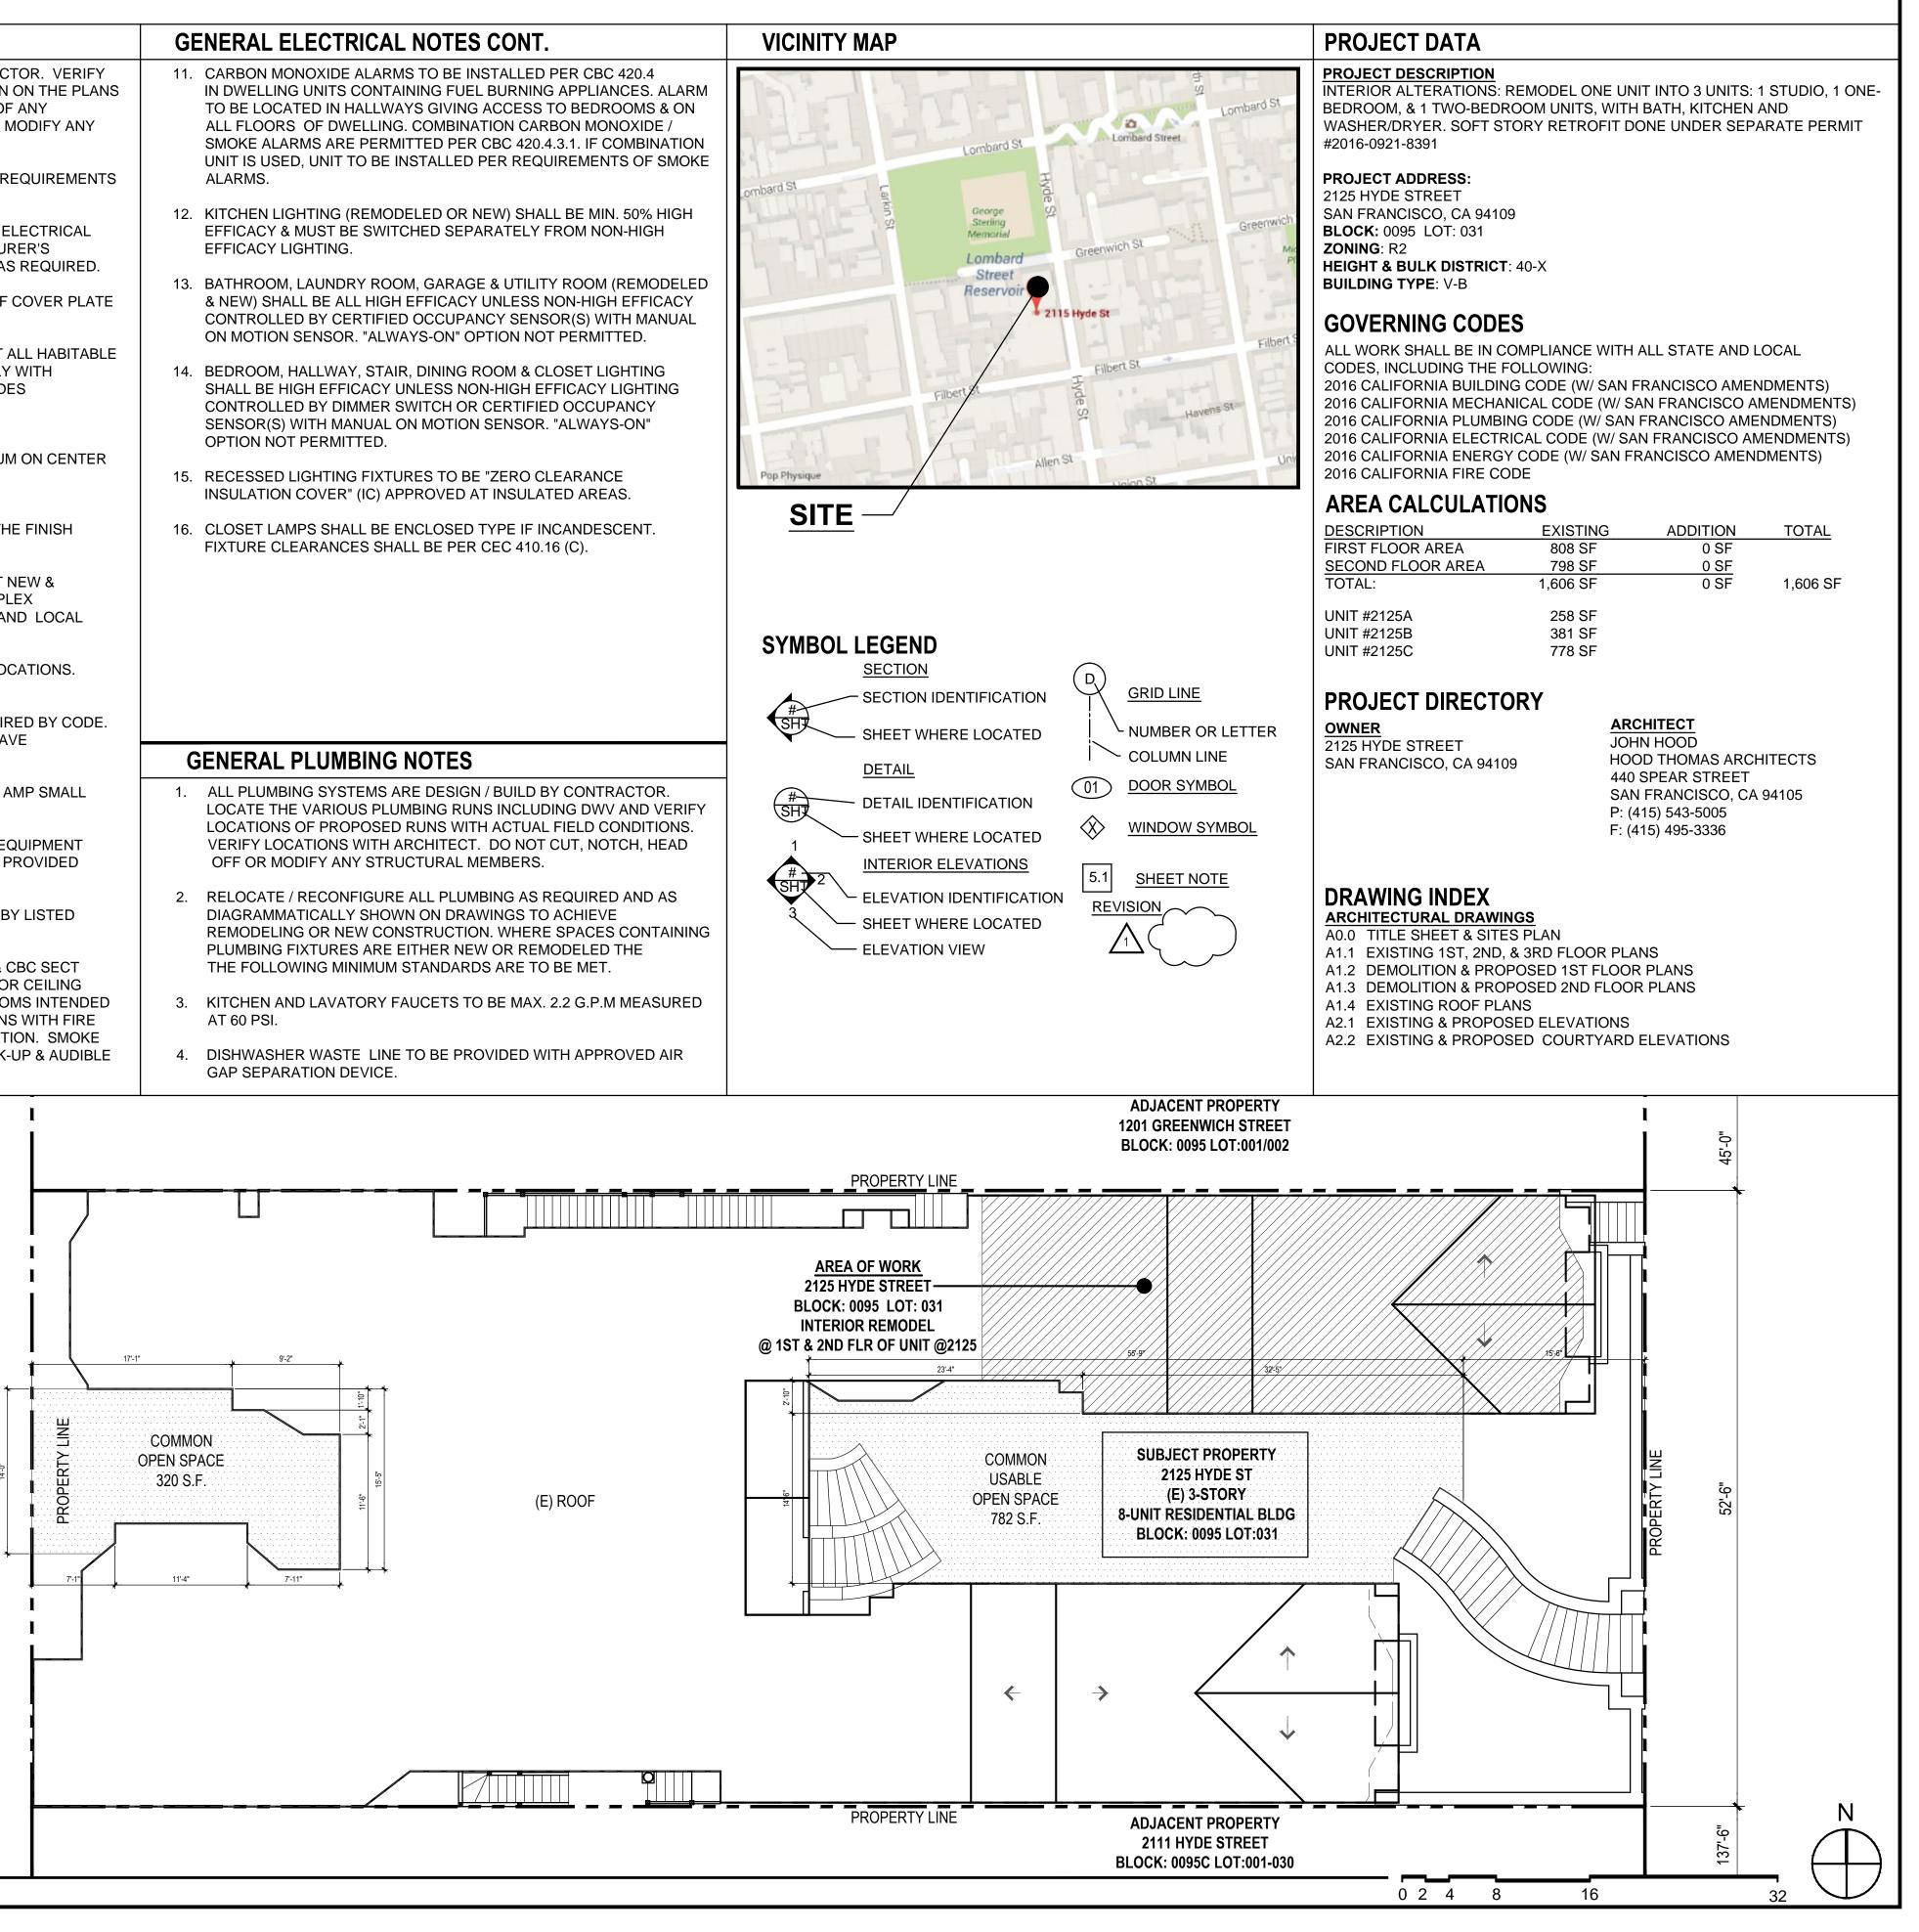



DESCRIPTION	EXISTING	ADDITION	TOTAL
FIRST FLOOR AREA	808 SF	0 SF	
SECOND FLOOR AREA	798 SF	0 SF	
TOTAL:	1,606 SF	0 SF	1,606 SF
UNIT #2125A UNIT #2125B	258 SF 381 SF		





440 SPEAR STREET SAN FRANCISCO, CALIFORNIA 94105 P:(415)543-5005 F:(415)495-3336 WWW.HOODTHOMAS.COM



2125 Hyde St. San Francisco, CA 94109 Block:0095 Lot:031

ISSUE:

DATE:


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DATE: REV # :






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- WALLBOARD AT INTERIOR WALLS AND FACE OF EXTERIOR FINISH AT EXTERIOR WALLS, U.O.N.
- DOORS, WINDOW AND SKYLIGHT PROJECT NOTES
- PRIMARY EXIT DOORS SHALL MEET THE REQUIREMENTS OF CBC SECTION 1008 FOR SIZE, PROJECTIONS INTO CLEAR WIDTH OF EGRESS PATH, DOOR SWING, & OPENING FORCE.
- DOORS SHALL BE PROVIDED WITH A MIN. 36" X 36" LEVEL LANDING ON EACH SIDE OF THE DOORS EXCEPT AS FOLLOWS: LANDINGS AT THE EXTERIOR SIDE OF A DOOR MAY BE A MAX. OF 7 $\frac{3}{4}$ " BELOW THE THRESHOLD PROVIDED THE DOOR DOES NOT SWING OVER THE LANDING. FOR DOORS THAT SWING OVER THE LANDING THE MAX. DISTANCE BELOW THE THRESHOLD IS ¹/₂" PER CBC 1008.1.5. SLIDING GLASS DOORS SHALL HAVE A MAX. ¹" LEVEL CHANGE FROM THRESHOLD.
- DOORWAY BETWEEN GARAGES & HABITABLE SPACE SHALL BE PROVIDED WITH EITHER SOLID WOOD DOORS OR SOLID OR HONEYCOMB CORE STEEL DOORS NOT LESS THAN 1 ³/₈" THICK & PROVIDED WITH SELF CLOSING AND SELF LATCHING H HARDWARE.
- PROVIDE LISTED, GASKETED DOORS w/ LISTED SELF CLOSING DEVICE & BOTTOM SEAL AT THRESHOLD PER CMC 904.1 WHERE COMPARTMENTS CONTAINING FURNACES & BOILERS ARE INSTALLED IN BEDROOMS OR BATHROOMS.
- (N) WINDOWS PER WINDOW SCHEDULE INCLUDED IN THIS DRAWING SET SHALL COMPLY WITH TITLE 24 REQUIREMENTS. SEE SCHEDULE FOR ADDITIONAL NOTES. EMERGENCY ESCAPE & RESCUE WINDOWS REQUIRED AT SLEEPING AREAS SHALL MEET THE FOLLOWING REQUIREMENTS: MIN. 5.7' CLEAR OPENING, MIN. 24" CLEAR HEIGHT, MIN. 20" CLEAR WIDTH, SILL HEIGHT MAX. 44" AFF.



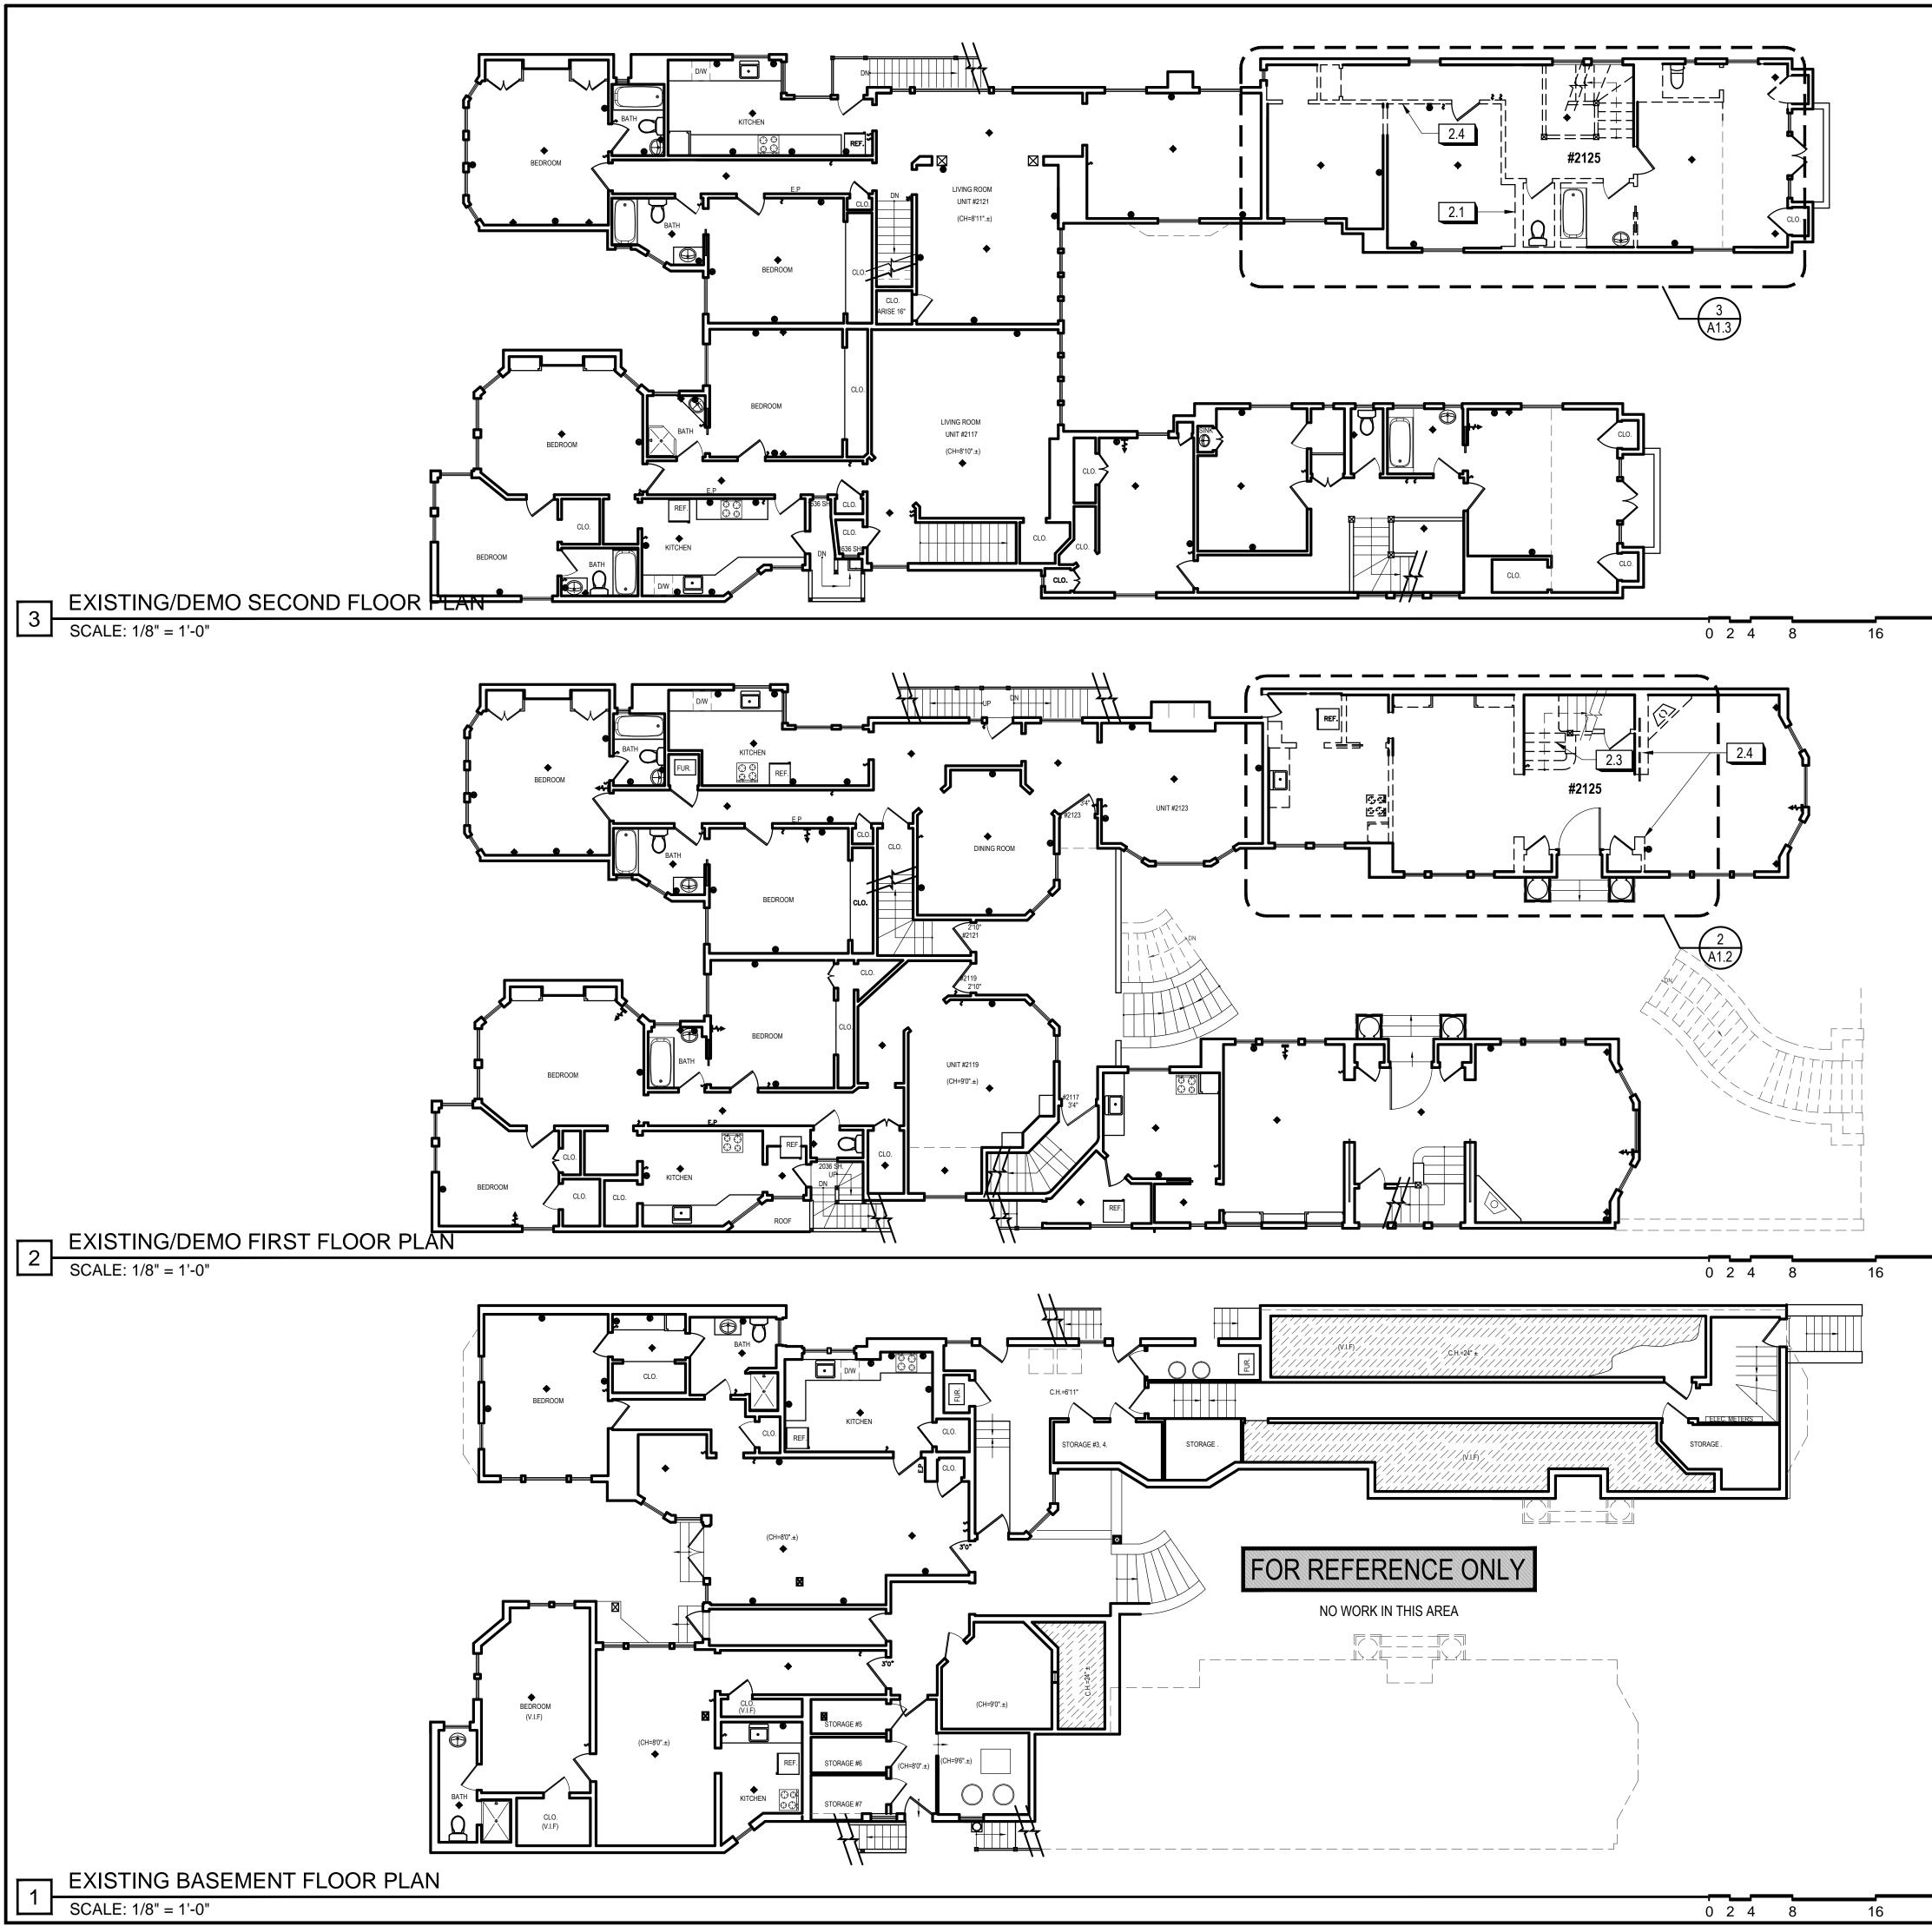

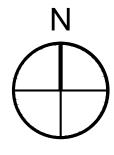

32

W3. WINDOWS IN LOCATIONS SUBJECT TO HUMAN IMPACT LOADS SHALL BE PROVIDED WITH SAFETY GLAZING INSTALLED IN ACCORDANCE WITH CBC 2406 & 2407.

- K1-8 KITCHEN PROJECT NOTES KITCHEN FAUCETS SHALL HAVE A MAX. FLOW RATE OF 1.5 G.P.M MEASURED AT 60 PSI.
- K2. GARBAGE DISPOSAL UNITS AT KITCHEN SINKS SHALL BE PROVIDED WITH REQUIRED AIR GAP. GAS COOKING APPLIANCES SHALL BE UL LISTED & INSTALLED PER MANUF.
- INSTRUCTIONS. PROVIDE GAS SHUT-OFF VALVE IN APPROVED, ACCESSIBLE LOCATION.
- RESIDENTIAL RANGEHOOD EXHAUST PER CMC 403.7. SHALL MEET REQUIREMENTS OF CMC 504.2. EXHAUST TERMINATION SHALL BE LOCATED AT LEAST 3'-0" AWAY FROM PROPERTY LINES AND BUILDING OPENINGS & BE PROVIDED WITH WEATHERPROOF BACKDRAFT DAMPER. WHERE REMOTE EXHAUST OR BOOSTER FANS ARE REQUIRED, FAN SHALL BE ON DEDICATED CIRCUIT.
- UPPER CABINETS SHALL BE MIN. 30" ABOVE COOKING TOP PER CMC 916.1.2. PROVIDE THE COOKING APPLIANCE MIN. CLEARANCE TO COMBUSTIBLES PER CMC.916.1.
- (N) DISHWASHERS SHALL BE PROVIDED WITH REQUIRED AIRGAP, HOT WATER STUB DEDICATED CIRCUIT. (N) APPLIANCES TO BE UL LISTED AND INSTALLED PER MANUF. INSTRUCTIONS.
- INSTALLING CONTRACTOR SHALL COORDINATE ALL ELECTRICAL AND PLUMBING REQUIREMENTS WITH MANUF. SPECIFICATIONS.
- (N) CABINETRY AND NONPOROUS COUNTERTOPS THROUGHOUT, U.O.N.

B1-9 BATHROOM PROJECT NOTES

- (N) NONPOROUS SLAB COUNTERTOP & SPLASH. GLASS SHOWER ENCLOSURES SAFETY GLAZING SUBJECT TO HUMAN IMPACT LOADS INSTALLED IN ACCORDANCE W/ CBC 2406 & 2407. SHOWER DOORS SHALL PROVIDE MIN 22" CLEAR OPENING WIDTH. PER CPC 408.5.
- SHOWER COMPARTMENTS & WALLS ABOVE TUBS w/ SHOWERHEADS SHALL BE FINISHED WITH A SMOOTH NONABSORBENT SURFACE TO A HEIGHT NOT LESS THAN 70" ABOVE DRAIN INLET. CBC 1210.3 NONPAPER-FACED BACKER BOARD TO BE USED IN ALL TUB, SHOWER & SPA
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- PROVIDE EXHAUST FAN CAPABLE OF PROVIDING 5 AIR CHANGES PER HOUR. VENT TO OUTSIDE. PROVIDE BACKDRAFT DAMPER


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- PROVIDE DRAIN PAN @ TANK WATER HEATERS AND CLOTHES WASHERS INSTALLED OVER LIVING SPACE.
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PLAN LEGEND

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Section Stress Existing Wall 그 국 DEMOLISHED WALL



2125 Hyde St. San Francisco, CA 94109 Block:0095 Lot:031

ISSUE:

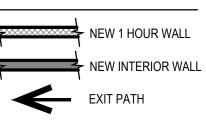DATE:

DRAWN BY:	MM
DATE:	3.15.17
SHEET TITLE:	


EXISTING FLOOR PLANS

SHEET NUMBER:

REV # :





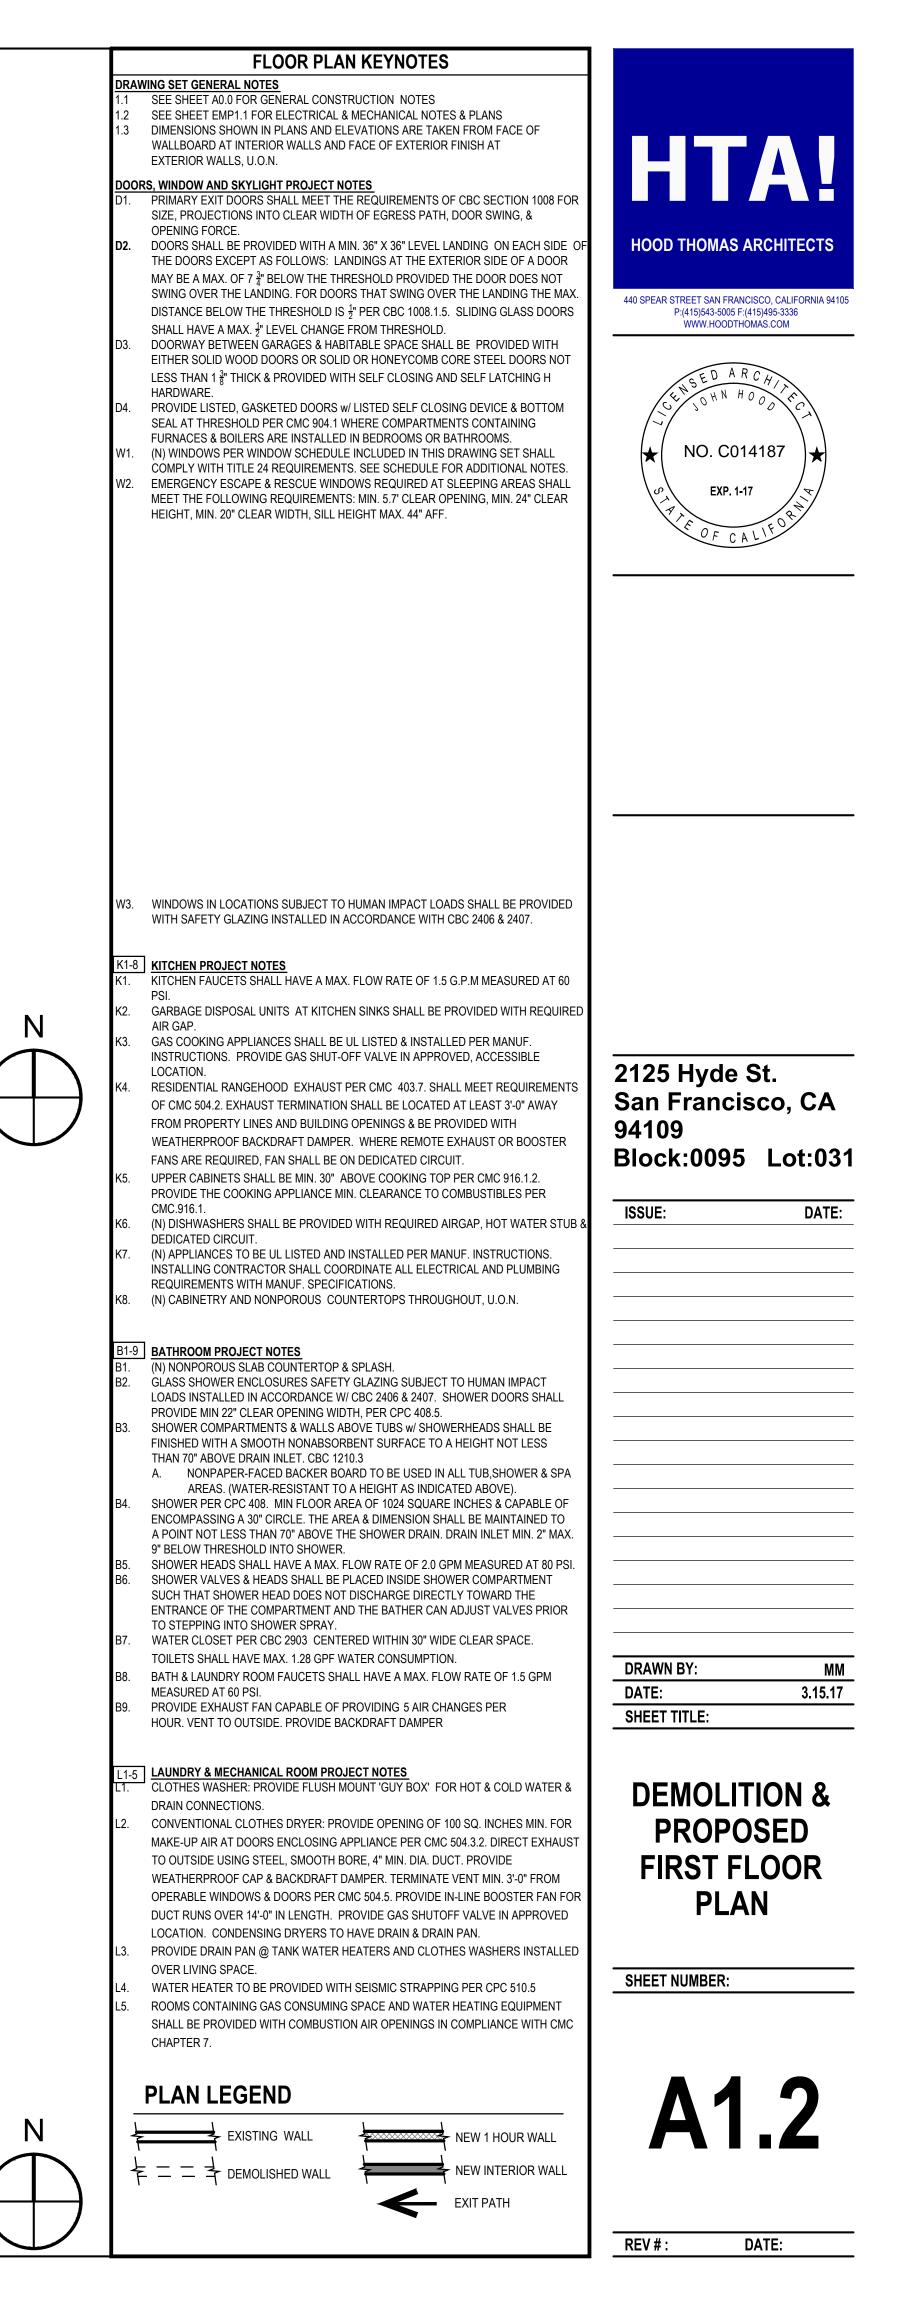



FLOOR PLAN KEYNOTES

- DRAWING SET GENERAL NOTES SEE SHEET A0.0 FOR GENERAL CONSTRUCTION NOTES
- 1.2 SEE SHEET EMP1.1 FOR ELECTRICAL & MECHANICAL NOTES & PLANS DIMENSIONS SHOWN IN PLANS AND ELEVATIONS ARE TAKEN FROM FACE OF
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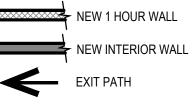
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- MEASURED AT 60 PSI. PROVIDE EXHAUST FAN CAPABLE OF PROVIDING 5 AIR CHANGES PER HOUR. VENT TO OUTSIDE. PROVIDE BACKDRAFT DAMPER
- L1-5 LAUNDRY & MECHANICAL ROOM PROJECT NOTES L1. CLOTHES WASHER: PROVIDE FLUSH MOUNT 'GUY BOX' FOR HOT & COLD WATER & DRAIN CONNECTIONS.
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- PROVIDE DRAIN PAN @ TANK WATER HEATERS AND CLOTHES WASHERS INSTALLED OVER LIVING SPACE. WATER HEATER TO BE PROVIDED WITH SEISMIC STRAPPING PER CPC 510.5
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PLAN LEGEND


= = \neq demolished wall



2125 Hyde St. San Francisco, CA 94109 Block:0095 Lot:031

ISSUE:

DATE:

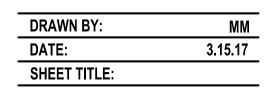


DEMOLITION & PROPOSED 2ND FLOOR PLAN


SHEET NUMBER:



DATE:

Ν

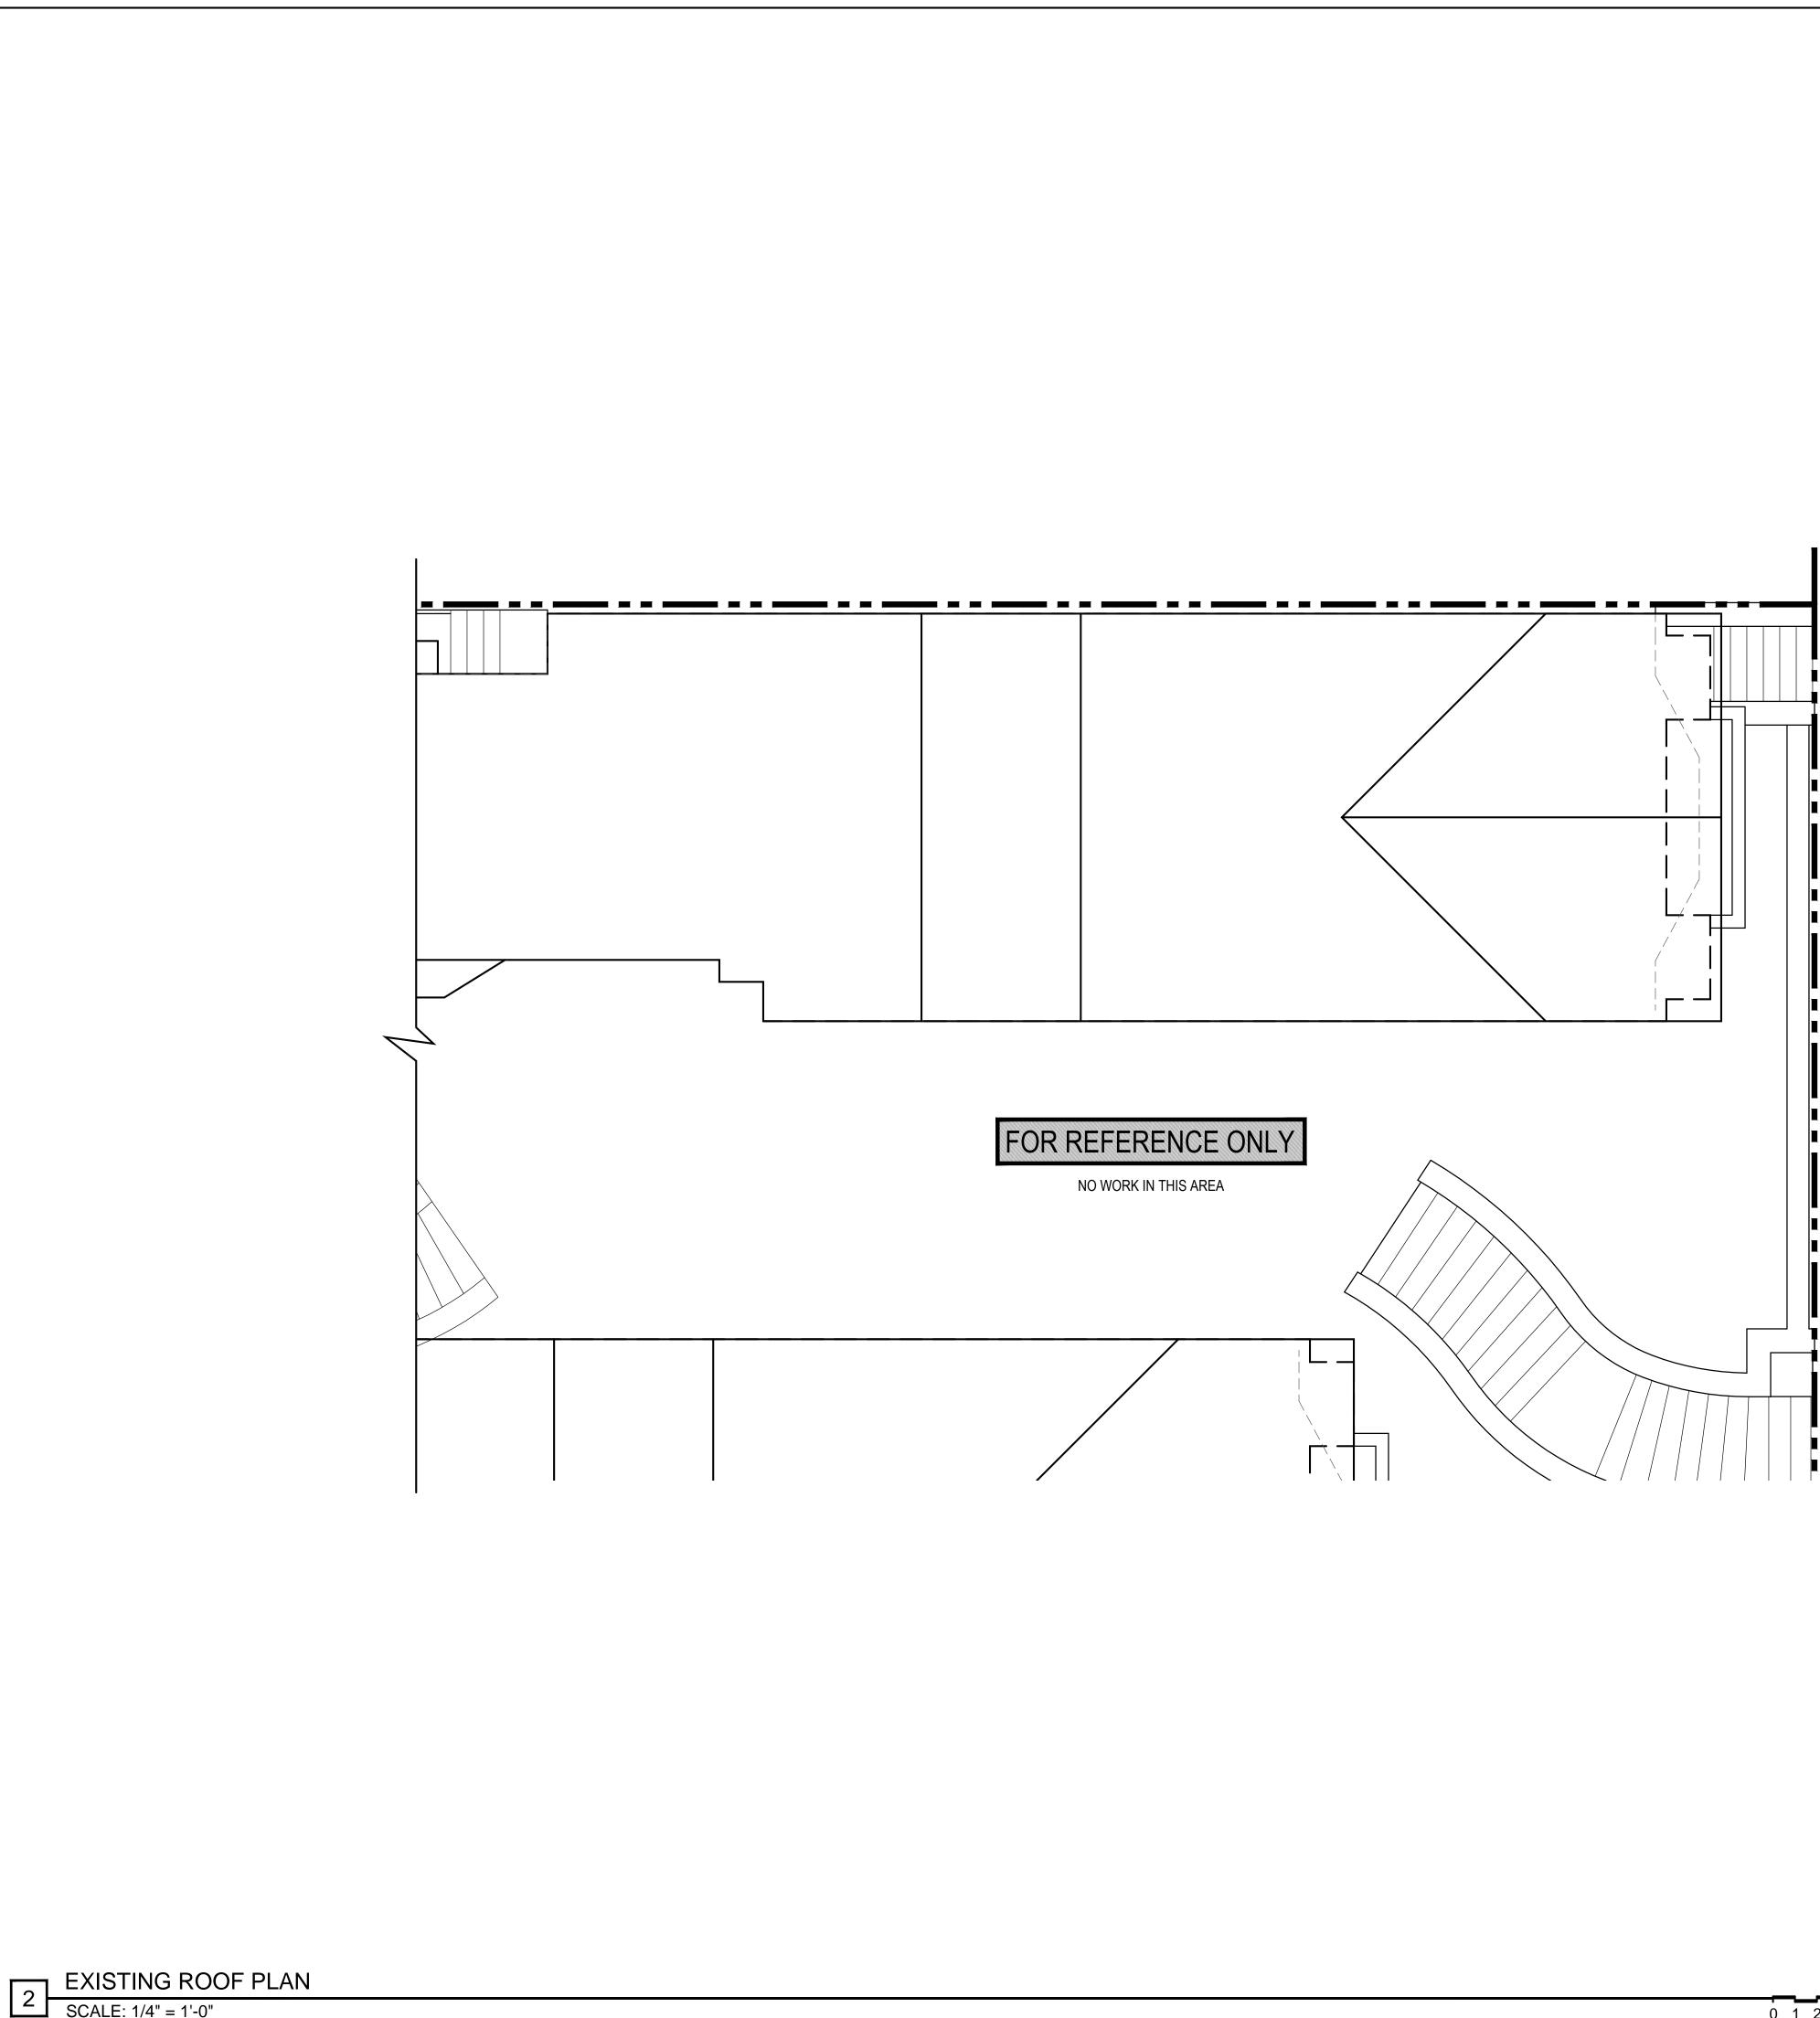

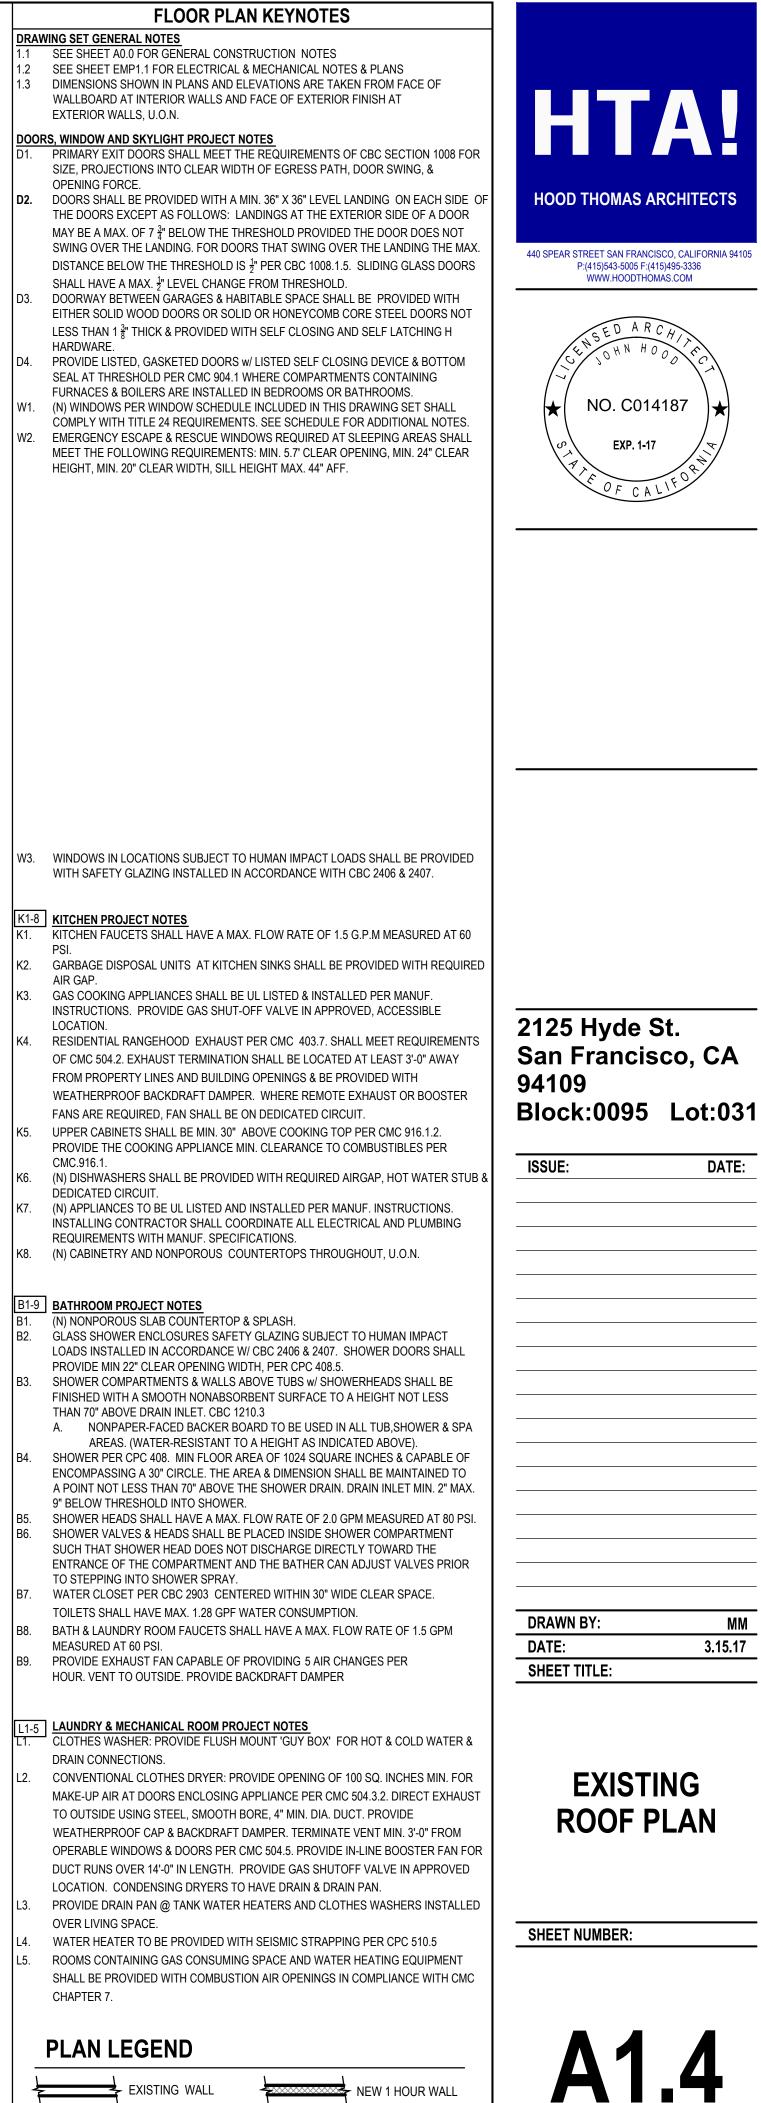

NEW INTERIOR WALL

DATE:


REV # :


EXIT PATH


L3. L4. L5.


 $\Box \equiv \pm 4$ demolished wall

Ν

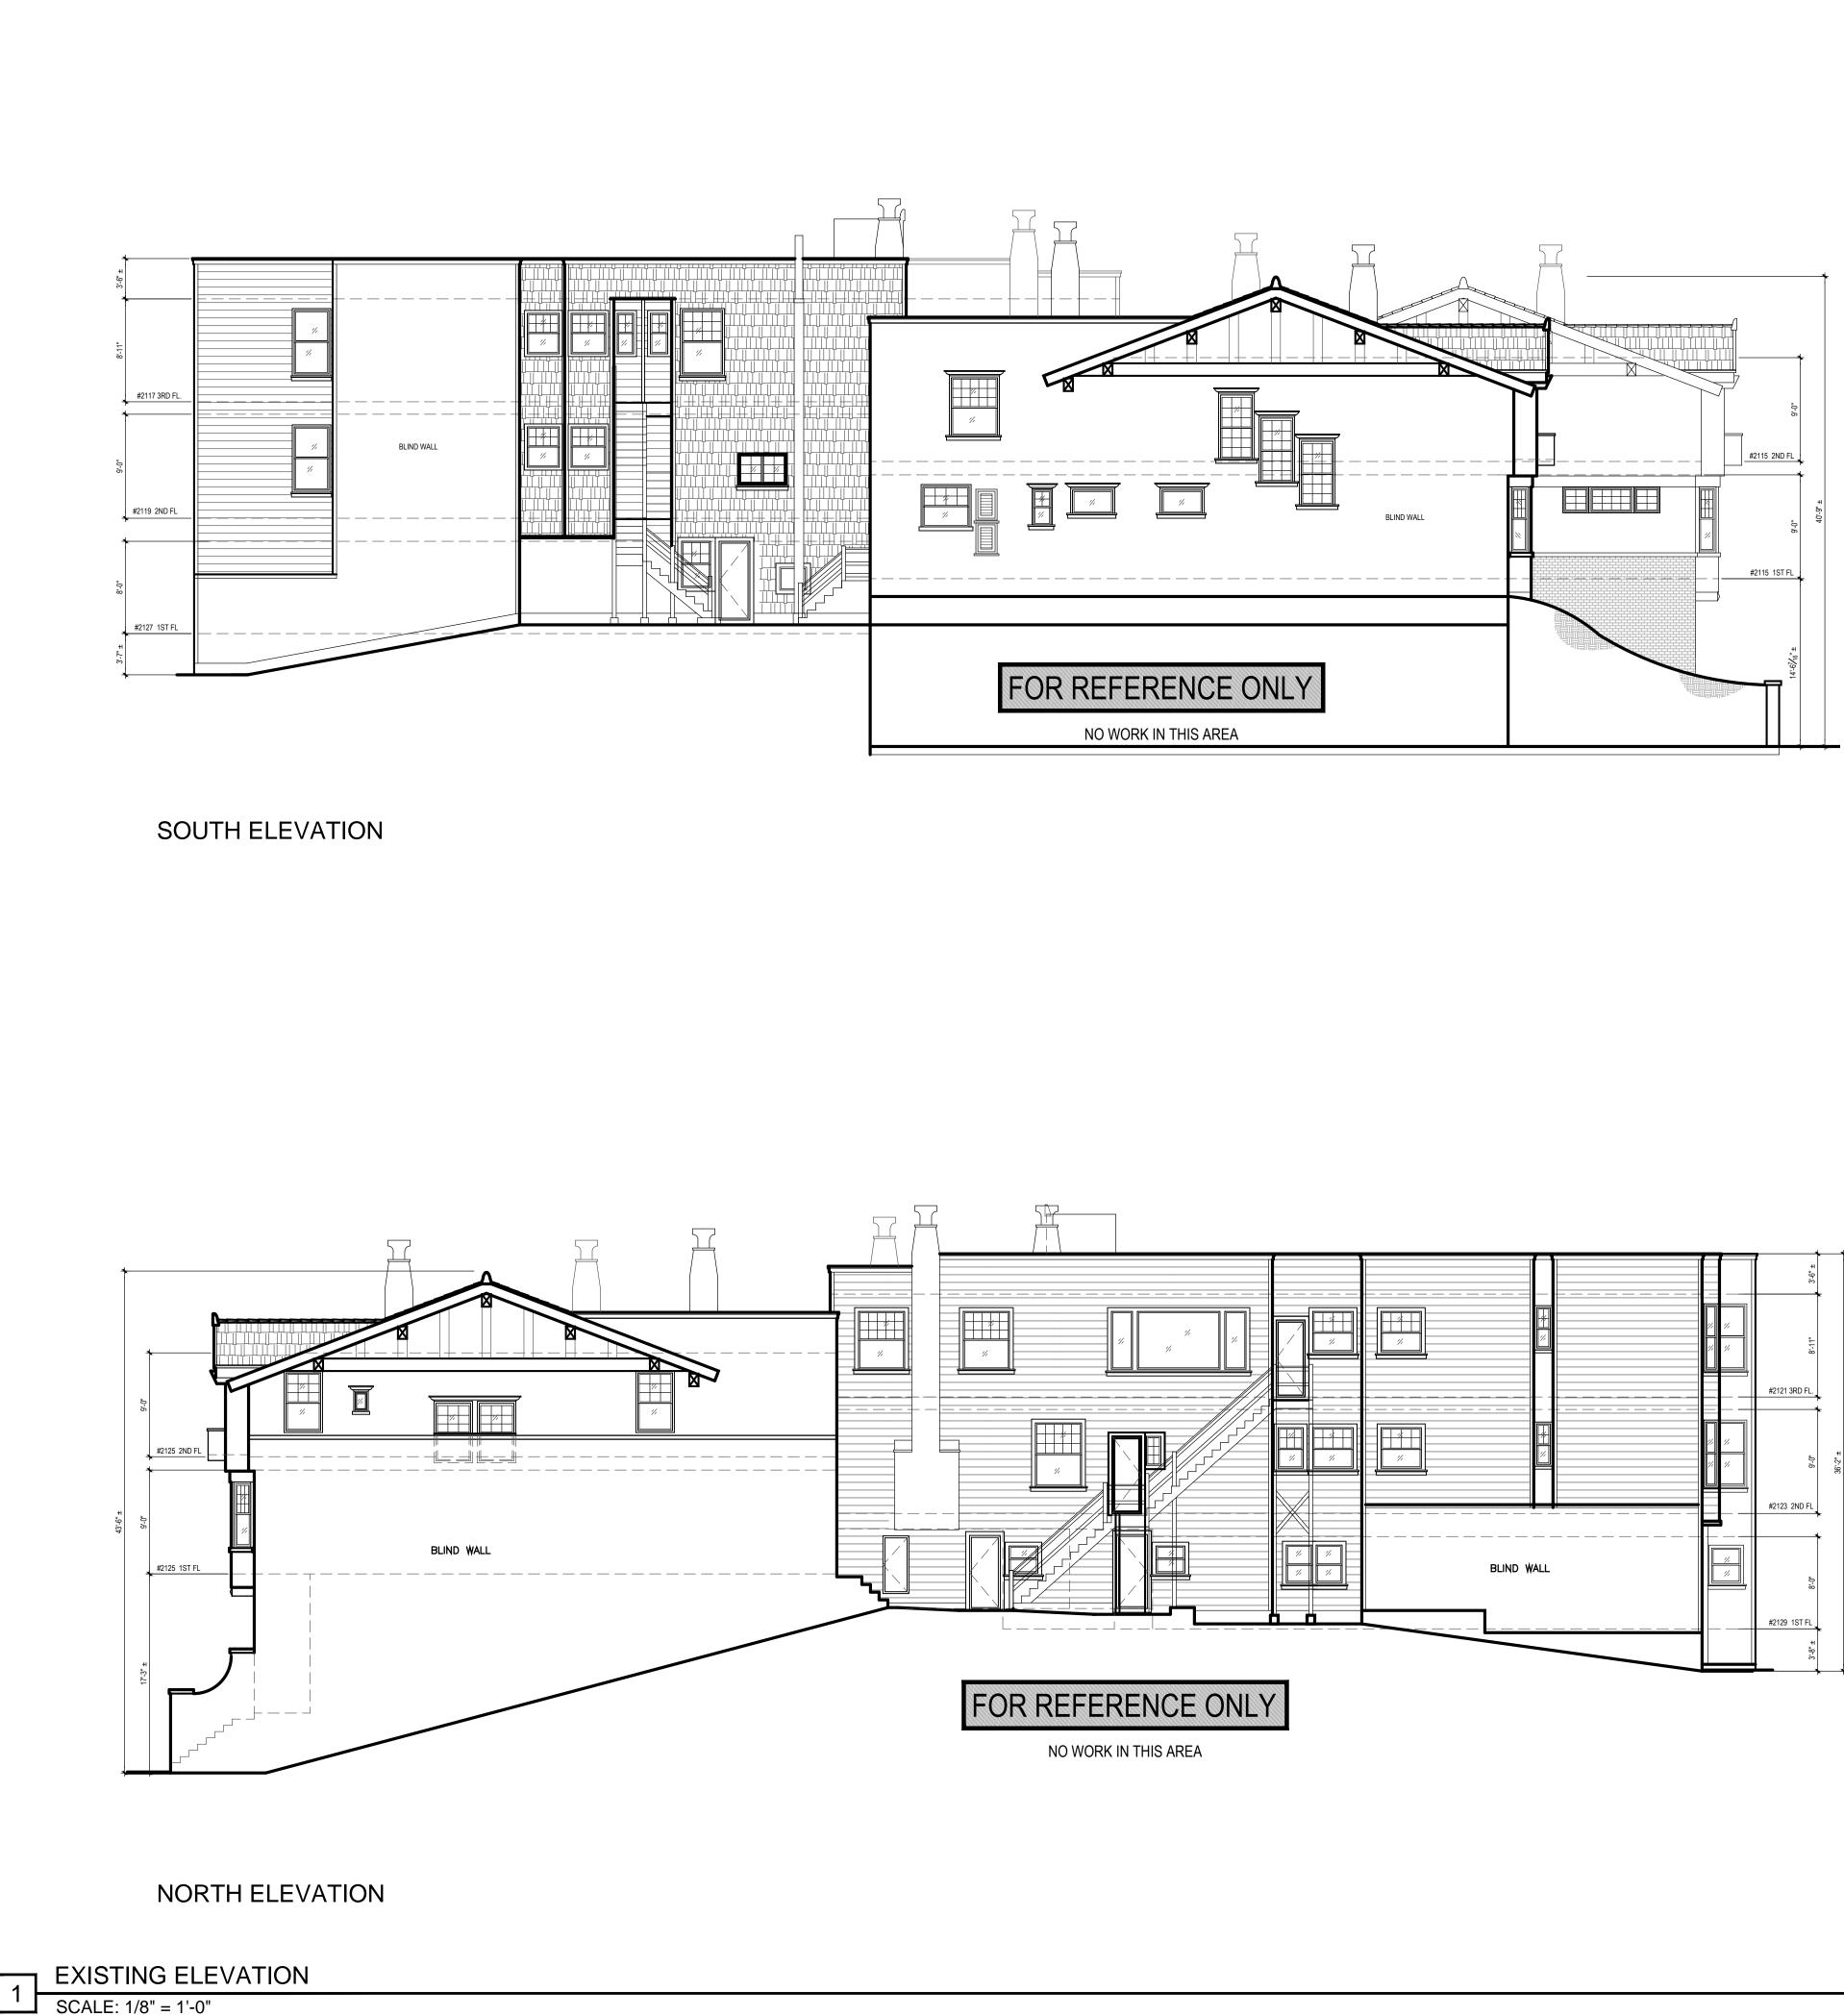

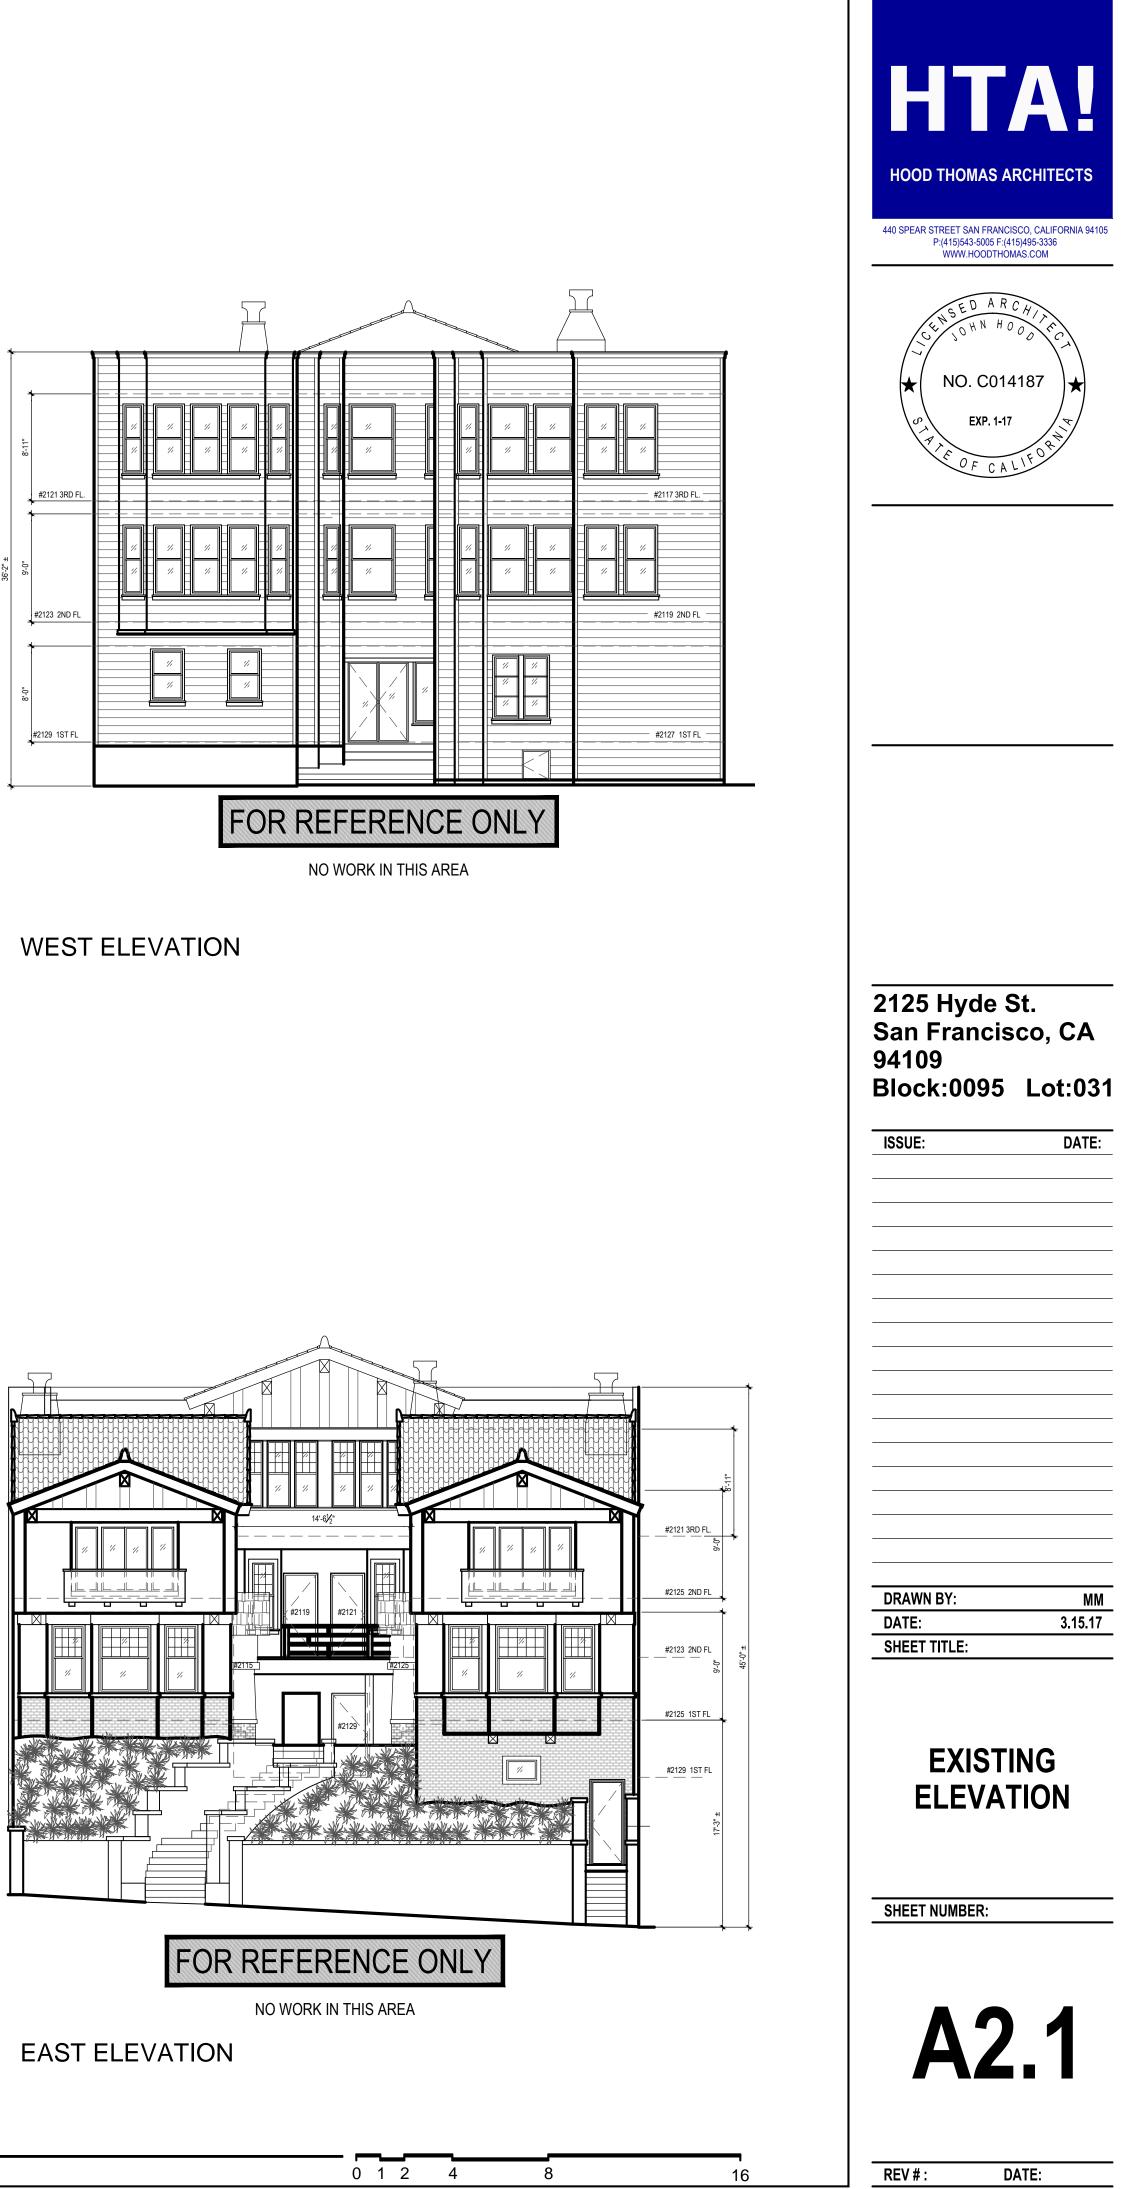

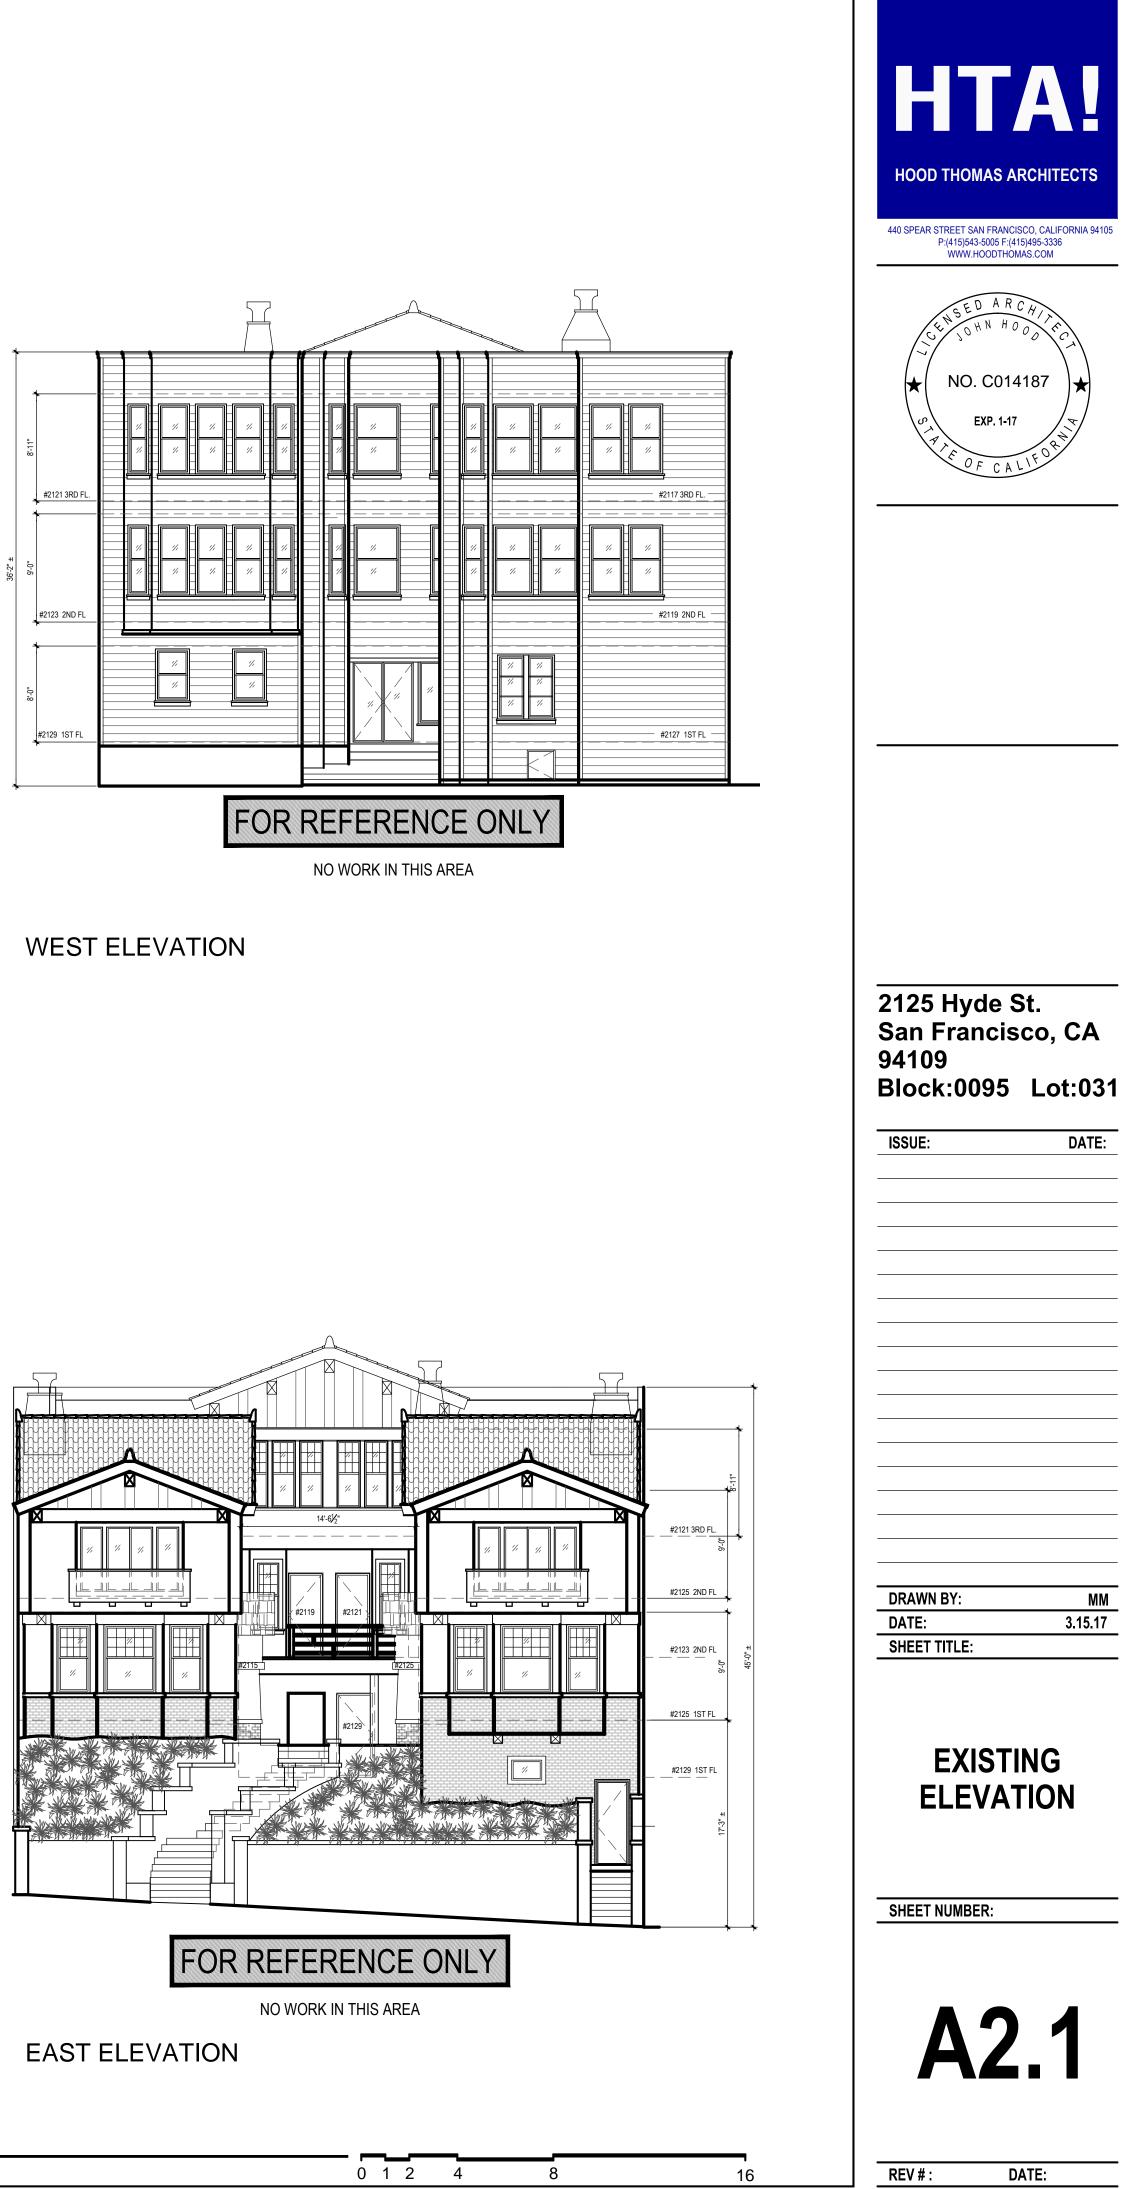


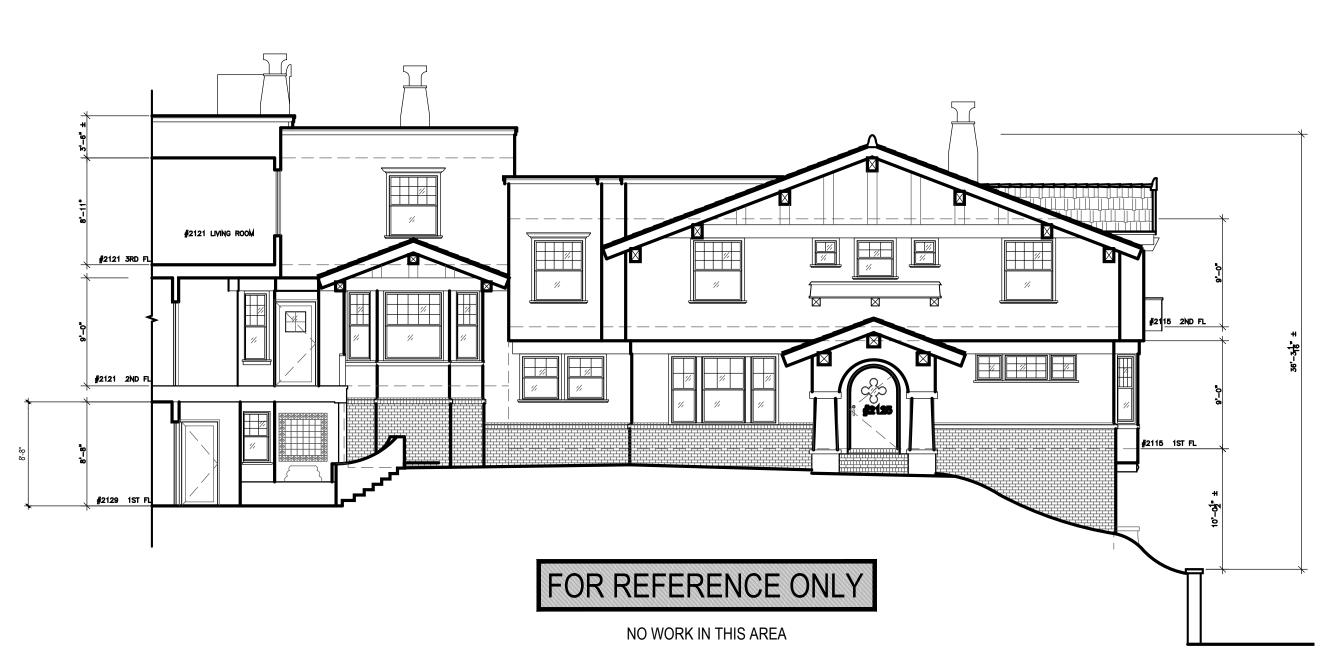


SOUTH ELEVATION

2 EXISTING COURTYARD ELEVATION

SCALE: 1/8" = 1'-0"

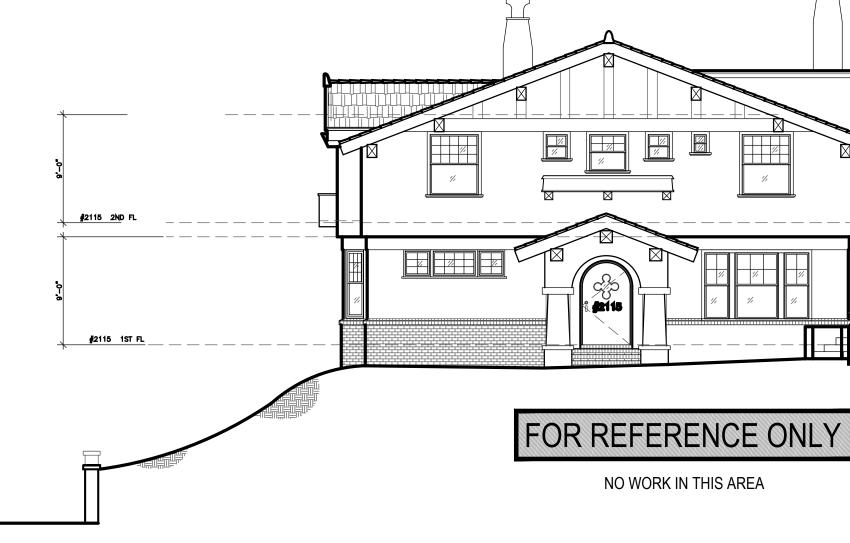



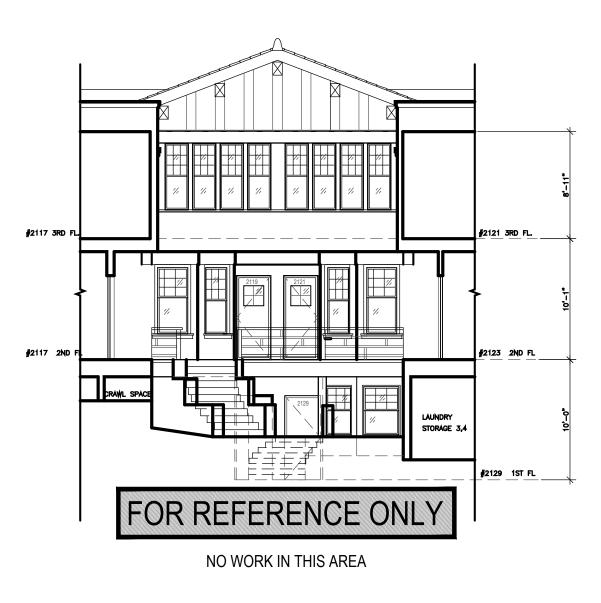

EAST ELEVATION

