

SAN FRANCISCO PLANNING DEPARTMENT

мемо

Disclaimer for Review of Plans

The San Francisco Planning Code requires that the plans of certain proposed projects be provided to members of the public prior to the City's approval action on the project. Accordingly, any images of plans featured on this website are provided for the primary purpose of facilitating public input prior to the City's action. The City and County of San Francisco does not own the copyright to these images. Please be aware that the unauthorized reproduction, distribution, or alteration of these images may result in a violation of Federal Copyright Law (17 U.S.C.A. Sections 101 et seq.) and that any party who seeks to reproduce or alter these images does so at his or her own risk.

Additionally, plans provided on this website are limited to site plans, elevations and/or section details (floor plans and structural details may not be included). These are DRAFT PLANS being provided for public review PRIOR to the City's approval action on the project. Final plans may differ from those that are currently available for review.

1650 Mission St. Suite 400 San Francisco, CA 94103-2479

Reception: 415.558.6378

Fax: 415.558.6409

Planning Information: 415.558.6377



SAN FRANCISCO PLANNING DEPARTMENT

1650 Mission Street, Suite 400 • San Francisco, CA 94103 • Fax (415) 558-6409

APPLICATION INFORMATION

NOTICE OF PUBLIC HEARING

Hearing Date:Wednesday, September 27, 2017Time:Not before 9:30 AMLocation:City Hall, 1 Dr. Carlton B. Goodlett Place, Room 408Case Type:Variance

Hearing Body: Zoning Administrator

PROPERTY INFORMATION

Project Address: 1148 Montgomery Street Case No.: 2016-014090VAR Green & Vallejo Streets Cross Street(s): Building Permit: 2016.09.21.8400 0134/025 Block /Lot No.: Applicant: John Hood Zoning District(s): RH-3 / 40-X Telephone: (415) 385-2303 Area Plan: F-Mail: john@hoodthomas.com N/A

PROJECT DESCRIPTION

The proposal is to add one Accessory Dwelling Unit at the ground floor level of an existing three-story, twounit residential building at the front of the property.

PER SECTION 140 OF THE PLANNING CODE, the subject property is required to have windows of each unit face directly on an open area no less than 25 feet in every horizontal dimension, with an increase of five feet in every horizontal dimension at each subsequent floor immediately above. The dimensions of the open area may be reduced to 15 feet in width and depth for Accessory Dwelling Units. The subject property has two residential buildings, one in the front and one in the rear, that are approximately 7'-4" apart at the widest. The proposed Accessory Dwelling Unit will face onto that area, which is less than the minimum 15 foot by 15 foot open area required for reduced dwelling unit exposure, thereby requiting an exposure variance.

ADDITIONAL INFORMATION

ARCHITECTURAL PLANS: The site plan and elevations of the proposed project are available on the Planning Department's website at: <u>http://notice.sfplanning.org/2016-014090VAR.pdf</u>

Members of the public are not required to provide personal identifying information when they communicate with the Commission or the Department. All written or oral communications, including submitted personal contact information, may be made available to the public for inspection and copying upon request and may appear on the Department's website or in other public documents.

FOR MORE INFORMATION, PLEASE CONTACT PLANNING DEPARTMENT STAFF:Planner:S. SkangosTelephone: (415) 575-8731E-Mail: Stephanie.Skangos@sfgov.org

GENERAL INFORMATION ABOUT PROCEDURES

HEARING INFORMATION

You are receiving this notice because you are either a property owner or resident that is adjacent to the proposed project or are an interested party on record with the Planning Department. You are not required to take any action. For more information regarding the proposed work, or to express concerns about the project, please contact the Applicant or Planner listed on this notice as soon as possible. Additionally, you may wish to discuss the project with your neighbors and/or neighborhood association, as they may already be aware of the project.

Persons who are unable to attend the public hearing may submit written comments regarding this application to the Planner listed on the front of this notice, Planning Department, 1650 Mission Street, Suite 400, San Francisco, CA 94103, by 5:00 pm the day before the hearing. These comments will be made a part of the official public record and will be brought to the attention of the person or persons conducting the public hearing.

Comments that cannot be delivered by 5:00 pm the day before the hearing may be taken directly to the hearing at the location listed on the front of this notice. Comments received at 1650 Mission Street after the deadline will be placed in the project file, but may not be brought to the attention of the Zoning Administrator at the public hearing.

BUILDING PERMIT APPLICATION INFORMATION

Pursuant to Planning Code Section 311 or 312, the Building Permit Application for this proposal may also be subject to notification of property owners and residents within 150-feet of the subject property.

APPEAL INFORMATION

An appeal of the approval (or denial) of a **Variance application** by the Zoning Administrator may be made to the **Board of Appeals within 10 calendar days** after the Variance Decision Letter is issued by the Zoning Administrator.

An appeal of the approval (or denial) of a **building permit application** by the Planning Commission may be made to the **Board of Appeals within 15 calendar days** after the building permit is issued (or denied) by the Director of the Department of Building Inspection.

Appeals must be submitted in person at the Board's office at 1650 Mission Street, 3rd Floor, Room 304. For further information about appeals to the Board of Appeals, including current fees, contact the Board of Appeals at (415) 575-6880.

1148 MONTGOMERY STREET INTERIOR & EXTERIOR ALTERATIONS 1148 MONTGOMERY STREET | SAN FRANCISCO | CALIFORNIA - VARIANCE APPLICATION -

OFF OR MODIFY ANY STRUCTURAL MEMBERS.

ALL PLUMBING SYSTEMS ARE DESIGN / BUILD BY CONTRACTOR.

LOCATE THE VARIOUS PLUMBING RUNS INCLUDING DWV AND VERIFY

LOCATIONS OF PROPOSED RUNS WITH ACTUAL FIELD CONDITIONS.

VERIFY LOCATIONS WITH ARCHITECT. DO NOT CUT, NOTCH, HEAD

RELOCATE / RECONFIGURE ALL PLUMBING AS REQUIRED AND AS

REMODELING OR NEW CONSTRUCTION. WHERE SPACES CONTAINING

KITCHEN AND LAVATORY FAUCETS TO BE MAX. 2.2 G.P.M MEASURED

DIAGRAMMATICALLY SHOWN ON DRAWINGS TO ACHIEVE

THE FOLLOWING MINIMUM STANDARDS ARE TO BE MET.

WATER CLOSETS HAVE MAX. 1.6 GPF WATER CONSUMPTION.

PRESSURE BALANCE OR THERMOSTATIC MIX TYPE.

SHOWER HEADS NOT TO EXCEED 2.5 GPM MEASURED AT 80 PSI.

SHOWER VALVES & HEADS SHALL BE PLACED INSIDE SHOWER

SHOWERS & TUBS TO HAVE INDIVIDUAL CONTROL VALVES OF THE

COMPARTMENT SUCH THAT SHOWER HEAD DOES NOT DISCHARGE

BATHER CAN ADJUST VALVES PRIOR TO STEPPING INTO SHOWER

DISHWASHER WASTE LINE TO BE PROVIDED WITH APPROVED AIR

HOSE BIBBS TO HAVE APPROVED BACK-FLOW PREVENTION DEVICE.

10. PROVIDE SEISMIC BRACING FOR WATER HEATERS IN ACCORDANCE

1. ALL MECHANICAL WORK IS DESIGN / BUILD BY CONTRACTOR.

BEFORE INITIATING ANY MECHANICAL SYSTEM WORK.

3. ALL NEW FAU'S TO BE RATED FOR THEIR SPECIFIC LOCATION.

FAU'S & SPACES CONTAINING THEM PER UMC.

VERIFY LOCATION OF EQUIPMENT AND FIXTURES AS SHOWN ON

THE PLANS WITH ACTUAL FIELD CONDITIONS. NOTIFY ARCHITECT

OF ANY DISCREPANCIES. DO NOT CUT, NOTCH, HEAD OFF OR

TELEPHONE / CATV / SPEAKER REQUIREMENTS WITH OWNER

MODIFY ANY STRUCTURAL MEMBERS. VERIFY ALL ELECTRICAL /

2. PROVIDE MINIMUM 100 S.I. COMBUSTION AIR AT NEW & REMODELED

4. NEW & REMODELED BATHROOMS TO BE PROVIDED WITH EXHAUST FAN CAPABLE OF PROVIDING 5 AIR CHANGES PER HOUR. VENT

TO OUTSIDE PER CMC 504.5. PROVIDE BACK-DRAFT DAMPER.

5. TYPE B GAS VENTS, WHEN INSTALLED AS PART OF THIS PROJECT

6. RANGEHOOD, BATH VENTILATION EXHAUST, DRYER EXHAUST &

BUILDING PER CMC 504.5. TERMINATE AT LEAST 3'-0" FROM

7. INTERSTITIAL SPACES SHALL NOT BE USED TO SUPPLY OR RETURN

PROPERTY LINE & 3'-0" FROM OPENINGS INTO BUILDINGS.

SIMILAR ENVIRONMENTAL DUCTS TO TERMINATE AT EXTERIOR OF

DIRECTLY TOWARD THE ENTRANCE OF THE COMPARTMENT AND THE

PLUMBING FIXTURES ARE EITHER NEW OR REMODELED THE

GENERAL CONSTRUCTION NOTES

- 1. ALL CONSTRUCTION SHALL CONFORM TO THE 2013 CALIFORNIA BUILDING CODE, AS AMENDED BY THE CITY OF SAN FRANCISCO, AND ANY OTHER GOVERNING CODES, RULES, REGULATION, ORDINANCES, LAWS, ORDER, APPROVALS, ETC. THAT ARE REQUIRED BY PUBLIC AUTHORITIES. IN THE EVENT OF A CONFLICT, THE MOST STRINGENT REQUIREMENTS SHALL APPLY.
- 2. ANY ERRORS, OMISSIONS, OR CONFLICTS FOUND IN THE VARIOUS PARTS OF THE CONSTRUCTION DOCUMENTS SHALL BE BROUGHT TO THE ATTENTION OF THE ARCHITECT BEFORE PROCEEDING WITH THE WORK.
- VERIFY ALL DIMENSIONS IN THE FIELD. CARE HAS BEEN TAKEN TO PREPARE THESE DOCUMENTS USING ALL AVAILABLE INFORMATION PROVIDED BY THE OWNER. DIMENSIONS MARKED (+/-) MAY BE ADJUSTED UP TO 2" AS REQUIRED BY FIELD CONDITIONS. ADJUSTMENTS OF MORE THAN 2" SHALL BE APPROVED BY THE ARCHITECT. DO NOT SCALE DRAWINGS. USE WRITTEN DIMENSIONS IF CONFLICTS EXIST NOTIFY THE ARCHITECT BEFORE PROCEEDING WITH WORK. DIMENSIONS ARE TO FACE OF FINISH UNLESS OTHERWISE NOTED.
- GENERAL CONTRACTOR IS RESPONSIBLE FOR COORDINATION OF HIS WORK AND THAT OF ALL SUB-CONTRACTORS. VERIFY AND COORDINATE ALL ROUTING OF MECHANICAL, ELECTRICAL AND PLUMBING ITEMS, ROUGH-IN DIMENSIONS, AND REQUIRED CLEARANCES ASSOCIATED WITH THE PROJECT WORK SUCH THAT CONFLICTS DO NOT OCCUR. NOTIFY ARCHITECT OF PROBLEMATIC CONDITIONS.
- 5. WHERE WORK REQUIRES CUTTING INTO OR DISRUPTION OF EXISTING CONSTRUCTION, THE CONTRACTOR IS RESPONSIBLE FOR PATCHING AND REPAIRING BOTH THE AREA OF WORK AND ITS A ADJACENT SURFACES TO MATCH ADJACENT EXISTING SURFACES. PATCHING INCLUDES FINISHED PAINTING OF AREA DISRUPTED.
- 6. CONTRACTOR SHALL REMOVE EXISTING WALLS AND OTHER ASSOCIATED CONSTRUCTION AS INDICATED ON THE DEMOLITION PLAN BY DASHED LINES.
- 7. CONTRACTOR TO VERIFY ALL CONDITIONS BEFORE PROCEEDING WITH DEMOLITION WORK IN ANY AREA. DEMOLITION OF DOORS, WINDOWS, CABINETRY, FINISHES, PARTITIONS OR ANY OTHER NONSTRUCTURAL ITEMS MAY PROCEED AS INDICATED. WHERE DISCREPANCIES INVOLVE STRUCTURAL ITEMS, REPORT SUCH DIFFERENCES TO THE ARCHITECT AND SECURE INSTRUCTIONS BEFORE PROCEEDING IN THE AFFECTED AREA.
- 8. SEE ELECTRICAL POWER & LIGHTING DRAWINGS FOR EXTENT OF (N) LIGHTING TO BE INSTALLED. CONTRACTOR TO REMOVE CEILING PLASTER AS REQUIRED FOR INSTALLATION OF PROPOSED LIGHTING.
- 9. CONTRACTOR SHALL COORDINATE WITH OWNER THE SALVAGE OF LIGHT FIXTURES, FURNISHINGS, DOORS AND MISC, EQUIPMENT,
- 10. CONTRACTOR SHALL PROVIDE ALL NECESSARY BARRICADES AND OTHER FORMS OF PROTECTION AS REQUIRED TO GUARD THE OWNER. OTHER TENANTS AND THE GENERAL PUBLIC FROM INJURY DUE TO DEMOLITION WORK.
- 11. CONTRACTOR SHALL ENSURE THAT DEMOLITION WORK DOES NOT INTERFERE WITH OR PROHIBIT THE CONTINUING OCCUPATION OF ADJACENT DWELLINGS WITHIN THE STRUCTURE. THIS INCLUDES BUT IS NOT LIMITED TO THE SELECTIVE DEMOLITION OF PARTITIONS, ELECTRICAL AND MECHANICAL SYSTEMS. THE CONTRACTOR SHALL INFORM OWNER 72 HOURS IN ADVANCE OF DEMOLITION ACTIVITIES THAT WILL AFFECT NORMAL OPERATION OF BUILDING.
- 12. CONTRACTOR SHALL REPAIR DAMAGE CAUSED TO ADJACENT FACILITIES BY DEMOLITION WORK.

GENERAL STRUCTURAL NOTES

- 1. STRUCTURAL OBSERVATION SHALL BE REQUIRED BY THE ENGINEER FOR STRUCTURAL CONFORMANCE TO THE APPROVED PLANS.
- 2. SEE STRUCTURAL DRAWINGS FOR ADDITIONAL NOTES & REQUIREMENTS.

GENERAL ENERGY CONSERVATION NOTES

- 1. EXTERIOR WALL, ROOF & RAISED FLOOR CAVITIES EXPOSED DURING DEMOLITION ARE TO BE INSULATED PER TITLE 24 ENERGY CALCULATIONS AND OR MANDATORY MEASURES PROVIDED WITHIN THIS DRAWING SET. SEE GENERAL INSULATION NOTES BELOW FOR MINIMUM INSULATION REQUIREMENTS SHOULD TITLE 24 ENERGY CALCULATION NOT BE REQUIRED FOR THIS PROJECT.
- 2. ALL LIGHTING TO COMPLY WITH CCR TITLE 24, LATEST EDITION. SEE GENERAL LIGHTING NOTES & ELECTRICAL & LIGHTING PLANS FOR ENERGY CONSERVATION FEATURES.

GENERAL INSULATION NOTES

- 1. PROVIDE INSULATION AT ALL EXTERIOR WALLS, FLOORS AND ROOFS WHEN EXPOSED DURING REMODELING PER MINIMUM REQUIREMENTS LISTED BELOW, UNLESS OTHERWISE NOTED IN TITLE 24 OR SUPPLEMENTAL GREEN COMPLIANCE DOCUMENTATION.
 - R-15 AT 2X4 WALLS R-19 AT 2X6 WALLS AND FLOORS **R-30 AT CEILING**

GENERAL ELECTRICAL NOTES

- 1. ALL ELECTRICAL WORK IS DESIGN/BUILD BY CONTRACTOR. VERIFY LOCATIONS OF EQUIPMENT AND FIXTURES AS SHOWN ON THE PLANS W/ ACTUAL FIELD CONDITIONS. NOTIFY ARCHITECT OF ANY DISCREPANCIES. DO NOT CUT NOTCH, HEAD OFF OR MODIFY ANY STRUCTURAL MEMBERS.
- 2. VERIFY ELECTRICAL / TELEPHONE / CATV / SPEAKER REQUIREMENTS WITH OWNER BEFORE INITIATING ANY WORK.
- 3. ELECTRICAL CONTRACTOR SHALL PROVIDE PROPER ELECTRICAL SERVICE TO ALL APPLIANCES. CONSULT MANUFACTURER'S INSTALLATION INSTRUCTIONS AND SPECIFICATIONS AS REQUIRED.
- 4. INSTALL THERMOSTATS AT 64" FROM CENTERLINE OF COVER PLATE TO FINISH FLOOR. MECHANICAL SUB-CONTRACTOR TO VERIFY LOCATIONS WITH OWNER.
- 5. MINIMUM REQUIREMENTS FOR ELECTRICAL WORK AT ALL HABITABLE ROOMS: PROVIDE DUPLEX RECEPTACLES TO COMPLY WITH CURRENT CEC AS AMENDED BY LOCAL BUILDING CODES AS FOLLOWS:
- A. RECEPTACLES SHALL BE 6'-0" FROM DOOR **OPENINGS**
- RECEPTACLES SHALL BE SPACED 12'-0" MAXIMUM ON CENTER B. ALONG WALLS IN HALLWAYS AND IN ROOMS.
- C. ANY WALL 2'-0" OR GREATER IN LENGTH SHALL
- HAVE MINIMUM (1) ELECTRICAL OUTLET. D. RECEPTACLES SHALL BE PLACED +12" ABOVE THE FINISH FLOOR UNLESS NOTED OTHERWISE.
- 6. MINIMUM REQUIREMENTS FOR ELECTRICAL WORK AT NEW & REMODELED KITCHENS & BATHROOMS: PROVIDE DUPLEX RECEPTACLES IN COMPLIANCE WITH CURRENT CEC AND LOCAL BUILDING CODE AMENDMENTS AS FOLLOWS:
- Α. RECEPTACLES SHALL BE 4'-0" MINIMUM FORM SINK LOCATIONS. RECEPTACLES SHALL BE SPACED 4'-0" MAX. ON R
- CENTER ALONG KITCHEN & BATH COUNTERS.
- PROVIDE GFIC AT RECEPTACLES WHERE REQUIRED BY CODE. C. D. ALL KITCHEN COUNTERS WIDER THAN 12" TO HAVE RECEPTACLE OUTLETS PER 2010 CEC.
- 7. PROVIDE 20 AMP BRANCH CIRCUITS TO SERVE BATHROOM RECEPTACLES OUTLETS PER CEC 210.11.
- 8. PROVIDE 20 BRANCH CIRCUITS TO SERVE LAUNDRY ROOM RECEPTACLE OUTLETS PER CEC 210.11.
- 9. KITCHENS SHALL BE PROVIDED WITH AT LEAST (2) 20 AMP SMALL SMALL APPLIANCE BRANCH CIRCUITS.
- 10. RANGES, DISHWASHERS, WASHER & DRYERS, HVAC EQUIPMENT & GARAGE DOOR OPENERS WHEN INSTALLED. TO BE PROVIDED WITH DEDICATED CIRCUIT AS REQUIRED BY CODE.
- 11. BEDROOMS BRANCH CIRCUITS SHALL BE PROTECTED BY LISTED ARC FAULT CIRCUIT INTERRUPTER PER CEC 210.12.
- 12. INSTALL HARDWIRED SMOKE DETECTORS CRC & CBC SECT 907.2.11.2 AT EACH FLOOR OR RESIDENCE ON WALL OR CEILING GIVING ACCESS TO SLEEPING AREAS AND INSIDE ROOMS INTENDED FOR SLEEPING. VERIFY ACCEPTABILITY OF LOCATIONS WITH FIRE MARSHALL / BUILDING INSPECTOR BEFORE INSTALLATION. SMOKE DETECTORS SHALL BE HARDWIRED w/ BATTERY BACK-UP & AUDIBLE IN ALL SLEEPING ROOMS.
- 13. CARBON MONOXIDE ALARMS TO BE INSTALLED PER CBC 420.4 IN DWELLING UNITS CONTAINING FUEL BURNING APPLIANCES. ALARM TO BE LOCATED HALLWAYS GIVING ACCESS TO BEDROOMS & ON ALL FLOORS OF DWELLING. COMBINATION CARBON MONOXIDE / SMOKE ALARMS ARE PERMITTED PER CBC 420.4.3.1. IF COMBINATION UNIT IS USED, UNIT TO BE INSTALLED PER REQUIREMENTS OF SMOKE ALARMS.
- 14. KITCHEN LIGHTING (REMODELED OR NEW) SHALL BE MIN. 50% HIGH EFFICACY & MUST BE SWITCHED SEPARATELY FROM NON-HIGH EFFICACY LIGHTING.
- 15. BATHROOM, LAUNDRY ROOM, GARAGE & UTILITY ROOM (REMODELED & NEW) SHALL BE ALL HIGH EFFICACY UNLESS NON-HIGH EFFICACY CONTROLLED BY CERTIFIED OCCUPANCY SENSOR(S) WITH MANUAL ON MOTION SENSOR. "ALWAYS-ON" OPTION NOT PERMITTED.
- 16. BEDROOM, HALLWAY, STAIR, DINING ROOM & CLOSET LIGHTING SHALL BE HIGH EFFICACY UNLESS NON-HIGH EFFICACY LIGHTING CONTROLLED BY DIMMER SWITCH OR CERTIFIED OCCUPANCY SENSOR(S) WITH MANUAL ON MOTION SENSOR. "ALWAYS-ON" OPTION NOT PERMITTED.
- 17. LIGHT FIXTURES IN TUB, SHOWER OR ANY OTHER LOCATION SUBJECT TO WATER SPRAY SHALL BE LABELED "SUITABLE FOR WET LOCATION".
- 18. OUTDOOR LIGHTING SHALL BE HIGH EFFICACY UNLESS LIGHTING IS CONTROLLED BY CERTIFIED MOTION SENSORS & PHOTOCONTROL OF LANDSCAPE LIGHTING (NOT ATTACHED TO BUILDINGS).
- 19. RECESSED LIGHTING FIXTURES TO BE "ZERO CLEARANCE INSULATION COVER" (IC) APPROVED AT INSULATED AREAS.
- 20. CLOSET LAMPS SHALL BE ENCLOSED TYPE IF INCANDESCENT. FIXTURE CLEARANCES SHALL BE PER CEC 410.16 (C).

GENERAL PLUMBING NOTES

AT 60 PSI.

SPRAY.

WITH CPC 510.


GAP SEPARATION DEVICE.

TO BE PER CMC 802.6

FORCED AIR.

11. ALL COLD WATER PIPES TO BE INSULATED.

GENERAL MECHANICAL NOTES

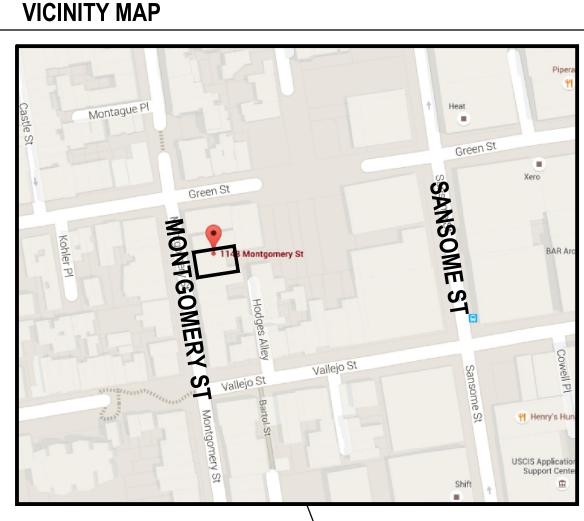



SYMBOL LEGEND SECTION GRID LINE SECTION IDENTIFICATION SHT SHEET WHERE LOCATED COLUMN LINE DETAIL DOOR SYMBOL * SHZ — DETAIL IDENTIFICATION ⟨X⟩ WINDOW SYMBOL SHEET WHERE LOCATED **INTERIOR ELEVATIONS** (# SHT 2 5.1 SHEET NOTE - ELEVATION IDENTIFICATION REVISION - SHEET WHERE LOCATED - ELEVATION VIEW

DRAWING INDEX

- **ARCHITECTURAL DRAWINGS** A0.0 COVER SHEET
- A0.1 SITE PLAN
- A1.1 EXISTING & PROPOSED BASEMENT FLOOR PLANS
- A1.2 EXISTING & PROPOSED 1ST FLOOR PLANS A1.3 EXISTING & PROPOSED 2ND FLOOR (FOR REFERENCE ONLY)
- A1.4 EXISTING & PROPOSED ROOF PLANS (FOR REFERENCE ONLY)
- A2.1 EXISTING FRONT & REAR EXTERIOR ELEVATIONS
- A2.2 PROPOSED REAR EXTERIOR ELEVATION A2.3 EXISTING SIDE ELEVATION
- A2.4 EXISTING SIDE ELEVATION
- A2.5 EXISTING REAR BUILDING FRONT ELEVATION

- NUMBER OR LETTER



PROJECT DATA

PROJECT DESCRIPTION

VARIANCE APPLICATION TO APPROVE CREATION OF ADU THAT DOES NOT COMPLY WITH MIN. 15' IN EACH DIRECTION FOR OPEN SPACE THAT PROVIDES UNIT EXPOSURE TO UNIT. VARIANCE ALSO REQUESTS APPROVAL OF PROJECT THAT DOES NOT PROVIDE REQUIRED USABLE OPEN SPACE.

REVISION TO BUILDING PERMIT 2015-0804-3285 /R1

UNFINISHED SPACE PREVIOUSLY APPROVED TO BECOME A HABITABLE ADDITION TO THE 2ND FLOOR UNIT TO BE BUILT AS ADU WITH NO CONNECTION TO THE UNIT ABOVE, ADU TO HAVE 1 BEDROOM, 1 BATH. KITCHEN, LAUNDRY AND LIVING AREA.

UNIT AT 2ND FLOOR TO BE REMODELED TO ADD (N) BEDROOM & LAUNDRY & RELOCATE KITCHEN.

NO NEW WORK AT 3RD FLOOR UNIT, EXTERIOR STAIRS AND ROOF/ROOF DECK OTHER THAN WORK PREVIOUSLY APPROVED UNDER PERMIT 2015-0804-3285 /R1, SHOWN IN THIS SET FOR REFERENCE PURPOSES.

SEISMIC UPGRADE PROPOSED IN PREVIOUS PERMIT TO BE REVISED PER STRUCTURAL ENGINEERING DRAWINGS CONTAINED WITHIN.

BUILDING TO BE PROVIDED WITH AUTOMATIC FIRE SPRINKLER SYSTEM UNDER SEPARATE, DEFERRED BUILDING PERMIT.

PROJECT ADDRESS: 1148 MONTGOMERY STREET SAN FRANCISCO, CA 94133

BLOCK: 0134 LOT: 025 **ZONING:** RH-3 (RESIDENTIAL- HOUSE, THREE FAMILY) HEIGHT & BULK DISTRICT: 40-X **BUILDING TYPE:** V-B

GOVERNING CODES

ALL WORK SHALL BE IN COMPLIANCE WITH ALL STATE AND LOCAL CODES, INCLUDING THE FOLLOWING:

2013 CALIFORNIA BUILDING CODE (W/ SAN FRANCISCO AMENDMENTS) 2013 CALIFORNIA MECHANICAL CODE (W/ SAN FRANCISCO AMENDMENTS) 2013 CALIFORNIA PLUMBING CODE (W/ SAN FRANCISCO AMENDMENTS) 2013 CALIFORNIA ELECTRICAL CODE (W/ SAN FRANCISCO AMENDMENTS) 2013 CALIFORNIA ENERGY CODE (W/ SAN FRANCISCO AMENDMENTS) 2013 CALIFORNIA FIRE CODE

AREA CALCULATIONS

DESCRIPTION	EXISTING	PROPOSED	ADDITION
FRONT BLDG			
BASEMENT HABITABLE 1ST FLOOR 2ND FLOOR (APPROVED UNDER PRE	1,027 S.F. 1,288 S.F.	1,027 S.F. 1,212 S.F.	0 S.F.
ROOF DECK (APPROVED UNDER PRE		408 S.F. NG PERMIT)	408 S.F.
USABLE OUTDOOR SPA (2) EXISTING UNITS (1) PROPOSED UNIT TOTAL REQUIRED:	REQUIRES:		
TOTAL PROVIDED:		408 S.F.	

PROJECT DIRECTORY

OWNER 1148 MONTGOMERY STREET, LLC 1148 MONTGOMERY STREET SAN FRANCISCO, CA 94133

ARCHITECT JOHN HOOD HOOD THOMAS ARCHITECTS 440 SPEAR STREET SAN FRANCISCO, CA 94105 P: (415) 543-5005 F: (415) 495-3336

HTAL

HOOD THOMAS ARCHITECTS

440 SPEAR STREET SAN FRANCISCO, CALIFORNIA 94105 P:(415)543-5005 F:(415)495-3336 WWW.HOODTHOMAS.COM



1148 Montgomery St. San Francisco, CA 94133


Block: 0134 Lot: 025

SSUE:	DATE
LDG. PERMIT APP.	09.19.1
ARIANCE APP.	03.01.1
ARIANCE APP.	08.18.1

DRAWN BY:	MM, DF
DATE:	03.01.17
SHEET TITLE:	




SHEET NUMBER:

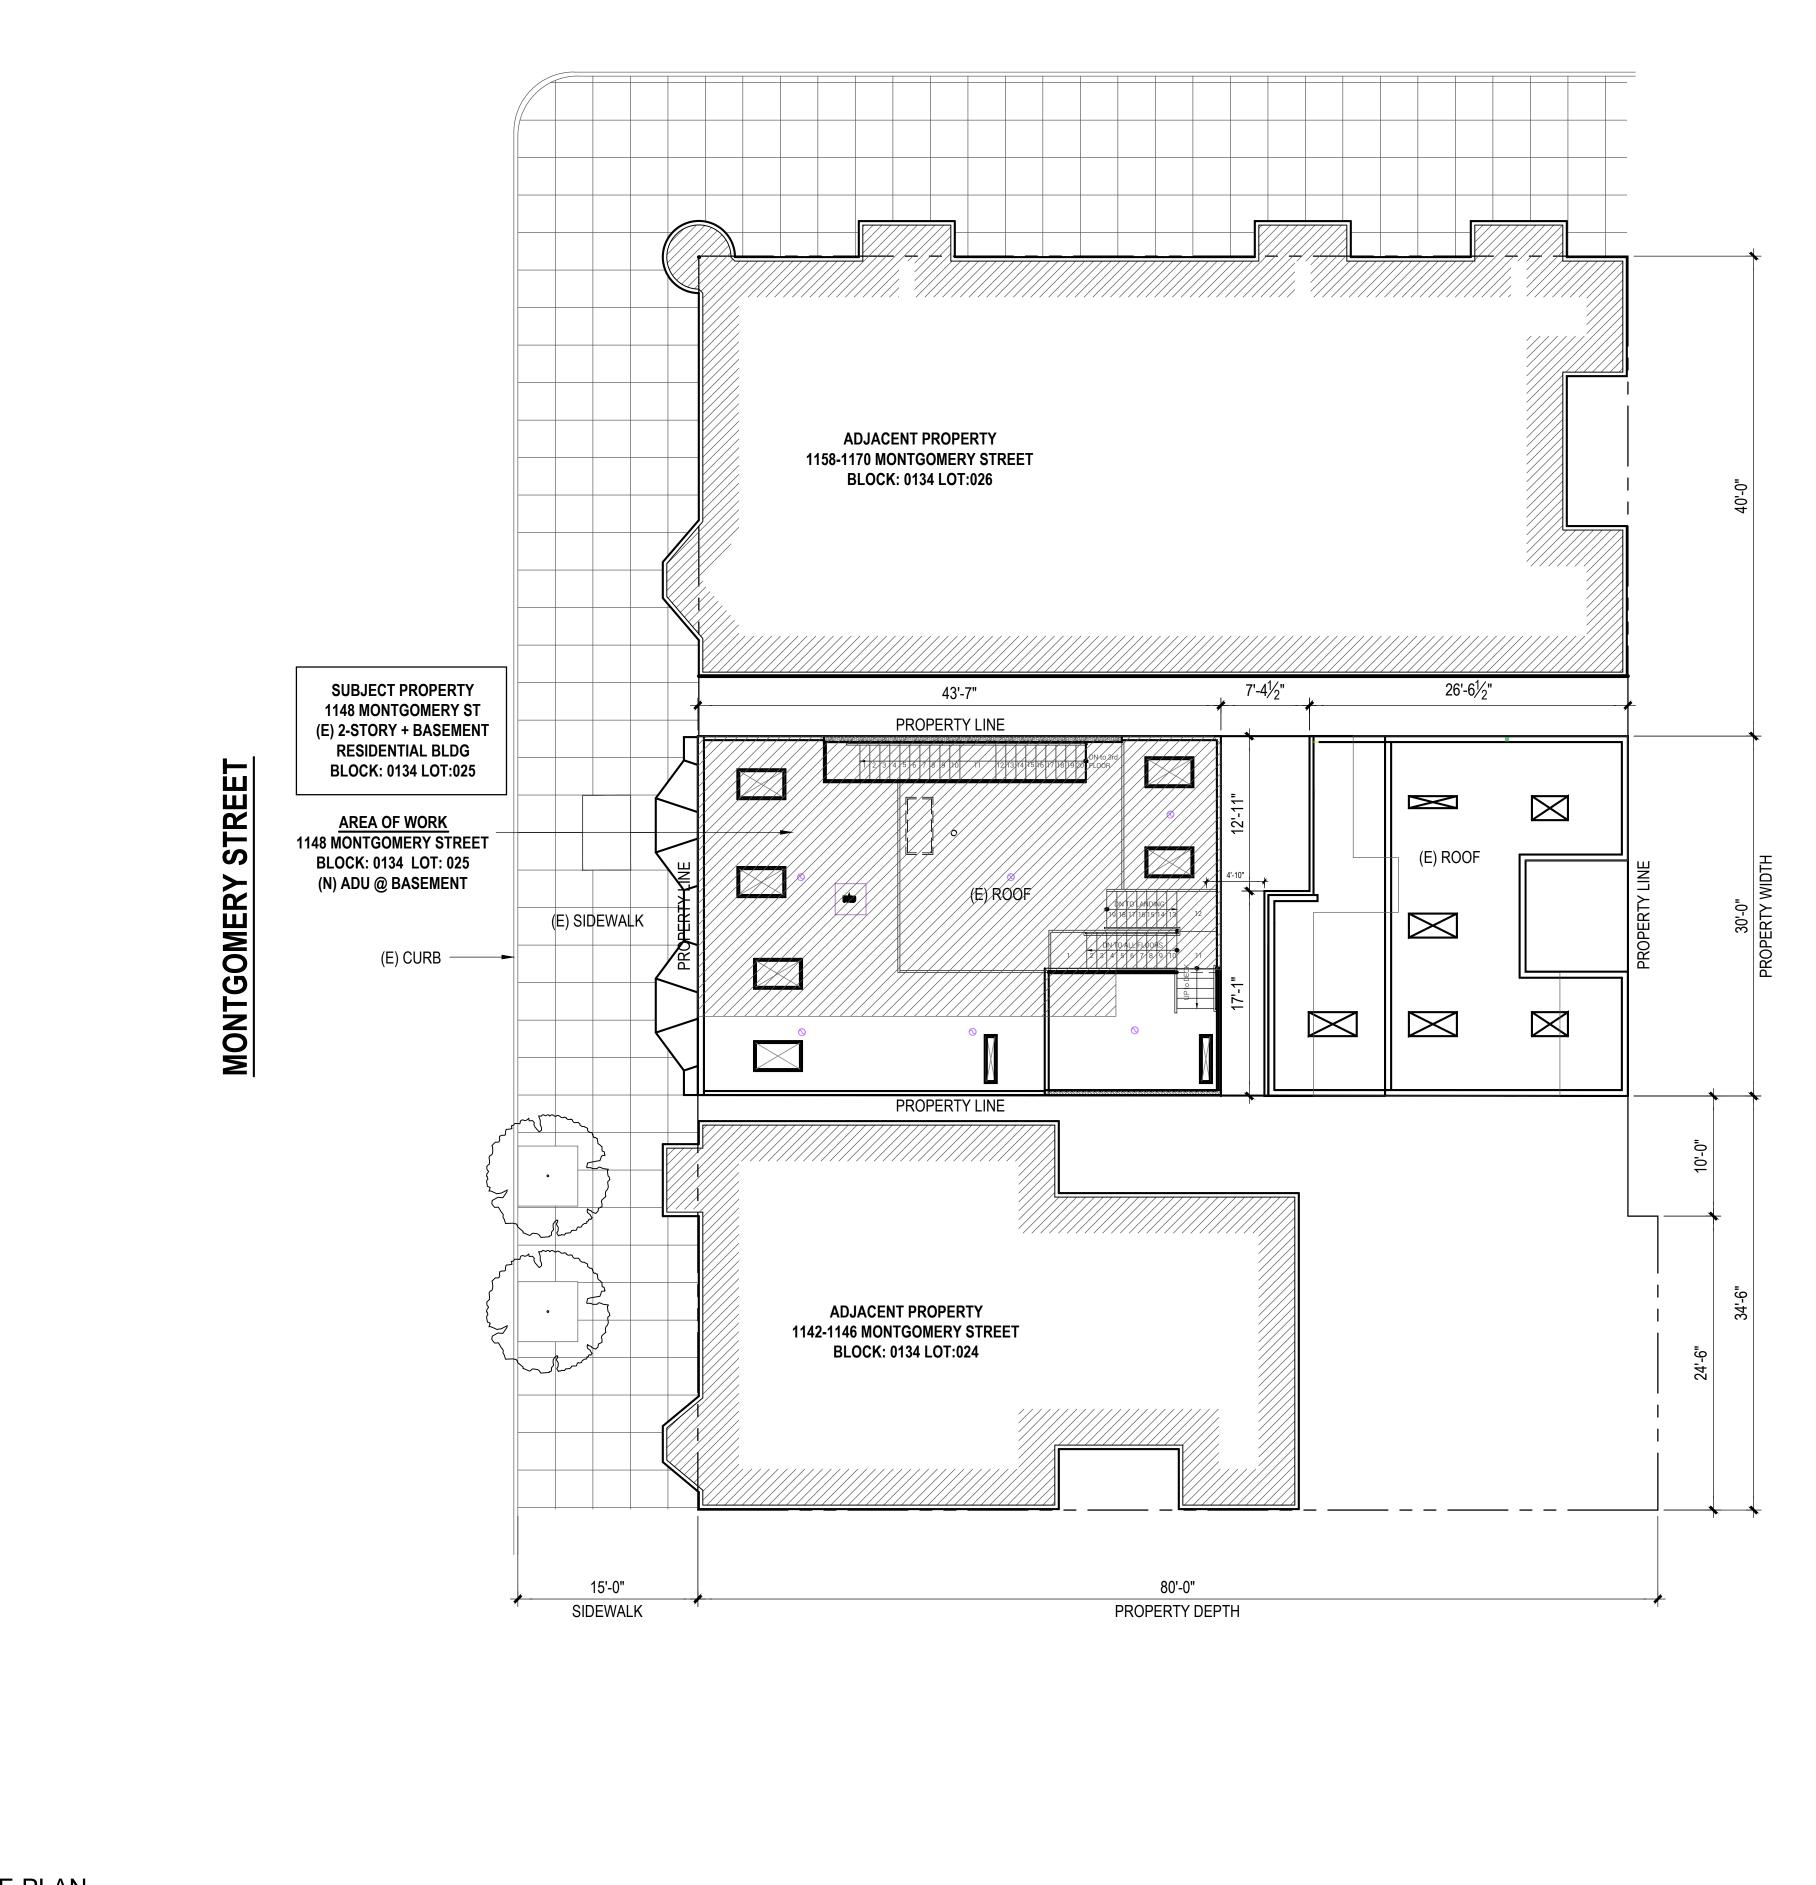

GREEN STREET

STREET TREE CALCULATION TOTAL STREET FRONTAGE: 30'-0" TOTAL STREET TREES REQ'D: 2 EXISTING STREET TREES: NET STREET TREES REQ'D: HTA! 0 2 HOOD THOMAS ARCHITECTS 440 SPEAR STREET SAN FRANCISCO, CALIFORNIA 94105 P:(415)543-5005 F:(415)495-3336 WWW.HOODTHOMAS.COM NO. C014187 EXP. 1-19 1148 Montgomery St. San Francisco, CA 94133 Block: 0134 Lot: 025 DATE: ISSUE: 09.19.16 BLDG. PERMIT APP. VARIANCE APP. 03.01.17 VARIANCE APP. 08.18.17 DRAWN BY: MM, DF DATE: 03.01.17 SHEET TITLE: SITE PLAN SHEET NUMBER: **A0.1** -_______ REV # : DATE:

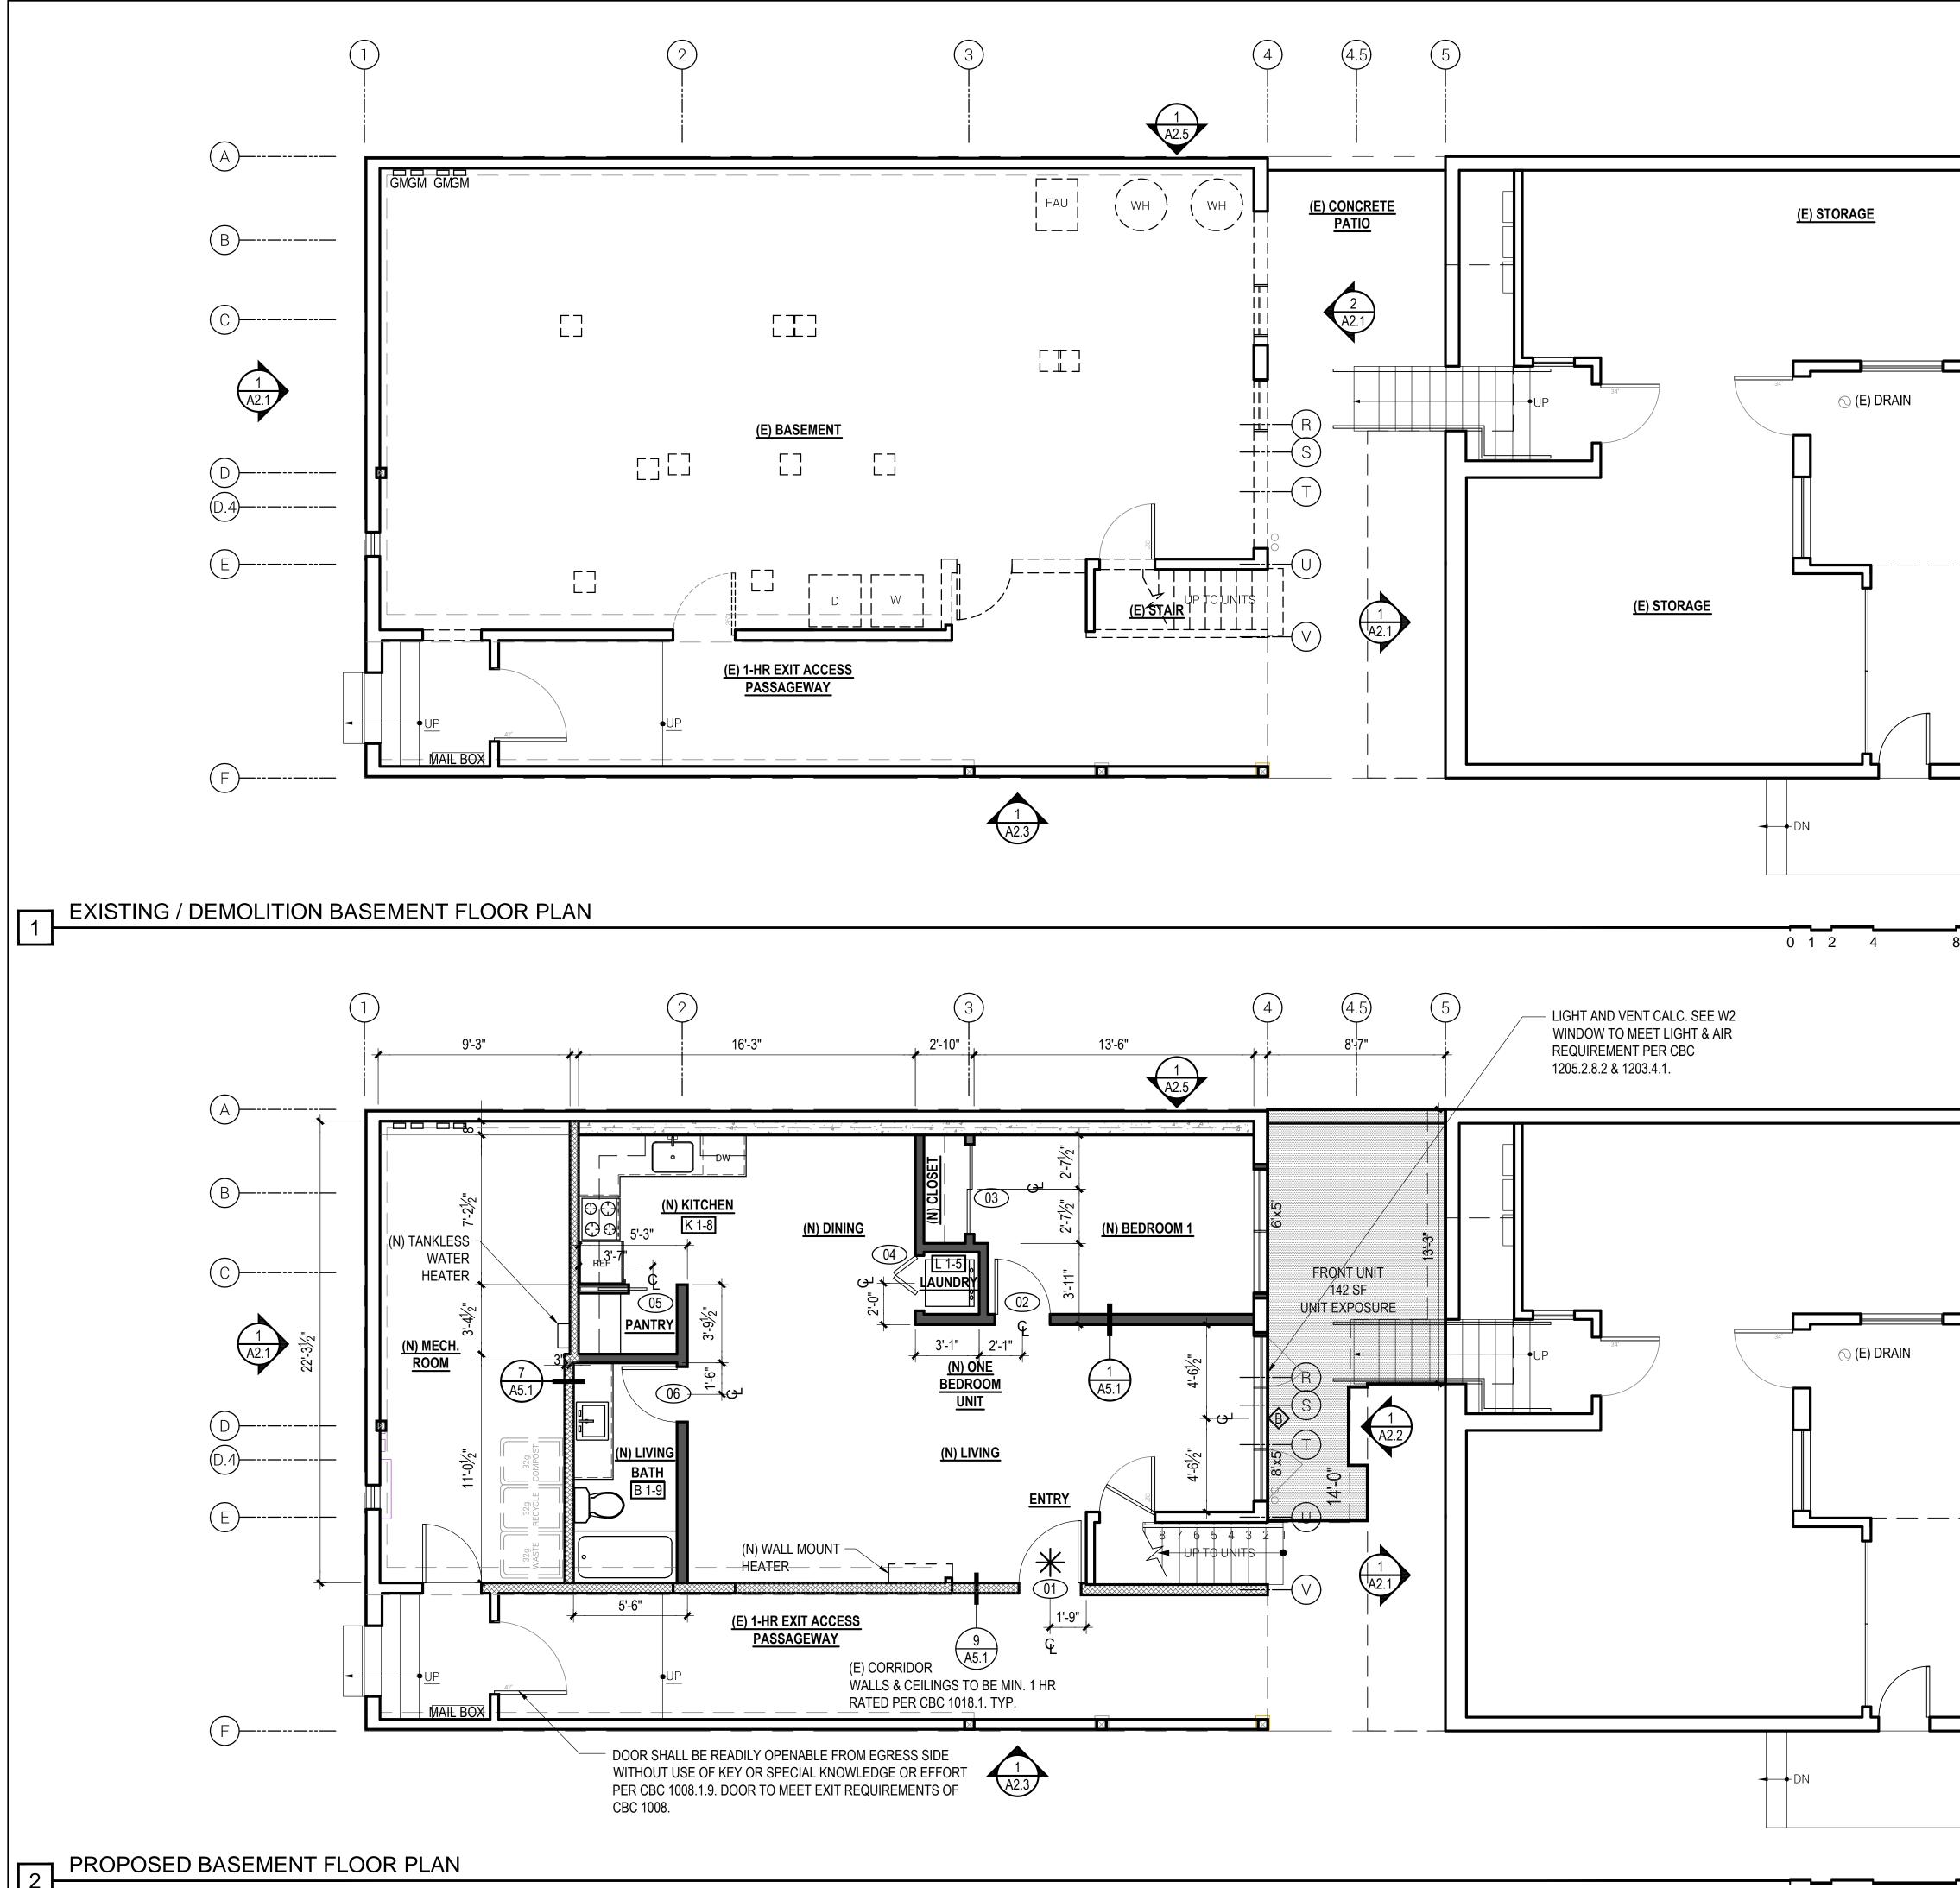

0 1 2 4

FLOOR PLAN KEYNOTES

- DRAWING SET GENERAL NOTES

 1.1
 SEE SHEET A0.0 FOR GENERAL CONSTRUCTION NOTES
- SEE SHEET EMP1.1 FOR ELECTRICAL & MECHANICAL NOTES & PLANS
 DIMENSIONS SHOWN IN PLANS AND ELEVATIONS ARE TAKEN FROM FACE OF WALLBOARD AT INTERIOR WALLS AND FACE OF EXTERIOR FINISH AT EXTERIOR WALLS, U.O.N.

DOORS, WINDOW AND SKYLIGHT PROJECT NOTES D1. PRIMARY EXIT DOORS SHALL MEET THE REQUIREMENTS OF CBC SECTION 1008 FOR SIZE, PROJECTIONS INTO CLEAR WIDTH OF EGRESS PATH, DOOR SWING, &

- OPENING FORCE. DOORS SHALL BE PROVIDED WITH A MIN. 36" X 36" LEVEL LANDING ON EACH SIDE OF THE DOORS EXCEPT AS FOLLOWS: LANDINGS AT THE EXTERIOR SIDE OF A DOOR MAY BE A MAX. OF 7 $\frac{3}{4}$ " BELOW THE THRESHOLD PROVIDED THE DOOR DOES NOT SWING OVER THE LANDING. FOR DOORS THAT SWING OVER THE LANDING THE MAX.
- DISTANCE BELOW THE THRESHOLD IS ¹/₂" PER CBC 1008.1.5. SLIDING GLASS DOORS SHALL HAVE A MAX. ¹/₂" LEVEL CHANGE FROM THRESHOLD.
 DOORWAY BETWEEN GARAGES & HABITABLE SPACE SHALL BE PROVIDED WITH EITHER SOLID WOOD DOORS OR SOLID OR HONEYCOMB CORE STEEL DOORS NOT LESS THAN 1 ³/₈" THICK & PROVIDED WITH SELF CLOSING AND SELF LATCHING H
- HARDWARE.
 PROVIDE LISTED, GASKETED DOORS w/ LISTED SELF CLOSING DEVICE & BOTTOM SEAL AT THRESHOLD PER CMC 904.1 WHERE COMPARTMENTS CONTAINING
- FURNACES & BOILERS ARE INSTALLED IN BEDROOMS OR BATHROOMS. (N) WINDOWS PER WINDOW SCHEDULE INCLUDED IN THIS DRAWING SET SHALL
- COMPLY WITH TITLE 24 REQUIREMENTS. SEE SCHEDULE FOR ADDITIONAL NOTES.
 EMERGENCY ESCAPE & RESCUE WINDOWS REQUIRED AT SLEEPING AREAS SHALL MEET THE FOLLOWING REQUIREMENTS: MIN. 5.7' CLEAR OPENING, MIN. 24" CLEAR HEIGHT, MIN. 20" CLEAR WIDTH, SILL HEIGHT MAX. 44" AFF.

	LIGHT / AIR REQUIRED BY CBC SEC 1205.2 & 1203.4.1		
	UNIT #E #E BEDROOM UNIT #F		
LIVING AREA	462 SF	123 SF	424 SF
LIGHT 8%	36.96 SF	9.84 SF	33.92 SF
LIGHT PROV.	40.0 SF	30.0 SF	39.58 SF
AIR 4%	18.48 SF	4.92 SF	16.96 SF
AIR PROV.	25.0 SF	30.0 SF	19.79 SF

W3. WINDOWS IN LOCATIONS SUBJECT TO HUMAN IMPACT LOADS SHALL BE PROVIDED WITH SAFETY GLAZING INSTALLED IN ACCORDANCE WITH CBC 2406 & 2407.

K1-8 KITCHEN PROJECT NOTES

- KITCHEN FAUCETS SHALL HAVE A MAX. FLOW RATE OF 1.5 G.P.M MEASURED AT 60 PSI.
 K2. GARBAGE DISPOSAL UNITS AT KITCHEN SINKS SHALL BE PROVIDED WITH
- REQUIRED AIR GAP.
 GAS COOKING APPLIANCES SHALL BE UL LISTED & INSTALLED PER MANUF. INSTRUCTIONS. PROVIDE GAS SHUT-OFF VALVE IN APPROVED,
- ACCESSIBLE LOCATION. K4. RESIDENTIAL RANGEHOOD EXHAUST PER CMC 403.7. SHALL MEET REQUIREMENTS OF CMC 504.2. EXHAUST TERMINATION SHALL BE LOCATED AT LEAST 3'-0" AWAY FROM PROPERTY LINES AND BUILDING OPENINGS & BE PROVIDED WITH WEATHERPROOF BACKDRAFT DAMPER. WHERE REMOTE EXHAUST OR BOOSTER FANS ARE REQUIRED, FAN SHALL BE ON DEDICATED CIRCUIT.
- K5. UPPER CABINETS SHALL BE MIN. 30" ABOVE COOKING TOP PER CMC 916.1.2. PROVIDE THE COOKING APPLIANCE MIN. CLEARANCE TO COMBUSTIBLES PER CMC.916.1.
- (6. (N) DISHWASHERS SHALL BE PROVIDED WITH REQUIRED AIRGAP, HOT WATER STUB & DEDICATED CIRCUIT.
 (7. (N) APPLIANCES TO BE UL LISTED AND INSTALLED PER MANUF.
- (N) AT LEAGED TO BE BE LETED AND INSTRUCTIONS. INSTALLING CONTRACTOR SHALL COORDINATE ALL
 ELECTRICAL AND PLUMBING REQUIREMENTS WITH MANUF. SPECIFICATIONS
 (N) CABINETRY AND NONPOROUS COUNTERTOPS THROUGHOUT, U.O.N.

B1-9 BATHROOM PROJECT NOTES

 \oplus

16

- (N) NONPOROUS SLAB COUNTERTOP & SPLASH.
 GLASS SHOWER ENCLOSURES SAFETY GLAZING SUBJECT TO HUMAN IMPACT LOADS INSTALLED IN ACCORDANCE W/ CBC 2406 & 2407. SHOWER DOORS SHALL PROVIDE MIN 22" CLEAR OPENING WIDTH, PER CPC 408.5.
 SHOWER COMPARTMENTS & WALLS ABOVE TUBS w/ SHOWERHEADS SHALL BE FINISHED WITH A SMOOTH NONABSORBENT SURFACE TO
- A HEIGHT NOT LESS THAN 70" ABOVE DRAIN INLET. CBC 1210.3
 A. NONPAPER-FACED BACKER BOARD TO BE USED IN ALL TUB,SHOWER & SPA AREAS. (WATER-RESISTANT TO A HEIGHT AS INDICATED ABOVE).
 B4. SHOWER PER CPC 408. MIN FLOOR AREA OF 1024 SQUARE INCHES & CAPABLE OF ENCOMPASSING A 30" CIRCLE. THE AREA & DIMENSION SHALL BE MAINTAINED TO A POINT NOT LESS THAN
- 70" ABOVE THE SHOWER DRAIN. DRAIN INLET MIN. 2" MAX. 9" BELOW THRESHOLD INTO SHOWER.
 5. SHOWER HEADS SHALL HAVE A MAX. FLOW RATE OF 2.0 GPM MEASURED AT 80 PSI.
- B6. SHOWER VALVES & HEADS SHALL BE PLACED INSIDE SHOWER COMPARTMENT SUCH THAT SHOWER HEAD DOES NOT DISCHARGE DIRECTLY TOWARD THE ENTRANCE OF THE COMPARTMENT AND THE BATHER CAN ADJUST VALVES PRIOR TO STEPPING INTO SHOWER SPRAY.
- WATER CLOSET PER CBC 2903 CENTERED WITHIN 30" WIDE CLEAR
 SPACE. TOILETS SHALL HAVE MAX. 1.28 GPF WATER CONSUMPTION.
 BATH & LAUNDRY ROOM FAUCETS SHALL HAVE A MAX. FLOW RATE OF
- 1.5 GPM MEASURED AT 60 PSI.
 PROVIDE EXHAUST FAN CAPABLE OF PROVIDING 5 AIR CHANGES PER HOUR. VENT TO OUTSIDE. PROVIDE BACKDRAFT DAMPER


L1-5 LAUNDRY & MECHANICAL ROOM PROJECT NOTES


- 1. CLOTHES WASHER: PROVIDE FLUSH MOUNT 'GUY BOX' FOR HOT & COLD WATER & DRAIN CONNECTIONS.
- 2. CONVENTIONAL CLOTHES DRYER: PROVIDE OPENING OF 100 SQ. INCHES MIN. FOR MAKE-UP AIR AT DOORS ENCLOSING APPLIANCE PER CMC 504.3.2. DIRECT EXHAUST TO OUTSIDE USING STEEL, SMOOTH BORE, 4" MIN. DIA. DUCT. PROVIDE WEATHERPROOF CAP & BACKDRAFT DAMPER. TERMINATE VENT MIN. 3'-0" FROM OPERABLE WINDOWS & DOORS PER CMC 504.5. PROVIDE IN-LINE BOOSTER FAN FOR DUCT RUNS OVER 14'-0" IN LENGTH. PROVIDE GAS SHUTOFF VALVE IN APPROVED LOCATION. CONDENSING DRYERS TO HAVE DRAIN & DRAIN PAN.
- L3. PROVIDE DRAIN PAN @ TANK WATER HEATERS AND CLOTHES WASHERS INSTALLED OVER LIVING SPACE.
- WATER HEATER TO BE PROVIDED WITH SEISMIC STRAPPING PER CPC 510.5
 ROOMS CONTAINING GAS CONSUMING SPACE AND WATER HEATING EQUIPMENT SHALL BE PROVIDED WITH COMBUSTION AIR OPENINGS IN COMPLIANCE WITH CMC CHAPTER 7.

PLAN LEGEND

 \oplus

16

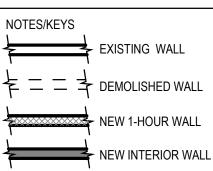

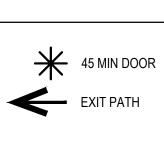



HOOD THOMAS ARCHITECTS


440 SPEAR STREET SAN FRANCISCO, CALIFORNIA 94105 P:(415)543-5005 F:(415)495-3336 WWW.HOODTHOMAS.COM



1148 Montgomery St. San Francisco, CA 94133

Block: 0134 Lot: 025


ISSUE:	DATE:
BLDG. PERMIT APP.	09.19.16
VARIANCE APP.	03.01.17
VARIANCE APP.	08.18.17

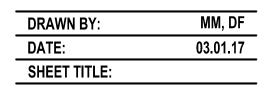

EXISTING & PROPOSED BASEMENT FLOOR PLANS

SHEET NUMBER:



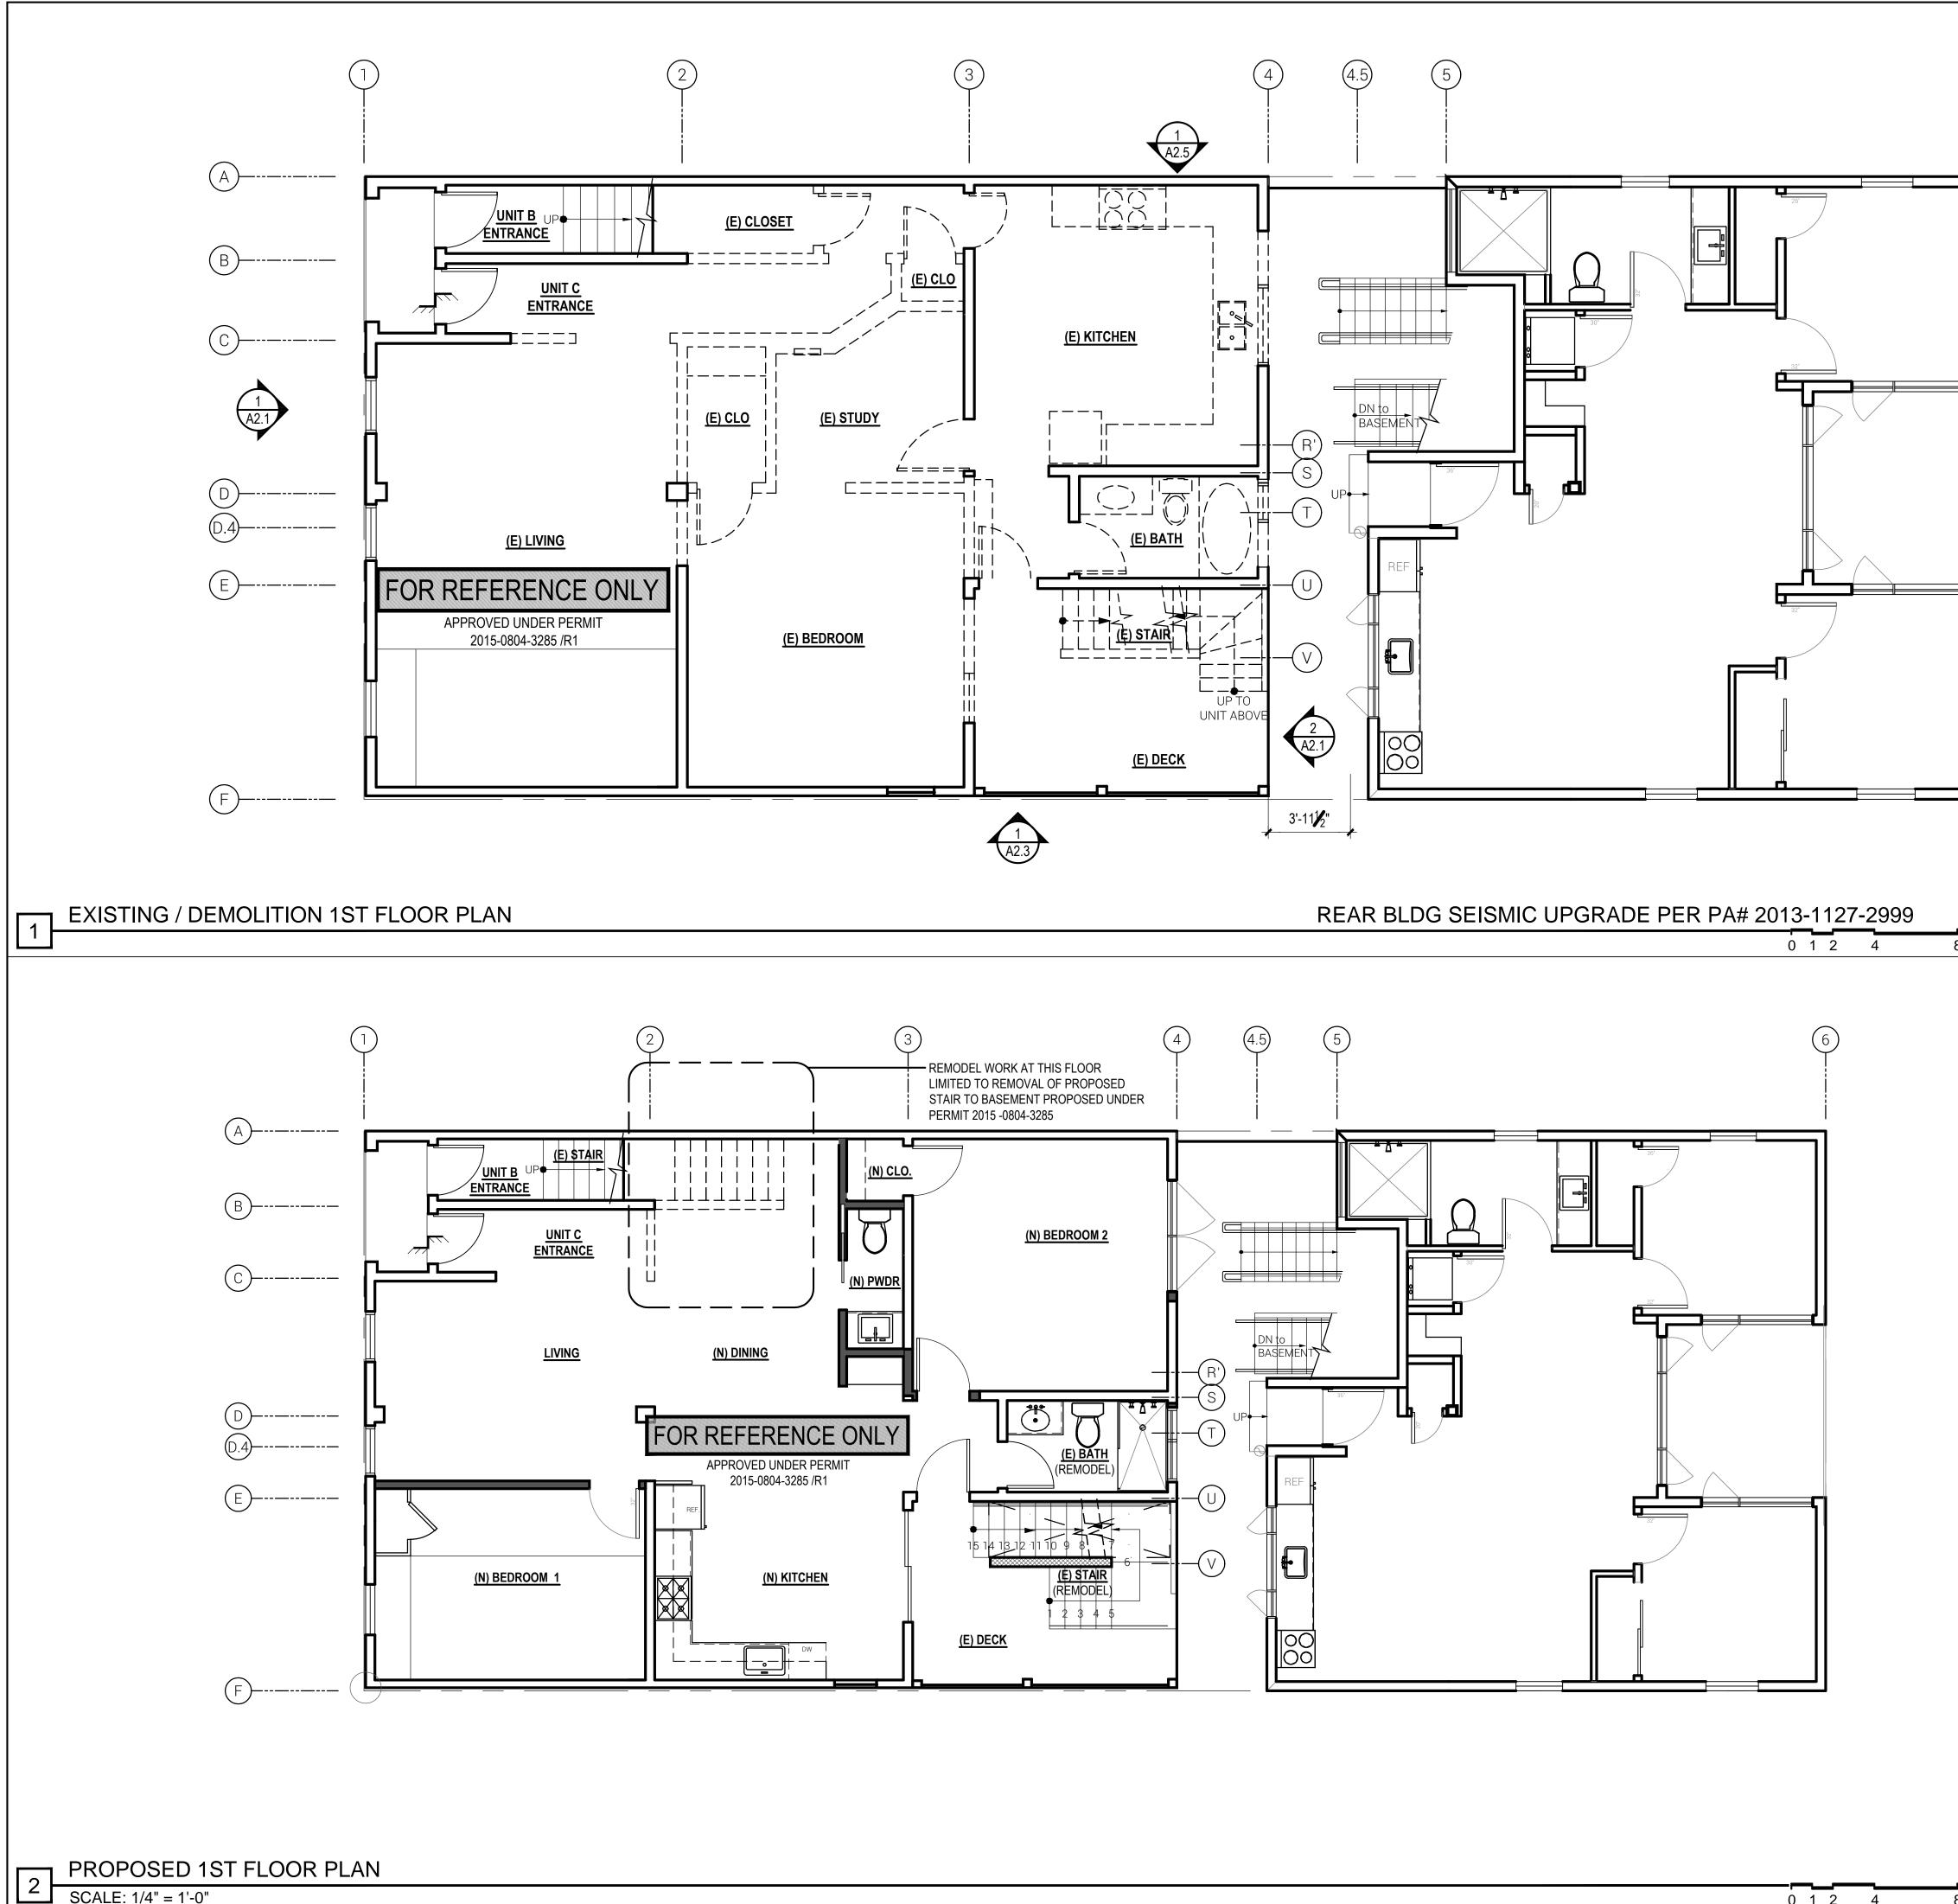

FLOOR PLAN KEYNOTES

- DRAWING SET GENERAL NOTES SEE SHEET A0.0 FOR GENERAL CONSTRUCTION NOTES
- SEE SHEET EMP1.1 FOR ELECTRICAL & MECHANICAL NOTES & PLANS DIMENSIONS SHOWN IN PLANS AND ELEVATIONS ARE TAKEN FROM FACE OF WALLBOARD AT INTERIOR WALLS AND FACE OF EXTERIOR FINISH AT
- EXTERIOR WALLS, U.O.N. DOORS, WINDOW AND SKYLIGHT PROJECT NOTES PRIMARY EXIT DOORS SHALL MEET THE REQUIREMENTS OF CBC SECTION 1008 FOR SIZE, PROJECTIONS INTO CLEAR WIDTH OF EGRESS PATH, DOOR SWING, &
- OPENING FORCE. DOORS SHALL BE PROVIDED WITH A MIN. 36" X 36" LEVEL LANDING ON EACH SIDE OF THE DOORS EXCEPT AS FOLLOWS: LANDINGS AT THE EXTERIOR SIDE OF A DOOR MAY BE A MAX. OF 7 ³/₇ BELOW THE THRESHOLD PROVIDED THE DOOR DOES NOT SWING OVER THE LANDING. FOR DOORS THAT SWING OVER THE LANDING THE MAX. DISTANCE BELOW THE THRESHOLD IS ¹/₂" PER CBC 1008.1.5. SLIDING GLASS DOORS
- SHALL HAVE A MAX. ¹/₂" LEVEL CHANGE FROM THRESHOLD. DOORWAY BETWEEN GARAGES & HABITABLE SPACE SHALL BE PROVIDED WITH EITHER SOLID WOOD DOORS OR SOLID OR HONEYCOMB CORE STEEL DOORS NOT LESS THAN 1 ³/₈" THICK & PROVIDED WITH SELF CLOSING AND SELF LATCHING H HARDWARE.
- PROVIDE LISTED, GASKETED DOORS w/ LISTED SELF CLOSING DEVICE & BOTTOM SEAL AT THRESHOLD PER CMC 904.1 WHERE COMPARTMENTS CONTAINING FURNACES & BOILERS ARE INSTALLED IN BEDROOMS OR BATHROOMS.
- (N) WINDOWS PER WINDOW SCHEDULE INCLUDED IN THIS DRAWING SET SHALL COMPLY WITH TITLE 24 REQUIREMENTS. SEE SCHEDULE FOR ADDITIONAL NOTES. EMERGENCY ESCAPE & RESCUE WINDOWS REQUIRED AT SLEEPING AREAS SHALL MEET THE FOLLOWING REQUIREMENTS: MIN. 5.7' CLEAR OPENING, MIN. 24" CLEAR

HEIGHT, MIN. 20" CLEAR WIDTH, SILL HEIGHT MAX. 44" AFF.			
	LIGHT / AIR REQUIRED BY CBC SEC 1205.2 & 1203.4.1		
	UNIT #E #E BEDROOM UNIT #F		
LIVING AREA	462 SF	123 SF	424 SF
LIGHT 8%	36.96 SF	9.84 SF	33.92 SF
LIGHT PROV.	40.0 SF	30.0 SF	39.58 SF
AIR 4%	18.48 SF	4.92 SF	16.96 SF
AIR PROV.	25.0 SF	30.0 SF	19.79 SF

WINDOWS IN LOCATIONS SUBJECT TO HUMAN IMPACT LOADS SHALL BE PROVIDED W3 WITH SAFETY GLAZING INSTALLED IN ACCORDANCE WITH CBC 2406 & 2407.

K1-8 KITCHEN PROJECT NOTES

- KITCHEN FAUCETS SHALL HAVE A MAX. FLOW RATE OF 1.5 G.P.M MEASURED AT 60 PSI. GARBAGE DISPOSAL UNITS AT KITCHEN SINKS SHALL BE PROVIDED WITH
- REQUIRED AIR GAP. GAS COOKING APPLIANCES SHALL BE UL LISTED & INSTALLED PER MANUF. INSTRUCTIONS. PROVIDE GAS SHUT-OFF VALVE IN APPROVED,
- ACCESSIBLE LOCATION. RESIDENTIAL RANGEHOOD EXHAUST PER CMC 403.7. SHALL MEET REQUIREMENTS OF CMC 504.2. EXHAUST TERMINATION SHALL BE LOCATED AT LEAST 3'-0" AWAY FROM PROPERTY LINES AND BUILDING OPENINGS & BE PROVIDED WITH WEATHERPROOF BACKDRAFT DAMPER. WHERE REMOTE EXHAUST OR BOOSTER FANS ARE REQUIRED, FAN SHALL BE ON DEDICATED CIRCUIT.
- UPPER CABINETS SHALL BE MIN. 30" ABOVE COOKING TOP PER CMC 916.1.2. PROVIDE THE COOKING APPLIANCE MIN. CLEARANCE TO COMBUSTIBLES PER CMC.916.1.
- (N) DISHWASHERS SHALL BE PROVIDED WITH REQUIRED AIRGAP, HOT WATER STUB & DEDICATED CIRCUIT. (N) APPLIANCES TO BE UL LISTED AND INSTALLED PER MANUF.
- INSTRUCTIONS. INSTALLING CONTRACTOR SHALL COORDINATE ALL ELECTRICAL AND PLUMBING REQUIREMENTS WITH MANUF. SPECIFICATIONS (N) CABINETRY AND NONPOROUS COUNTERTOPS THROUGHOUT, U.O.N.

B1-9 BATHROOM PROJECT NOTES

- (N) NONPOROUS SLAB COUNTERTOP & SPLASH. GLASS SHOWER ENCLOSURES SAFETY GLAZING SUBJECT TO HUMAN IMPACT LOADS INSTALLED IN ACCORDANCE W/ CBC 2406 & 2407. SHOWER DOORS SHALL PROVIDE MIN 22" CLEAR OPENING WIDTH, PER CPC 408.5. SHOWER COMPARTMENTS & WALLS ABOVE TUBS w/ SHOWERHEADS
- SHALL BE FINISHED WITH A SMOOTH NONABSORBENT SURFACE TO A HEIGHT NOT LESS THAN 70" ABOVE DRAIN INLET. CBC 1210.3 NONPAPER-FACED BACKER BOARD TO BE USED IN ALL TUB, SHOWER & SPA AREAS. (WATER-RESISTANT TO A HEIGHT AS INDICATED ABOVE).
- SHOWER PER CPC 408. MIN FLOOR AREA OF 1024 SQUARE INCHES & CAPABLE OF ENCOMPASSING A 30" CIRCLE. THE AREA & DIMENSION SHALL BE MAINTAINED TO A POINT NOT LESS THAN 70" ABOVE THE SHOWER DRAIN. DRAIN INLET MIN. 2" MAX. 9" BELOW THRESHOLD INTO SHOWER.
- SHOWER HEADS SHALL HAVE A MAX. FLOW RATE OF 2.0 GPM MEASURED AT 80 PSI. SHOWER VALVES & HEADS SHALL BE PLACED INSIDE SHOWER
- COMPARTMENT SUCH THAT SHOWER HEAD DOES NOT DISCHARGE DIRECTLY TOWARD THE ENTRANCE OF THE COMPARTMENT AND THE BATHER CAN ADJUST VALVES PRIOR TO STEPPING INTO SHOWER SPRAY
- WATER CLOSET PER CBC 2903 CENTERED WITHIN 30" WIDE CLEAR SPACE. TOILETS SHALL HAVE MAX. 1.28 GPF WATER CONSUMPTION. BATH & LAUNDRY ROOM FAUCETS SHALL HAVE A MAX. FLOW RATE OF
- 1.5 GPM MEASURED AT 60 PSI. PROVIDE EXHAUST FAN CAPABLE OF PROVIDING 5 AIR CHANGES PER HOUR. VENT TO OUTSIDE. PROVIDE BACKDRAFT DAMPER


L1-5 LAUNDRY & MECHANICAL ROOM PROJECT NOTES

- CLOTHES WASHER: PROVIDE FLUSH MOUNT 'GUY BOX' FOR HOT & COLD WATER & DRAIN CONNECTIONS.
- CONVENTIONAL CLOTHES DRYER: PROVIDE OPENING OF 100 SQ. INCHES MIN. FOR MAKE-UP AIR AT DOORS ENCLOSING APPLIANCE PER CMC 504.3.2. DIRECT EXHAUST TO OUTSIDE USING STEEL, SMOOTH BORE, 4" MIN. DIA. DUCT. PROVIDE WEATHERPROOF CAP & BACKDRAFT DAMPER. TERMINATE VENT MIN. 3'-0" FROM OPERABLE WINDOWS & DOORS PER CMC 504.5. PROVIDE IN-LINE BOOSTER FAN FOR DUCT RUNS OVER 14'-0" IN LENGTH. PROVIDE GAS SHUTOFF VALVE IN APPROVED LOCATION. CONDENSING DRYERS TO HAVE DRAIN & DRAIN PAN.
- PROVIDE DRAIN PAN @ TANK WATER HEATERS AND CLOTHES WASHERS INSTALLED OVER LIVING SPACE.
- WATER HEATER TO BE PROVIDED WITH SEISMIC STRAPPING PER CPC 510.5 ROOMS CONTAINING GAS CONSUMING SPACE AND WATER HEATING EQUIPMENT SHALL BE PROVIDED WITH COMBUSTION AIR OPENINGS IN COMPLIANCE WITH CMC CHAPTER 7.

PLAN LEGEND

 \oplus

16

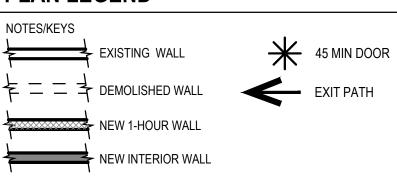



HOOD THOMAS ARCHITECTS

440 SPEAR STREET SAN FRANCISCO, CALIFORNIA 94105 P:(415)543-5005 F:(415)495-3336 WWW.HOODTHOMAS.COM



1148 Montgomery St. San Francisco, CA 94133

Block: 0134 Lot: 025


ISSUE:	DATI
BLDG. PERMIT APP.	09.19.1
VARIANCE APP.	03.01.1
VARIANCE APP.	08.18.1


DRAWN BY:	MM, DF
DATE:	03.01.17
SHEET TITLE:	



SHEET NUMBER:

DATE:

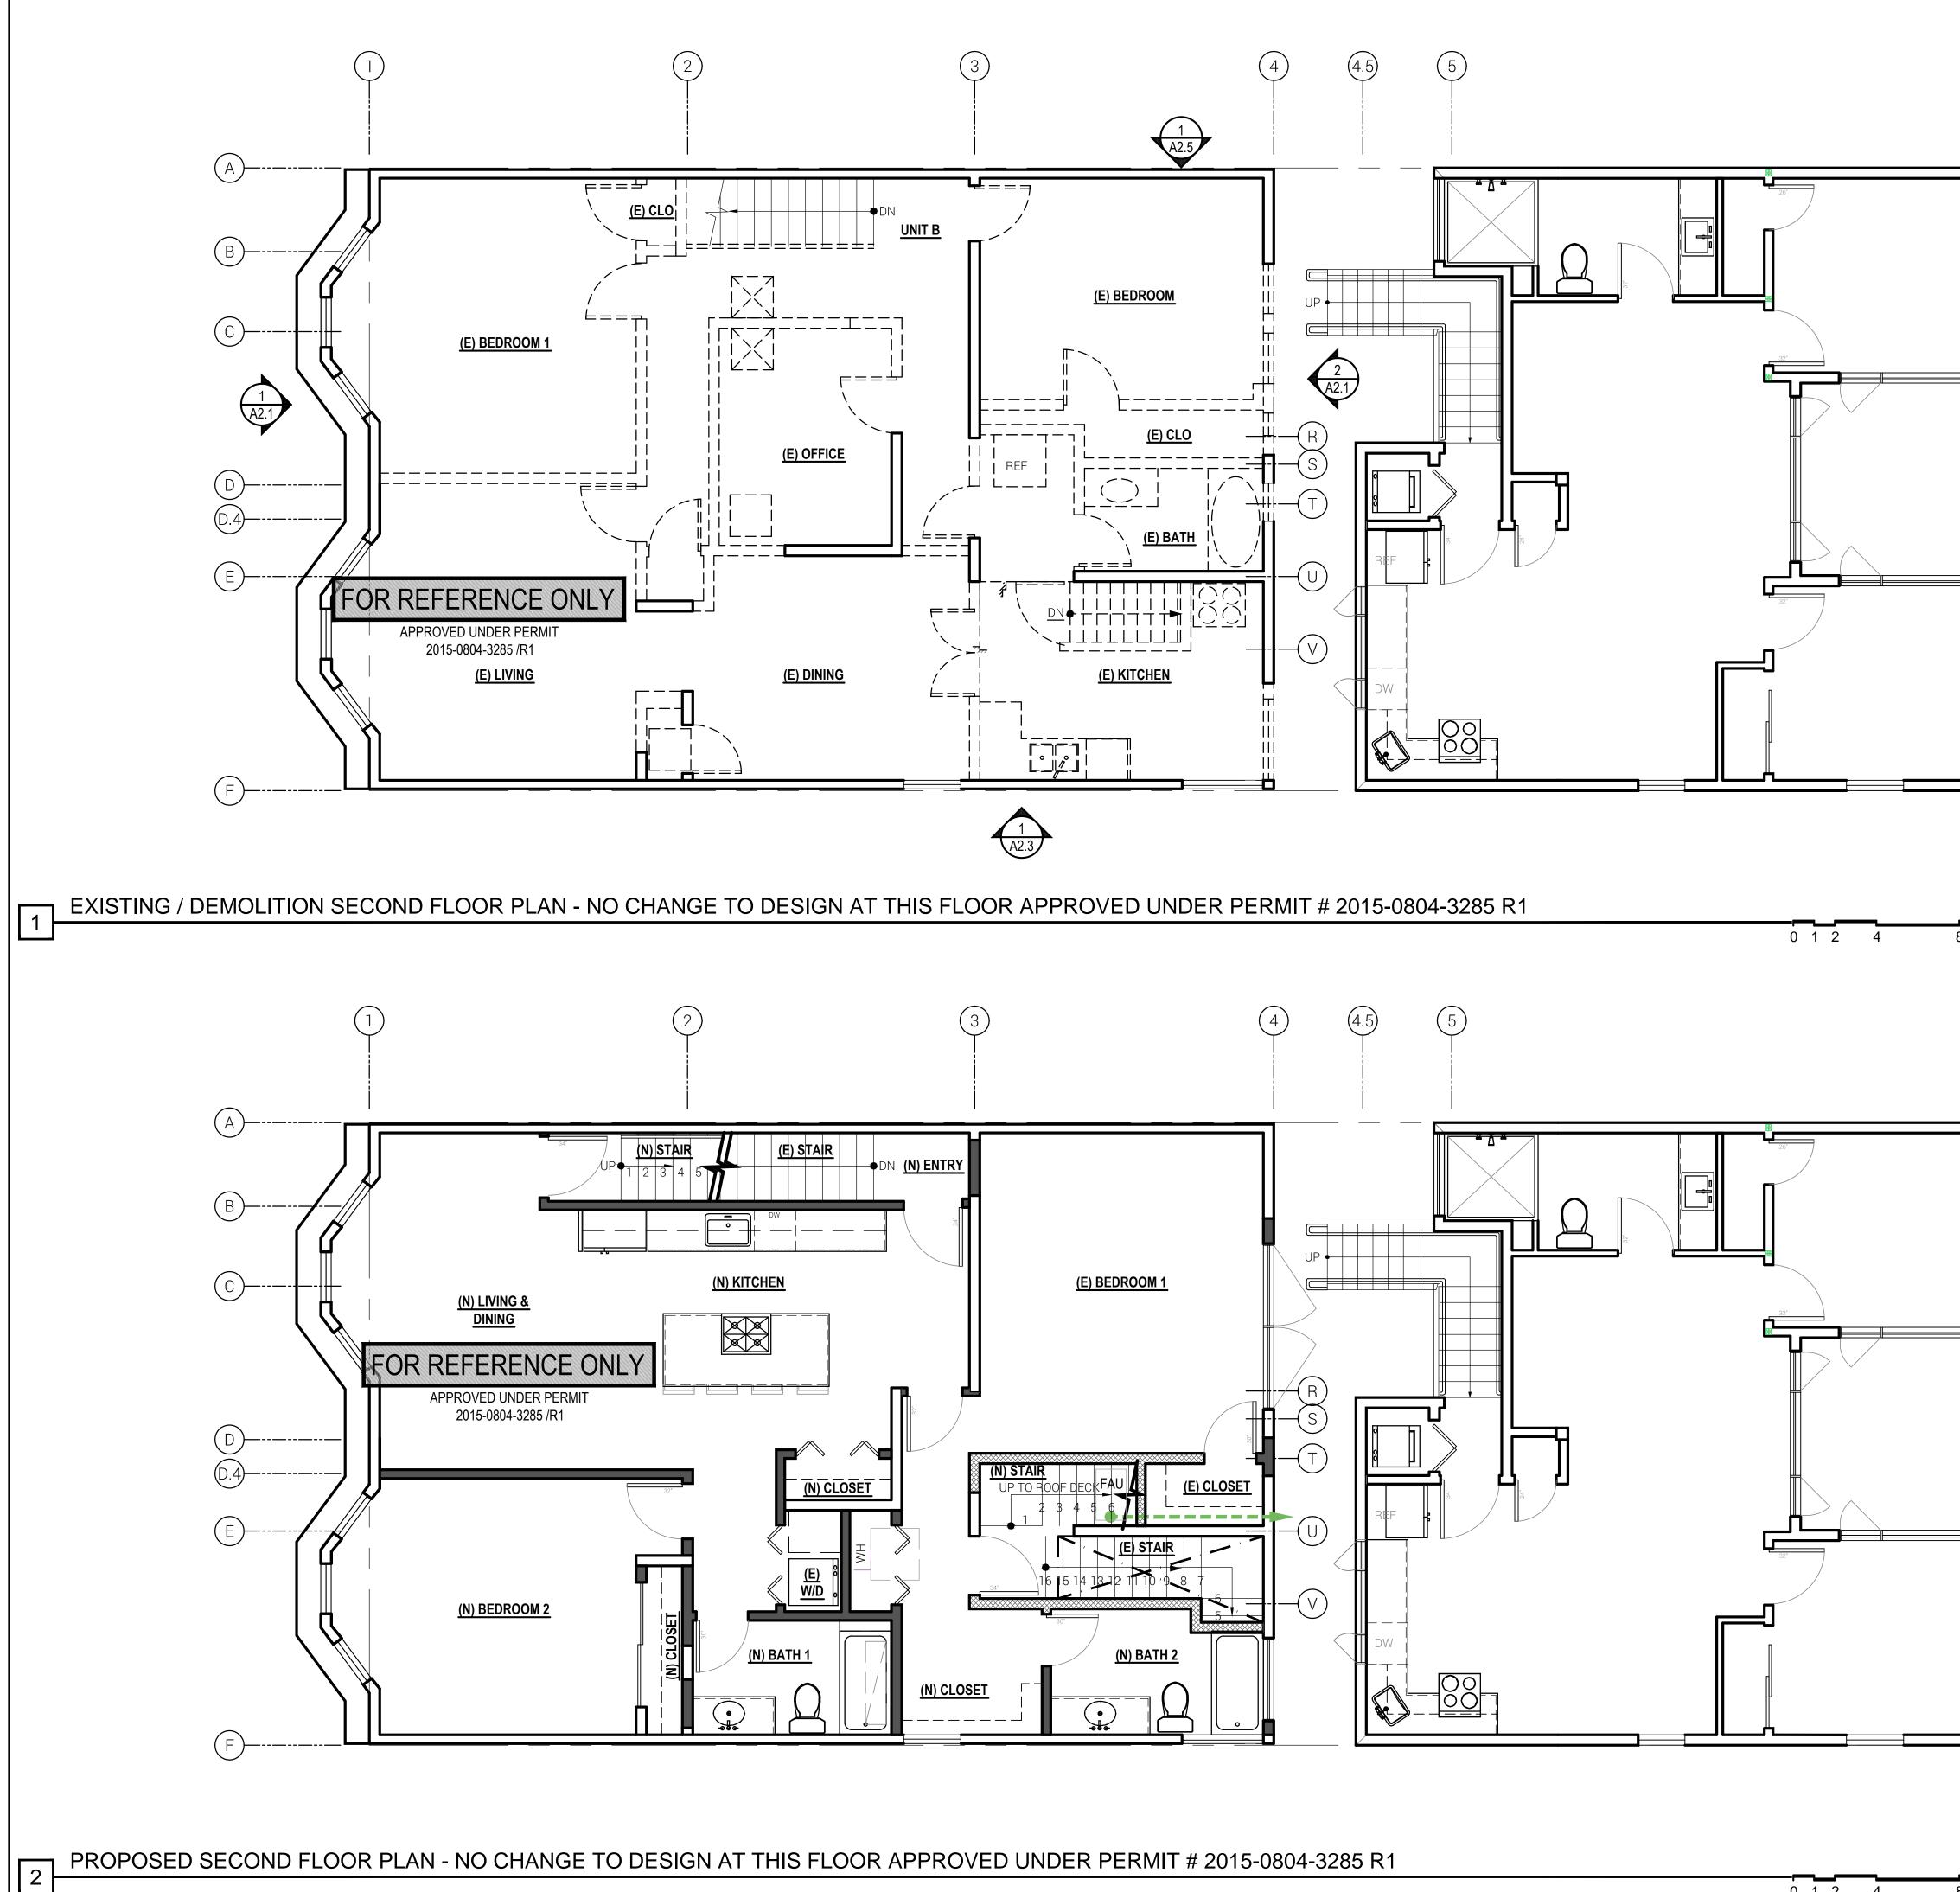

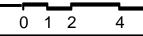



FLOOR PLAN KEYNOTES

- DRAWING SET GENERAL NOTES SEE SHEET A0.0 FOR GENERAL CONSTRUCTION NOTES
- SEE SHEET EMP1.1 FOR ELECTRICAL & MECHANICAL NOTES & PLANS DIMENSIONS SHOWN IN PLANS AND ELEVATIONS ARE TAKEN FROM FACE OF WALLBOARD AT INTERIOR WALLS AND FACE OF EXTERIOR FINISH AT
- EXTERIOR WALLS, U.O.N. DOORS, WINDOW AND SKYLIGHT PROJECT NOTES PRIMARY EXIT DOORS SHALL MEET THE REQUIREMENTS OF CBC SECTION 1008 FOR SIZE, PROJECTIONS INTO CLEAR WIDTH OF EGRESS PATH, DOOR SWING, &
- OPENING FORCE. DOORS SHALL BE PROVIDED WITH A MIN. 36" X 36" LEVEL LANDING ON EACH SIDE OF THE DOORS EXCEPT AS FOLLOWS: LANDINGS AT THE EXTERIOR SIDE OF A DOOR MAY BE A MAX. OF 7 $\frac{3}{4}$ " BELOW THE THRESHOLD PROVIDED THE DOOR DOES NOT SWING OVER THE LANDING. FOR DOORS THAT SWING OVER THE LANDING THE MAX. DISTANCE BELOW THE THRESHOLD IS $\frac{1}{2}$ " PER CBC 1008.1.5. SLIDING GLASS DOORS
- SHALL HAVE A MAX. ¹/₂" LEVEL CHANGE FROM THRESHOLD. DOORWAY BETWEEN GARAGES & HABITABLE SPACE SHALL BE PROVIDED WITH EITHER SOLID WOOD DOORS OR SOLID OR HONEYCOMB CORE STEEL DOORS NOT LESS THAN 1 ³" THICK & PROVIDED WITH SELF CLOSING AND SELF LATCHING H HARDWARE.
- PROVIDE LISTED, GASKETED DOORS w/ LISTED SELF CLOSING DEVICE & BOTTOM SEAL AT THRESHOLD PER CMC 904.1 WHERE COMPARTMENTS CONTAINING FURNACES & BOILERS ARE INSTALLED IN BEDROOMS OR BATHROOMS.
- (N) WINDOWS PER WINDOW SCHEDULE INCLUDED IN THIS DRAWING SET SHALL COMPLY WITH TITLE 24 REQUIREMENTS. SEE SCHEDULE FOR ADDITIONAL NOTES. EMERGENCY ESCAPE & RESCUE WINDOWS REQUIRED AT SLEEPING AREAS SHALL MEET THE FOLLOWING REQUIREMENTS: MIN. 5.7' CLEAR OPENING, MIN. 24" CLEAR

HEIGHT, MIN. 20" CLEAR WIDTH, SILL HEIGHT MAX. 44" AFF.			
	LIGHT / AIR REQUIRED BY CBC SEC 1205.2 & 1203.4.1		
	UNIT #E #E BEDROOM UNIT #F		
LIVING AREA	462 SF	123 SF	424 SF
LIGHT 8%	36.96 SF	9.84 SF	33.92 SF
LIGHT PROV.	40.0 SF	30.0 SF	39.58 SF
AIR 4%	18.48 SF	4.92 SF	16.96 SF
AIR PROV.	25.0 SF	30.0 SF	19.79 SF

WINDOWS IN LOCATIONS SUBJECT TO HUMAN IMPACT LOADS SHALL BE PROVIDED WITH SAFETY GLAZING INSTALLED IN ACCORDANCE WITH CBC 2406 & 2407.

K1-8 KITCHEN PROJECT NOTES

- KITCHEN FAUCETS SHALL HAVE A MAX. FLOW RATE OF 1.5 G.P.M MEASURED AT 60 PSI. GARBAGE DISPOSAL UNITS AT KITCHEN SINKS SHALL BE PROVIDED WITH
- REQUIRED AIR GAP. GAS COOKING APPLIANCES SHALL BE UL LISTED & INSTALLED PER MANUF. INSTRUCTIONS. PROVIDE GAS SHUT-OFF VALVE IN APPROVED,
- ACCESSIBLE LOCATION. RESIDENTIAL RANGEHOOD EXHAUST PER CMC 403.7. SHALL MEET REQUIREMENTS OF CMC 504.2. EXHAUST TERMINATION SHALL BE LOCATED AT LEAST 3'-0" AWAY FROM PROPERTY LINES AND BUILDING OPENINGS & BE PROVIDED WITH WEATHERPROOF BACKDRAFT DAMPER. WHERE REMOTE EXHAUST OR BOOSTER FANS ARE REQUIRED, FAN SHALL BE ON DEDICATED CIRCUIT.
- UPPER CABINETS SHALL BE MIN. 30" ABOVE COOKING TOP PER CMC 916.1.2. PROVIDE THE COOKING APPLIANCE MIN. CLEARANCE TO COMBUSTIBLES PER CMC.916.1.
- (N) DISHWASHERS SHALL BE PROVIDED WITH REQUIRED AIRGAP, HOT WATER STUB & DEDICATED CIRCUIT. (N) APPLIANCES TO BE UL LISTED AND INSTALLED PER MANUF.
- INSTRUCTIONS. INSTALLING CONTRACTOR SHALL COORDINATE ALL ELECTRICAL AND PLUMBING REQUIREMENTS WITH MANUF. SPECIFICATIONS. (N) CABINETRY AND NONPOROUS COUNTERTOPS THROUGHOUT, U.O.N.

B1-9 BATHROOM PROJECT NOTES

 \oplus

16

- (N) NONPOROUS SLAB COUNTERTOP & SPLASH. GLASS SHOWER ENCLOSURES SAFETY GLAZING SUBJECT TO HUMAN IMPACT LOADS INSTALLED IN ACCORDANCE W/ CBC 2406 & 2407. SHOWER DOORS SHALL PROVIDE MIN 22" CLEAR OPENING WIDTH, PER CPC 408.5. SHOWER COMPARTMENTS & WALLS ABOVE TUBS w/ SHOWERHEADS SHALL BE FINISHED WITH A SMOOTH NONABSORBENT SURFACE TO
- A HEIGHT NOT LESS THAN 70" ABOVE DRAIN INLET. CBC 1210.3 NONPAPER-FACED BACKER BOARD TO BE USED IN ALL TUB, SHOWER & SPA AREAS. (WATER-RESISTANT TO A HEIGHT AS INDICATED ABOVE).
- SHOWER PER CPC 408. MIN FLOOR AREA OF 1024 SQUARE INCHES & CAPABLE OF ENCOMPASSING A 30" CIRCLE. THE AREA & DIMENSION SHALL BE MAINTAINED TO A POINT NOT LESS THAN 70" ABOVE THE SHOWER DRAIN. DRAIN INLET MIN. 2" MAX. 9" BELOW THRESHOLD INTO SHOWER.
- SHOWER HEADS SHALL HAVE A MAX. FLOW RATE OF 2.0 GPM MEASURED AT 80 PSI.
- SHOWER VALVES & HEADS SHALL BE PLACED INSIDE SHOWER COMPARTMENT SUCH THAT SHOWER HEAD DOES NOT DISCHARGE DIRECTLY TOWARD THE ENTRANCE OF THE COMPARTMENT AND THE BATHER CAN ADJUST VALVES PRIOR TO STEPPING INTO SHOWER SPRAY
- WATER CLOSET PER CBC 2903 CENTERED WITHIN 30" WIDE CLEAR SPACE. TOILETS SHALL HAVE MAX. 1.28 GPF WATER CONSUMPTION. BATH & LAUNDRY ROOM FAUCETS SHALL HAVE A MAX. FLOW RATE OF
- 1.5 GPM MEASURED AT 60 PSI. PROVIDE EXHAUST FAN CAPABLE OF PROVIDING 5 AIR CHANGES PER HOUR.

VENT TO OUTSIDE. PROVIDE BACKDRAFT DAMPER

L1-5 LAUNDRY & MECHANICAL ROOM PROJECT NOTES


- CLOTHES WASHER: PROVIDE FLUSH MOUNT 'GUY BOX' FOR HOT & COLD WATER & DRAIN CONNECTIONS.
- CONVENTIONAL CLOTHES DRYER: PROVIDE OPENING OF 100 SQ. INCHES MIN. FOR MAKE-UP AIR AT DOORS ENCLOSING APPLIANCE PER CMC 504.3.2. DIRECT EXHAUST TO OUTSIDE USING STEEL, SMOOTH BORE, 4" MIN. DIA. DUCT. PROVIDE WEATHERPROOF CAP & BACKDRAFT DAMPER. TERMINATE VENT MIN. 3'-0" FROM OPERABLE WINDOWS & DOORS PER CMC 504.5. PROVIDE IN-LINE BOOSTER FAN FOR DUCT RUNS OVER 14'-0" IN LENGTH. PROVIDE GAS SHUTOFF VALVE IN APPROVED LOCATION. CONDENSING DRYERS TO HAVE DRAIN & DRAIN PAN.
- PROVIDE DRAIN PAN @ TANK WATER HEATERS AND CLOTHES WASHERS INSTALLED OVER LIVING SPACE.
- WATER HEATER TO BE PROVIDED WITH SEISMIC STRAPPING PER CPC 510.5 ROOMS CONTAINING GAS CONSUMING SPACE AND WATER HEATING EQUIPMENT SHALL BE PROVIDED WITH COMBUSTION AIR OPENINGS IN COMPLIANCE WITH CMC CHAPTER 7.

45 MIN DOOR

EXIT PATH

PLAN LEGEND

 \oplus

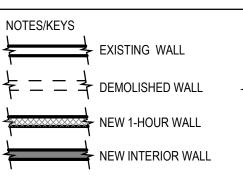



HOOD THOMAS ARCHITECTS

440 SPEAR STREET SAN FRANCISCO, CALIFORNIA 94105 P:(415)543-5005 F:(415)495-3336 WWW.HOODTHOMAS.COM



1148 Montgomery St. San Francisco, CA 94133

Block: 0134 Lot: 025

ISSUE:	DATE:
BLDG. PERMIT APP.	09.19.16
VARIANCE APP.	03.01.17
VARIANCE APP.	08.18.17


DRAWN BY:	MM, DF
DATE:	03.01.17
SHEET TITLE:	

EXISTING & PROPOSED **2ND FLOOR** PLANS

SHEET NUMBER:



DATE:

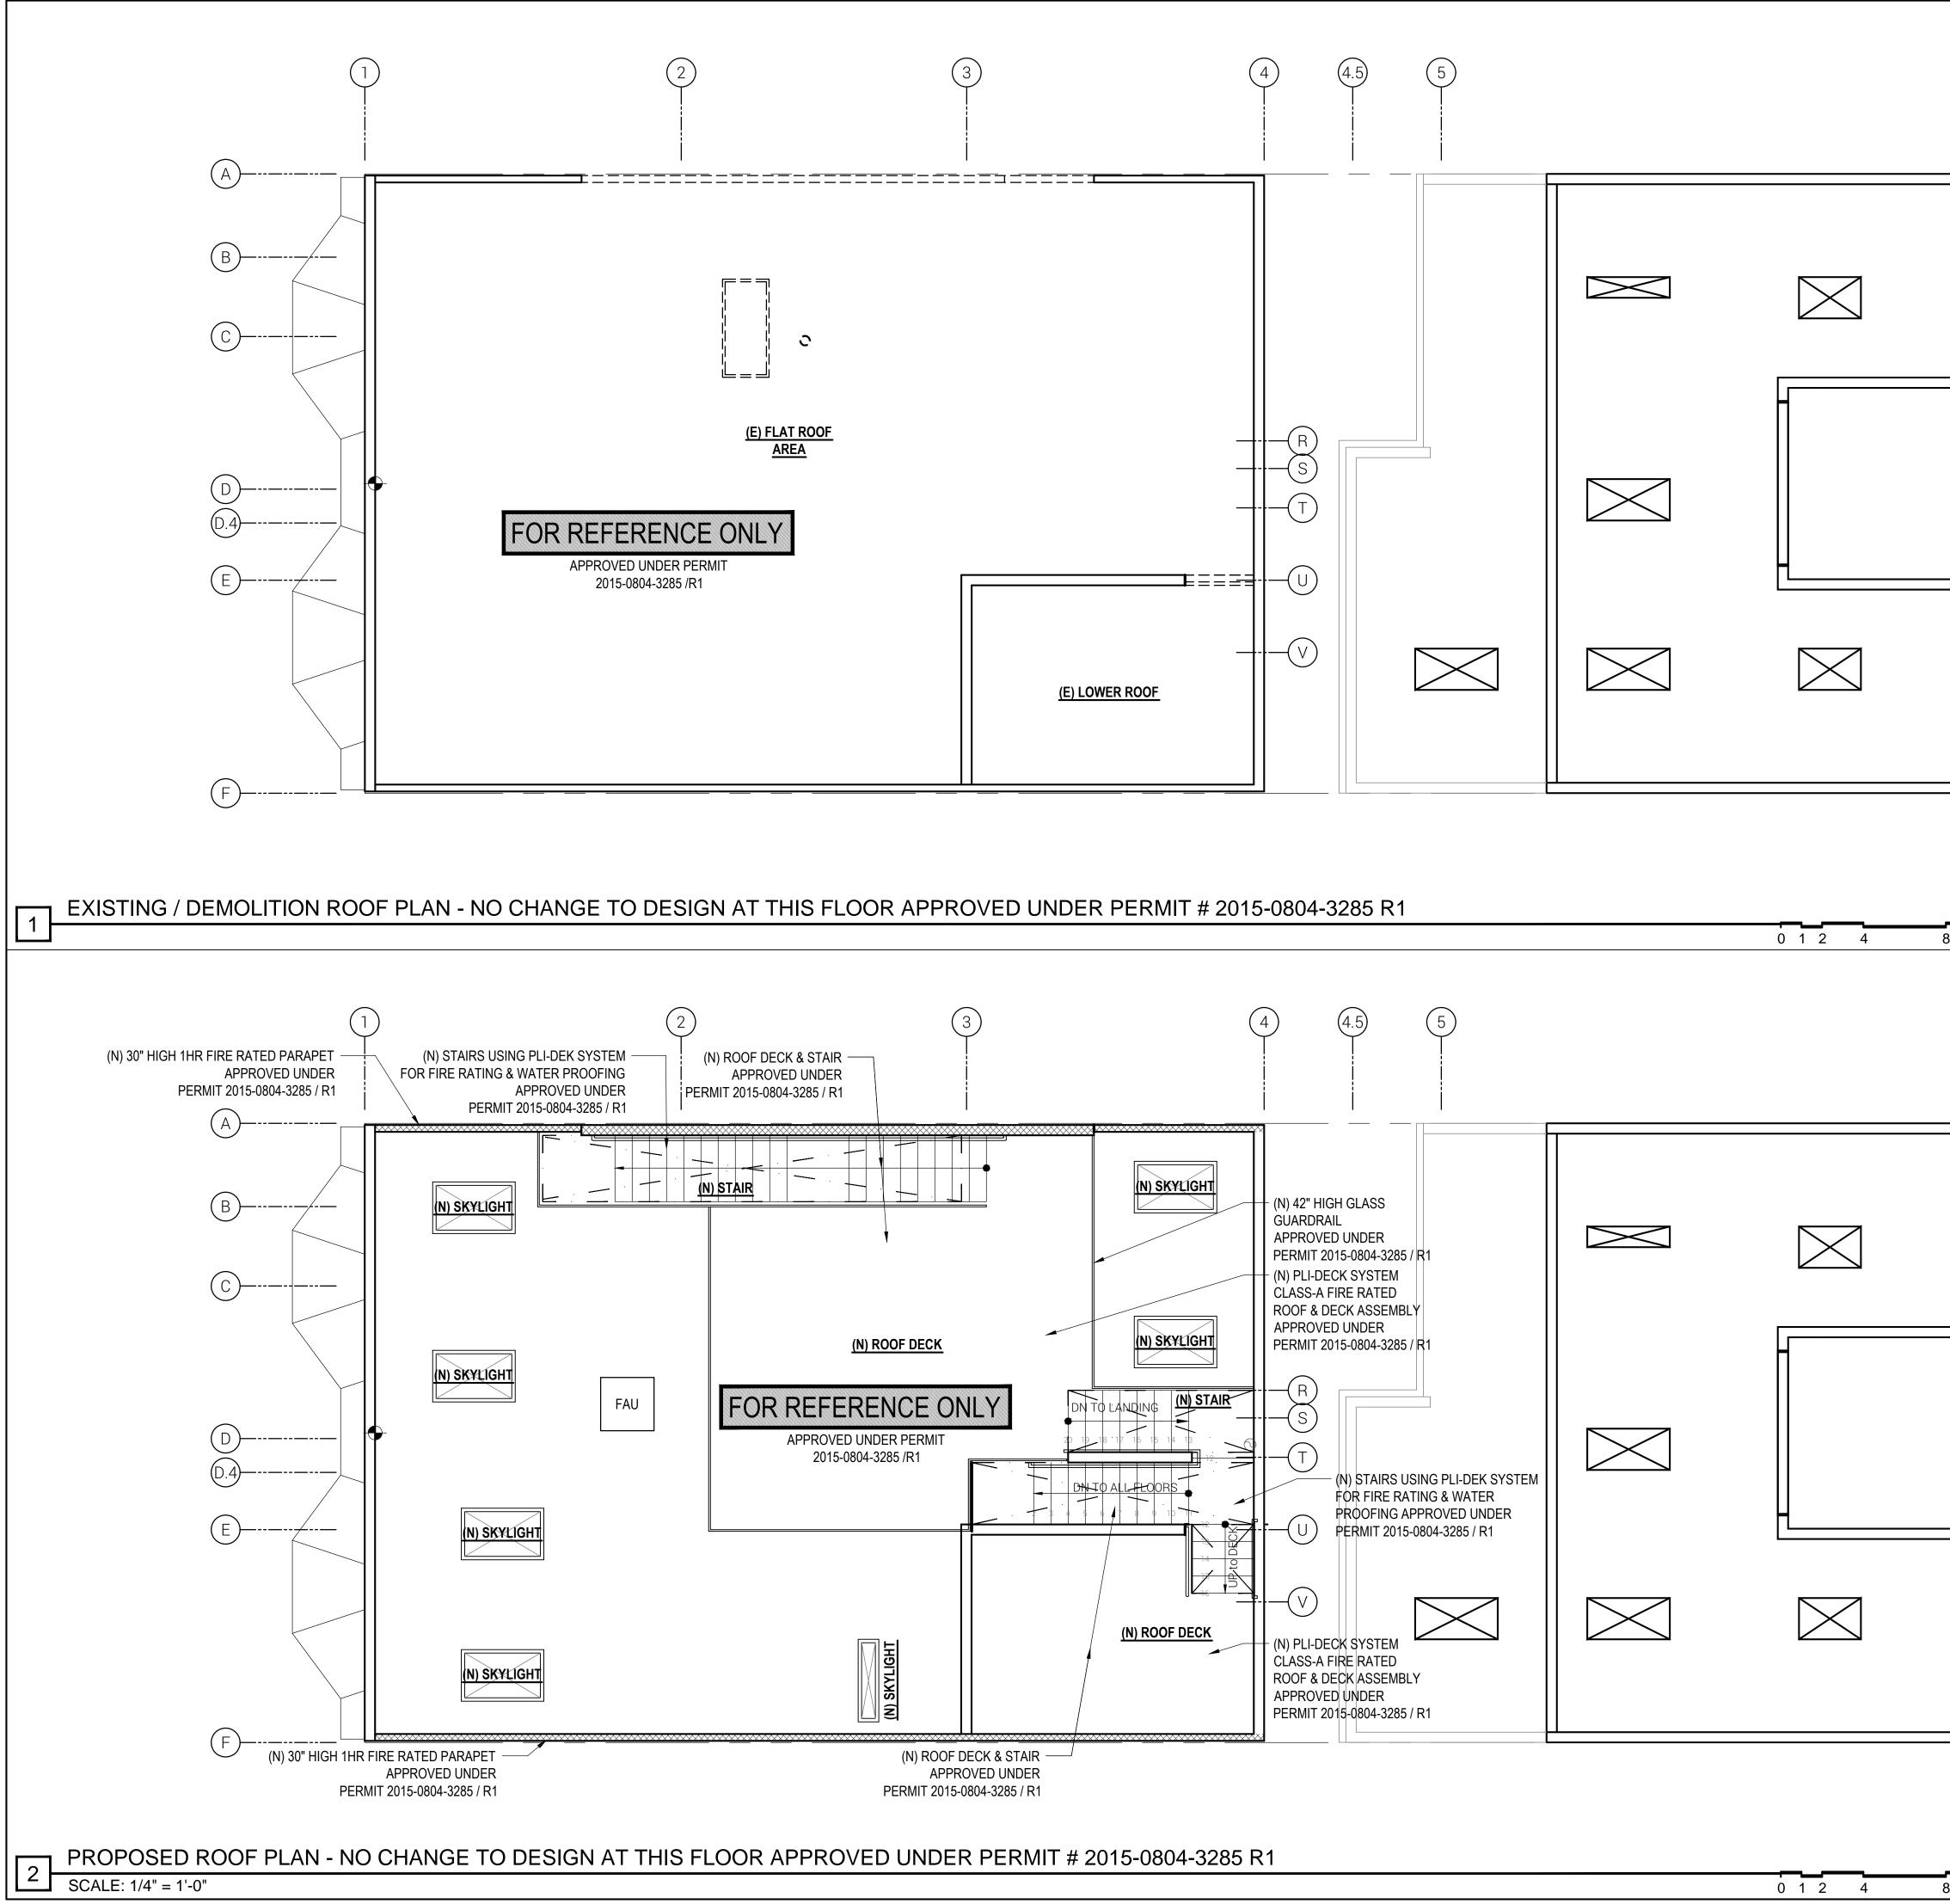

FLOOR PLAN KEYNOTES

- DRAWING SET GENERAL NOTES SEE SHEET A0.0 FOR GENERAL CONSTRUCTION NOTES
- SEE SHEET EMP1.1 FOR ELECTRICAL & MECHANICAL NOTES & PLANS DIMENSIONS SHOWN IN PLANS AND ELEVATIONS ARE TAKEN FROM FACE OF WALLBOARD AT INTERIOR WALLS AND FACE OF EXTERIOR FINISH AT

EXTERIOR WALLS, U.O.N. DOORS, WINDOW AND SKYLIGHT PROJECT NOTES PRIMARY EXIT DOORS SHALL MEET THE REQUIREMENTS OF CBC SECTION 1008 FOR SIZE, PROJECTIONS INTO CLEAR WIDTH OF EGRESS PATH, DOOR SWING, &

- OPENING FORCE. DOORS SHALL BE PROVIDED WITH A MIN. 36" X 36" LEVEL LANDING ON EACH SIDE OF THE DOORS EXCEPT AS FOLLOWS: LANDINGS AT THE EXTERIOR SIDE OF A DOOR
- MAY BE A MAX. OF 7 $\frac{3}{4}$ " BELOW THE THRESHOLD PROVIDED THE DOOR DOES NOT SWING OVER THE LANDING. FOR DOORS THAT SWING OVER THE LANDING THE MAX. DISTANCE BELOW THE THRESHOLD IS $\frac{1}{2}$ " PER CBC 1008.1.5. SLIDING GLASS DOORS SHALL HAVE A MAX. ¹/₂" LEVEL CHANGE FROM THRESHOLD.
- DOORWAY BETWEEN GARAGES & HABITABLE SPACE SHALL BE PROVIDED WITH EITHER SOLID WOOD DOORS OR SOLID OR HONEYCOMB CORE STEEL DOORS NOT LESS THAN 1 ³/₈" THICK & PROVIDED WITH SELF CLOSING AND SELF LATCHING H HARDWARE.
- PROVIDE LISTED, GASKETED DOORS w/ LISTED SELF CLOSING DEVICE & BOTTOM SEAL AT THRESHOLD PER CMC 904.1 WHERE COMPARTMENTS CONTAINING FURNACES & BOILERS ARE INSTALLED IN BEDROOMS OR BATHROOMS.
- (N) WINDOWS PER WINDOW SCHEDULE INCLUDED IN THIS DRAWING SET SHALL COMPLY WITH TITLE 24 REQUIREMENTS. SEE SCHEDULE FOR ADDITIONAL NOTES. EMERGENCY ESCAPE & RESCUE WINDOWS REQUIRED AT SLEEPING AREAS SHALL MEET THE FOLLOWING REQUIREMENTS: MIN. 5.7' CLEAR OPENING, MIN. 24" CLEAR HEIGHT, MIN. 20" CLEAR WIDTH, SILL HEIGHT MAX. 44" AFF.

	LIGHT / AIR REQUIRED BY CBC SEC 1205.2 & 1203.4.1		
	UNIT #E #E BEDROOM UNIT #F		
LIVING AREA	462 SF	123 SF	424 SF
LIGHT 8%	36.96 SF	9.84 SF	33.92 SF
LIGHT PROV.	40.0 SF	30.0 SF	39.58 SF
AIR 4%	18.48 SF	4.92 SF	16.96 SF
AIR PROV.	25.0 SF	30.0 SF	19.79 SF

W3. WINDOWS IN LOCATIONS SUBJECT TO HUMAN IMPACT LOADS SHALL BE PROVIDED WITH SAFETY GLAZING INSTALLED IN ACCORDANCE WITH CBC 2406 & 2407.

K1-8 KITCHEN PROJECT NOTES

- KITCHEN FAUCETS SHALL HAVE A MAX. FLOW RATE OF 1.5 G.P.M MEASURED AT 60 PSI. GARBAGE DISPOSAL UNITS AT KITCHEN SINKS SHALL BE PROVIDED WITH
- REQUIRED AIR GAP. GAS COOKING APPLIANCES SHALL BE UL LISTED & INSTALLED PER MANUF. INSTRUCTIONS. PROVIDE GAS SHUT-OFF VALVE IN APPROVED,
- ACCESSIBLE LOCATION. RESIDENTIAL RANGEHOOD EXHAUST PER CMC 403.7. SHALL MEET REQUIREMENTS OF CMC 504.2. EXHAUST TERMINATION SHALL BE LOCATED AT LEAST 3'-0" AWAY FROM PROPERTY LINES AND BUILDING OPENINGS & BE PROVIDED WITH WEATHERPROOF BACKDRAFT DAMPER. WHERE REMOTE EXHAUST OR BOOSTER FANS ARE REQUIRED, FAN SHALL BE ON DEDICATED CIRCUIT.
- UPPER CABINETS SHALL BE MIN. 30" ABOVE COOKING TOP PER CMC 916.1.2. PROVIDE THE COOKING APPLIANCE MIN. CLEARANCE TO COMBUSTIBLES PER CMC.916.1.
- (N) DISHWASHERS SHALL BE PROVIDED WITH REQUIRED AIRGAP, HOT WATER STUB & DEDICATED CIRCUIT. (N) APPLIANCES TO BE UL LISTED AND INSTALLED PER MANUF.
- INSTRUCTIONS. INSTALLING CONTRACTOR SHALL COORDINATE ALL ELECTRICAL AND PLUMBING REQUIREMENTS WITH MANUF. SPECIFICATIONS. (N) CABINETRY AND NONPOROUS COUNTERTOPS THROUGHOUT, U.O.N.

B1-9 BATHROOM PROJECT NOTES

16

- (N) NONPOROUS SLAB COUNTERTOP & SPLASH. GLASS SHOWER ENCLOSURES SAFETY GLAZING SUBJECT TO HUMAN IMPACT LOADS INSTALLED IN ACCORDANCE W/ CBC 2406 & 2407. SHOWER DOORS SHALL PROVIDE MIN 22" CLEAR OPENING WIDTH, PER CPC 408.5. SHOWER COMPARTMENTS & WALLS ABOVE TUBS w/ SHOWERHEADS SHALL BE FINISHED WITH A SMOOTH NONABSORBENT SURFACE TO
- A HEIGHT NOT LESS THAN 70" ABOVE DRAIN INLET. CBC 1210.3 NONPAPER-FACED BACKER BOARD TO BE USED IN ALL TUB, SHOWER & SPA AREAS. (WATER-RESISTANT TO A HEIGHT AS INDICATED ABOVE).
- SHOWER PER CPC 408. MIN FLOOR AREA OF 1024 SQUARE INCHES & CAPABLE OF ENCOMPASSING A 30" CIRCLE. THE AREA & DIMENSION SHALL BE MAINTAINED TO A POINT NOT LESS THAN 70" ABOVE THE SHOWER DRAIN. DRAIN INLET MIN. 2" MAX. 9" BELOW THRESHOLD INTO SHOWER.
- SHOWER HEADS SHALL HAVE A MAX. FLOW RATE OF 2.0 GPM MEASURED AT 80 PSI.
- SHOWER VALVES & HEADS SHALL BE PLACED INSIDE SHOWER COMPARTMENT SUCH THAT SHOWER HEAD DOES NOT DISCHARGE DIRECTLY TOWARD THE ENTRANCE OF THE COMPARTMENT AND THE BATHER CAN ADJUST VALVES PRIOR TO STEPPING INTO SHOWER SPRAY
- WATER CLOSET PER CBC 2903 CENTERED WITHIN 30" WIDE CLEAR SPACE. TOILETS SHALL HAVE MAX. 1.28 GPF WATER CONSUMPTION. BATH & LAUNDRY ROOM FAUCETS SHALL HAVE A MAX. FLOW RATE OF
- 1.5 GPM MEASURED AT 60 PSI. PROVIDE EXHAUST FAN CAPABLE OF PROVIDING 5 AIR CHANGES PER HOUR. VENT TO OUTSIDE. PROVIDE BACKDRAFT DAMPER


L1-5 | LAUNDRY & MECHANICAL ROOM PROJECT NOTES

- CLOTHES WASHER: PROVIDE FLUSH MOUNT 'GUY BOX' FOR HOT & COLD WATER & DRAIN CONNECTIONS.
- CONVENTIONAL CLOTHES DRYER: PROVIDE OPENING OF 100 SQ. INCHES MIN. FOR MAKE-UP AIR AT DOORS ENCLOSING APPLIANCE PER CMC 504.3.2. DIRECT EXHAUST TO OUTSIDE USING STEEL, SMOOTH BORE, 4" MIN. DIA. DUCT. PROVIDE WEATHERPROOF CAP & BACKDRAFT DAMPER. TERMINATE VENT MIN. 3'-0" FROM OPERABLE WINDOWS & DOORS PER CMC 504.5. PROVIDE IN-LINE BOOSTER FAN FOR DUCT RUNS OVER 14'-0" IN LENGTH. PROVIDE GAS SHUTOFF VALVE IN APPROVED LOCATION. CONDENSING DRYERS TO HAVE DRAIN & DRAIN PAN.
- PROVIDE DRAIN PAN @ TANK WATER HEATERS AND CLOTHES WASHERS INSTALLED OVER LIVING SPACE.
- WATER HEATER TO BE PROVIDED WITH SEISMIC STRAPPING PER CPC 510.5 ROOMS CONTAINING GAS CONSUMING SPACE AND WATER HEATING EQUIPMENT SHALL BE PROVIDED WITH COMBUSTION AIR OPENINGS IN COMPLIANCE WITH CMC CHAPTER 7.

PLAN LEGEND

 \oplus

16

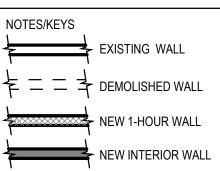



HTA!

HOOD THOMAS ARCHITECTS

440 SPEAR STREET SAN FRANCISCO, CALIFORNIA 94105 P:(415)543-5005 F:(415)495-3336 WWW.HOODTHOMAS.COM



1148 Montgomery St. San Francisco, CA 94133

Block: 0134 Lot: 025

ISSUE:	DATE:
BLDG. PERMIT APP.	09.19.16
VARIANCE APP.	03.01.17
VARIANCE APP.	08.18.17


03.01.17

EXISTING &PROPOSED **ROOF PLANS**

SHEET NUMBER:





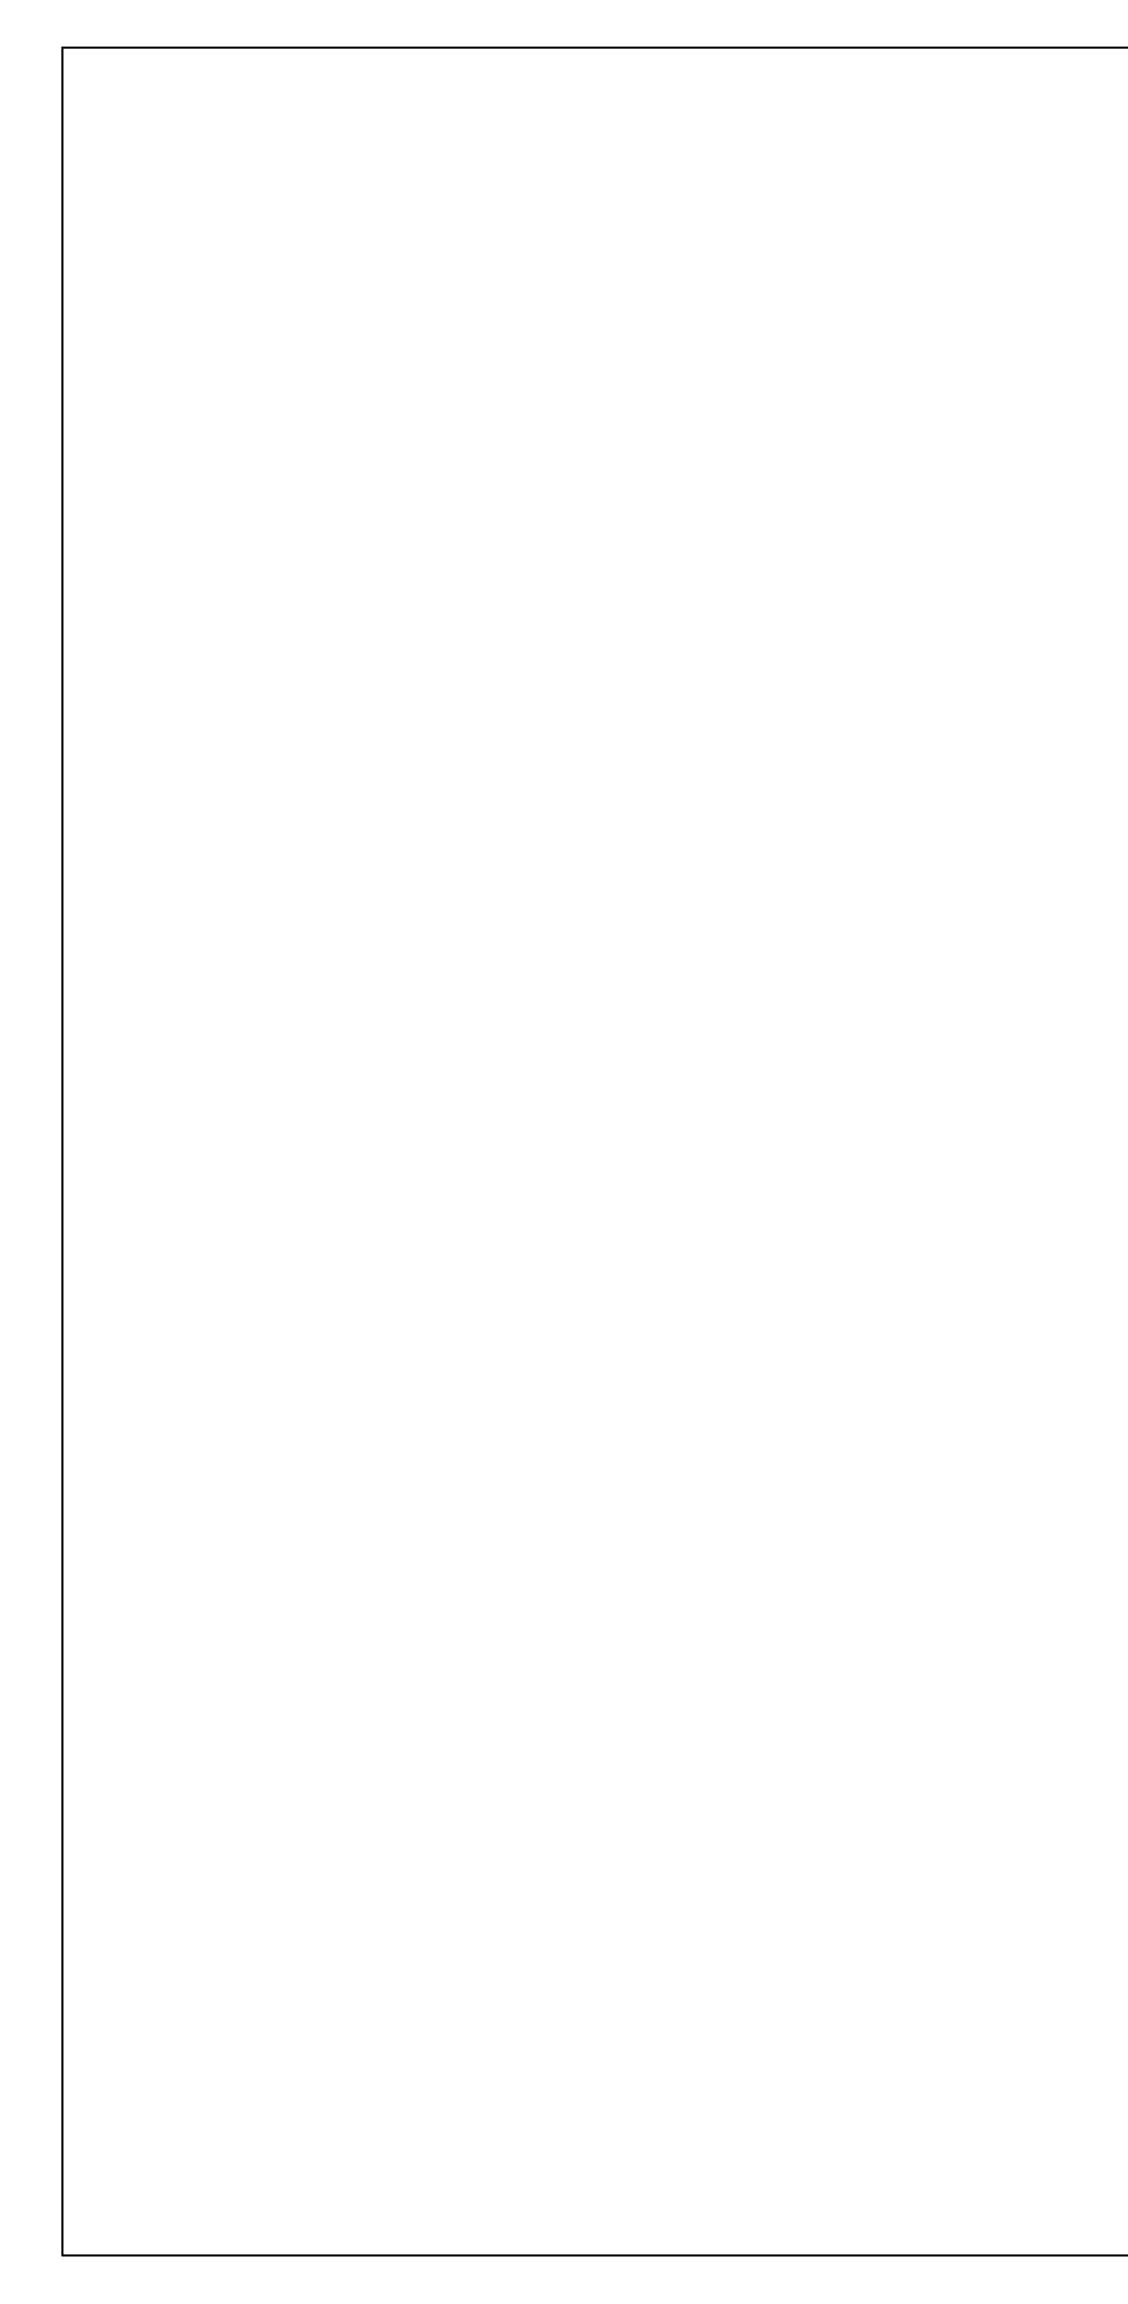

PROPOSED REAR (EAST) EXTERIOR ELEVATION SCALE: 1/4" = 1'-0"







- DRAWING SET GENERAL NOTES1.1SEE SHEET A0.0 FOR GENERAL CONSTRUCTION NOTES
- SEE SHEET EMP1.1 FOR ELECTRICAL & MECHANICAL NOTES & PLANS
 DIMENSIONS SHOWN IN PLANS AND ELEVATIONS ARE TAKEN FROM FACE OF WALLBOARD AT INTERIOR WALLS AND FACE OF EXTERIOR FINISH AT EXTERIOR WALLS, U.O.N.

DOORS, WINDOW AND SKYLIGHT PROJECT NOTES

- D1. PRIMARY EXIT DOORS SHALL MEET THE REQUIREMENTS OF CBC SECTION 1008 FOR SIZE, PROJECTIONS INTO CLEAR WIDTH OF EGRESS PATH, DOOR SWING, & OPENING FORCE.
- **D2.** DOORS SHALL BE PROVIDED WITH A MIN. 36" X 36" LEVEL LANDING ON EACH SIDE OF THE DOORS EXCEPT AS FOLLOWS: LANDINGS AT THE EXTERIOR SIDE OF A DOOR MAY BE A MAX. OF 7 $\frac{3}{4}$ " BELOW THE THRESHOLD PROVIDED THE DOOR DOES NOT SWING OVER THE LANDING. FOR DOORS THAT SWING OVER THE LANDING THE MAX. DISTANCE BELOW THE THRESHOLD IS $\frac{1}{2}$ " PER CBC 1008.1.5. SLIDING GLASS DOORS SHALL HAVE A MAX. $\frac{1}{4}$ " LEVEL CHANGE FROM THRESHOLD.
- DOORWAY BETWEEN GARAGES & HABITABLE SPACE SHALL BE PROVIDED WITH EITHER SOLID WOOD DOORS OR SOLID OR HONEYCOMB CORE STEEL DOORS NOT LESS THAN 1³/₈" THICK & PROVIDED WITH SELF CLOSING AND SELF LATCHING H HARDWARE.
- D4. PROVIDE LISTED, GASKETED DOORS w/ LISTED SELF CLOSING DEVICE & BOTTOM SEAL AT THRESHOLD PER CMC 904.1 WHERE COMPARTMENTS CONTAINING FURNACES & BOILERS ARE INSTALLED IN BEDROOMS OR BATHROOMS.
- (N) WINDOWS PER WINDOW SCHEDULE INCLUDED IN THIS DRAWING SET SHALL COMPLY WITH TITLE 24 REQUIREMENTS. SEE SCHEDULE FOR ADDITIONAL NOTES.
 EMERGENCY ESCAPE & RESCUE WINDOWS REQUIRED AT SLEEPING AREAS SHALL MEET THE FOLLOWING REQUIREMENTS: MIN. 5.7' CLEAR OPENING, MIN. 24" CLEAR HEIGHT, MIN. 20" CLEAR WIDTH, SILL HEIGHT MAX. 44" AFF.

	LIGHT / AIR REQUIRED BY CBC SEC 1205.2 & 1203.4.1			
	UNIT #E	#E BEDROOM	UNIT #F	
LIVING AREA	462 SF	123 SF	424 SF	
LIGHT 8%	36.96 SF	9.84 SF	33.92 SF	
LIGHT PROV.	40.0 SF	30.0 SF	39.58 SF	
AIR 4%	18.48 SF	4.92 SF	16.96 SF	
AIR PROV.	25.0 SF	30.0 SF	19.79 SF	

W3. WINDOWS IN LOCATIONS SUBJECT TO HUMAN IMPACT LOADS SHALL BE PROVIDED WITH SAFETY GLAZING INSTALLED IN ACCORDANCE WITH CBC 2406 & 2407.

K1-8 KITCHEN PROJECT NOTES

- KITCHEN FAUCETS SHALL HAVE A MAX. FLOW RATE OF 1.5 G.P.M MEASURED AT 60 PSI.
 GARBAGE DISPOSAL UNITS AT KITCHEN SINKS SHALL BE PROVIDED WITH
- GAS COOKING APPLIANCES SHALL BE UL LISTED & INSTALLED PER MANUF. INSTRUCTIONS. PROVIDE GAS SHUT-OFF VALVE IN APPROVED,
- ACCESSIBLE LOCATION. K4. RESIDENTIAL RANGEHOOD EXHAUST PER CMC 403.7. SHALL MEET REQUIREMENTS OF CMC 504.2. EXHAUST TERMINATION SHALL BE LOCATED AT LEAST 3'-0" AWAY FROM PROPERTY LINES AND BUILDING OPENINGS & BE PROVIDED WITH WEATHERPROOF BACKDRAFT DAMPER. WHERE REMOTE EXHAUST OR BOOSTER FANS ARE REQUIRED, FAN SHALL BE ON DEDICATED CIRCUIT.
- VICE AND ADDRESS SHALL BE MIN. 30" ABOVE COOKING TOP PER CMC 916.1.2. PROVIDE THE COOKING APPLIANCE MIN. CLEARANCE TO COMBUSTIBLES PER CMC.916.1.
- K6. (N) DISHWASHERS SHALL BE PROVIDED WITH REQUIRED AIRGAP, HOT WATER STUB & DEDICATED CIRCUIT.
 (N) ADDIVANCES TO DE UN LIGTED AND INSTALLED DED MANUE
- K7. (N) APPLIANCES TO BE UL LISTED AND INSTALLED PER MANUF. INSTRUCTIONS. INSTALLING CONTRACTOR SHALL COORDINATE ALL ELECTRICAL AND PLUMBING REQUIREMENTS WITH MANUF. SPECIFICATIONS.
- (8. (N) CABINETRY AND NONPOROUS COUNTERTOPS THROUGHOUT, U.O.N.

B1-9 BATHROOM PROJECT NOTES


- (N) NONPOROUS SLAB COUNTERTOP & SPLASH.
 GLASS SHOWER ENCLOSURES SAFETY GLAZING SUBJECT TO HUMAN IMPACT LOADS INSTALLED IN ACCORDANCE W/ CBC 2406 & 2407. SHOWER DOORS SHALL PROVIDE MIN 22" CLEAR OPENING WIDTH, PER CPC 408.5.
 SHOWER COMPARTMENTS & WALLS ABOVE TUBS w/ SHOWERHEADS SHALL BE FINISHED WITH A SMOOTH NONABSORBENT SURFACE TO
- A HEIGHT NOT LESS THAN 70" ABOVE DRAIN INLET. CBC 1210.3 NONPAPER-FACED BACKER BOARD TO BE USED IN ALL TUB,SHOWER & SPA AREAS. (WATER-RESISTANT TO A HEIGHT AS INDICATED ABOVE).
- SHOWER PER CPC 408. MIN FLOOR AREA OF 1024 SQUARE INCHES & CAPABLE OF ENCOMPASSING A 30" CIRCLE. THE AREA & DIMENSION SHALL BE MAINTAINED TO A POINT NOT LESS THAN 70" ABOVE THE SHOWER DRAIN. DRAIN INLET MIN. 2" MAX. 9" BELOW
- THRESHOLD INTO SHOWER.
 SHOWER HEADS SHALL HAVE A MAX. FLOW RATE OF 2.0 GPM MEASURED AT 80 PSI.
- SHOWER VALVES & HEADS SHALL BE PLACED INSIDE SHOWER
 COMPARTMENT SUCH THAT SHOWER HEAD DOES NOT DISCHARGE
 DIRECTLY TOWARD THE ENTRANCE OF THE COMPARTMENT AND THE
 BATHER CAN ADJUST VALVES PRIOR TO STEPPING INTO SHOWER
 SPRAY.
- WATER CLOSET PER CBC 2903 CENTERED WITHIN 30" WIDE CLEAR SPACE. TOILETS SHALL HAVE MAX. 1.28 GPF WATER CONSUMPTION.
 BATH & LAUNDRY ROOM FAUCETS SHALL HAVE A MAX. FLOW RATE OF
- DATITY LANDER ROOM ACCE TO CHARLE HAVE A MAX. FLOW HATE OF 1.5 GPM MEASURED AT 60 PSI.
 PROVIDE EXHAUST FAN CAPABLE OF PROVIDING 5 AIR CHANGES PER HOUR.

L1-5 LAUNDRY & MECHANICAL ROOM PROJECT NOTES

VENT TO OUTSIDE. PROVIDE BACKDRAFT DAMPER

- I. CLOTHES WASHER: PROVIDE FLUSH MOUNT 'GUY BOX' FOR HOT & COLD WATER & DRAIN CONNECTIONS.
- CONVENTIONAL CLOTHES DRYER: PROVIDE OPENING OF 100 SQ. INCHES MIN. FOR MAKE-UP AIR AT DOORS ENCLOSING APPLIANCE PER CMC 504.3.2. DIRECT EXHAUST TO OUTSIDE USING STEEL, SMOOTH BORE, 4" MIN. DIA. DUCT. PROVIDE WEATHERPROOF CAP & BACKDRAFT DAMPER. TERMINATE VENT MIN. 3'-0" FROM OPERABLE WINDOWS & DOORS PER CMC 504.5. PROVIDE IN-LINE BOOSTER FAN FOR DUCT RUNS OVER 14'-0" IN LENGTH. PROVIDE GAS SHUTOFF VALVE IN APPROVED LOCATION. CONDENSING DRYERS TO HAVE DRAIN & DRAIN PAN.
- L3. PROVIDE DRAIN PAN @ TANK WATER HEATERS AND CLOTHES WASHERS INSTALLED OVER LIVING SPACE.
- WATER HEATER TO BE PROVIDED WITH SEISMIC STRAPPING PER CPC 510.5
 ROOMS CONTAINING GAS CONSUMING SPACE AND WATER HEATING EQUIPMENT SHALL BE PROVIDED WITH COMBUSTION AIR OPENINGS IN COMPLIANCE WITH CMC CHAPTER 7.

PLAN LEGEND

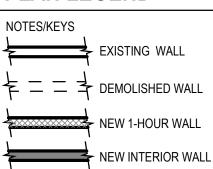



HTA!

HOOD THOMAS ARCHITECTS

440 SPEAR STREET SAN FRANCISCO, CALIFORNIA 94105 P:(415)543-5005 F:(415)495-3336 WWW.HOODTHOMAS.COM



1148 Montgomery St. San Francisco, CA 94133

Block: 0134 Lot: 025

ISSUE:	DATE:
BLDG. PERMIT APP.	09.19.16
VARIANCE APP.	03.01.17
VARIANCE APP.	08.18.17

DRAWN BY:	MM, DF
DATE:	03.01.17
SHEET TITLE:	

PROPOSED & PRE-APPROVED SIDE ELEVATIONS

SHEET NUMBER:



Δ

WINDOW


INSTALLATION

1 & 2 APPROVED


UNDER PERMIT


2015-0804-3285

AT FLOORS

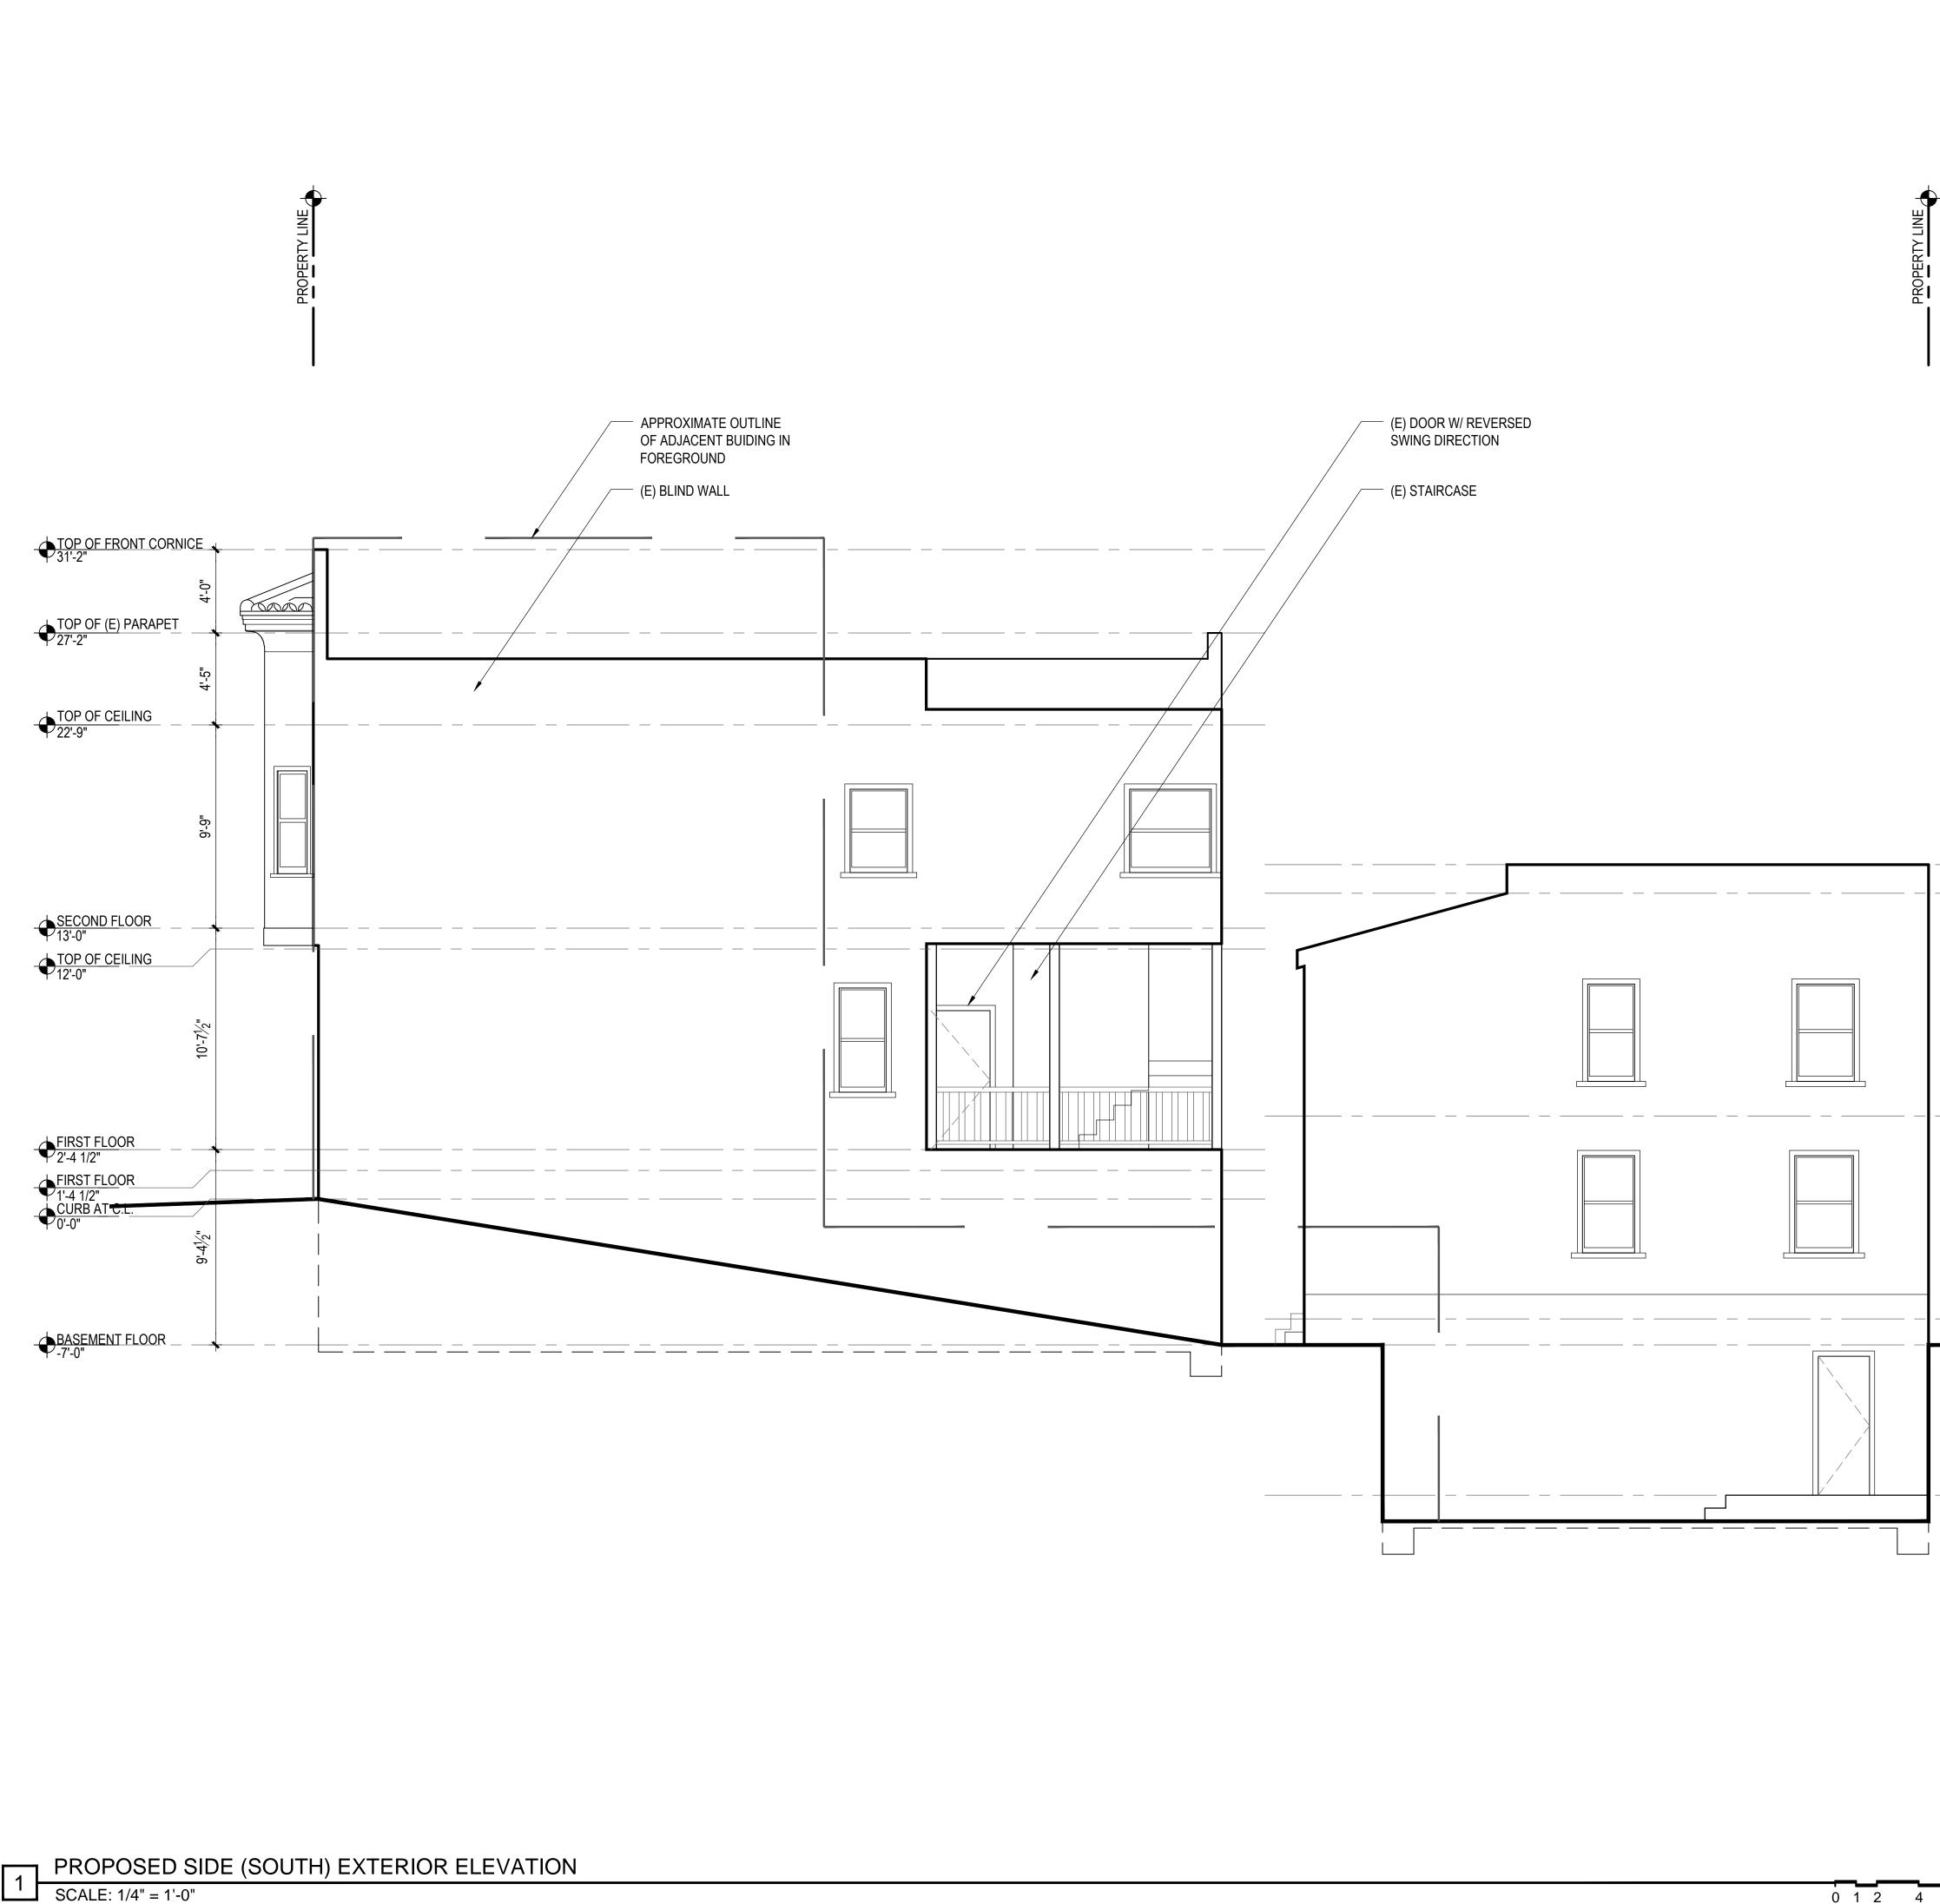

	<section-header><section-header><section-header><section-header><text><text></text></text></section-header></section-header></section-header></section-header>
PARAPET	
PARAPET 16'-0 1/2" ROOF 14'-8"	1148 Montgomery St. San Francisco, CA
	94133
	Block: 0134 Lot: 025
	ISSUE: DATE: BLDG. PERMIT APP. 09.19.16
	VARIANCE APP. 03.01.17 VARIANCE APP. 08.18.17
SECOND FLOOR 4'-0"	
FIRST FLOOR -5'-9" GRADE -7'-0"	
	DRAWN BY: MM, DF
	DATE: 03.01.17 SHEET TITLE:
, <u>BASEMENT</u> -14'-2 1/2"	EXISTINGSIDE (SOUTH) ELEVATION
	SHEET NUMBER:
	A2.3
16	REV # : DATE:

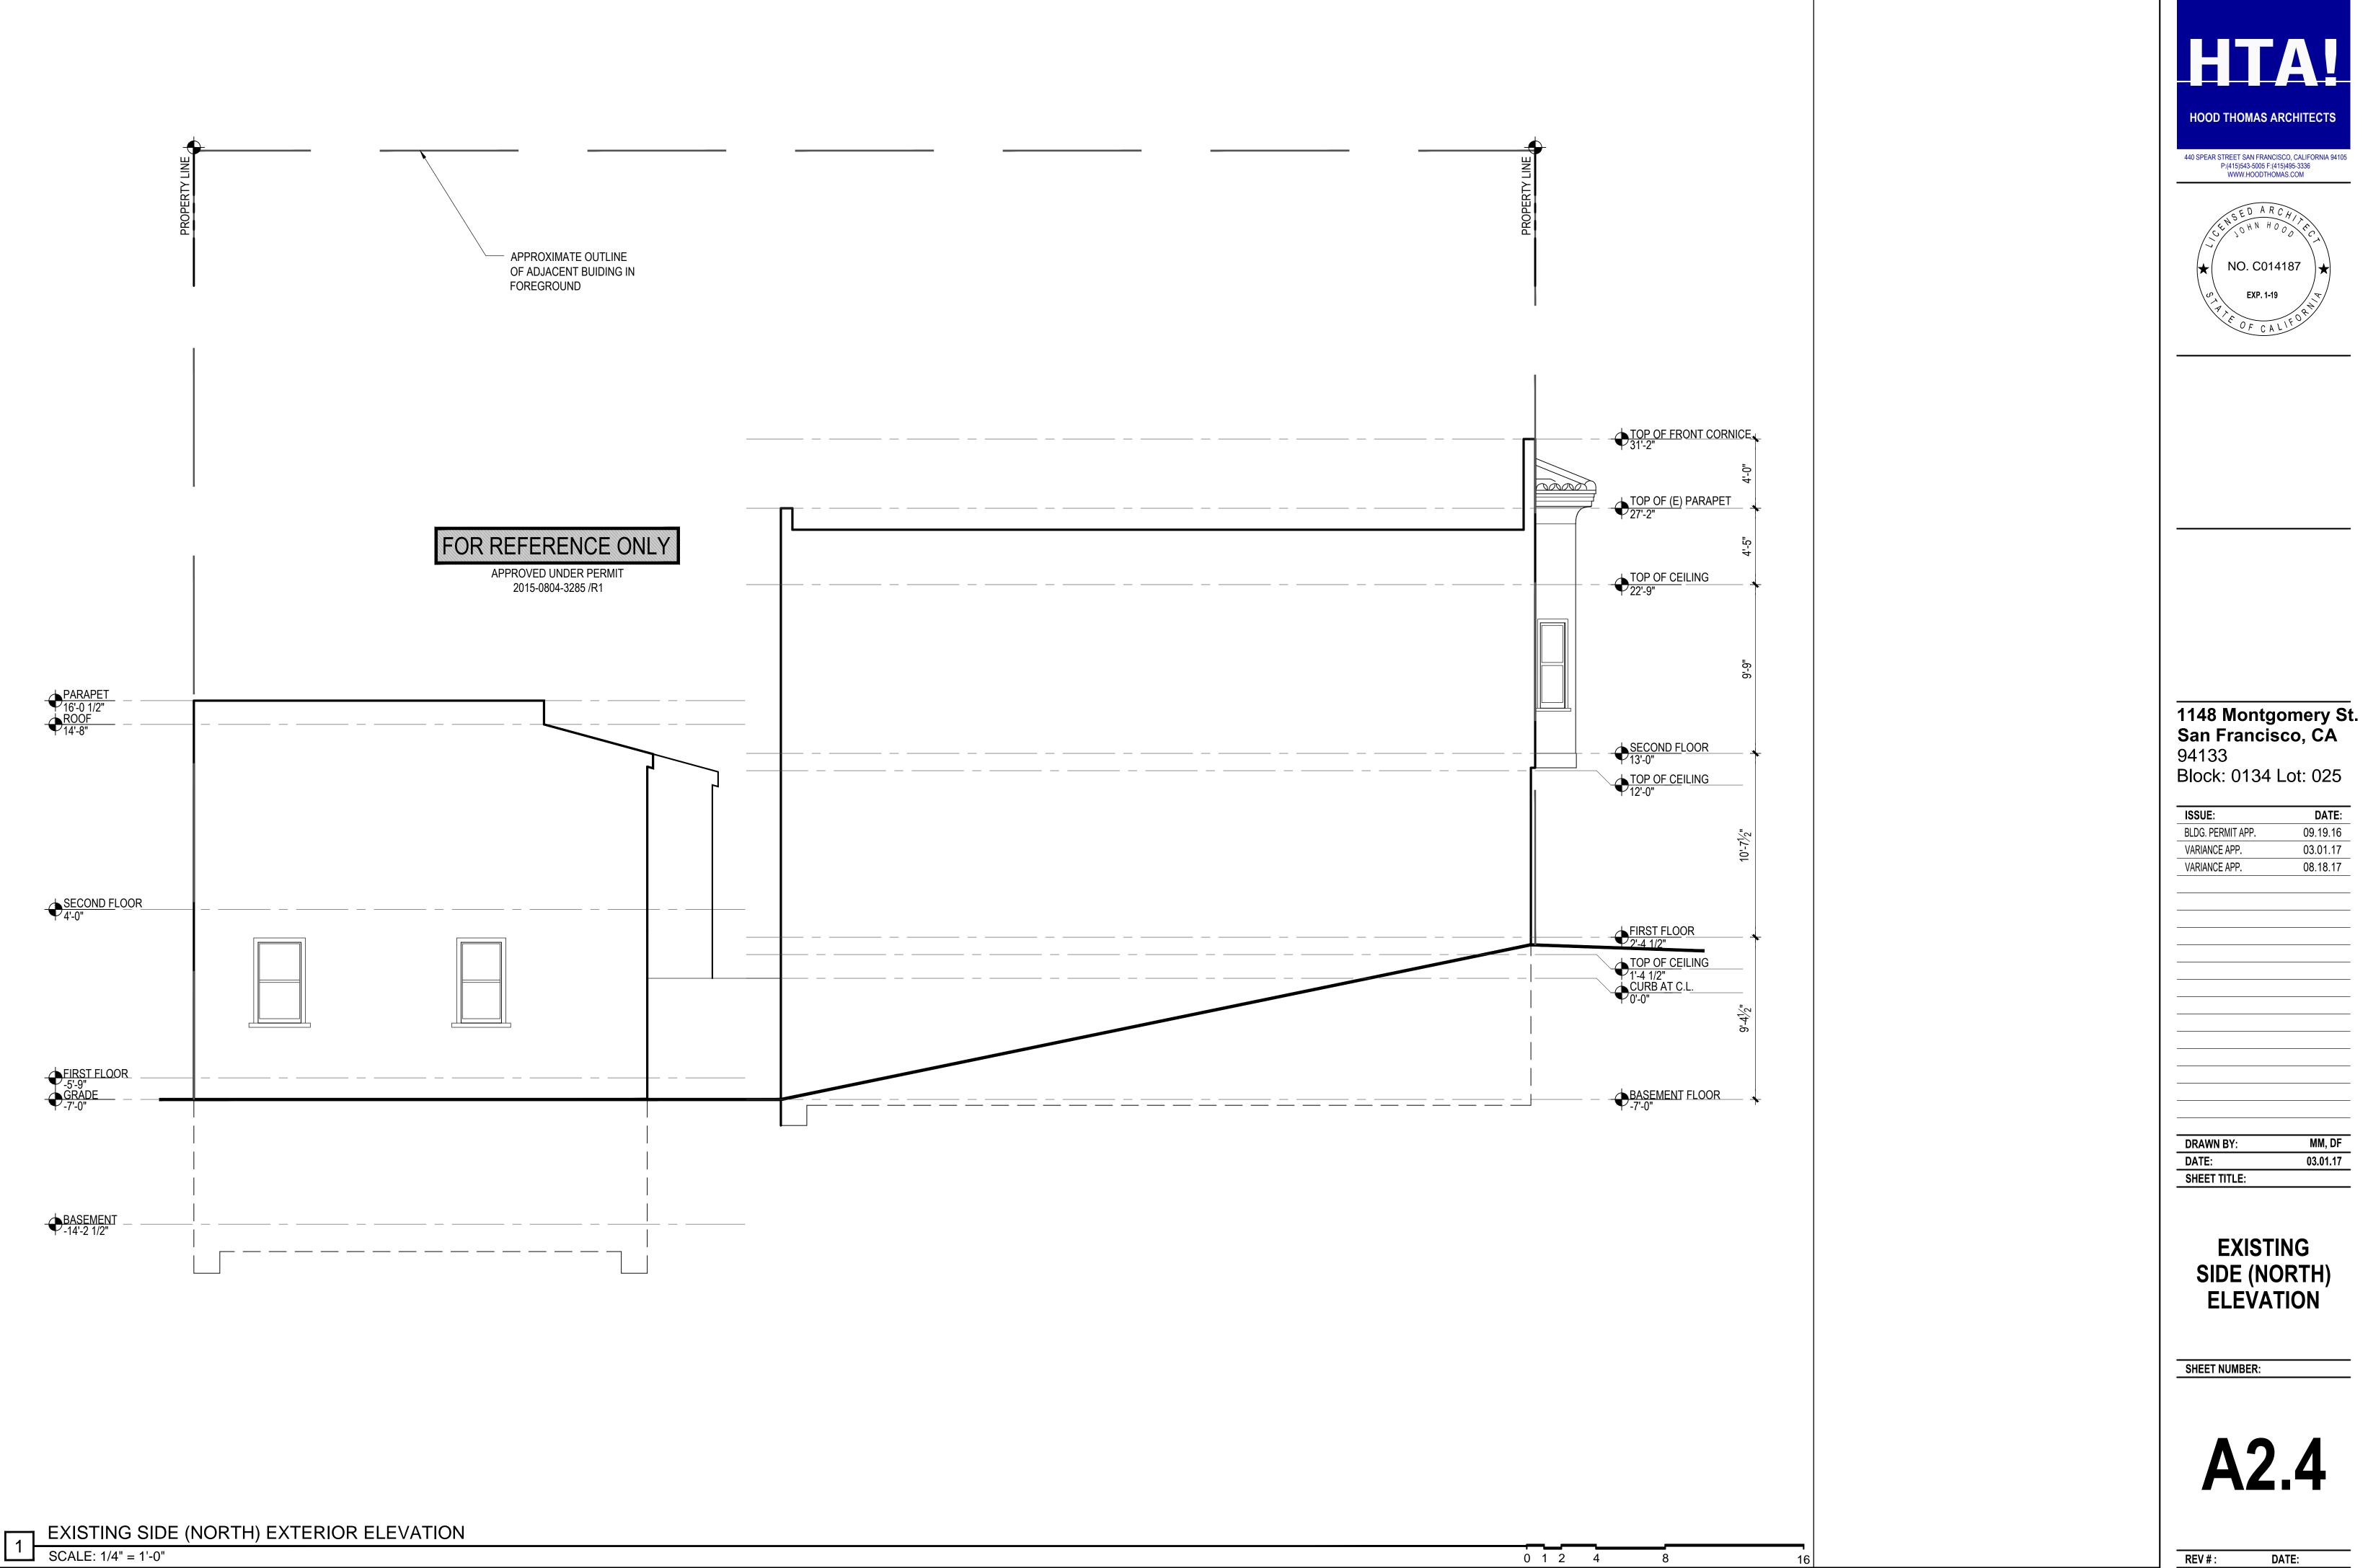

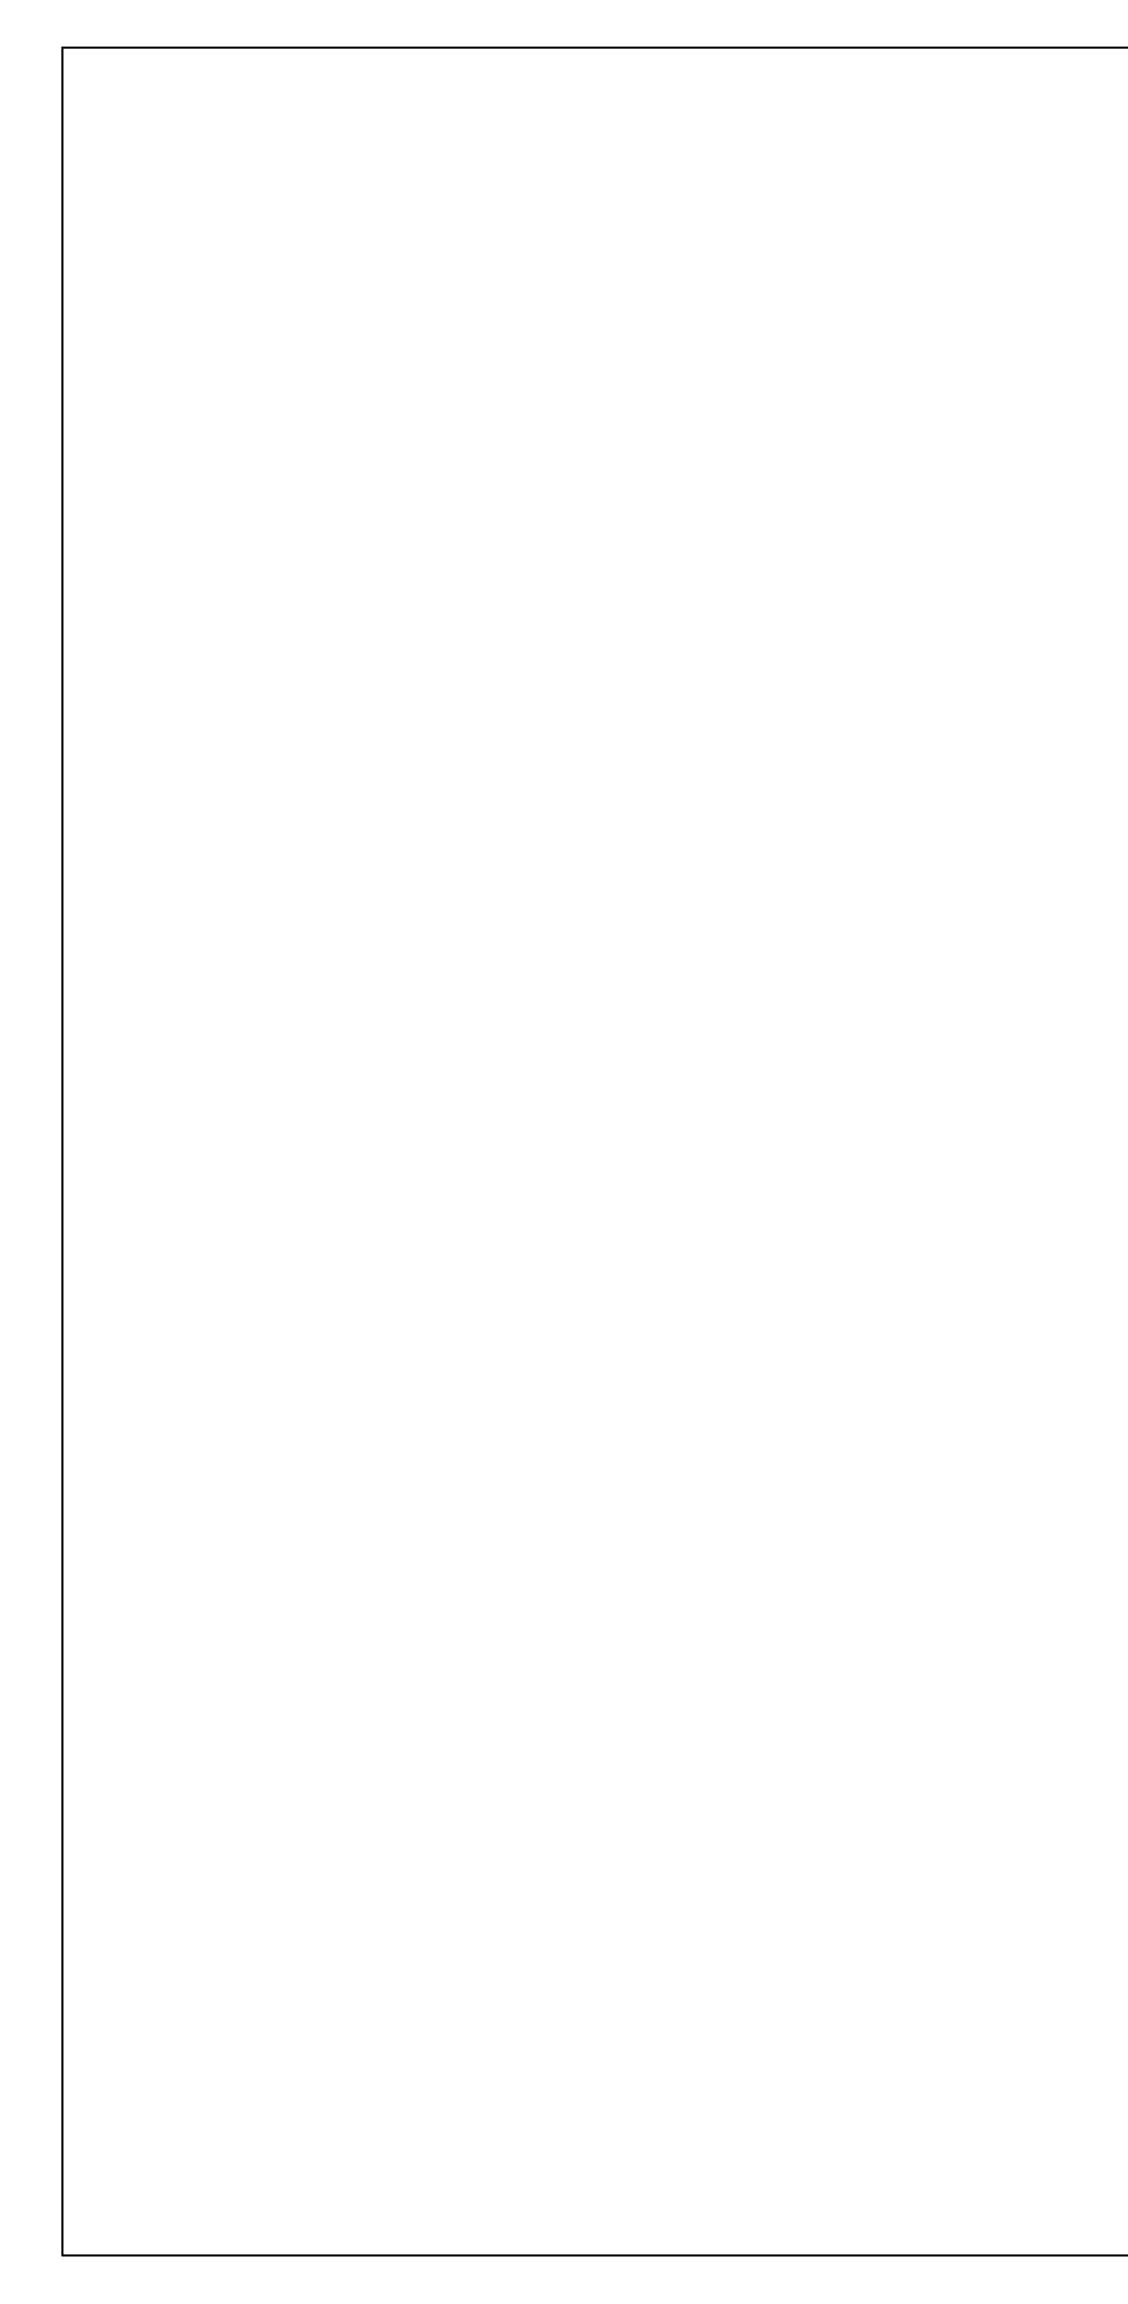

EXISTING REAR BUILDING FRONT (WEST) ELEVATION SCALE: 1/4" = 1'-0"
SCALE: 1/4" = 1'-0"



SLOPE



• PARAPET 23'-1" • ROOF 21'-8"

.≂∞

C



	HOOD THOMAS ARCHITECTS 440 SPEAR STREET SAN FRANCISCO, CALIFORNIA 94105 P:(415)543-5005 F:(415)495-3336
	WWW.HOODTHOMAS.COM K E K
PARAPET FRONT SHED ROOF	1148 Montgomery St.San Francisco, CA 94133Block: 0134 Lot: 025ISSUE:DATE:BLDG. PERMIT APP.09.19.16VARIANCE APP.03.01.17VARIANCE APP.08.18.17
CONCRETE PATIO ADJACENT	
NEIGHBOR'S REAR YARD	DRAWN BY:MM, DFDATE:03.01.17SHEET TITLE:SHEET TITLE:SHEET NULDING FRONT (WEST) ELEVATIONSHEET NUMBER:
4 8 16	A2.5 REV #: DATE:

)	2)	,
(N) LIVING THRD FLOOR UNIT B ENTRANCE QUBB AT CL_ CUBB AT CL_ COURD AT CL_ CNI MECHANICAL ROOM			· ·	· · · _	
SECOND FLOOR ◆ 2'-4.5" CURB AT C.L. CURB AT C.L. (N) MECHANICAL ROOM		<u>(N) LIVING</u>			
Image: CURB AT C.L. Image: Curb AT C.L. Imag		<u>UNIT B ENTRANCE</u>			
	CURB AT C.L.	<u>(N) MECHANICAL</u> <u>ROOM</u>			 <u>(N) LIV</u>

