MEMO

Disclaimer for Review of Plans

The San Francisco Planning Code requires that the plans of certain proposed projects be provided to members of the public prior to the City's approval action on the project. Accordingly, any images of plans featured on this website are provided for the primary purpose of facilitating public input prior to the City's action. The City and County of San Francisco does not own the copyright to these images. Please be aware that the unauthorized reproduction, distribution, or alteration of these images may result in a violation of Federal Copyright Law (17 U.S.C.A. Sections 101 et seq.) and that any party who seeks to reproduce or alter these images does so at his or her own risk.

Additionally, plans provided on this website are limited to site plans, elevations and/or section details (floor plans and structural details may not be included). These are DRAFT PLANS being provided for public review PRIOR to the City's approval action on the project. Final plans may differ from those that are currently available for review.

1650 Mission St. Suite 400 San Francisco, CA 94103-2479

Reception: 415.558.6378

Fax: 415.558.6409

Planning Information: 415.558.6377

NOTICE OF PUBLIC HEARING

Hearing Date: Wednesday, January 25, 2017

Time: Not before 9:30 AM

Location: City Hall, 1 Dr. Carlton B. Goodlett Place, Room 408

Case Type: Variance

Hearing Body: Zoning Administrator

PROPERTY IN	IFORMATION	APPLICATION INFORMATION				
Project Address:	534 Broadway	Case No.: Building Permit: Applicant: Telephone: E-Mail:	2016-013224VAR			
Cross Street(s):	Romolo Place		2016.04.28.5949			
Block /Lot No.:	0145 / 010		Daniel Perez			
Zoning District(s):	Broadway NCD / 65-A-1		(415) 503-0329			
Area Plan:	N/A		dperez@studioperez.com			

PROJECT DESCRIPTION

The project proposes to replace and expand an existing rear deck and stairs within the required rear yard.

PER SECTION 134 OF THE PLANNING CODE the subject property is required to maintain a rear yard of 34'-4.5" at the second level and above. The existing stair structure to grade will be demolished and a new second floor deck spanning the width of the property, with stairs to grade, will be constructed within the required rear yard setback; therefore a variance is required.

ADDITIONAL INFORMATION

ARCHITECTURAL PLANS: The site plan and elevations of the proposed project are available on the Planning Department's website at: http://notice.sfplanning.org/2016-013224VAR.pdf

Members of the public are not required to provide personal identifying information when they communicate with the Commission or the Department. All written or oral communications, including submitted personal contact information, may be made available to the public for inspection and copying upon request and may appear on the Department's website or in other public documents.

FOR MORE INFORMATION, PLEASE CONTACT PLANNING DEPARTMENT STAFF:

Planner: Andrew Perry Telephone: (415) 575-9017 E-Mail: andrew.perry@sfgov.org

GENERAL INFORMATION ABOUT PROCEDURES

HEARING INFORMATION

You are receiving this notice because you are either a property owner or resident that is adjacent to the proposed project or are an interested party on record with the Planning Department. You are not required to take any action. For more information regarding the proposed work, or to express concerns about the project, please contact the Applicant or Planner listed on this notice as soon as possible. Additionally, you may wish to discuss the project with your neighbors and/or neighborhood association, as they may already be aware of the project.

Persons who are unable to attend the public hearing may submit written comments regarding this application to the Planner listed on the front of this notice, Planning Department, 1650 Mission Street, Suite 400, San Francisco, CA 94103, by 5:00 pm the day before the hearing. These comments will be made a part of the official public record and will be brought to the attention of the person or persons conducting the public hearing.

Comments that cannot be delivered by 5:00 pm the day before the hearing may be taken directly to the hearing at the location listed on the front of this notice. Comments received at 1650 Mission Street after the deadline will be placed in the project file, but may not be brought to the attention of the Zoning Administrator at the public hearing.

BUILDING PERMIT APPLICATION INFORMATION

Pursuant to Planning Code Section 311 or 312, the Building Permit Application for this proposal may also be subject to notification of property owners and residents within 150-feet of the subject property. On December 23, 2016, the Department issued the required Section 312 notification for this project (expires January 22, 2017).

APPEAL INFORMATION

An appeal of the approval (or denial) of a **Variance application** by the Zoning Administrator may be made to the **Board of Appeals within 10 calendar days** after the Variance Decision Letter is issued by the Zoning Administrator.

An appeal of the approval (or denial) of a **building permit application** by the Planning Commission may be made to the **Board of Appeals within 15 calendar days** after the building permit is issued (or denied) by the Director of the Department of Building Inspection.

Appeals must be submitted in person at the Board's office at 1650 Mission Street, 3rd Floor, Room 304. For further information about appeals to the Board of Appeals, including current fees, contact the Board of Appeals at (415) 575-6880.

- 1. The Contractor will visit the site and be fully cognizant of all existing conditions prior to submitting any propositions or bids.
- 2. The Contractor shall thoroughly examine the premises and shall base his bid on the existing conditions. The Contractor shall notify the Owner's Agent immediately of any discrepancies between the drawings and the actual field conditions.
- 3. If any asbestos or known materials containing asbestos are discovered, the the Contractor will be responsible to coordinate with the Building Owner, as required for the removal of these conditions, prior to the beginning of this project. If the Contractor participates in any portion of the removal process in his coordination with the Building Owner, then the Contractor will provide the Building Owner with a written statement releasing the Building Owner of any future liability from the Contractor, his employees and any subcontractors hired by the Contractor related to this

These drawings and specifications do not represent an assessment of the presence or absence of any toxic or hazardous materials on this project site. The Building Owners are solely responsible for such an assessment and should be consulted for any questions therein. If the Contractor discovers any toxic or hazardous materials, as defined by the appropriate governing authorities, in the course of his work, he must notify the Building Owners in writing, as per the guidelines of all governing ordinances. The Contractor will resolve all applicable regulations and procedures with the Building Owner at the time of discovery.

- 4. The Contractor shall provide a schedule for construction as required to meet the owner's completion date.
- 5. The Contractor shall confirm in writing, approximate on—site delivery dates for all construction items as required by the construction documents, and shall notify the Owner in writing and in a timely manner of any delays affecting occupancy.
- 6. Substitutions, revisions and/or changes must have prior written approval by the Architect and Owner.
- The intent of these drawings and specifications is that the work of the alteration, rehabilitation or reconstruction is to be in accordance with Title 24, California Code of Regulations. All work will be performed in accordance with all applicable codes, laws and ordinances and regulations, which relate to this project, including but not limited to The 2013 California Building Code. It is the Contractor's responsibility to notify the Owner's Agent should any existing conditions such as deterioration or noncompliant construction be discovered which is not covered by the contract documents wherein the finished work shall not comply with Title 24, California Code of Regulations. A change order, or a separate set of plans and specifications, detailing and specifying the required work, shall be submitted to and approved by the Office before proceeding with the
- 8. Complete all work to meet the State of California Energy Conservation requirements, including but not limited to, all mandatory features identified in the Title 24 report submitted for this project, as well as any <u>local</u> ordinances (CECO and RECO) and any new requirements identified by the local building inspector.
- The General Contractor is responsible for the payment and obtaining of all building permits for a complete project.
- 10. A.I.A. Document A201 General Conditions for the Performance of a Contract, are hereby incorporated into these drawings and shall be considered as part of the requirements for the completion of work
- 11. The Contractor will coordinate and be responsible for all work by his subcontractors and their compliance with all Contract Documents. The Contractor will identify any conflicts between the work of the subcontractors, as directed by these drawings, during the layout of affected trades. The Contractor will review these conditions with the Owner's Agent for design conformance before beginning any installation. 12. The Contractor will field verify all existing and proposed dimensions and conditions. It is the responsibility of the Contractor to notify the Owner's Agent at once upon the discovery of any conflicts or discrepancies between the aforementioned and the drawings and
- specifications of this project. The Contractor should follow dimensions and should not scale these drawings. If dimensions are required but not shown, then the Contractor shall notify the Owner's Agent immediately. Contractor shall provide shop drawings for all millwork items.
- Any changes, alternatives or modifications to these drawings and specifications must be approved in writing prior to installation by the Owner's Agent and Owner, and only when such written approval clearly states the agreed cost or credit of the change, alternative or modification
- 15. The intent of these drawings and specifications is to include all items necessary for a complete job. The Contractor will provide all materials, labor and expertise necessary to complete job as shown in these drawings and specifications or not shown, but intended. The Contractor is fully responsible for construction means, methods, techniques, sequences and procedures for the work shown on these drawings and specifications. It is the Contractor's responsibility to enact the aforementioned in compliance with generally accepted standards of practice for the construction industry for the type of work shown on these drawings and specifications.
- 16. The Owner's Agent reserves the right of review for all materials and products for which no specific brand name or manufacturer is identified in these drawings and specifications. The Contractor shall verify with the Owner's Agent the need for shop drawings or samples of materials and products which were not identified in these drawings and specifications, as well as any material product, or equipment substitutions proposed in place of those items identified in these drawings and specifications.
- 17. The Contractor shall identify in his proposal which utility (water. electricity, telephone, etc.) connections, use and related costs will be included in his overhead and which costs he expects the Building Owner to provide. Any utility cost which is not identified as an Owner provided item will be assumed to be included in the Contractor's overhead cost.

- 17. Cont., It is the contractor's responsibility to verify and coordinate all utility connections, utility company's requirements and include any related costs associated with this responsibility in their proposal or bid. the contractor is also responsible for writing letter of confirmations regarding operative agreements for this project between the contractor and the local fire department, the local water agency, the natural or propane gas providers, the local electricity provider, the local telephone service providers, the local cable television provider, the owner's security provider and any unnamed utility service provider, the contractor will provide copies of any such agreements to the owner's agent and owner. If required or requested.
- The Contractor is fully responsible to enact the appropriate safety precautions required to maintain a safe working environment. The Contractor will indemnify and hold harmless the Owner, the Owner's Agent, their Consultants, and their Employees from and against any injury claims by the Contractor, his Employees, his Subcontractors or anyone he allows onto the construction site, which result from the Contractor's performance of the work shown on these drawings and specifications. The Contractor will carry the appropriate Workman's Compensation and Liability Insurance as required by the local government agency having jurisdiction for this issue, as well as comply with the generally accepted industry standards of practice for a project of this scope. It will be the responsibility of the Contractor to verify with the Building Owner if he will be required to carry Fire Insurance or other types of insurance for the duration of the project. The Contractor should assist the Building Owner in identifying the amount of coverage required.
- The Contractor will maintain a clean and orderly job site on a daily basis. The Contractor will not unreasonably encumber the site with materials or equipment. The Contractor will not endanger the existing structures and any newly constructed structure by overloading the aforementioned with materials or equipment. The Contractor will be responsible to provide temporary enclosures to protect the existing structure and any newly constructed structure from the ill effect of weather for the duration of the entire construction process.
- The Contractor is fully responsible for any damage by him or his Subcontractors to any existing structure or work, any structure or work in progress, unused material intended for use in the project or any existing site condition within the scope of the work intended by these drawings and specifications. This responsibility will include any materials and labor required to correct such damage to the Owner's satisfaction, at no cost to the Owner unless agreed to by the Owner in writing. The Contractor shall identify and provide the required sidewalk and public passage enclosure protection at the affected Right-of-Way areas, if required. The Contractor will review all intended signage with the Building Owner and the Owner's Agent.
- Work under this contract shall be warranted by the Contractor, his employees and his Subcontractors against all defects or errors for one (1) year from the date of substantial completion of the work or designated portions thereof or for one (1) year after acceptance by owner of designated equipment. In case of items remaining uncompleted after date of substantial completion, the one-year warranty period shall be from date of written acceptance of such items. Any and all defects and errors which do become apparent will be repaired by the Contractor to the Owner's satisfaction at no cost to the Owner.
- 23. It is the responsibility of the Contractor to verify the appropriateness of the application for all the product selections shown or intended in these drawings and specifications. The intended meaning of "appropriateness" is the proper system, model and specific selection required for intended use as a shown in these drawings and specifications. The Contractor is to verify that any installers which he selects for the various products will follow all the product manufacturers' required and recommended methods and procedures to achieve the desired results claimed by such manufacturers for their products. The electrical, mechanical, plumbing and fire protection work shall
- be design-build and the responsibility of the General Contractor and his Subcontractors. The Design Build Contractors shall be responsible for providing all the necessary information to the local building department to obtain permit(s). All engineering drawings to be submitted to the architect for review and approval.
- The Contractor shall provide complete product data and related information appropriate for the owner's maintenance and operation of products furnished under the contract.
- The Contractor will identify which permits he expects to obtain and which permits and application fees he expects the Owner to provide for him in his proposal or bid.
- 28. The Contractor is responsible to identify any conflicts between his contract with the Owner and these drawings. These conflicts will be reviewed by the Owner's Agent, the Contractor and the Owner in order to amend one of these documents before the start of construction. If a conflict is discovered without his prior resolution, then these drawings will take precedence over any other documents in resolving a conflict.
- The Contractor shall be responsible to maintain the security of the job site during the construction process until final acceptance by the owner or until an alternate date, as mutually agreed between the Owner and the Contractor.
- Site meetings will be held once a week with the Owner's Agent and the Contractor unless they are mutually changed or canceled. The Contractor will keep written notes of all relevant information discussed at these meetings and provide copies of them to the Owner's Agent. The Owner's Agent will provide any requested sketches or any information which is requested during these meetings. The Contractor and the Owner will provide any requested information which is required during these


31. The Owner's Agent will write and issue field orders for changes to the drawings as requested by the Owner or the Contractor. If additional (or deletion) cost to the project is required, then these field orders will become the basis of a change order

32. The Contractor will write and issue all change orders, which will include a cost breakdown for all the work described in such change order. Any change order will not be binding to the Owner until both the Contractor and the Owner have signed it.

33. Upon Substantial Completion the Contractor will notify the Owner's Agent, who will coordinate a walk-through of the project with the Owner and the Contractor and then provide a punch list of items to complete. Arrangements for final payment will be made at that time.

34. If the Contractor finds fault, disagrees, objects or would like to change the scope of these conditions and his stated responsibilities as outlined in these General Notes. then the Contractor must resolve such changes with the Owner in writing before signing a contract. Failure to do so will constitute an understanding of these General Notes and their acceptance by the Contractor.

SYMBOLS LIST

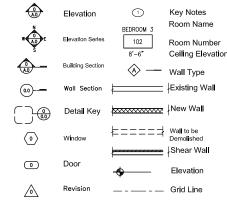

ABBREVIATIONS

Adjustable

AD.I

נטו	Adjustable	IVIZZZ	Maximum
FF	Above Finish Floor	MECH	Mechanical
LUM	Aluminum	MFR	Manufacturer
LT	Alternate	MIN	Minimum
RCH	Architectural	MTL	Metal
RCT	Architect	MAT'L	Material
0	At	MTD	Mounted
ĹDG	Building	MUL	Mullion
LKG	Blocking	(N)	New
J	Control Joint	N/Á	Not Applicable
L.	Center Line	NIC	Not In Contract
LG	Ceiling	NTS	Not To Scale
LR	Clear	OC	On Center
ONC	Concrete	OH	Opposite Hand
ONT	Continuous	OPP	Opposite
:PT	Carpet	PLAM	Plastic Laminate
TR	Center	PLYWD	Plywood
BL	Double	PNT	Paint
IA	Diameter	PNTD	Painted
IM	Dimension	PRHT	Partial Height
N	Down	PTDF	Pressure Treated
S	Downspout		Douglas Fir
WG	Drawing	RCP	Reflected Ceiling Plan
TL	Detail	REQD	Required
Ξ)	Existing	RD	Roof Drain
=) A	Each	RM	Room
LEC	Electrical	RO	Rough Opening
L, ELEV	Elevation	SC	Solid Core
	Equal	SHT	Sheet
Q QUIV	Equivalent	SIM	Similar
	Exterior	SJ	Seismic Joint
XT	Furnished By Owner	SPEC	Specification
ВО	Floor Drain	SQ	Square
D F	Finish Floor	SSD	See Structural Drawin
	Finish		
IN	Floor	SST	Stainless Steel
LR	Face Of Finish	STRUCT	Structural
OF	Face Of Structure	SVF	Sheet Vinyl Flooring
os	Feet	SYM	Symmetrical
Т		T&G	Tongue and Groove
iA	Gauge	TBD	To Be Determined
ALV	Galvanized	THK	Thick
iL	Glass	T.O.	Top of
YP BD	Gypsum Board	TOS	Top of Sill
DWD	Hardwood	TOW	Top of Wall
DWR	Hardware	TYP	Typical
M	Hollow Metal	UON	Unless Otherwise Not
Т	Height	VIF	Verify In Field
Т	Joint	W/	With
		WD	Wood
		WP	Water Proof

MAX

Maximum

534 BROADWAY

REAR STAIR & PARTIAL WINDOW REPLACEMENT



VICINITY MAP

PROJECT DESCRIPTION & SCOPE OF WORK

THE PROJECT CONSISTS OF REPLACEMENT OF THE REAR EXTERIOR STAIRS AND LANDING WITH NEW PRE-FABRICATED METAL STAIRS AND LANDING TO COMPLY WITH NOV 201543321. SIX WOOD WINDOWS WILL BE REPLACED IN KIND AND TWO WILL BE ENLARGED AT ROMOLO PLACE, ALL EIGHT WOOD WINDOWS WILL HAVE OGEE LUGS FOUR SECURITY WINDOW GUARDS WILL BE REPLACED AT ROMOLO PLACE AND FOUR WILL BE REPLACED AT THE REAR OF THE BUILDING. A METAL GATE AT ROMOLO PLACE WILL BE REPLACED. A NEW ROLL UP DOOR, GANTRY CRANE & JIB, AND METAL PLATFORM WILL BE ADDED AT (E) MECHANICAL ROOM TO IMPROVE WASTE REMOVAL SYSTEM.

PROJECT DATA

ADDRESS: 534 BROADWAY STREET SAN FRANCISCO, CA 94133

ASSESSOR'S BLOCK NO: 0145 ASSESSOR'S LOT NO:

NCD BROADWAY NEIGHBORHOOD

COMMERCIAL

HEIGHT & BUI K DISTRICT: 65-A-1

OCCUPANCY: GROUND LEVEL

M RETAIL, A-3 MUSEUM 2ND & 3RD FLOOR R-2 APARTMENTS

BUILDING TYPE: V-B (PROTECTED) BUILDING HEIGHT

43'-6" (3 STORIES) AT BROADWAY BUILDING AREA. 18 878 SQ FT LOT WIDTH/AREA

APPLICABLE CODES AND REGULATIONS

2013 CALIFORNIA BUILDING CODE. CALIFORNIA CODE OF REGULATIONS TITLE 24, PART2, VOLUME 1 AND 2. 2013 SAN FRANCISCO BUILDING CODE AMENDMENTS 2013 CALIFORNIA ELECTRICAL CODE, 2013 SAN FRANCISCO ELECTRICAL CODE AMENDMENTS 2013 CALIFORNIA MECHANICAL CODE, 2013 SAN FRANCISCO MECHANICAL CODE AMENDMENTS 2013 CALIFORNIA PLUMBING CODE, 2013 SAN FRANCISCO PLUMBING

CODE AMENDMENTS 2013 CALIFORNIA GREEN BUILDING CODE, 2013 SAN FRANCISCO GREEN BUILDING CODE AMENDMENTS

2010 CALIFORNIA ENERGY CODE 2013 SAN FRANCISCO FIRE CODE

TITLE 19, CCR, PUBLIC SAFETY, STATE FIRE MARSHAL REGULATIONS AMERICAN WITH DISABILITIES ACT - 2010 ADA STANDARDS FOR ACCESSIBLE

INDEX OF DRAWINGS

T0.00 COVER SHEET, INDEX, AND PROJECT INFO, GENERAL NOTES A0.01 SITE PLAN
A1.01 DEMOLITION FLOOR PLANS
A2.01 PROPOSED FLOOR PLANS
A3.00 EXTERIOR ELEVATIONS AND WINDOW SCHEDULE


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Studio Perez

534 BROADWAY **REAR STAIR** REPLACEMENT


534 BROADWAY STREET SAN FRANCISCO, CA 94133

Sheet Title COVER SHEET INDEX PROJECT INFO, GENERAL

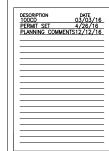

Date February 22, 2016 orawn DP Job Project # 1512

T0.00

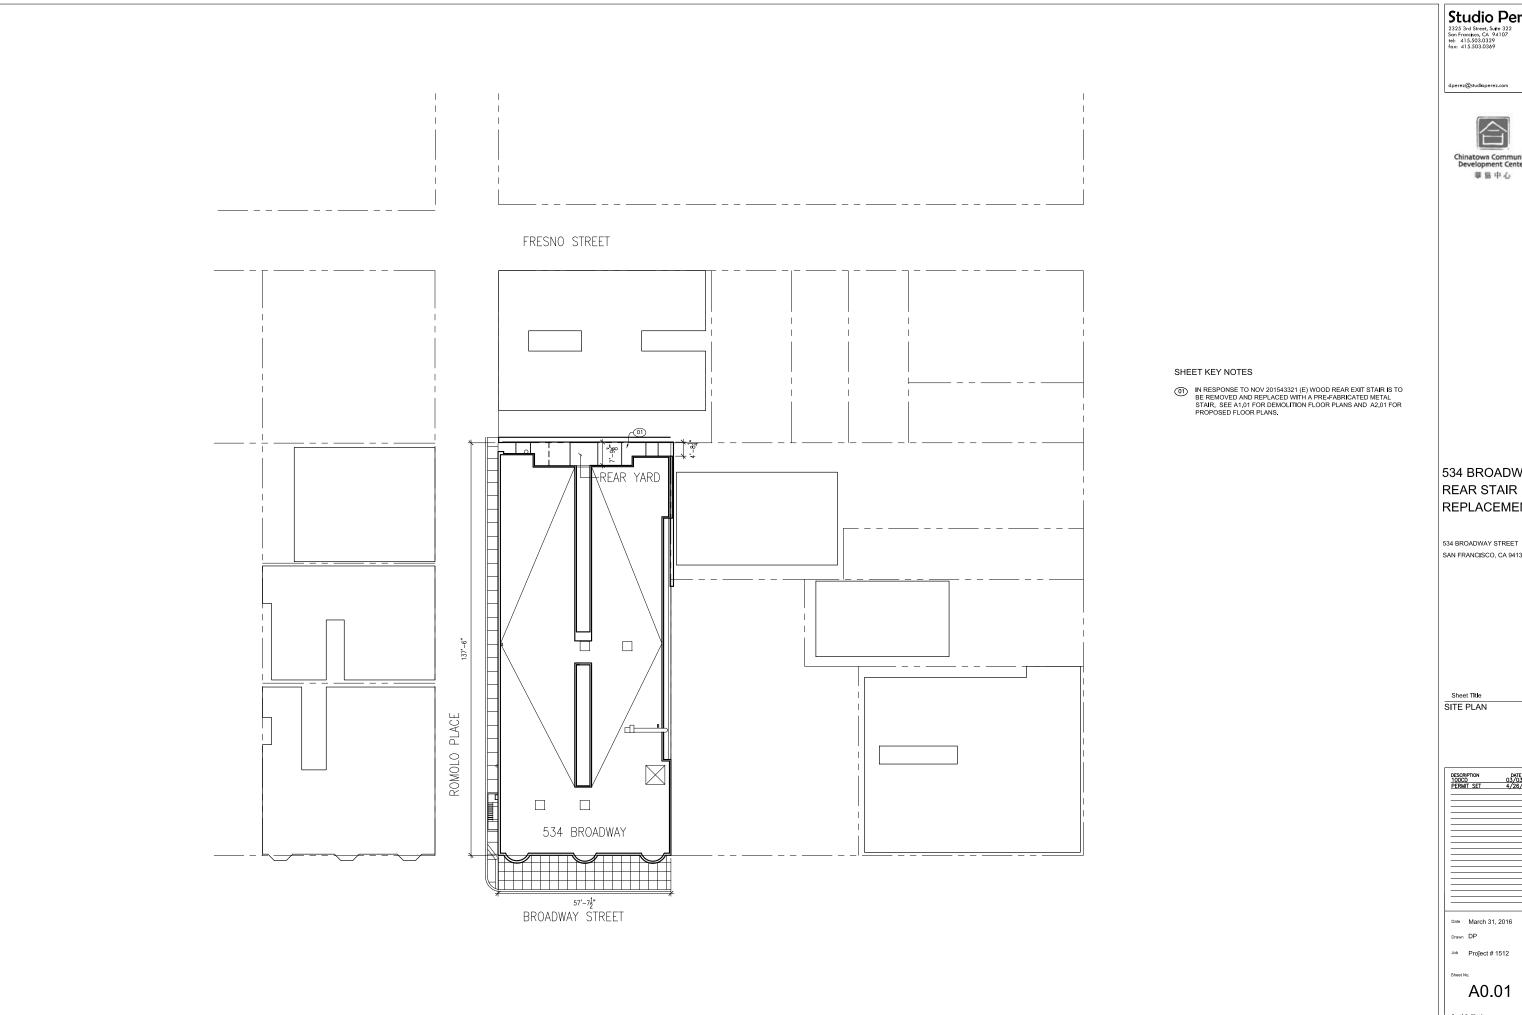

Studio Perez 2325 3rd Street, Suite 322 Son Francisco, CA 94107 tel: 415.503.0329 fax: 415.503.0369



534 BROADWAY REAR STAIR REPLACEMENT

SAN FRANCISCO, CA 94133



Job Project # 1512

A0.01



1. ITEMS TO BE DEMOLISHED OR REMOVED ARE TYPICALLY INDICATED BY A DASHED LINE UON.

IF MECHANICAL/ELECTRICAL ELEMENTS ARE NOT SHOWN TO BE DEMOLISHED, NOTHEY THE ARCHITECT FOR WRITTEN ACCEPTANCE OF DEMOLITION. DEMOLITION AND REMOVAL WORK INCLUDES CAPPING AND DISCONNECTION OF ABANDONED SERVICES.

2. ALL AREAS SHALL BE CLEANED AND PREPPED PRIOR TO PAINTING.

dperez@studioperez.com



Studio Perez

SHEET KEY NOTES

- (1) REMOVE (E) WOOD STAIR, LANDING, HAND RAILS, AND GUARDRAIL.
- (22) REMOVE (E) CONCRETE FOOTINGS AT (E) WOOD POSTS, PATCH REMOVED AREA WITH NEW CONCRETE FLUSH TO ADJACENT SURFACE.
- REMOVE (E) CONCRETE TREAD AT BASE OF (E) STAIR. PATCH AREA REMOVED WITH NEW CONCRETE FLUSH W/ (E) ADJACENT SURFACE.
- (E) CONCRETE STEPS AT ROMOLO TO REMAIN IN PLACE. MODIFY AS REQUIRED FOR NEW STEEL LANDING AND STAIRS.
- (6) REMOVE (E) HANDRAIL AT (E) CONCRETE STAIR.
- (66) REMOVE EIGHT (E) WINDOWS AT ROMOLO PLACE WHERE INDICATED.
- $\ensuremath{\overline{\text{07}}}$ REMOVE FOUR (E) WINDOW GRILLES AT ROMOLO PLACE WHERE INDICATED.
- $\ensuremath{\text{(B)}}$ REMOVE FOUR (E) WINDOW GRILLES AT REAR WINDOWS WHERE INDICATED.
- (B) REMOVE (E) METAL GATE AT ROMOLO PLACE.
- REMOVE (E) METAL GATE AT NORTH LIGHT WELL AS SALVAGE FOR REUSE.
- (1) REMOVE (E) WOOD LEDGER AT (E) LANDING PERIMETER
- (E) BRICK BUTRUSSES TO REMAIN IN PLACE
- (E) RETAINING WALL

534 BROADWAY REAR STAIR REPLACEMENT

534 BROADWAY STREET SAN FRANCISCO, CA 94133

Sheet Title DEMOLITION FLOOR PLANS



Job Project # 1512

A1.01



1. ALL AREAS SHALL BE CLEANED AND PREPPED PRIOR TO PAINTING.

FAINTING.
2. SHOP DRAWINGS AND ENGINEERING TO BE PROVIDED BY
FABRICATOR FOR PRE-FABRICATED METAL STAIR AND LANDING
ASSEMBLY. ALL DIMENSIONS TO BE VERIFIED IN FIELD.

Studio Perez



SHEET KEY NOTES

- (01) PROVIDE NEW PRE-FABRICATED METAL STAIRS, TREADS TO BE ROUND HOLE OPEN-GRIP ANTI-SLIP. RISERS TO BE CLOSED CHECKER PLATE
- PROVIDE NEW METAL POSTS TO SUPPORT METAL PRE-FABRICATED STAIR AND LANDINGS.
- (3) PROVIDE NEW CONCRETE FOOTINGS AT NEW POST LOCATIONS
- (04) REVERSE SWING OF EXISTING METAL GATE TO SWING INTO THE NORTH LIGHTWELL
- (05) PROVIDE (N) METAL GATE AT ROMOLO PLACE, SEE 6/A3.00.
- PROVIDE EIGHT NEW WOOD WINDOWS AT WEST ELEVATION. SEE WINDOW SCHEDULE 6/A3.00
- (07) PROVIDE FOUR (N) WINDOW GRILLES AT ROMOLO PLACE WHERE INDICATED. SEE 6/A3.00 AND WINDOW SCHEDULE.
- (08) PROVIDE FOUR (N) WINDOW GRILLES AT REAR WINDOWS WHERE INDICATED. SEE 3 & 4 A3.00 AND WINDOW SCHEDULE.
- (9) PROVIDE (N) ROLL-UP SERVICE DOOR TO MECHANICAL ROOM FROM ROMOLO. SEE DOOR SCHEDULE.
- (10) PROVIDE AND INSTALL (N) VESTIL FLOOR MOUNTED JIB CRANE JIB-FM-10-80 AT MECHANICAL ROOM. PROVIDE NEW 4'-2" SQ. X 2'-6" DEEP CONCRETE PAD, FLUSH WITH EXISTING SLAB, FOR THE CRANE. SEE 8/A5.00
- (1) PROVIDE 5'-0"W X 5'-0"D X3'-8" H PRE-FABRICATED CHECKER PLATE METAL PLATFORM ON STEEL POSTS, PROVIDE 3'-6"H GUARD RAIL ON NORTH SIDE OF PLATFORM.
- PROVIDE METAL LADDER TO ACCESS METAL PLATFORM.
- (13) PROVIDE METAL ROD AND RAIL GUARD RAILS AT LANDINGS AND STAIRS.

534 BROADWAY REAR STAIR REPLACEMENT


534 BROADWAY STREET SAN FRANCISCO, CA 94133


Sheet Title PROPOSED FLOOR PLANS



Job Project # 1512

A2.01

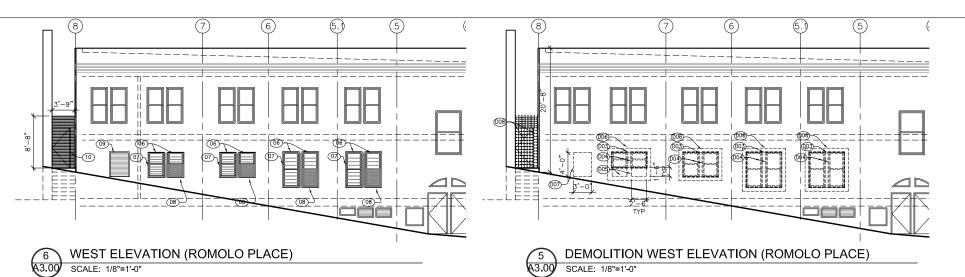

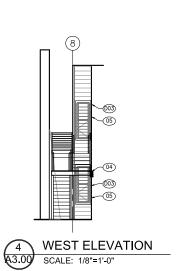

PARTIAL NORTH ELEVATION

SCALE: 1/8"=1'-0"

	WINDOW SCHEDULE													
MARK	SIZE			TYPE	MATERIAL	GLAZING	DETAILS			WINDOW GUARD		GATE SIZE		NOTES
	WIDTH	HEIGHT	SILL HEIGHT				HEAD	JAMB	SILL	WIDTH	HEIGHT	WIDTH	HEIGHT	PROVIDE (N) METAL WINDOW SECURITY BARS AT WINDOWS ON THIS SCHEDULE
210.1	2'-6"	5'-8"	1'-11 1/4"	DH	WOOD	IG	5/A5.0	5/A5.0	7/A5.0	6'-1"	5'-8"	2'-11"	2'-11"	DH=DOUBLE HUNG
210.2	2'-6"	5'-8"	1'-11 1/4"	DH	WOOD	IG	5/A5.0	5/A5.0	7/A5.0					IG = INSULATED GLASS
212.1	2'-6"	5'-8"	1'-11 1/4"	DH	WOOD	IG	5/A.0	5/A5.0	7/A5.0	6'-1"	5'-8"	2'-11"	2'-11"	SEE 13/A5.00 FOR WINDOW FLASHING DETAILS
212.2	2'-6"	5'-8"	1'-11 1/4"	DH	WOOD	IG	5/A5.0	5/A5.0	7/A5.0					
214.1	2'-6"	4'-0"	3'-5 1/2"	DH	WOOD	IG	5/A5.0	5/A5.0	7/A5.0	6'-1"	4'-0"	2'-11"	2'-0"	
214.2	2'-6"	4'-0"	3'-5 1/2"	DH	WOOD	IG	5/A5.0	5/A5.0	7/A5.0	1				
216.1	2'-6"	4'-0"	3'-5 1/2"	DH	WOOD	IG	5/A5.0	5/A5.0	7/A5.0	6'-1"	4'-0"	2'-11"	2'-0"	ENLARGE HEIGHT OF
216.2	2'-6"	4'-0"	3'-5 1/2"	DH	WOOD	IG	5/A5.0	5/A5.0	7/A5.0					OPENING
231.1	2'-0"	6'-0"	2'-2"	(E) DH	(E)	(E)				2'-3"	6'-0"	2'-1"	3'-1"	(E)WINDOW TO REMAIN
231.2	2'-0"	6'-0"	2'-2"	(E) DH	(E)	(E)				2'-3"	6'-0"	2'-1"	3'-1"	(E)WINDOW TO REMAIN
333.1	2'-0"	6'-0"	2'-2"	(E) DH	(E)	(E)				2'-3"	6'-0"	2'-1"	3'-1"	(E)WINDOW TO REMAIN
333.2	2'-0"	6'-0"	2'-2"	(E) DH	(E)	(E)				2'-3"	6'-0"	2'-1"	3'-1"	(E)WINDOW TO REMAIN


DOOR SCHEDULE NOTES

FOLLOWS:
A) EXTERIOR DOORS = 5 LBS

2. ALL DOOR HANDLE SETS SHALL BE ADA COMPLIANT LEVER SETS.
3. ALL DOORS TO CONFORM TO CLEARANCE AND CONSTRUCTION DIMENSIONS.

1. ALL RATED DOORS SHALL BE POSITIVE LATCHING AND SELF CLOSING. THE MAXIMUM EFFORT TO OPERATE SUCH DOORS SHALL BE AS

	DOOR SCHEDULE											
DOOR TAG	SIZE		HAND	DOOR		FRAME				NOTES		
		THICKNESS		MATERIAL	FINISH	MATERIAL	FINISH	LOCATION	FUNCTION			
001	3'-0 X 4'-0"	5/8"	NA	METAL	PAINT	STEEL	PAINT	MECH. RM		MODEL 650 INSULATED W/ ELECTRIC MOTOR AND HOOD.		
GA1	3'-0 X 6'-8"	2"	LHR	METAL	PAINT	METAL	PAINT	REAR YARD		PROVIDE CONDUIT AND WIRING FOR ELECTRIFIED STRIKE FUTURE USE. PROVIDE LEVER HARDWARE.		
(E) GA2	3'-0"X6'-8"	2"	LH	METAL	PAINT	METAL	PAINT	NORTH LIGHT	STOREROOM	REVERSE GATE TO SWING INTO LIGHT		

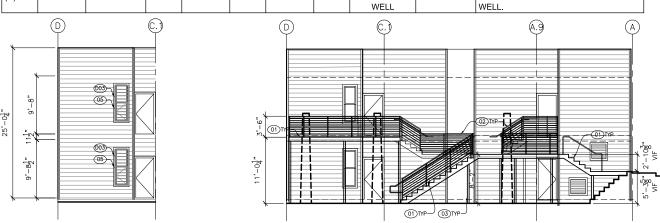

NORTH ELEVATION


SCALE: 1/8"=1'-0"

(D)

ROMOLO PLACE

2'-11" ROMOLO PLACE

WINDOW GUARD ELEVATIONS 6'-1"

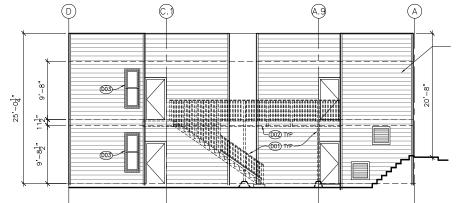

DEMOLITION NORTH ELEVATION SCALE: 1/8"=1'-0"

SHEET NOTES

1. VERIFY PLAN LAYOUT AND DIMENSIONS. CONTRACTOR SHALL VERIFY EXISTING CONDITIONS AT ALL AREAS AFFECTED BY NEW WORK PRIOR TO CONSTRUCTION.
2. PAINT STUCCO AND SIDING AT NEW AREAS OF WORK TO MATCH EXISTING.



Studio Perez

DEMOLITION KEY NOTES

- (E) WOOD STAIR, LANDING, POSTS AND FOOTINGS.
- REMOVE (E) WOOD LEDGER AT LANDING PERIMETER.
- (6) REMOVE (E) SECURITY WINDOW GRILLES AND OPERATING HARWARE AT THE INTERIOR WHERE OCCURS.
- $\begin{tabular}{ll} \begin{tabular}{ll} \be$
- MODIFY (E) WINDOW OPENING TO FIT NEW 2'-6" X 4'-0" WINDOWS AT WINDOWS 216.1 AND 216.2.
- (006) REMOVE STUCCO AT WINDOW PERIMETER TO INSTALL (N) WINDOW FLASHING. PATCH AND REPAIR WITH NEW STUCCO TO MATCH (E).
- MAKE OPENING IN WALL TO FIT NEW 3"-0" X 5"-8" ROLL-UP DOOR AT MECHANICAL ROOM.
- REMOVE (E) METAL GATE ENCLOSURE

SHEET KEY NOTES

- PROVIDE (N) METAL STAIR AND LANDINGS WITH ROUND HOLE GRATING. SEE DETAILS 1 & 2/AS, 0. SEE 3 & 4/AS, 0 FOR ADD ALTERNATE FOR ADDING COMPOSITE DECKING OVER METAL LANDING AND STAIRS. PROVIDE SHOP DRAWINGS FOR ARCHITECT REVIEW.
- (02) PROVIDE (N) ROD AND RAIL GUARDRAILS AT STAIRS AND LANDINGS
- 03 PROVIDE NEW STEEL POST WITH CONCRETE FOOTINGS.
- (94) PROVIDE NEW LEDGER AT BUILDING WALL FOR STAIR AND LANDING SUPPORT, REPLACE WOOD SIDING AS REQUIRED TO INSTALL NEW WOOD LEDGERS. SEE 1/A5.0
- 05) PROVIDE NEW SECURITY WINDOW GRILLES AT REAR YARD.
- (06) PROVIDE (N) WOOD WINDOWS WITH OGEE LUGS TO MATCH EXISTING, SEE WINDOW SCHEDULE.
- (7) PROVIDE NEW SECURITY WINDOW GRILLES. PROVIDE SHOP DRAWINGS FOR ARCHITECT REVIEW.
- (08) PROVIDE 75% TRANSPARENCY WIRE MESH AT OPERABLE DOORS AT SECURITY GRILLES AT ROMOLO (NO MESH AT REAR OF BUILDING WINDOWS), PROVIDE CODE APPROVED RELEASE MECHANISM AT WINDOW INTERIOR, RELEASING MECHANISM MUST BE HAND OPERATED AND APPROVED BY THE SAN FRANCISCO FIRE

DEPARTMENT. THE RELEASING DEVICE SHOULD BE NO HIGHER THAN 48". SEE OBC 1029.4. SECURITY BARS INSTALLED ON EMERGENCY EGRESS AND RESCUE WINDOWS, SUCH DEVICES SHALL COMPLY WITH THE STANDARDS OF THE 2013 CALIFORNIA BUILDING STANDARDS CODE, PART 12, CHAPTER 12-3 AND OTHER APPLICABLE

- PROVIDE (N) ROLL UP DOOR BY ROLL UP DOOR DIRECT OR APPROVED EQUAL.
- 10 PROVIDE (N) METAL GATE ENCLOSURE AT ROMOLO ALLEY WITH 75% TRANSPARENCY MESH.

2'-1" 08SIM BUILDING REAR 534 BROADWAY REAR STAIR RERUAGEMENT


534 BROADWAY STREET SAN FRANCISCO, CA 94133


Sheet Title EXTERIOR ELEVATIONS & WINDOW SCHEDULE


Date January 15, 2016

Drawn DP Job Project # 1512

A3.00

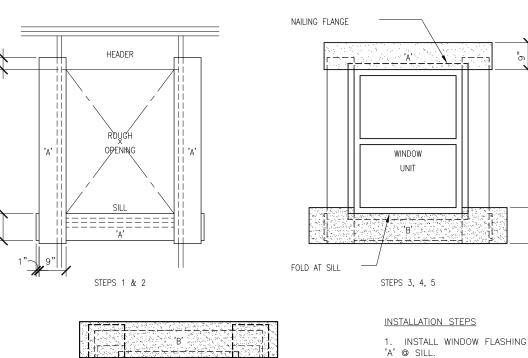

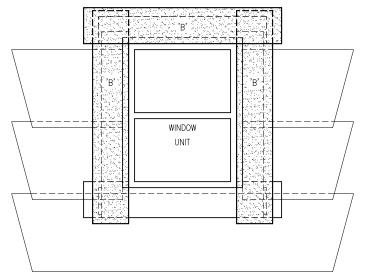

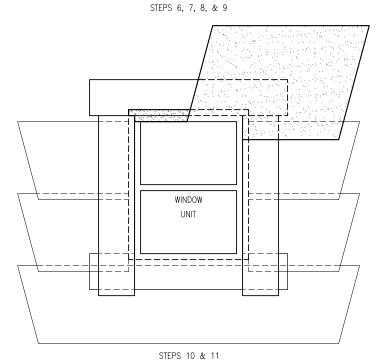

IB-FM-10. PROVIDE CH HOIST AND TROLLEY HOISI AND INCILLEY H-1000-1 OR APPROVED EQUAL. DISTRIBUTORS SILICON VALLEY SHELVING SAN JOSE 408-451-950 OR BENCH-TEK, SANTA CLARA 408-653-1100. ROLL UP DOOR BEYOND 42-INCH GUARD RAIL (NORTH SIDE OF PLATFOR PRE-FABRICATED METAL PLATFORM WITH CHECK PLATE FLOOR. METAL POSTS AT FOUR CORNERS OF PLATFORM SECURED TO CONC. SLA METAL LADDER 4'-2" X 4'-2" X 2'-6"— CONCRETE FOOTING FOR JIB CRANE SHOWN DASHED. 8 METAL PLATFORM FOR WASTE REMOVAL A5.00 SCALE: 1/2"=1'-0"

2. INSTALL WINDOW FLASHING

INSTALL SELF-ADHESIVE

LAP ON SILL. LEAVE BACKING

INSTALL BLDG. PAPER @

LAP O/ LOWER COURSE. HOLD

ON SO BLDG. PAPER CAN BE

TUCKED UNDERNEATH.

HEAD, BED IN SEALANT.

SELF-ADHESIVE FLASHING 7. CONTINUE BLDG. PAPER, 2"

BLDG. PAPER OFF VERTICAL

SELF-ADHESIVE FLASHING O/ VERT. NAILING FIN AND O/ BLDG.

INSTALL HORIZONTAL

SELF-ADHESIVE FLASHING @

HEAD. LAP O/ WINDOW FRAME,

SELF-ADHESIVE FLASHING, AND

11. INSTALL BLDG. PAPER. LAP

SHEATHING NOT SHOWN FOR

SILL. TUCK UNDER

8. INSTALL VERT.

PAPER @ JAMBS.

NAILING FIN, VERT.

WALL SURFACE. 10. INSTALL 24 GA. GSM FLASHING CAP @ HEAD.

GSM FLASHING.

NOTE:

CLARITY

NAILING FIN.


FLASHING 'B' @ SILL. CUT AND

INSTALL WINDOW IN SEALANT


INSTALL WINDOW FLASHING @


'A' @ JAMBS.

BED.

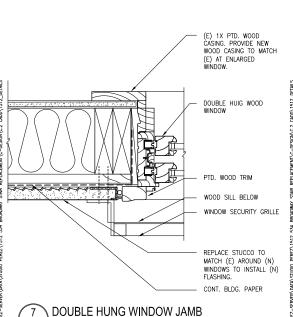


A5.0 SCALE: 3"=1'-0"

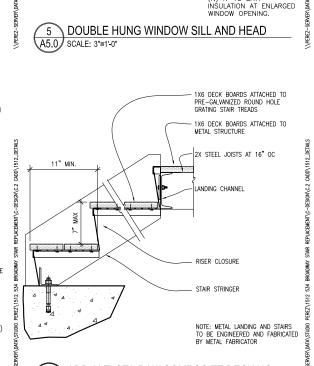

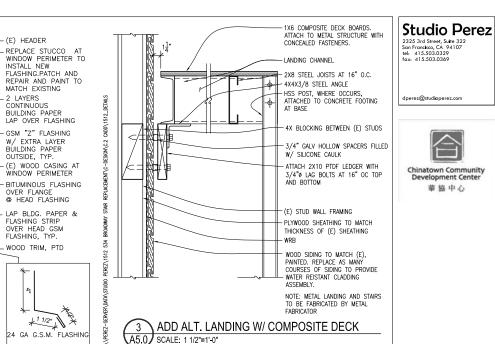

PRE-GALVANIZED ROUND HOLE GRATING LANDING AND STAIR 11" MIN. ANDING CHANNEL 534 BROADWAY REAR STAIR REPLACEMENT 534 BROADWAY STREET RISER CLOSURE STAIR STRINGER NOTE: METAL LANDING AND STAIRS TO BE ENGINEERED AND FABRICATED BY METAL FABRICATOR

1-1/2" THICK SLIP RESISTANT

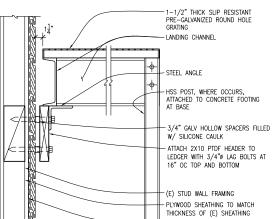

STAIR WITH METAL GRATING

2 STAIR WITH A5.0 SCALE: 1 1/2"=1'-0"

ASSEMBLY. NOTE: METAL LANDING AND STAIRS TO BE ENGINEERED AND FABRICATED BY METAL FABRICATOR

WOOD SIDING TO MATCH (E), PAINTED. REPLACE AS MANY COURSES OF SIDING TO PROVIDE

WATER REISTANT CLADDING

METAL GRATING LANDING A5.0 SCALE: 1 1/2"=1'-0"

SAN FRANCISCO, CA 94133


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Sheet Title DETAILS

Date January 15, 2016 Drawn DP

Job Project # 1512

A5.00

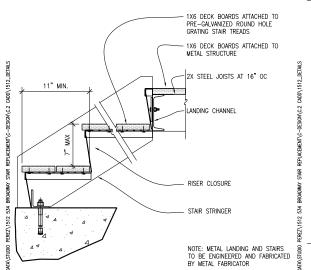

-(E) HEADER

REPAIR AND PAINT TO

BUILDING PAPER LAP OVER FLASHING

GSM "Z" FLASHING W/ EXTRA LAYER BUILDING PAPER OUTSIDE, TYP.

(E) WOOD CASING AT

- BITUMINOUS FLASHING

- LAP BLDG. PAPER & FLASHING STRIP OVER HEAD GSM FLASHING, TYP.

£1 1/2"

OPERABLE DOOR WITH WIRE MESH AT WINDOW SECURITY

- QUICK RELEASE ACTUATOR FOR OPERABLE DOOR.

- (N) WOOD DOUBLE HUNG WINDOW W/ OGEE LUGS

PROVIDE NEW WOOD
CASING TO MATCH (E) AT
ENLARGED WINDOW.

- FLEXIBLE FLASHING MEMBRANE OVER SILL EXTENDS 6" UP

WINDOW FRAME AT

- WOOD SILL, W/ CHAMFERED TOP

BACKER-ROD

- (E) 1X SHEATHING

- LAP (N) BUILDING

PAPER OVER (E), EXTEND UP & UNDER SILL

(N) R-13 BATT

FLASHING.

(F) WINDOW CASING

ANDW / INSULATED GLAZING TO MATCH (E).

24 GA G.S.M. FLASHI

GRILLE.

WOOD TRIM, PTD

WINDOW PERIMETER

MATCH EXISTING

2 LAYERS CONTINUOUS

ADD ALT. STAIR W/ COMPOSITE DECKING A5.0 SCALE: 1 1/2"=1'-0"

A5.0 SCALE: NTS

13 WINDOW FLASHING