MEMO

Disclaimer for Review of Plans

The San Francisco Planning Code requires that the plans of certain proposed projects be provided to members of the public prior to the City's approval action on the project. Accordingly, any images of plans featured on this website are provided for the primary purpose of facilitating public input prior to the City's action. The City and County of San Francisco does not own the copyright to these images. Please be aware that the unauthorized reproduction, distribution, or alteration of these images may result in a violation of Federal Copyright Law (17 U.S.C.A. Sections 101 et seq.) and that any party who seeks to reproduce or alter these images does so at his or her own risk.

Additionally, plans provided on this website are limited to site plans, elevations and/or section details (floor plans and structural details may not be included). These are DRAFT PLANS being provided for public review PRIOR to the City's approval action on the project. Final plans may differ from those that are currently available for review.

1650 Mission St. Suite 400 San Francisco, CA 94103-2479

Reception: 415.558.6378

Fax: 415.558.6409

Planning Information: 415.558.6377

NOTICE OF PUBLIC HEARING

Hearing Date: Wednesday, December 6, 2017

Time: Not before 9:00 AM

Location: City Hall, 1 Dr. Carlton B. Goodlett Place, Room 408

Case Type: Variance

Hearing Body: Zoning Administrator

PROPERTY IN	NFORMATION	APPLICATI	ON INFORMATION
Project Address:	33-35 Aladdin Terrace	Case No.: Building Permit: Applicant: Telephone: E-Mail:	2016-012089VAR
Cross Street(s):	Taylor/Mason Streets		201609026778
Block /Lot No.:	0100/021B		Blake Evans
Zoning District(s):	RM-1/ 40-X		(415) 346-9990
Area Plan:	N/A		blake@martinkovicmilford.com

PROJECT DESCRIPTION

The proposal is a horizontal and vertical addition to an existing, 3-story residential building containing 2 Dwelling Units. The proposal would excavate under the existing structure and lift the existing floor plates approximately 3 feet, 6 inches, creating a new fourth floor. The project would add a two-car garage, with two garage doors measuring 8 feet wide (each). A new roof deck accessible via a roof hatch is included in the proposal.

PER SECTION 134 OF THE PLANNING CODE, a rear yard of approximately 15 feet is required for the subject property. The project proposes a horizontal and vertical addition within a portion of the side yard and the rear yard. A portion of the horizontal and vertical addition encroaches into the required rear yard by approximately 6 feet, 8 inches. Therefore, a variance is required.

ADDITIONAL INFORMATION

ARCHITECTURAL PLANS: The site plan and elevations of the proposed project are available on the Planning Department's website at: http://notice.sfplanning.org/2016-012089VAR.pdf

Members of the public are not required to provide personal identifying information when they communicate with the Commission or the Department. All written or oral communications, including submitted personal contact information, may be made available to the public for inspection and copying upon request and may appear on the Department's website or in other public documents.

FOR MORE INFORMATION, PLEASE CONTACT PLANNING DEPARTMENT STAFF:

Planner: Nicholas Foster Telephone: (415) 575-9167 E-Mail: nicholas.foster@sfgov.org

GENERAL INFORMATION ABOUT PROCEDURES

HEARING INFORMATION

You are receiving this notice because you are either a property owner or resident that is adjacent to the proposed project or are an interested party on record with the Planning Department. You are not required to take any action. For more information regarding the proposed work, or to express concerns about the project, please contact the Applicant or Planner listed on this notice as soon as possible. Additionally, you may wish to discuss the project with your neighbors and/or neighborhood association, as they may already be aware of the project.

Persons who are unable to attend the public hearing may submit written comments regarding this application to the Planner listed on the front of this notice, Planning Department, 1650 Mission Street, Suite 400, San Francisco, CA 94103, by 5:00 pm the day before the hearing. These comments will be made a part of the official public record and will be brought to the attention of the person or persons conducting the public hearing.

Comments that cannot be delivered by 5:00 pm the day before the hearing may be taken directly to the hearing at the location listed on the front of this notice. Comments received at 1650 Mission Street after the deadline will be placed in the project file, but may not be brought to the attention of the Zoning Administrator at the public hearing.

BUILDING PERMIT APPLICATION INFORMATION

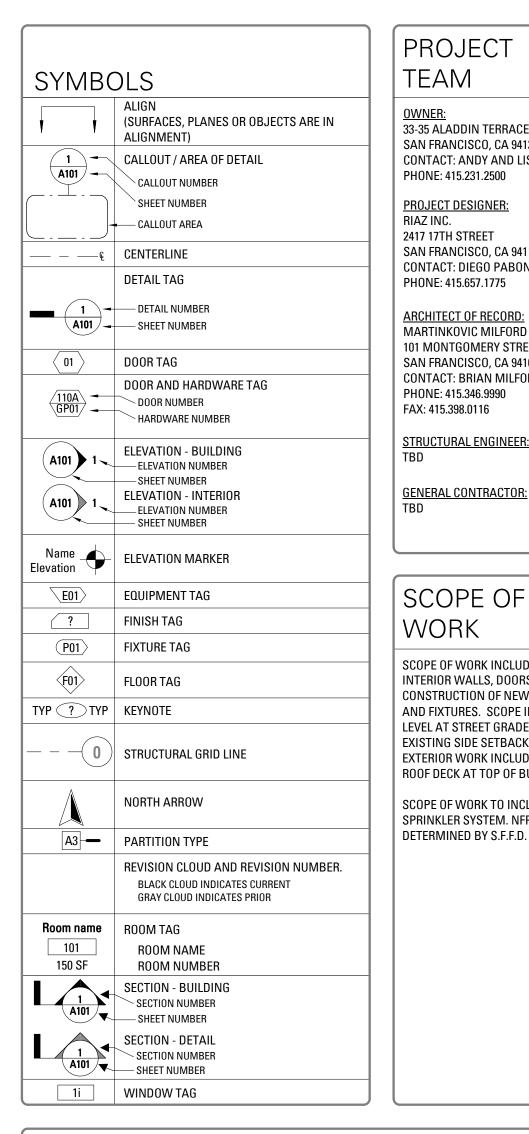
Pursuant to Planning Code Section 311, the Building Permit Application for this proposal may also be subject to notification of property owners and residents within 150-feet of the subject property.

APPEAL INFORMATION

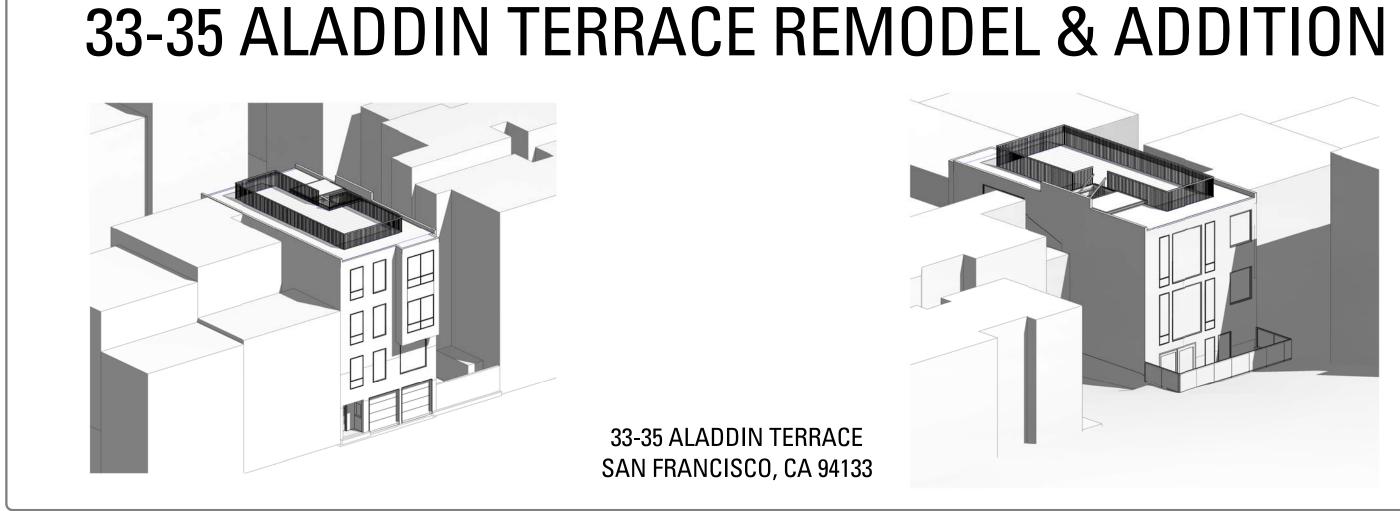
An appeal of the approval (or denial) of a **Variance application** by the Zoning Administrator may be made to the **Board of Appeals within 10 calendar days** after the Variance Decision Letter is issued by the Zoning Administrator.

An appeal of the approval (or denial) of a **building permit application** by the Planning Commission may be made to the **Board of Appeals within 15 calendar days** after the building permit is issued (or denied) by the Director of the Department of Building Inspection.

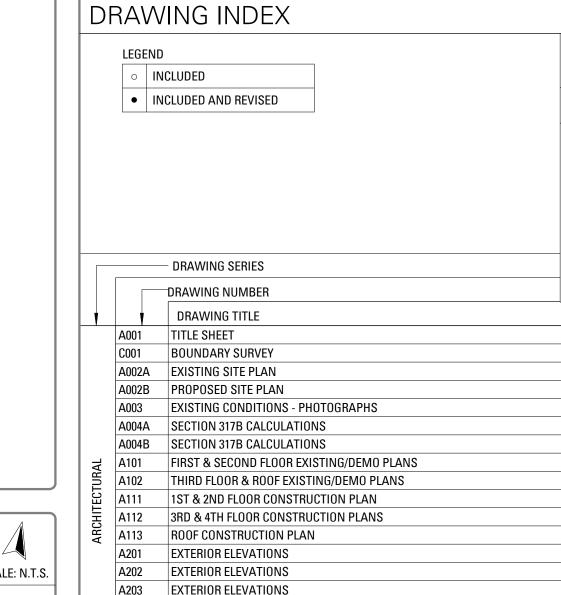
Appeals must be submitted in person at the Board's office at 1650 Mission Street, 3rd Floor, Room 304. For further information about appeals to the Board of Appeals, including current fees, contact the Board of Appeals at (415) 575-6880.











EXTERIOR ELEVATIONS

BUILDING SECTIONS

A301

A902 SCHEDULES

33-35 ALADDIN TERRACE REMODEL & ADDITION

33-35 ALADDIN TERRACE SAN FRANCISCO, CA 94133



101 Montgomery Street Suite 650 San Francisco, CA 94104 T 415 346 9990

PROJECT DESIGNER

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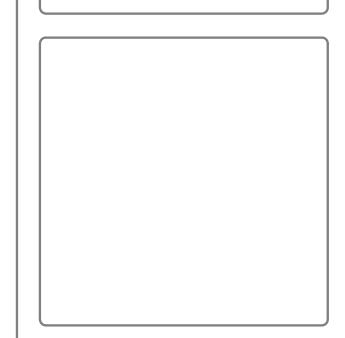
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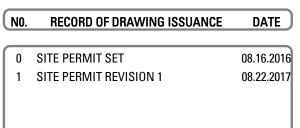
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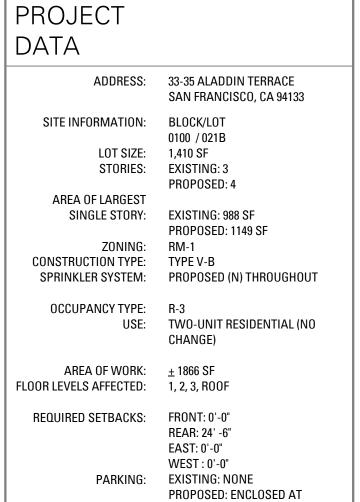
Drawn By: BE Checked By: 1639.1 Project Number:

TITLE SHEET

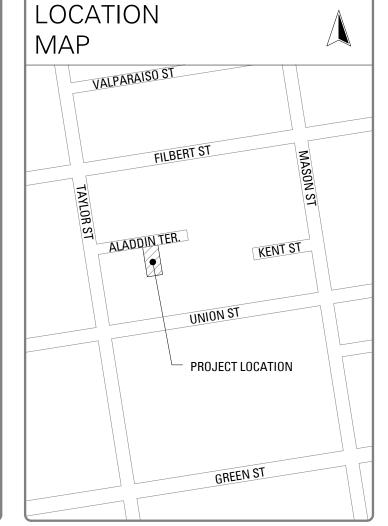


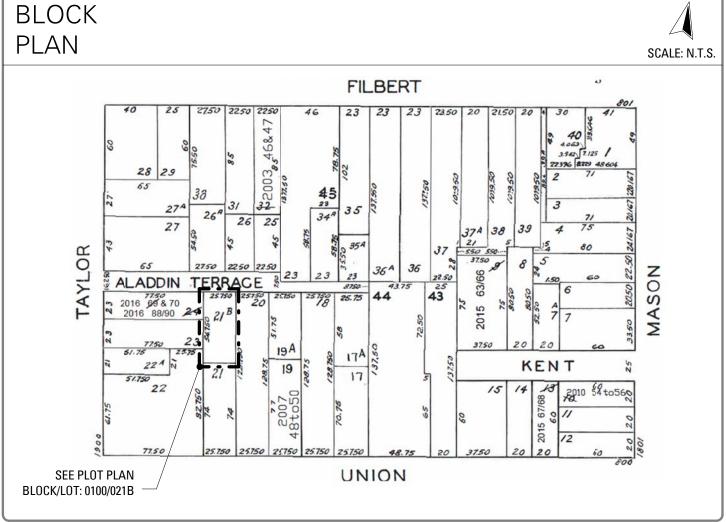
INTERIOR WALLS, DOORS, FINISHES AND FIXTURES AND LEVEL AT STREET GRADE WITH NEW GARAGE, INFILL OF EXISTING SIDE SETBACK AND INFILL OF EXISTING LIGHTWELL EXTERIOR WORK INCLUDES NEW WINDOWS, DOORS AND ROOF DECK AT TOP OF BUILDING.

SCOPE OF WORK TO INCLUDE A FULLY AUTOMATIC SPRINKLER SYSTEM. NFPA STANDARD SYSTEM TYPE TO BE DETERMINED BY S.F.F.D.



GROUND LEVEL (2 SPACES)





ABBREVIATIONS

•						
	&	AND	EXST.	EXISTING	N.T.S.	NOT TO SCALE
	@	AT	EXT.	EXTERIOR	0.A.	OVERALL
	G_	CENTERLINE	EXTR.	EXTRUSION	0.C.	ON CENTER
	±	PLUS OR MINUS	F.F.	FIRE ALARM	OFF.	OFFICE
	PL	PROPERTY LINE	F.E.	FIRE EXTINGUISHER	0.F.S.	OUTSIDE FACE OF STUD
	#	POUND OR NUMBER	F.E.C.	FIRE EXTINGUISHER CABINET	P.LAM	PLASTIC LAMINATE
	A.F.F.	ABOVE FINISH FLOOR	F.H.C.	FIRE HOSE CABINET	PLYWD.	PLYW00D
	AL.	ALUMINUM	FIN.	FINISH	PR.	PAIR
	ALUM.	ALUMINUM	FL.	FLOOR	PT.	POINT
	ANOD.	ANODIZED	FLUOR.	FLUORESCENT	PTN.	PARTITION
	_	APPROXIMATE	F.O.C.	FACE OF CONCRETE	R.	RISER
	A.R.	AS REQUIRED	F.O.F.	FACE OF FINISH	REF.	REFERENCE
	ARCH.	ARCHITECTURAL	F.O.P.	FACE OF PLYWOOD	REFR.	REFIGERATOR
	A/V	AUDIO/VISUAL	F.O.S.	FACE OF STUD	REQ.	REQUIRED
	BD.	BOARD	F.R.	FIRE RETARDENT or FIRE RATED	R.F.P.	REINFORCED FIBERGLASS PANE
	BLDG.	BUILDING	FT.	FOOT or FEET	RM.	ROOM
	BLK.	BLOCK	FURR.	FURRING	R.O.	ROUGH OPENING
	BLKG.	BLOCKING	FUT.	FUTURE	S.	SOUTH
	B.O.	BOTTOM OF	F.V.	FIELD VERIFY	S.C.D.	SEE CIVIL DRAWINGS
	B.U. BTWN.	BETWEEN	GA.	GAUGE	SCHED.	SCHEDULE
	CAB.	CABINET	GALV.	GALVANIZED	SECT.	SECTION
		CEILING	G.C.	GENERAL CONTRACTOR	S.E.D.	SEE ELECTRICAL DRAWINGS
	CLG.					
	CLKG.	CAULKING	GEN.	GENERAL	S.F.	SQUARE FEET
	CLOS.	CLOSET	GWB.	GYPSUM WALL BOARD	SIM.	SIMILAR
	CLR.	CLEAR	GYP.	GYPSUM	S.M.D.	SEE MECHANICAL DRAWINGS
	CMU	CONCRETE MASONRY UNIT	H.B.	HOSE BIB	SPEC.	SPECIFICATION
	C.O.	CLEAN OUT	H.C.	HANDICAPPED	SQ.	SQUARE
	COL.	COLUMN	H.M.	HOLLOW METAL	S.S.D.	SEE STRUCTURAL DRAWINGS
	CONC.	CONCRETE	HORIZ.	HORIZONTAL	SST.	STAINLESS STEEL
	CONN.	CONNECTION	HR.	HOUR	STD.	STANDARD
		CONSTRUCTION	HT.	HEIGHT	STL.	STEEL
	CONT.	CONTINUOUS	H.W.D.	HOT WATER DISPENSER	STOR.	STORAGE
	CORR.	CORRIDOR	H.W.H.	HOT WATER HEATER	STRUCT.	STRUCTURAL
	CTR.	CENTER	INSUL.	INSULATION	T.B.D.	TREAD
	CTSK.	COUNTERSUNK	INT.	INTERIOR	T.	TO BE DETERMINED
	DBL.	DOUBLE	JAN.	JANITOR	T&G	TONGUE AND GROOVE
	DEPT.	DEPARTMENT	J.C.	JANITOR'S CLOSET	TEL.	TELEPHONE
	DET.	DETAIL	JT.	JOINT	TEMP.	TEMPORARY
	D.F.	DRINKING FOUNTATIN	KIT.	KITCHEN	THK.	THICK
	DIA.	DIAMETER	LAM.	LAMINATE	T.0.	TOP OF
	DIM.	DIMENSION	LAV.	LAVATORY	T.0.S.	TOP OF SLAB
	DISP.	DISPENSER	MAX.	MAXIMUM	T.0.W.	TOP OF WALL
	DN.	DOWN	M.D.F.	MEDIUM DENSITY FIBERBOARD	TYP.	TYPICAL
	D.O.	DOOR OPENING	MECH.	MECHANICAL	U.L.	UNDERWRITERS LABORATORY
	DR.	D00R	MEMB.	MEMBRANE	U.O.N.	UNLESS OTHERWISE NOTED
	DWG.	DRAWING	MET.	METAL	UTIL.	UTILITY
	DWR.	DRAWER	MEZZ.	MEZZANINE	VAR.	VARIES
	(E)	EXISTING	MFR.	MANUFACTURER	V.C.T.	VINYL COMPOSITION TILE
	E	EAST	MIN.	MINIMUM	VERT.	VERTICAL
	EA.	EACH	MISC.	MISCELLANEOUS	V.I.F.	VERIFY IN FIELD
	E.J.	EXPANSION JOINT	M.O.	MASONRY OPENING	VOL.	VOLUME
	E.	ELEVATION	MTD.	MOUNTED	W.	WEST
	ELEC.	ELECTRICAL	MTG.	MOUNTING	WD.	WIDE or WIDTH
	ELEV.	ELEVATION	MUL.	MULLION	W/	WITH
	EMER.	EMERGENCY	(N)	NEW	w.c.	WATER CLOSET
	ENGR.	ENGINEER	N.	NORTH	WD.	W00D
	E.P.	ELECTRIAL PANEL BOARD	N.I.C.	NOT IN CONTRACT	W.O.	WHERE OCCURS
	EQ.	EQUAL	NO.	NUMBER	W/0	WITHOUT
	EQPT	EQUIPMENT	NOM.	NOMINAL	WT.	WEIGHT
					VVI.	VADD

APPLICABLE

2013 CALIFORNIA BUILDING CODE 2013 CALIFORNIA ELECTRICAL CODE 2013 CALIFORNIA MECHANICAL CODE 2013 CALIFORNIA PLUMBING CODE 2013 CALIFORNIA FIRE CODE 2013 CALIFORNIA ENERGY CODE 2013 CALIFORNIA TITLE 24 ENERGY EFFICIENCY STANDARDS 2013 CALIFORNIA GREEN BUILDING CODE 2013 SAN FRANCISCO BUILDING CODE AMENDMENTS 2013 SAN FRANCISCO ELECTRICAL CODE AMENDMENTS 2013 SAN FRANCISCO MECHANICAL CODE AMENDMENTS 2013 SAN FRANCISCO PLUMBING CODE AMENDMENTS 2013 SAN FRANCISCO GREEN BUILDING CODE AMENDMENTS 2013 SAN FRANCISCO HOUSING CODE AMENDMENTS 2013 SAN FRANCISCO FIRE CODE AMENDMENTS

ADDITIONAL

NFPA 13 & NFPA 13R

DEFERRED SUBMITTALS & COORDINATING SCOPE OF WORK AS REQUIRED

LIFE SAFETY LANDSCAPING SHORING AND/OR UNDERPINNING FIRE ALARM AND/OR LIFE SAFETY FIRE SPRINKLER CIVIL ENGINEERING STRUCTURAL

EXISTING AND PROPOSED UNIT AREAS

GROSS SQUARE FOOTAGE BY FLOOR: UNIT 1 EXISTING: 897 SF UNIT 1 PROPOSED: 1317 SF UNIT 2 EXISTING: 900 SF UNIT 2 PROPOSED: 2050 SF EXISTING COMMON AREAS AND COMMON STAIRS: 1011 SF PROPOSED GARAGE, CORRIDORS AND COMMON STAIRS: 895 SF EXISTING YARDS AND DECKS: 282 SF PROPOSED YARDS AND DECKS: 1308 SF TOTAL EXISTING GROSS BUILDING AREA: 2877 SF

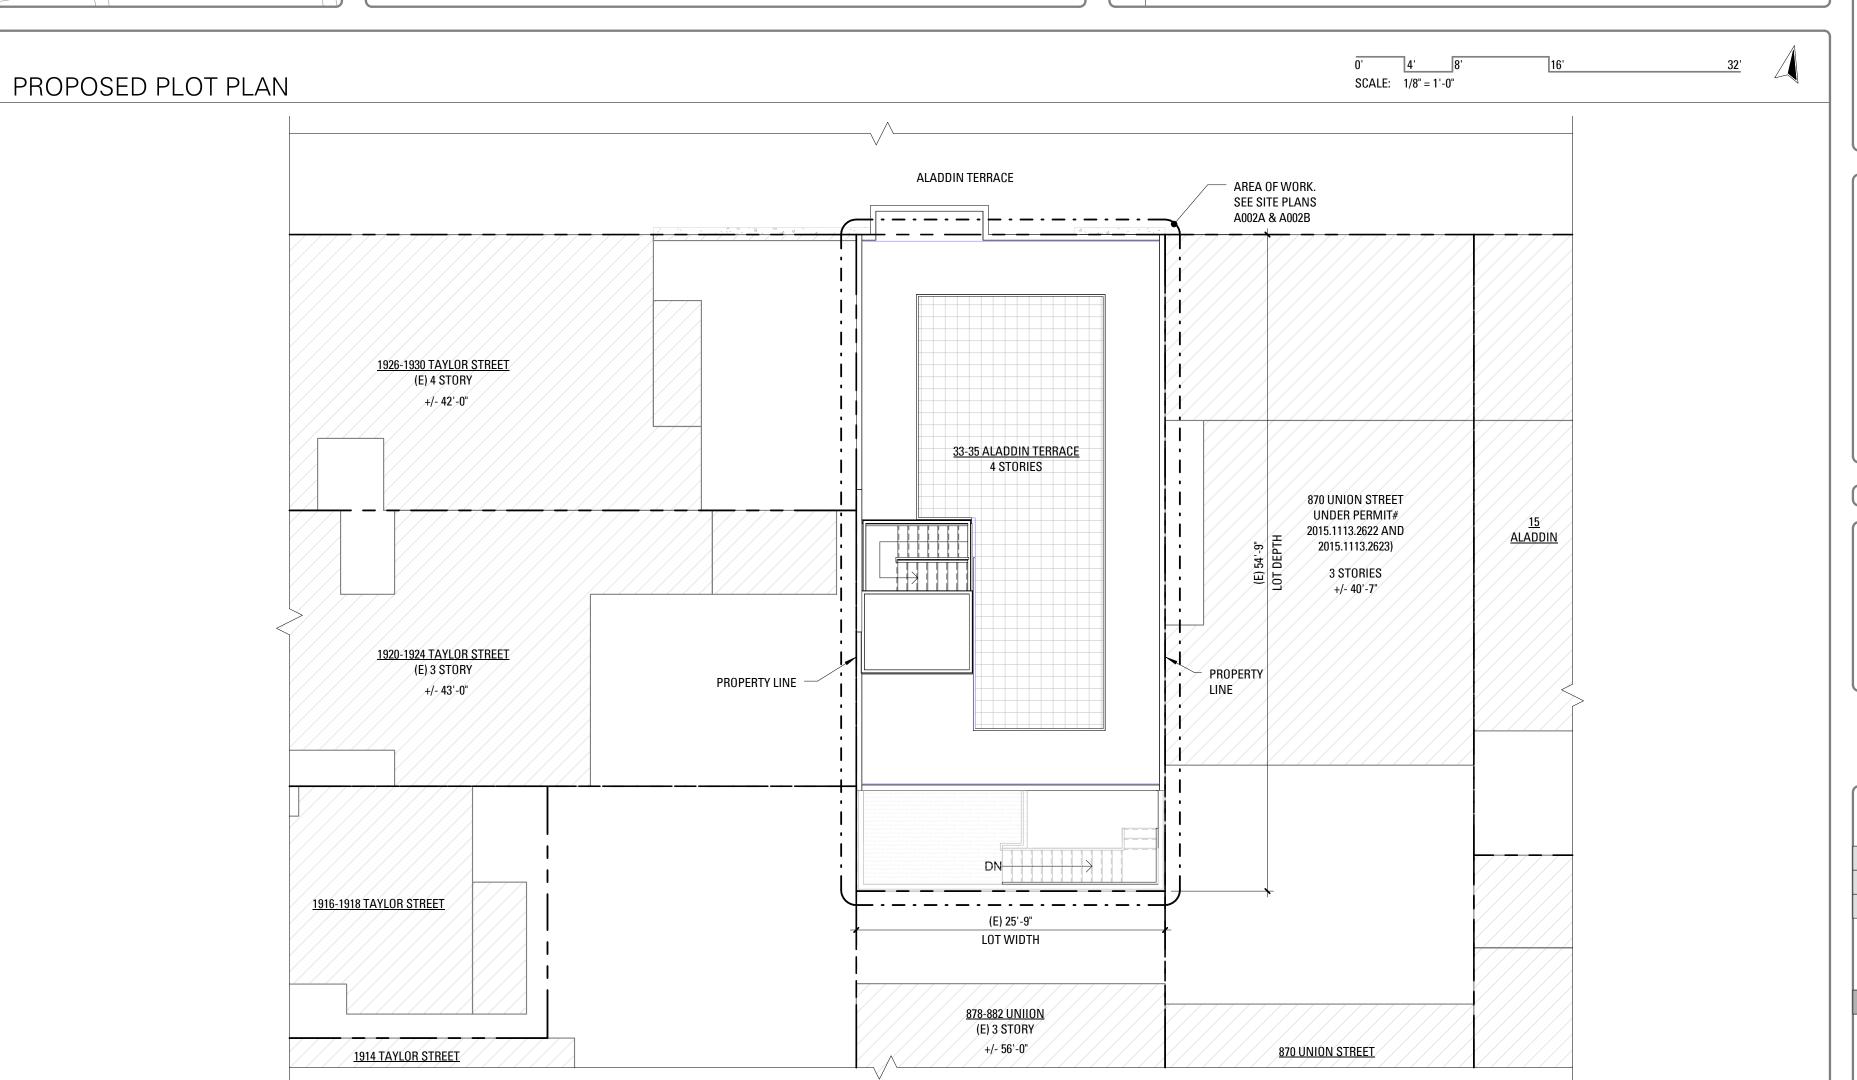
TOTAL PROPOSED GROSS BUILDING AREA: 4486 SF

UNIT 1 EXISTING BEDROOMS: 2 UNIT 1 PROPOSED BEDROOMS: 2 UNIT 2 EXISTING BEDROOMS: 2 UNIT 2 PROPOSED BEDROOMS: 3 TOTAL EXISTING BEDROOMS: 4

TOTAL PROPOSED BEDROOMS: 5

YARD

55.92% INCREASE IN GROSS SF






33-35 ALADDIN TERRACE REMODEL & ADDITION


33-35 ALADDIN TERRACE SAN FRANCISCO, CA 94133



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N0.	RECORD OF DRAWING ISSUANCE	DATE
0	SITE PERMIT SET	08.16.2016

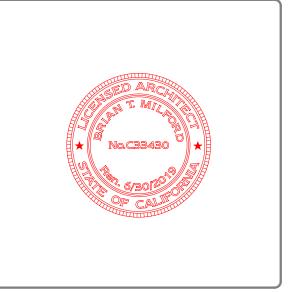SITE PERMIT SET REVISION 1

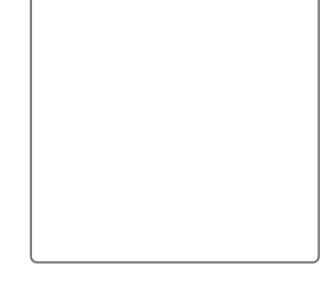Drawn By: AW
Checked By: BE
Project Number: 1639.1

EXISTING SITE PLAN

A002A

SHEET NUMBER




33-35 ALADDIN TERRACE REMODEL & ADDITION

33-35 ALADDIN TERRACE SAN FRANCISCO, CA 94133



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10 .	RECORD OF DRAWING ISSUANCE	DATE
0	SITE PERMIT SET	08.16.2016
1	SITE PERMIT REVISION 1	08.22.2017

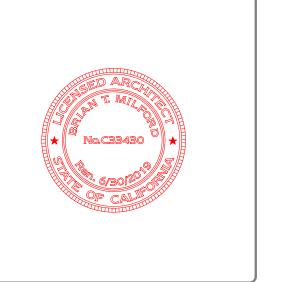SITE PERMIT SET REVISION 1

Drawn By: AW
Checked By: BE
Project Number: 1639.1

PROPOSED SITE PLAN

SHEET NUMBER

4002B



(13) ALADDIN TERRACE FROM TAYLOR ST



(12) VIEWS FROM SUBJECT PROPERTY ROOF



(11) Existing Photos - from roof 2



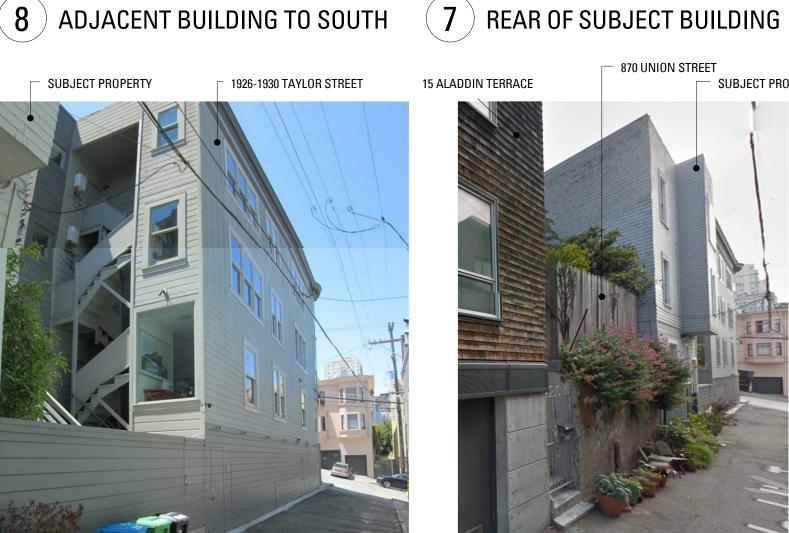
1926-1930 TAYLOR STREET

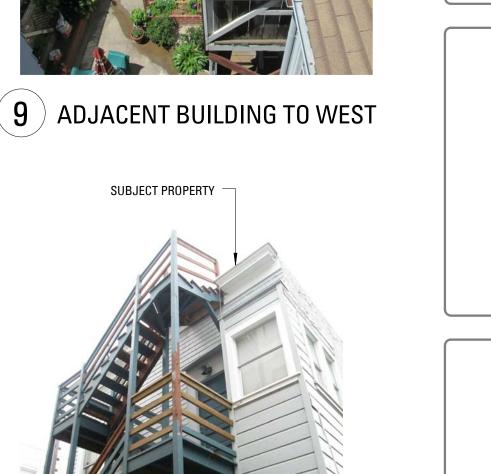
(10) ADJACENT BUILDING TO WEST











1926-1930 TAYLOR STREET

NO. RECORD OF DRAWING ISSUANCE DATE 0 SITE PERMIT SET SUBJECT PROPERTY

AW BE

1639.1

33-35 ALADDIN

TERRACE

REMODEL &

ADDITION

33-35 ALADDIN TERRACE SAN FRANCISCO, CA 94133

MARTINKOVIC MILFORD ARCHITECTS

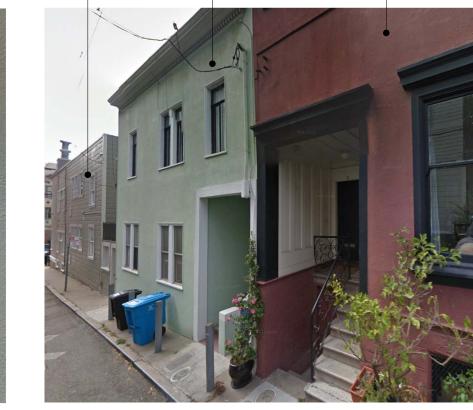
101 Montgomery Street Suite 650

San Francisco, CA 94104 T 415 346 9990





6 NORTH SIDE OF ALADDIN TERRACE



1932-1938 TAYLOR STREE34-36 ALADDIN TERRACE

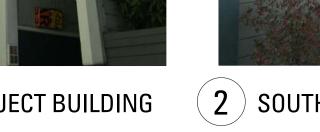
5 Existing Photos - north 2



(4) Existing Photos - north 3



(3) FRONT OF SUBJECT BUILDING



2 SOUTH SIDE OF ALADDIN TERRACE






ABOVE GRADE VERTICAL ELEMENTS IN SQUARE EET	EXISTING	PROPOSED REMOVAL	PERCENT REMOVAL	PERCENT BY CODE	COMPLIES?
FRONT (NORTH) ELEVATION	966.8 SF	364.8 SF	37.7%		
REAR (SOUTH) ELEVATION	482.9 SF	321.8 SF	66.6 %		
EAST ELEVATION	1389.5 SF	587.5 SF	42.3 %		
WEST ELEVATION	1668.8 SF	742.8 SF	44.5 %		
TOTAL:	4508 SF	2016.9	44.7%	50%	YES
ABOVE GRADE HORIZONTAL ELEMENTS IN SQUARE	EXISTING	PROPOSED	PERCENT	PERCENT BY	COMPLIES?
ABOVE GRADE HORIZONTAL ELEMENTS IN SQUARE FEET	EXISTING	PROPOSED REMOVAL	PERCENT REMOVAL	PERCENT BY CODE	COMPLIES?
	EXISTING N/A				COMPLIES?
FEET		REMOVAL	REMOVAL		COMPLIES?
FIRST FLOOR (SLAB ON GRADE)	N/A	REMOVAL N/A	REMOVAL N/A		COMPLIES?
FIRST FLOOR (SLAB ON GRADE) SECOND FLOOR	N/A 947 SF	N/A 947 SF	N/A 100%		COMPLIES?

(E) FRONT T.O.ROOF 38' - 11 3/8" (E) REAR T.O.ROOF 36' - 7 7/8"

DATE 08.16.201
 18.16.201
08.22.201
N 1
IN I
er

7	VERTICAL DEMOLITION CALCULATION DIAGRAMS 1/8" = 1'-0"
Z	1/8" = 1'-0"



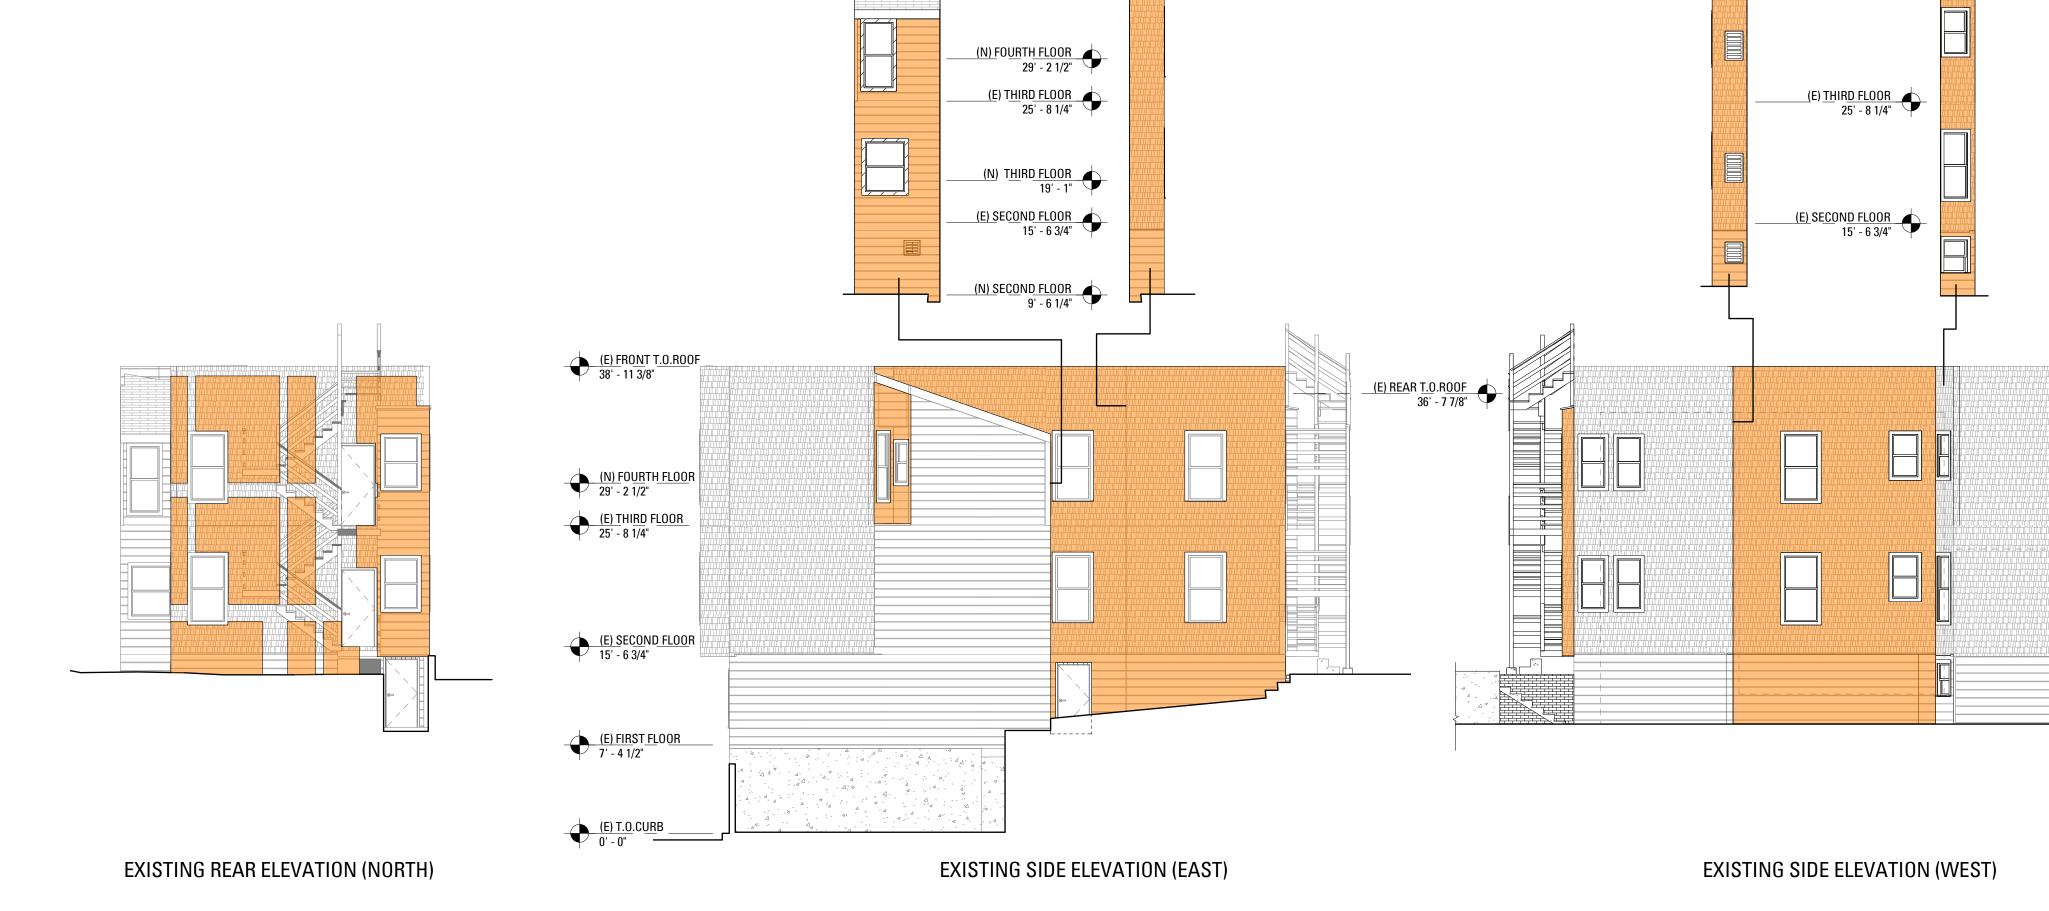

(E) FRONT T.O.ROOF 38' - 11 3/8" (E) REAR T.O.ROOF 36' - 7 7/8"



08.22.2017



(E) FRONT T.O.ROOF 38' - 11 3/8" (E) REAR T.O.ROOF 36' - 7 7/8"

(E) THIRD FLOOR 25' - 8 1/4"

(E) <u>SECOND FLOOR</u> 15' - 6 3/4"

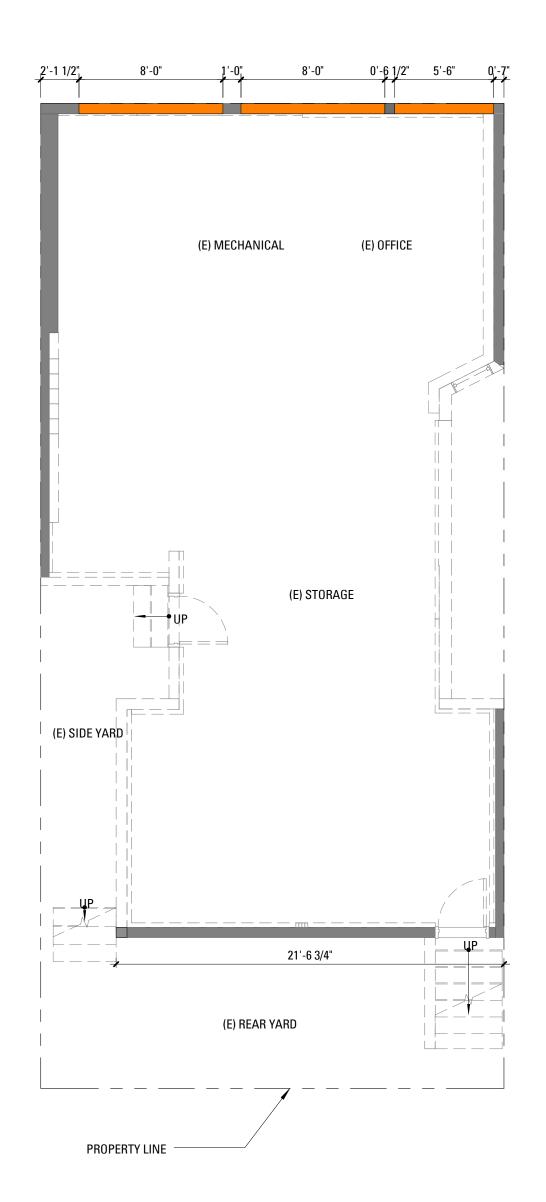
(E) FIRST FLOOR 7' - 4 1/2"

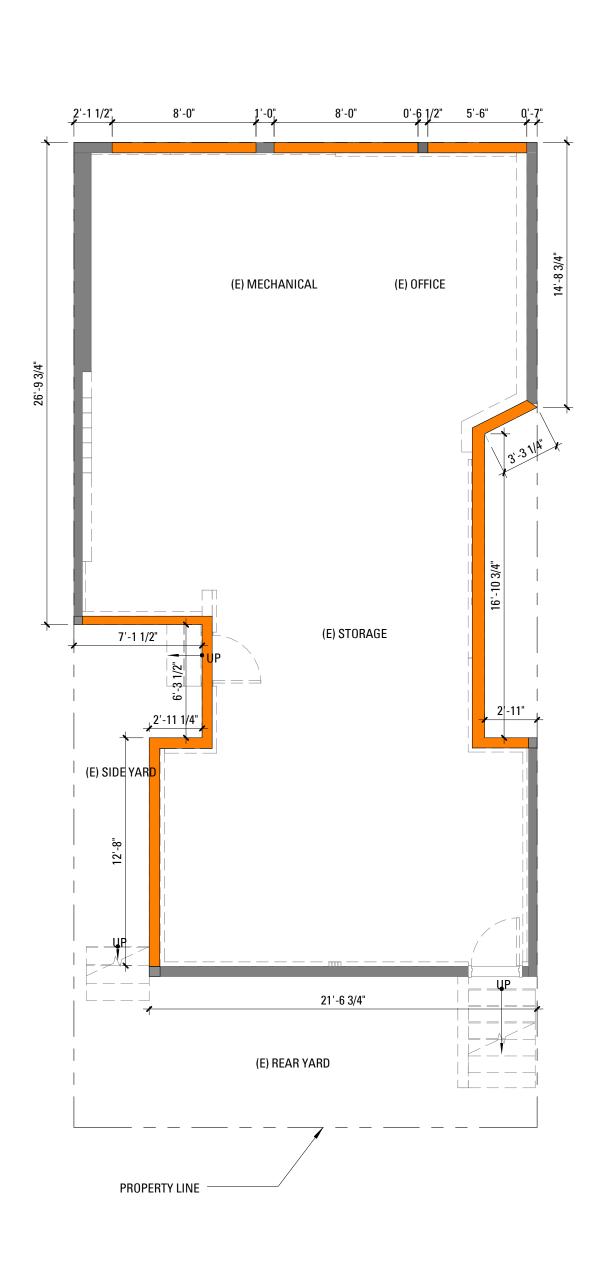
(E) T.O.CURB 0' - 0"



33-35 ALADDIN TERRACE REMODEL &

ADDITION






33-35 ALADDIN TERRACE REMODEL & ADDITION


33-35 ALADDIN TERRACE SAN FRANCISCO, CA 94133



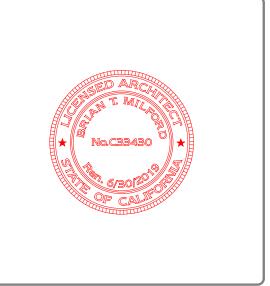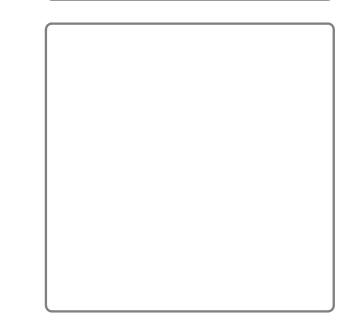101 Montgomery Street Suite 650 San Francisco, CA 94104 T 415 346 9990







NO. RECORD OF DRAWING ISSUANCE DATE

0 SITE PERMIT SET 08.16.2016

0 SITE PERMIT SET
1 SITE PERMIT REVISION 1

08.22.2017


M OF FRONT AND REAR WALLS MEASURED LINEAL FEET AT THE FOUNDATION	EXISTING	PROPOSED REMOVAL	PERCENT REMOVAL	PERCENT BY CODE	COMPLIES?
ONT (NORTH) ELEVATION	25'-7"	21'-6"	86%		
AR (SOUTH) ELEVATION	21'-6 3/4"	0'-0"	0%		
TOTAL:	46'-1 3/4"	21'-6"	46.6%	50%	YES
M OF EXTERIOR WALLS MEASURED IN NEAL FEET AT THE FOUNDATION	EXISTING	PROPOSED REMOVAL	PERCENT REMOVAL	PERCENT BY CODE	COMPLIES?
RIMETER	150'-1/2"	73'-7 1/4"	49.1%	65%	YES

-SURFACE AREA TO BE REMOVED

SITE PERMIT SET REVISION 1

Drawn By: Author
Checked By: Approver
Project Number: 1639.1
SECTION 317B
CALCULATIONS

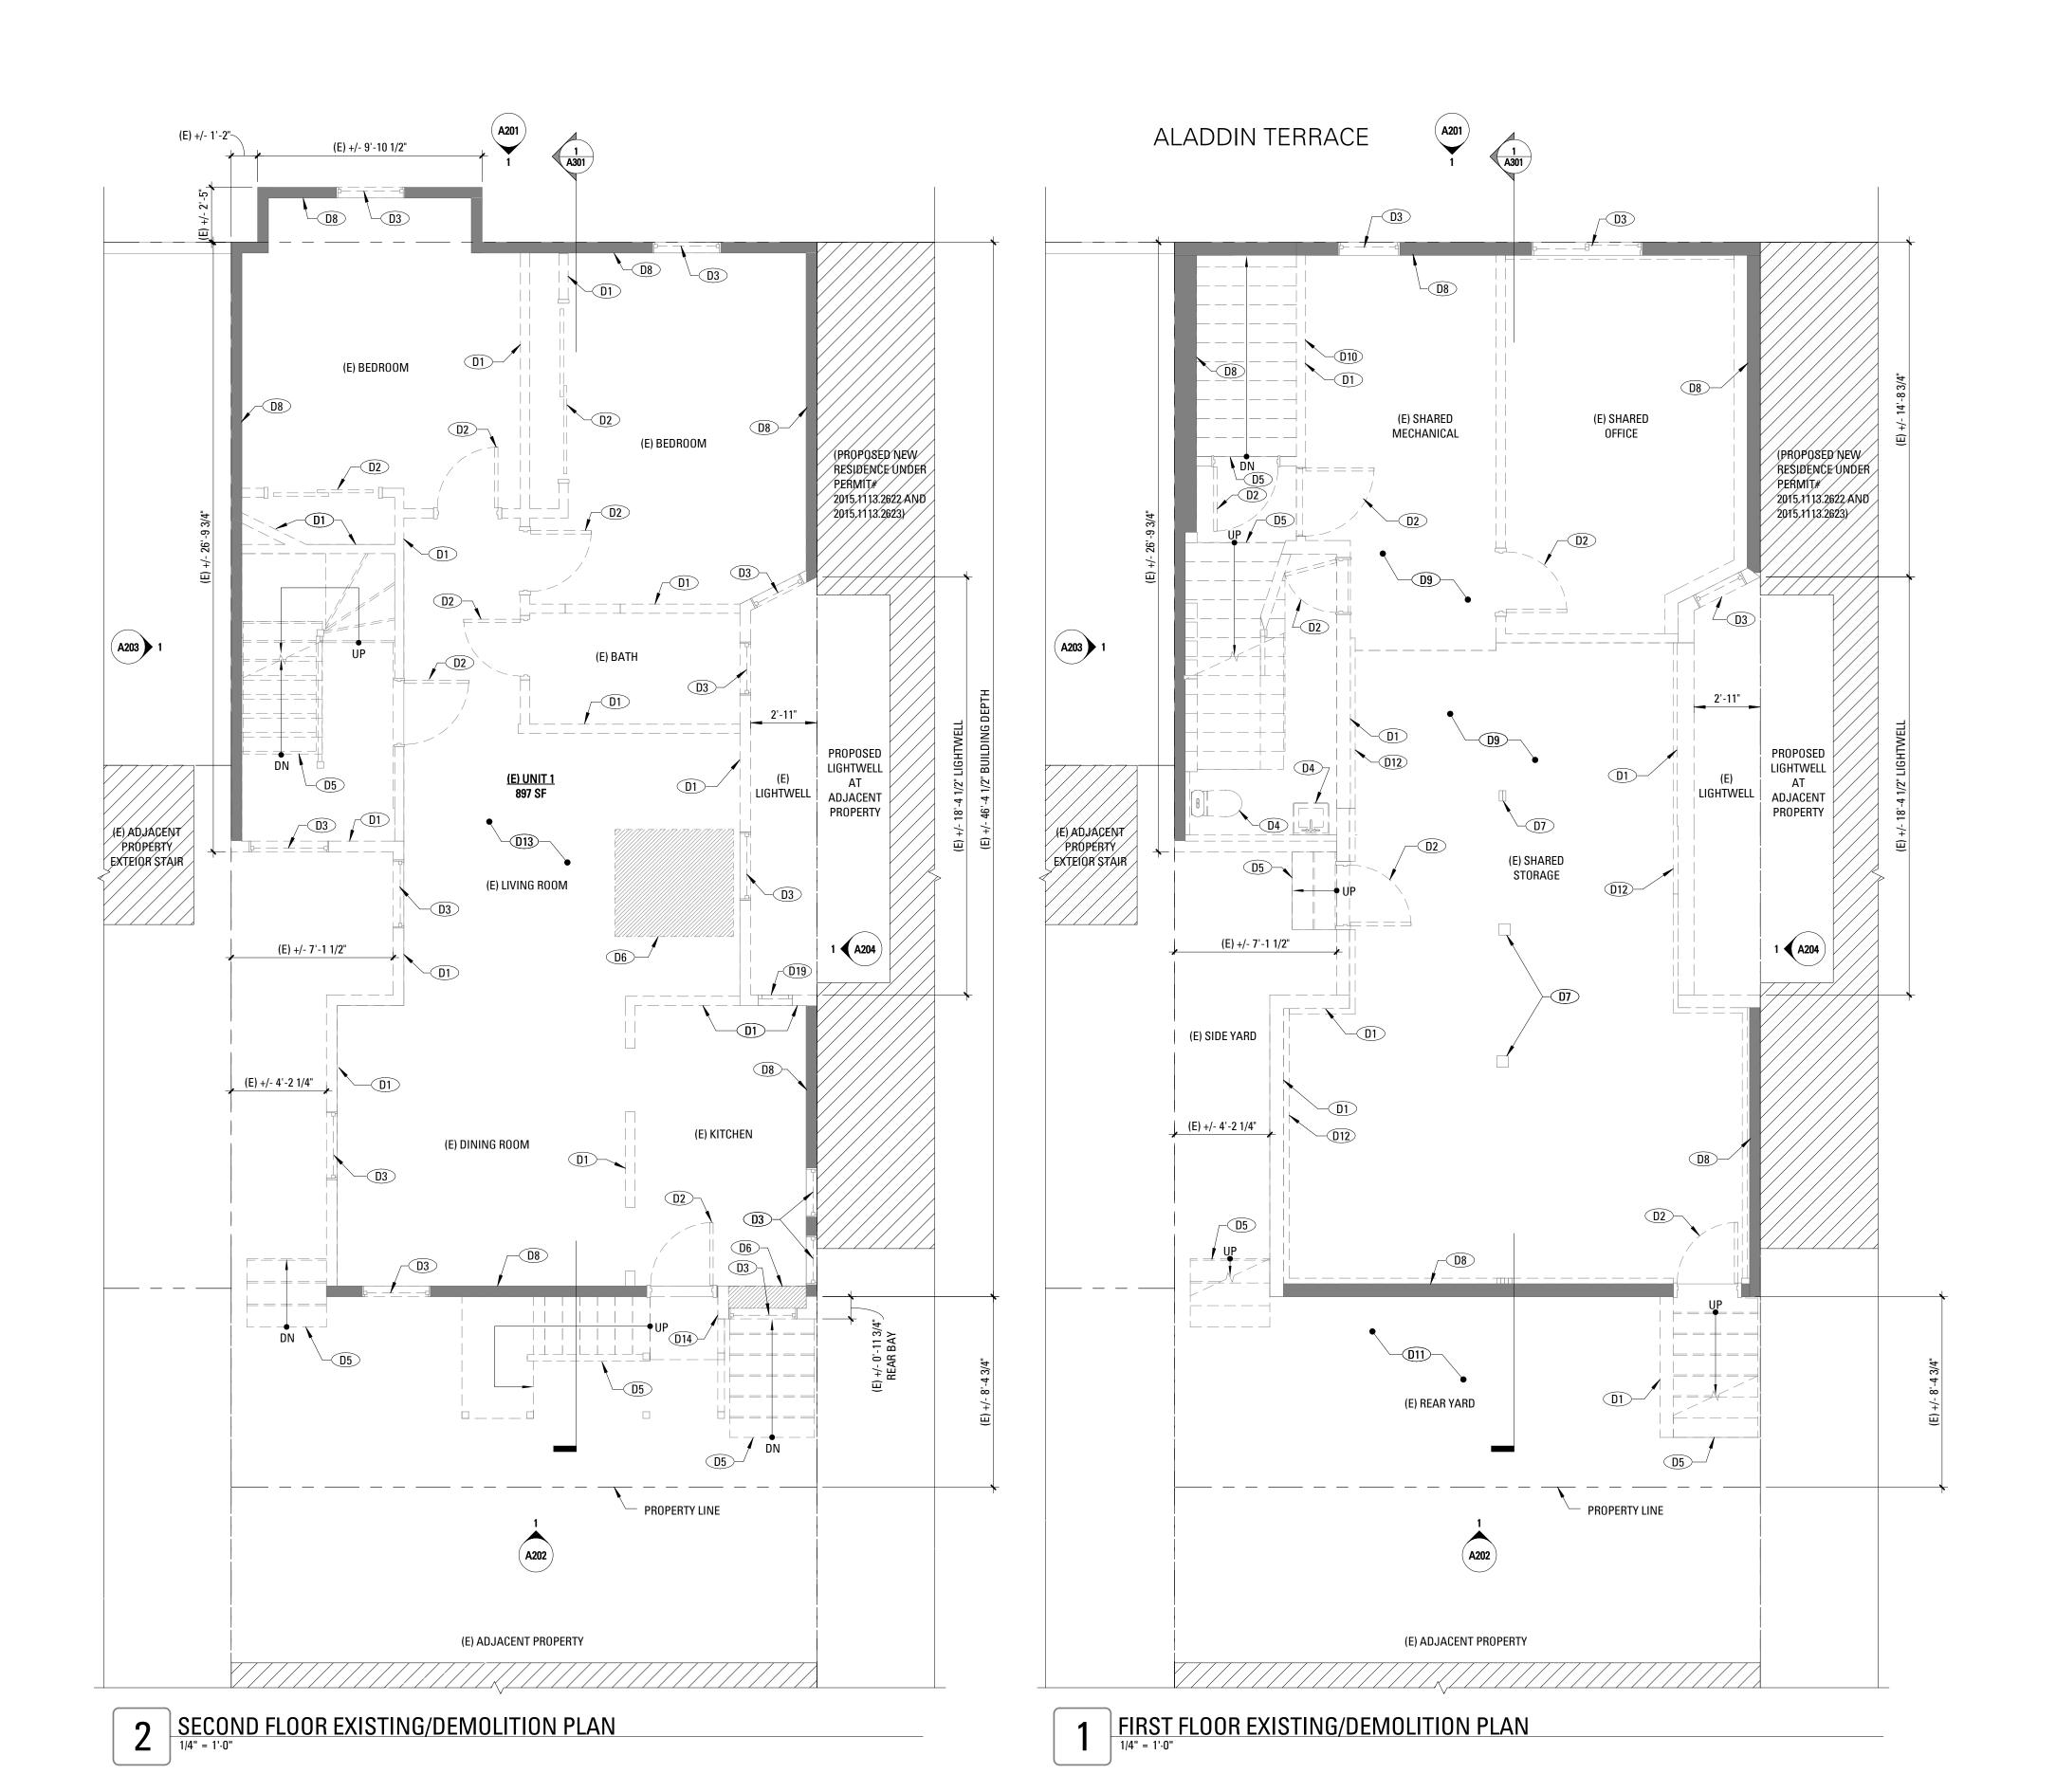A004B



PLAN LEGEND (E) CONSTRUCTION TO BE REMOVED (E) CONSTRUCTION TO BE REMOVED (E) PTN TO REMAIN WALL TAG (N) NON-RATED PTN (N) NON-RATED ACOUSTIC INT PTN. (N) 1HR-RATED, INSULATED INT. PTN. (N) 2HR-RATED, INSULATED INT. PTN. (N) INT. TEMPERED GLASS PTN. (N) DOOR TAG (N) SWING DOOR DASHED LINE INDICATES ADDITIONAL BACKING TO BE MOUNTED. SEE 1/A111 FOR LOCATIONS. PROVIDE BACKING FOR MILLWORK A.R. ALL BACKING TO BE CONCEALED HOSE BIB GAS SHUTOFF VALVE _____ ITEMS OVERHEAD AREA NOT IN CONTRACT.

DEMOLITION PLAN GENERAL NOTES

- SEE SHEET A001 FOR LEGEND AND ABBREVIATIONS DEMOLITION WITH NEW CONSTRUCTION. REFER TO PLANS AND ELEVATIONS. PROTECT ALL PORTIONS OF (E) STRUCTURE TO
- REMOVE ALL (E) FINISHES, HARDWARE, EQUIPMENT, CONDUIT,
- CAP OFF ALL PLUMBING, GAS, & ELECTRICAL LINES WHERE APPLIANCES AND FIXTURES ARE DISCONNECTED.
- CONTRACTOR SHALL ENSURE THE STABILITY OF ALL (E) STRUCTURE, FRAMING AND FOUNDATIONS TO REMAIN DURING
- DEMOLITION AND CONSTRUCTION OF NEW WORK CONTRACTOR SHALL REPLACE ALL DAMAGED OR DECAYED EXISTING WOOD FRAMING, FLOOR, OR SHEATHING IN AREAS OF REMODEL AND REPAIR. NOTIFY ARCHITECT IF DAMAGED OR DECAYED CONDITIONS ARE ENCOUNTERED PRIOR TO
- COMMENCING REPAIR WORK. DOCUMENTATION HEREIN DOES NOT AUTHORIZE, DESCRIBE, REQUIRE OR INCLUDE THE REMOVAL OF ANY HAZARDOUS MATERIALS OR ELEMENTS, INCLUDING, BUT NOT LIMITED TO LEAD PAINT, ASBESTOS AND PCB'S. GENERAL CONTRACTOR SHALL COMPLY WITH ALL APPLICABLE LAWS, REGULATIONS, ORDINANCES AND RULES RELATING TO ANY HAZARDOUS OR TOXIC MATERIALS. IF GENERAL CONTRACTOR DISCOVERS ANY SUCH MATERIALS ON THE PROPERTY, GENERAL CONTRACTOR SHALL PROMPTLY NOTIFY THE OWNER. ANY REMOVAL OF HAZARDOUS MATERIALS SHALL BE DOCUMENTED SEPARATELY, AND SHALL OCCUR AS REQUIRED BY CODE AND REGULATORY

DEMOLITION

KEYNOTES

- REMOVE (E) WALL TO ACCOMMODATE (N) WORK
- REMOVE (E) PLUMBING FIXTURE; CAP OFF/RE-ROUTE UTILITY LINES AS REQ'D
- WORK SEE NEW CONSTRUCTION SHEETS A111-A113
- REMOVE (E) FLOOR SLAB AND EXCAVATE AS REQUIRED FOR (N) FIRST FLOOR SLAB
- RELOCATE (E) RADIANT HEAT MANIFOLD AND TANKLESS WATER HEATER
- D11 (E) REAR YARD TO BE EXCAVATED TO ACCOMMODATE (N) WORK
- D13 (E) FLOOR ASSEMBLY TO BE RAISED, SEE (E) AND (N) LEVELS ON


33-35 ALADDIN TERRACE REMODEL & ADDITION 33-35 ALADDIN TERRACE

SAN FRANCISCO, CA 94133



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- REMOVE (E) DOOR
- REMOVE (E) WINDOW TO ACCOMMODATE (N) WORK
- REMOVE (E) STAIRS AND (E) HANDRAIL W.O.
- REMOVE PORTION OF (E) FLOOR PLATE TO ACCOMMODATE (N)
- REMOVE (E) COLUMNS
- REMOVE (E) WALL FINISHES. (E) FRAMING TO REMAIN
- D12 REMOVE (E) FOUNDATION WALL
- ELEVATION SHEETS A201-A204 D14 REMOVE (E) REAR POPOUT
- D19 REMOVE (E) WALL VENT

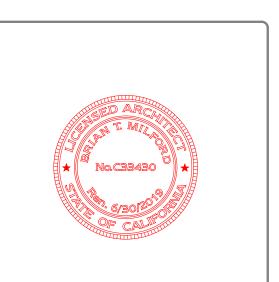NO. RECORD OF DRAWING ISSUANCE DATE

0 SITE PERMIT SET 08.16.2016




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AW Drawn By: BE Checked By: 1639.1 Project Number:

FIRST & SECOND FLOOR EXISTING/DEMO PLANS

SHEET NUMBER

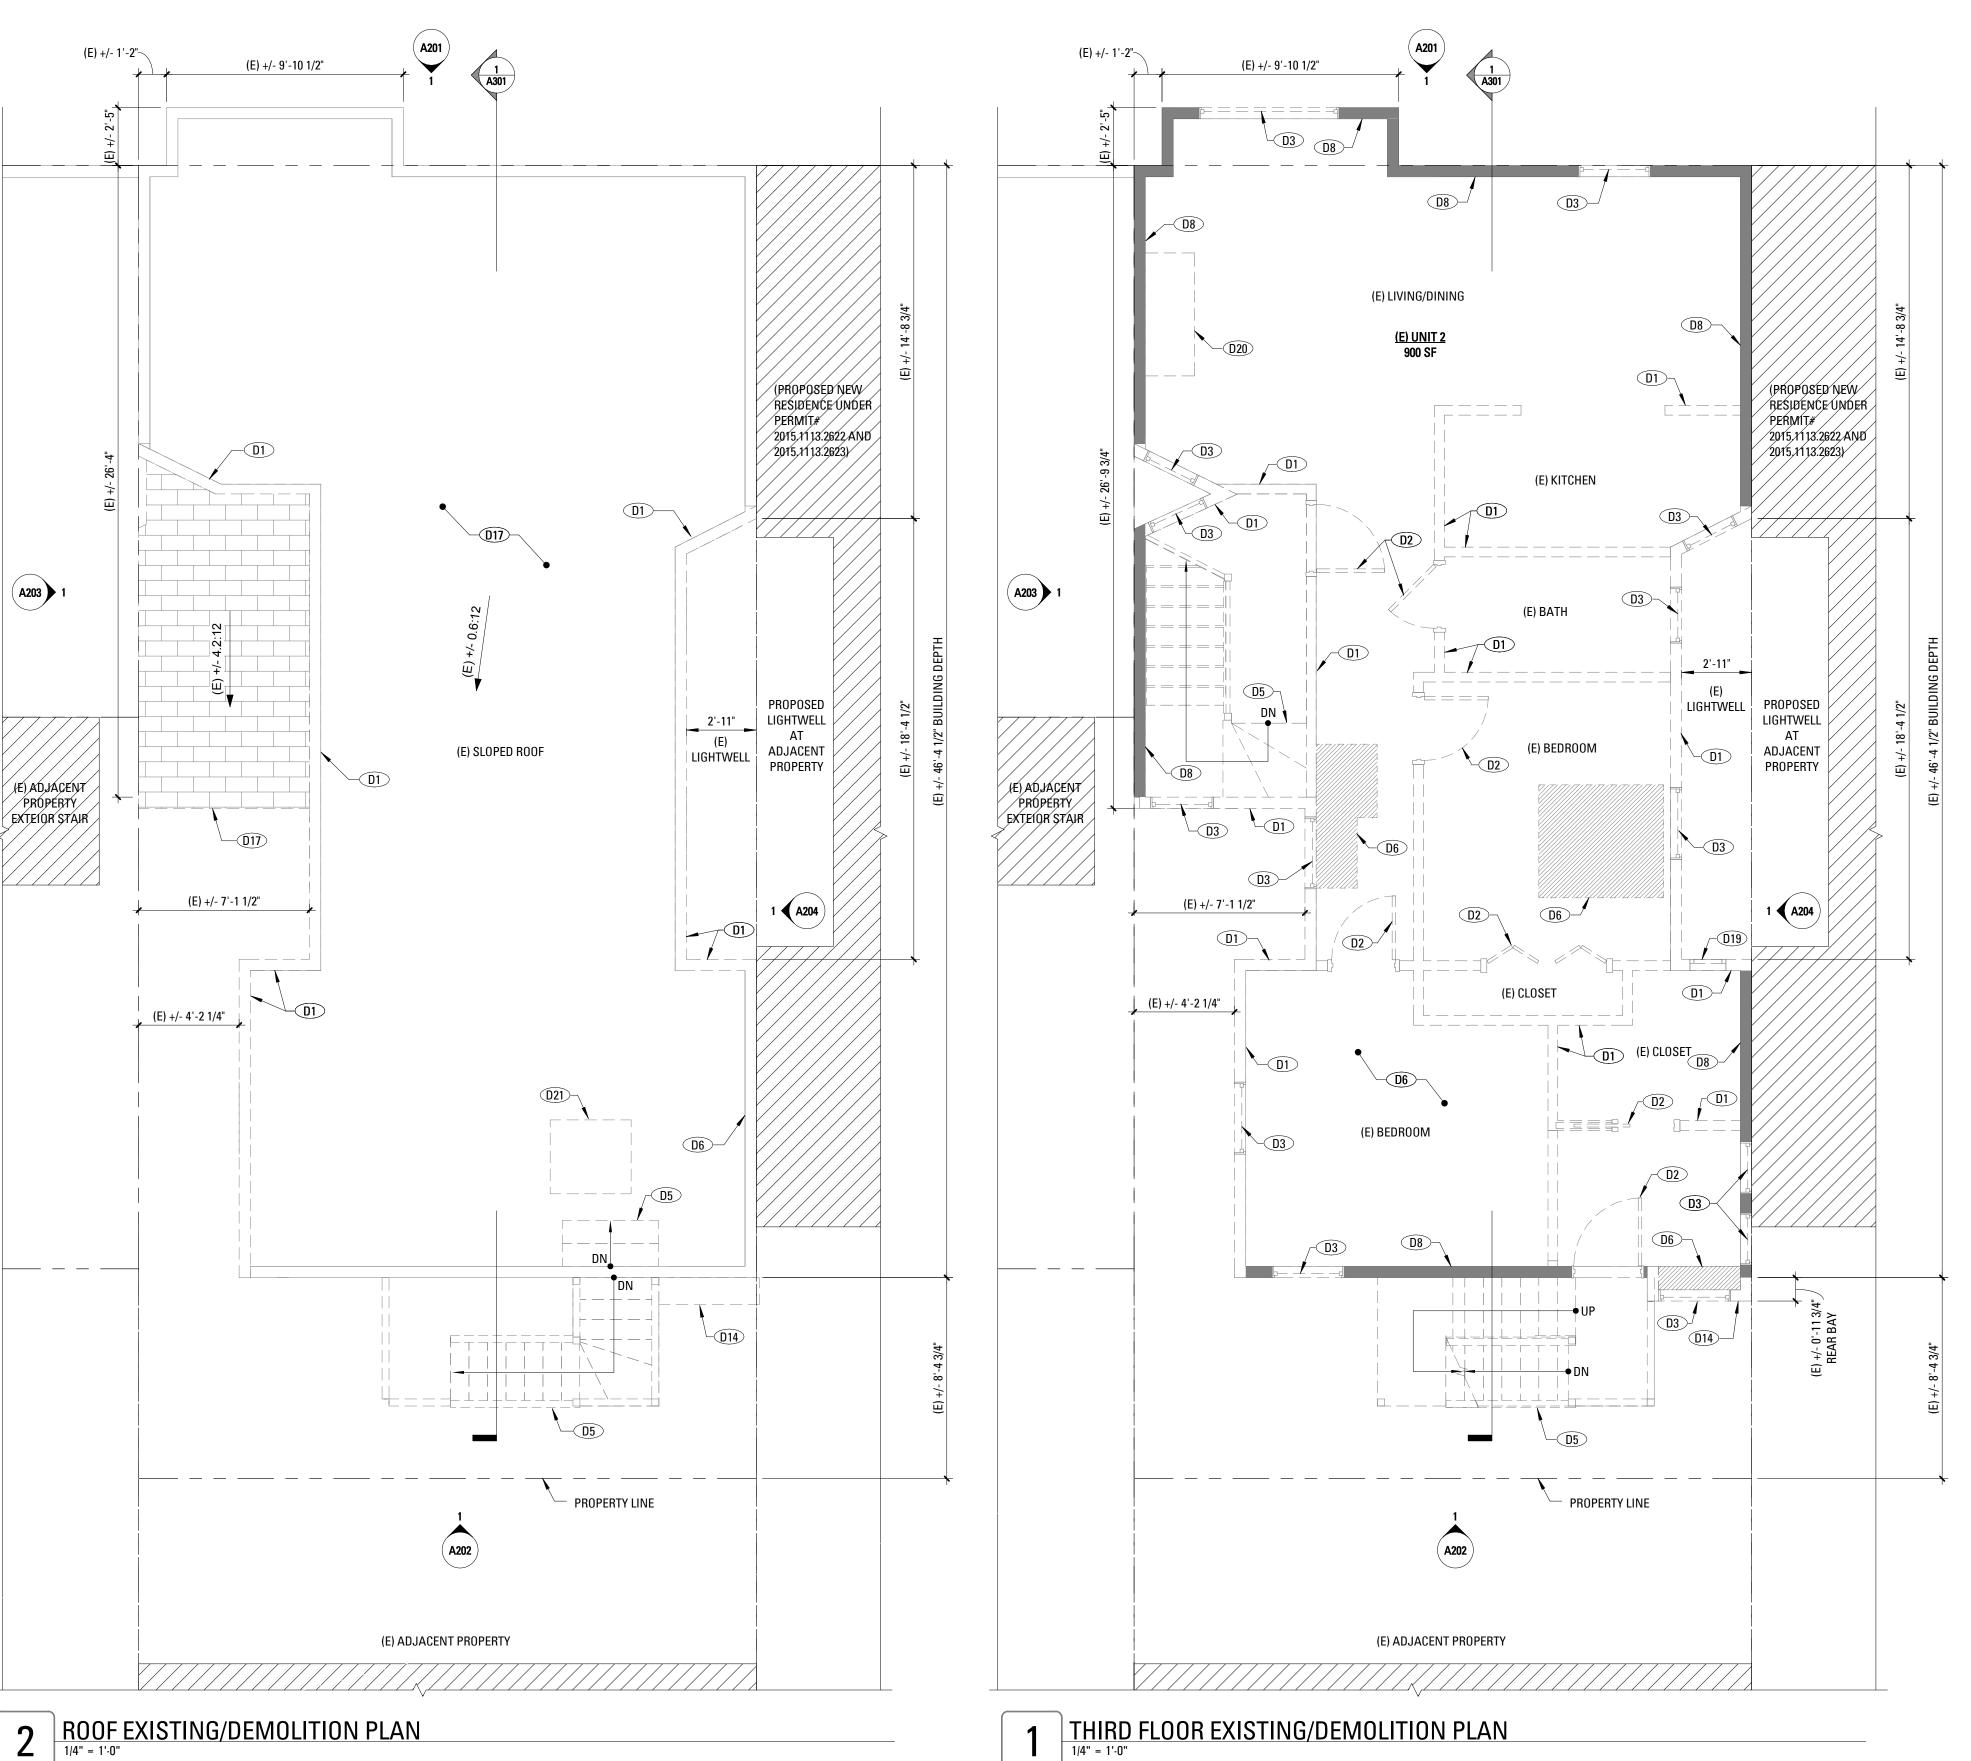A101



PLAN LEGEND (E) CONSTRUCTION TO BE REMOVED (E) CONSTRUCTION TO BE REMOVED (E) PTN TO REMAIN WALL TAG (N) NON-RATED PTN (N) NON-RATED ACOUSTIC INT PTN. (N) 1HR-RATED, INSULATED INT. PTN. (N) 2HR-RATED, INSULATED INT. PTN. (N) INT. TEMPERED GLASS PTN. (N) DOOR TAG (N) SWING DOOR DASHED LINE INDICATES ADDITIONAL BACKING TO BE MOUNTED. SEE 1/A111 FOR LOCATIONS. PROVIDE BACKING FOR MILLWORK A.R. ALL BACKING TO BE CONCEALED HOSE BIB GAS SHUTOFF VALVE _____ ITEMS OVERHEAD AREA NOT IN CONTRACT.

DEMOLITION PLAN GENERAL NOTES

- SEE SHEET A001 FOR LEGEND AND ABBREVIATIONS CONTRACTOR SHALL COORDINATE THE EXTENT OF THE DEMOLITION WITH NEW CONSTRUCTION. REFER TO PLANS AND ELEVATIONS. PROTECT ALL PORTIONS OF (E) STRUCTURE TO
- REMOVE ALL (E) FINISHES, HARDWARE, EQUIPMENT, CONDUIT, PLUMBING, AND FRAMING NECESSARY TO ACCOMMODATE ALL
- NEW WORK. CAP OFF ALL PLUMBING, GAS, & ELECTRICAL LINES WHERE
- APPLIANCES AND FIXTURES ARE DISCONNECTED. CONTRACTOR SHALL ENSURE THE STABILITY OF ALL (E) STRUCTURE, FRAMING AND FOUNDATIONS TO REMAIN DURING DEMOLITION AND CONSTRUCTION OF NEW WORK
- CONTRACTOR SHALL REPLACE ALL DAMAGED OR DECAYED EXISTING WOOD FRAMING, FLOOR, OR SHEATHING IN AREAS OF REMODEL AND REPAIR. NOTIFY ARCHITECT IF DAMAGED OR DECAYED CONDITIONS ARE ENCOUNTERED PRIOR TO
- COMMENCING REPAIR WORK. DOCUMENTATION HEREIN DOES NOT AUTHORIZE, DESCRIBE, REQUIRE OR INCLUDE THE REMOVAL OF ANY HAZARDOUS MATERIALS OR ELEMENTS, INCLUDING, BUT NOT LIMITED TO LEAD PAINT, ASBESTOS AND PCB'S. GENERAL CONTRACTOR SHALL COMPLY WITH ALL APPLICABLE LAWS, REGULATIONS, ORDINANCES AND RULES RELATING TO ANY HAZARDOUS OR TOXIC MATERIALS. IF GENERAL CONTRACTOR DISCOVERS ANY SHALL PROMPTLY NOTIFY THE OWNER. ANY REMOVAL OF HAZARDOUS MATERIALS SHALL BE DOCUMENTED SEPARATELY, AND SHALL OCCUR AS REQUIRED BY CODE AND REGULATORY REQUIREMENTS.

DEMOLITION

KEYNOTES


- REMOVE (E) WALL TO ACCOMMODATE (N) WORK
- REMOVE (E) DOOR
- REMOVE (E) WINDOW TO ACCOMMODATE (N) WORK REMOVE (E) STAIRS AND (E) HANDRAIL W.O.
- REMOVE PORTION OF (E) FLOOR PLATE TO ACCOMMODATE (N) WORK - SEE NEW CONSTRUCTION SHEETS A111-A113
- REMOVE (E) WALL FINISHES. (E) FRAMING TO REMAIN
- REMOVE (E) REAR POPOUT REMOVE (E) ROOF TO ACCOMMODATE (N) WORK
- D19 REMOVE (E) WALL VENT
- D20 REMOVE (E) FIREPLACE AND SURROUND D21 REMOVE (E) ROOF ACCESS HATCH


33-35 ALADDIN TERRACE REMODEL & ADDITION 33-35 ALADDIN TERRACE SAN FRANCISCO, CA 94133



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SITE PERMIT SET REVISION 1

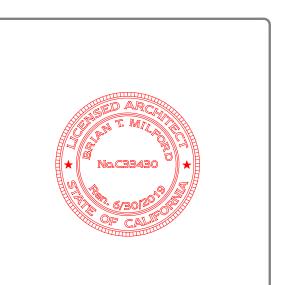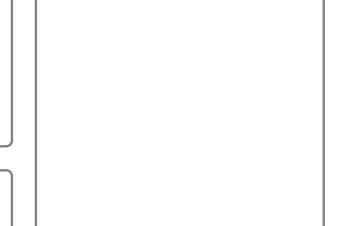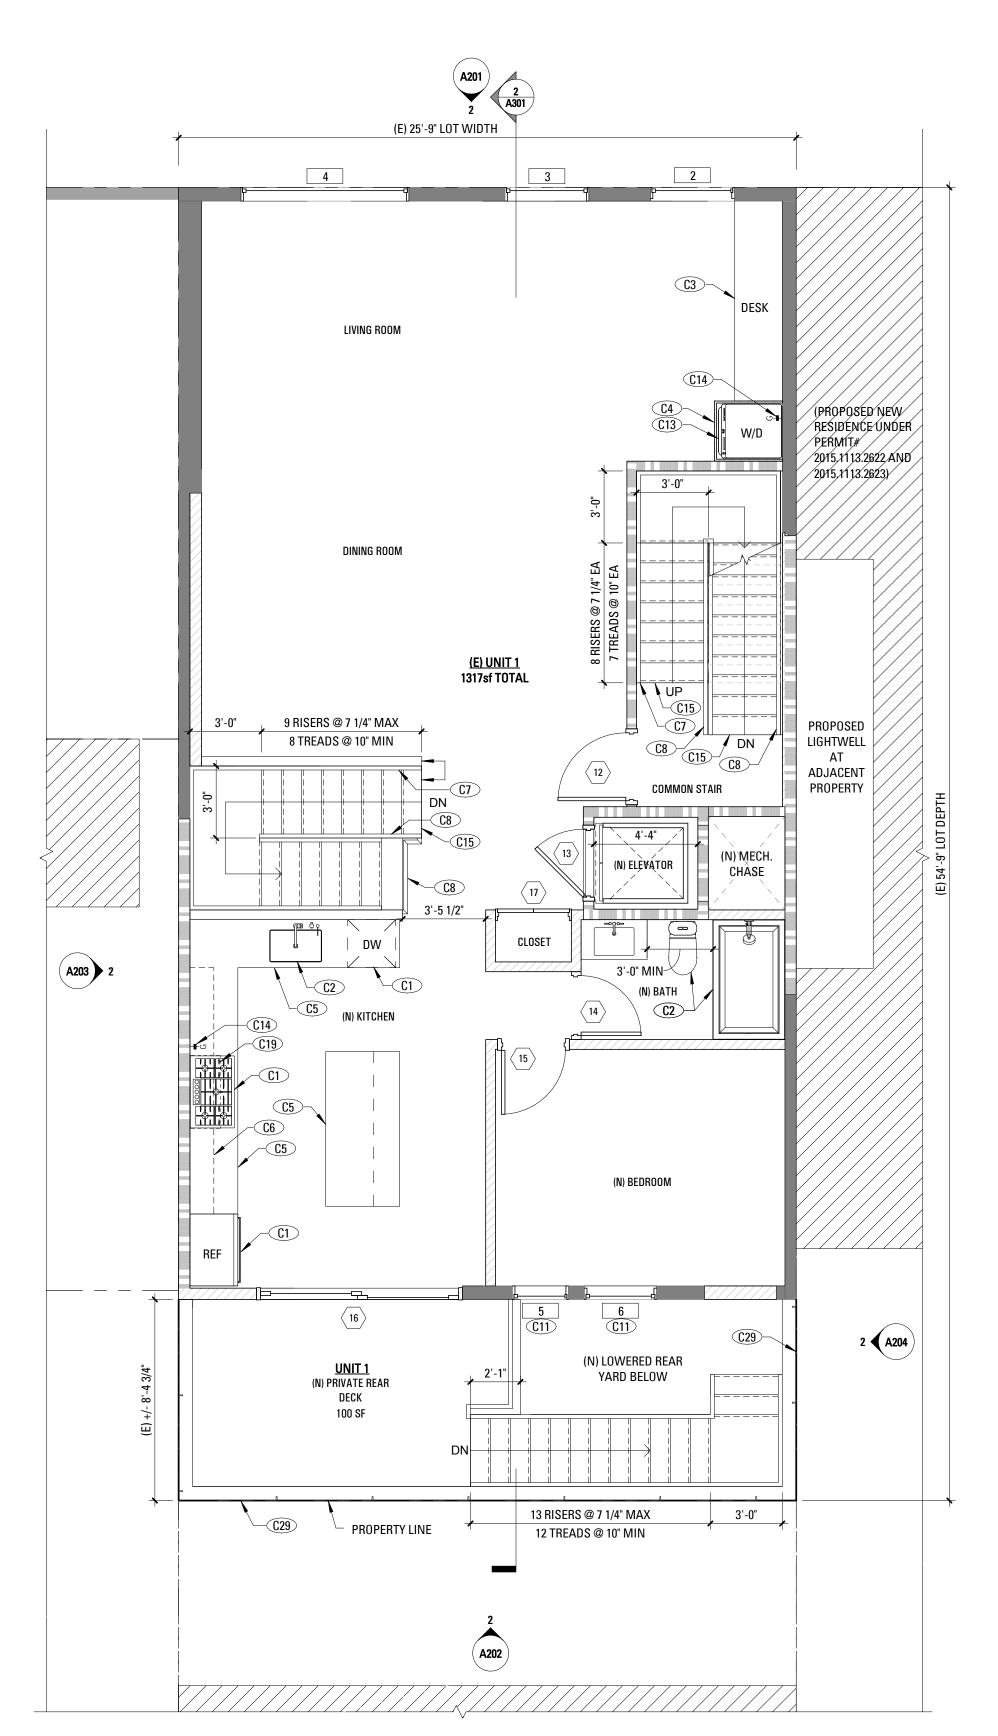
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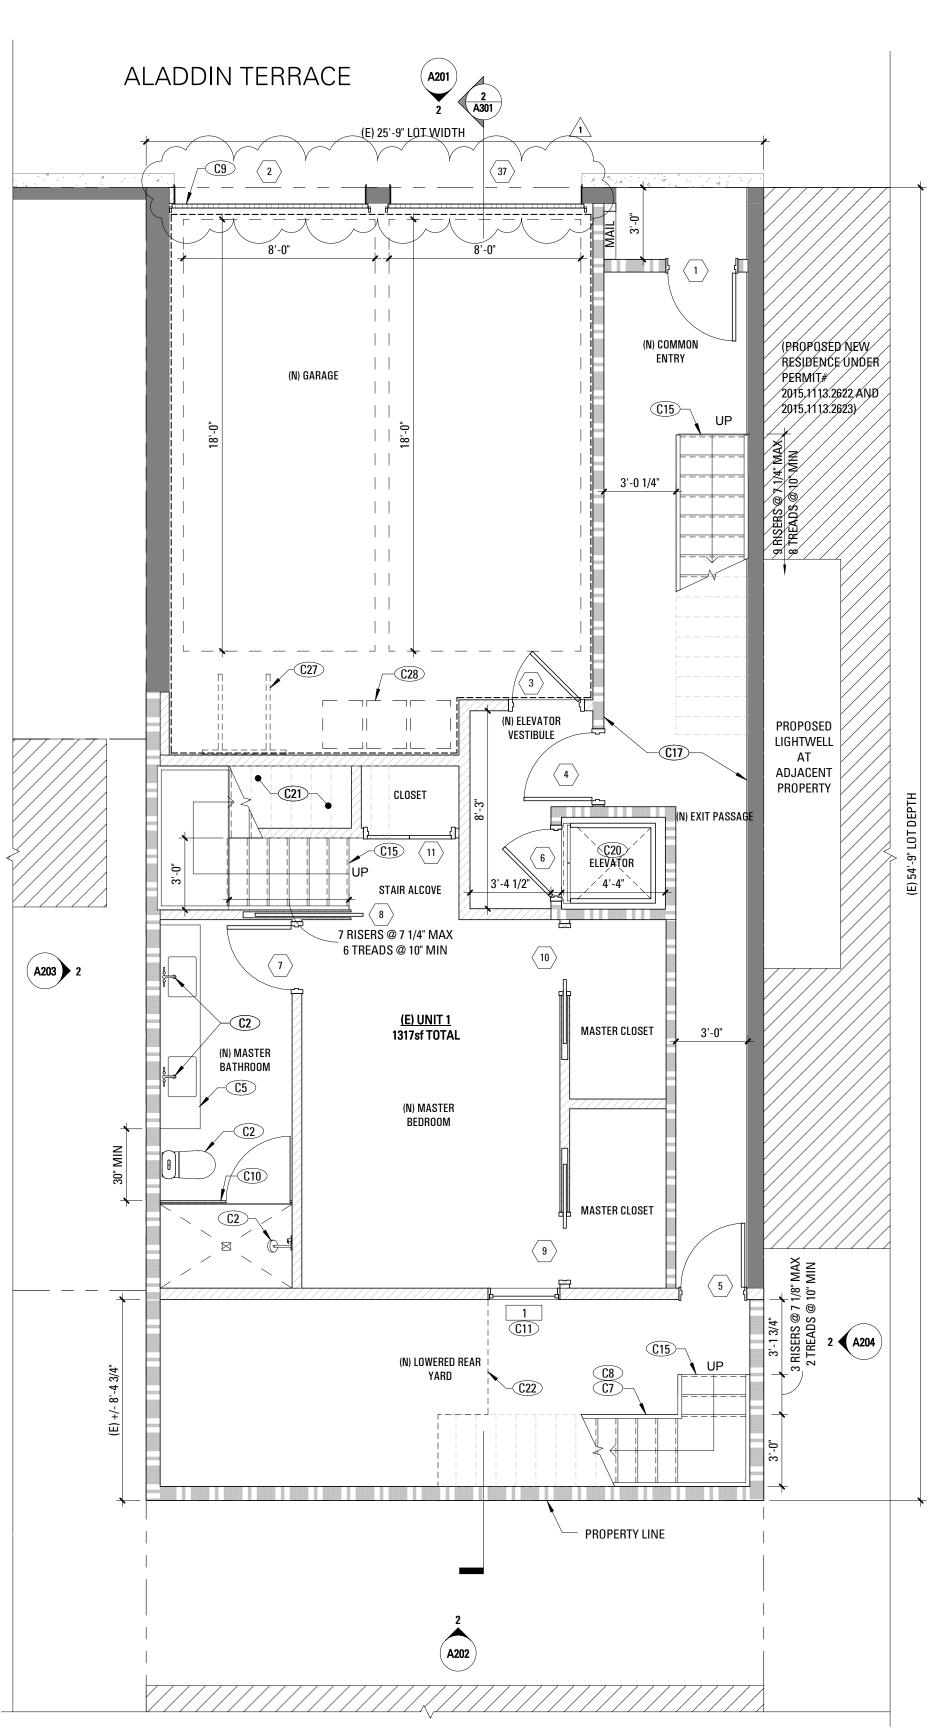
THIRD FLOOR & ROOF EXISTING/DEMO PLANS

> SHEET NUMBER A102

THIRD FLOOR EXISTING/DEMOLITION PLAN

1/4" = 1'.0"





FIRST FLOOR CONSTRUCTION PLAN
1/4" = 1'-0"

CONSTRUCTION PLAN (RES)

GENERAL NOTES

SEE SHEET A004 FOR ACCESSIBLE CLEARANCES & FURTHER INFORMATION ON RECEPTION DESK SEE GENERAL NOTES ON SHEET A002.

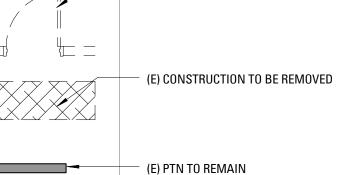
- ALL (N) WALLS TYPE "A" U.O.N. SEE SCHEDULE, A901. ALL DIMENSIONS ARE TO FACE OF FINISH, CENTERLINE OF
- OPENING OR EDGE OF JAMB FRAME, U.O.N.
- ON SHEET A901.
- PROVIDE & INSTALL FLASHING, COUNTERFLASHING, CAP FLASHING, METAL TRIM, OTHER FABRICATED ITEMS AND MISCELLANEOUS SHEET METALWORK AT JUNCTIONS OF A ROOF AND WALL, AT CHIMNEYS, OVER EXPOSED DOORS AND WINDOWS, AT CHANGES OF SIDING MATERIAL IN ROOF VALLEYS OR WHERE REQUIRED TO PROVIDE COMPLETE WATERTIGHT AND WATERPROOF CONSTRUCTION.
- PROVIDE & INSTALL ONE PIECE GSM PAN FLASHING AT ALL NEW WINDOWS, DOORS, AND SKYLIGHTS.
- FLASHING & SHEET METALWORK SHALL BE FABRICATED AND INSTALLED IN ACCORDANCE WITH SHEET METAL & AIR CONDITIONING CONTRACTORS' NATIONAL ASSOCIATION (SMACNA) ARCHITECTURAL SHEET METAL MANUAL. COMPLY WITH MINIMUM THICKNESS OR GAGE REQUIREMENTS AS SPECIFIED IN SMACNA ARCHITECTURAL SHEET METAL MANUAL
- ISOLATE AND PROTECT DISSIMILAR METALS FROM CONTACT WITH EACH OTHER BY APPLYING SPECIFIED ISOLATION MATERIAL TO CONTACT SURFACES. PROTECT SURFACES OF SHEET METAL IN CONTACT WITH CONCRETE, TREATED WOOD, OR ALUMINUM WITH A HEAVY COATING OF BITUMINOUS PAINT AS RECOMMENDED BY MANUFACTURER/FABRICATOR.
- 10 FLASHING & SHEET METALWORK WILL NOT BE MEASURED SEPARATELY FOR PAYMENT BUT WILL BE PAID FOR AS PART OF THE CONTRACT LUMP SUM PRICE FOR ARCHITECTURAL WORK. PROVIDE MINIMUM OF R-19 BATT INSULATION IN EXTERIOR WALLS ADJACENT TO LIVING SPACE.
- W00D.
- 14 ALL DOORS AND WINDOWS NOT TAGGED ARE EXISTING TO
- AND 15" FROM CENTERLINE OF THE TOILET TO EACH SIDE.
- ALL APPLIANCES WITH QUICK-ACTING VALVES, INCLUDING BUT NOT LIMITED TO DISHWASHERS & CLOTHES WASHERS, SHALL
- WATER HEATERS SHALL HAVE SEISMIC STRAPPING AT A POINT WITHIN THE UPPER 1/3 AND THE LOWER 1/3 OF THE WATER HEATER'S VERTICAL DIMENSIONS. AT THE LOWER POINT, A MINIMUM DISTANCE OF FOUR (4) INCHES SHALL BE MAINTAINED ABOVE THE CONTROLS TO THE STRAP. (CPC 507.2).
- KITCHEN RANGES SHALL BE PROVIDED WITH A METAL VENTILATING HOOD. A VERTICAL CLEARANCE OF 24" MINIMUM BETWEEN THE COOKTOP & METAL VENTILATING HOOD SHALL BE MAINTAINED. THE HOOD SHALL BE AS WIDE AS THE RANGE AND CENTERED OVER THE UNIT. THE METAL HOOD SHALL BE 0.0122" MINIMUM THICK (2013 CMC 920.3).
- KITCHEN IS REQUIRED TO HAVE AN EXHAUST FAN DUCTED TO THE OUTSIDE WITH A MINIMUM VENTILATION RATE OF 100 CFM. ALL EXHAUST FAN DUCTING, INCLUDING BUT NOT LIMITED TO TO
- KITCHEN AND BATHROOM EXHAUST FANS, SHALL BE SIZED ACCORDING TO ASHRAE STANDARD 62.2 TABLE 7.1. 23 APPLIANCES IN ATTIC AND UNDER-FLOOR SPACES SHALL BE ACCESSIBLE THROUGH AN OPENING AND PASSAGEWAY AT
- LEAST AS LARGE AS THE LARGEST COMPONENT OF THE APPLIANCE, AND NOT LESS THAN 22 INCHES BY 30 INCHES. (CPC 24 APPLIANCES IN ATTIC AND UNDER-FLOOR SPACES SHALL HAVE
- A SOLID FLOOR PASSAGEWAY OF NOT LESS THAN 24 INCHES AND A WORK PLATFORM OF NOT LESS THAN 30 INCHES BY 30 INCHES IN FRONT OF THE SERVICE SIDE OF THE APPLIANCE. (CPC 508.4.2 & 508.4.3).
- A PERMANENT 120-VOLT RECEPTACLE OUTLET AND A LIGHTING FIXTURE NEAR THE APPLIANCE. (CPC 508.4.4).

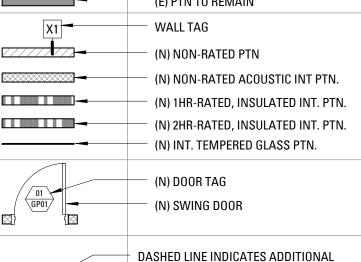
- CONTRACTOR SHALL VERIFY ALL FIELD DIMENSIONS AND NOTIFY ARCHITECT OF ANY DISCREPANCIES BEFORE PROCEEDING. ARCHITECT TO REVIEW ALL CHALK LINES IN FIELD PRIOR TO STUD INSTALLATION.
- DOORS NOT LOCATED BY DIMENSION SHALL BE PLACED 3" OFF JAMB, U.O.N. REFER TO DOOR SCHEDULE FOR TYPES AND SIZES
- AND REPLACEMENT EXTERIOR DOORS. COMPLY WITH ASTM E2112-07, STANDARD PRACTICE FOR INSTALLATION OF EXTERIOR
- WATERPROOFING SHALL OVERLAP FLASHINGS FOR POSITIVE DRAINAGE AT ALL CONDITIONS.
- PROVIDE CEMENT BOARD BACKING IN AREAS TO RECEIVE TILE
- REMAIN U.O.N.
- 15 ALL TOILETS TO HAVE A MINIMUM CLEARANCE OF 24" IN FRONT
- 16 STAIRWAYS SHALL HAVE A MINIMUM HEADROOM CLEARANCE OF 80 INCHES ABOVE THE FRONT EDGE OF THE NOSING.
- HAVE WATER HAMMER ARRESTORS (CPC 609.10).
- ALL EXISTING NON-COMPLIANT AND NEW PLUMBING FIXTURES SHALL COMPLY WITH CALIFORNIA SB-407 (2009).

- 25 APPLIANCES IN ATTIC AND UNDER-FLOOR SPACES SHALL HAVE
- **26** ALL GLASS SHALL BE BIRD SAFE GLAZING PER SAN FRANCISCO STANDARDS FOR BIRD SAFE BUILDINGS.

PLAN LEGEND

(E) CONSTRUCTION TO BE REMOVED





BACKING TO BE MOUNTED. SEE 1/A111 FOR LOCATIONS. PROVIDE BACKING FOR MILLWORK A.R. ALL BACKING TO BE CONCEALED HOSE BIB

GAS SHUTOFF VALVE _ _ _ _ _ _ -ITEMS OVERHEAD AREA NOT IN CONTRACT

WOOD LOCATED NEARER THAN 6" TO EARTH SHALL BE TREATED

KEYNOTES

- (N) APPLIANCES AND EQUIPMENT
- (N) PLUMBING FIXTURES, TYP.
- (N) BUILT-IN CASEWORK (N) FULL HEIGHT BUILT-IN CASEWORK

CONSTRUCTION

- (N) BASE CABINETS AND COUNTERS (N) UPPER CABINETS
- (N) GRIPPABLE HANDRAIL @ 36" ABOVE NOSING; DESIGN SHALL RESIST LINEAR LOAD OF 50 PLF IN ACCORDANCE W/ SECTION 4.5.1
- OF ASCE 7 PER CBC 1607.8.1 (N) GUARDRAIL @ 42" W/ 4" MAX OPENING: DESIGN SHALL RESIST
- LINEAR LOAD OF 50 PLF IN ACCORDANCE W/ SECTION 4.5.1 OF
- ASCE 7 PER CBC 1607.8.1 C9 MINIMUM 200 SQ. INCH LOUVER FOR GARAGE VENTILATION
- C10 (N) TEMPERED GLASS SHOWER ENCLOSURE (N) WINDOW TO BE OPERABLE AND COMPLY W/ EGRESS
- REQUIREMENTS PER CBC 1029 C13 (N) WASHER/DRYER AND HOOK UPS. VENT DRYER TO EXTERIOR
- C14 (N) GAS SHUTOFF (N) CARPENTER-BUILT STAIR; (3) 2X12 WOOD STRINGERS MIN 2/ 3/4" PLYWOOD TREADS & RISERS; P.T. LUMBER AT ALL EXTERIOR
- WALLS AND CEILING OF PASSAGE SHALL BE RATED AND
- CONSTRUCTED PER CBC 707 & 711 (CBC TABLE 721.1(3) 13-1.4) (N) EXHAUST HOOD COMPLIANT WITH CBC 2013, EXTERIOR VENT C20 (N) PASSENGER ELEVATOR
- PROVIDE 5/8" GYPSUM BOARD ON UNDERSIDE OF STAIRS (N) DECK ABOVE C27 (N) DEDICATED VERTICAL BICYCLE RACKS PER SF ZONING
- ADMINISTRATOR BULLETIN NO. 9 C28 LOCATION OF EQUAL ACCESS FOR STORAE, COLLECTION AND LOADING OF RECYCLABLE, COMPOSTABLE AND LAND FILL
- MATERIALS C29 (N) PAINTED WOOD GUARDRAIL

33-35 ALADDIN TERRACE REMODEL & ADDITION 33-35 ALADDIN TERRACE SAN FRANCISCO, CA 94133



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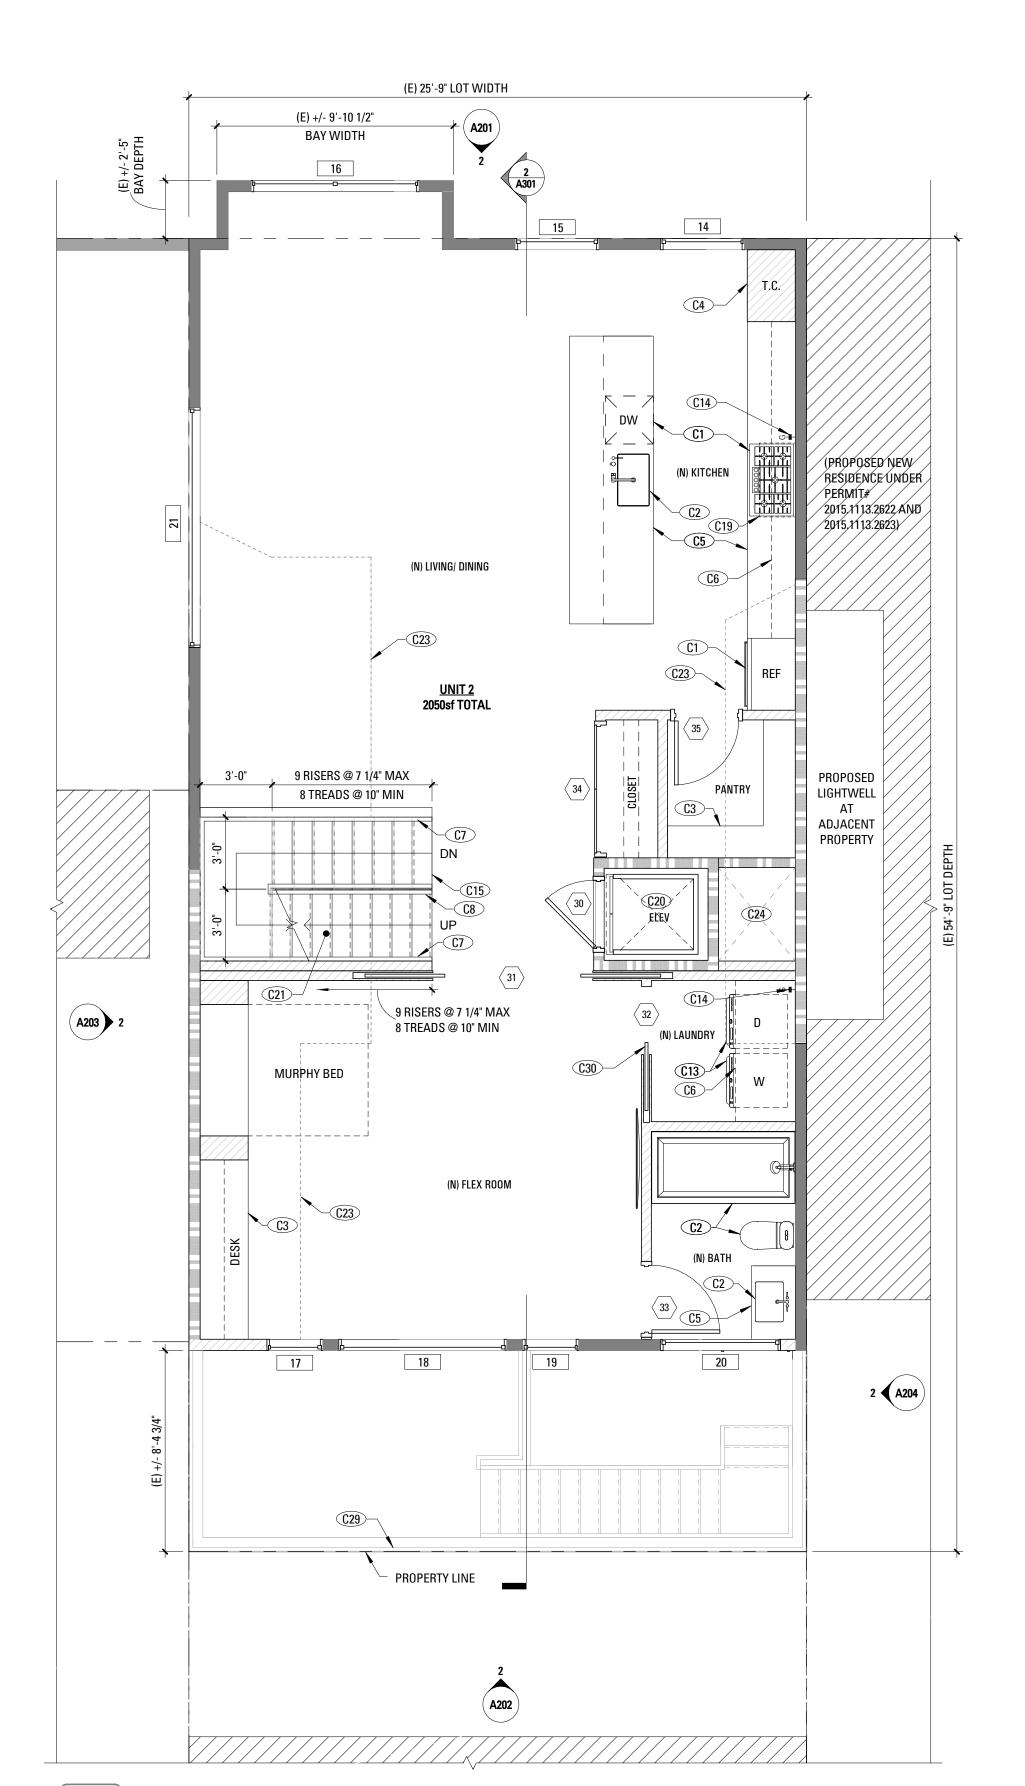



SITE PERMIT SET REVISION 1

AW Drawn By: BE Checked By: 1639.1 Project Number:

1ST & 2ND FLOOR **CONSTRUCTION PLAN**

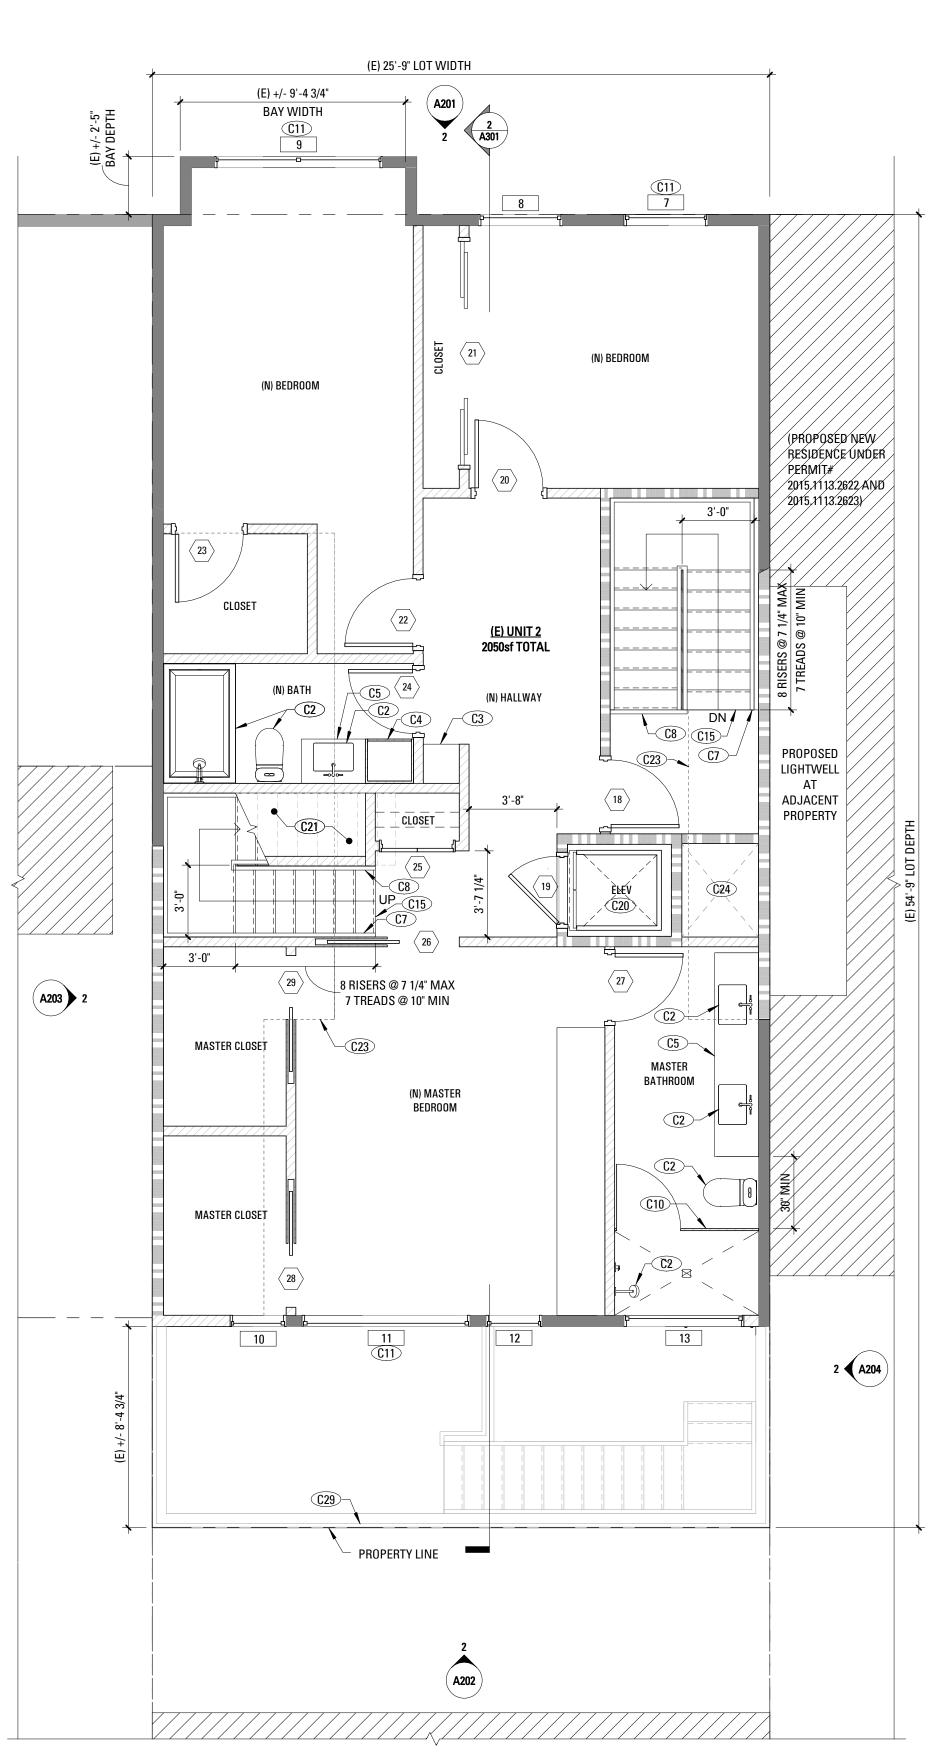SHEET NUMBER





CONSTRUCTION PLAN (RES)

GENERAL NOTES

SEE SHEET A004 FOR ACCESSIBLE CLEARANCES & FURTHER INFORMATION ON RECEPTION DESK
SEE GENERAL NOTES ON SHEET A002.

- ALL (N) WALLS TYPE "A" U.O.N. SEE SCHEDULE, A901. ALL DIMENSIONS ARE TO FACE OF FINISH, CENTERLINE OF
- OPENING OR EDGE OF JAMB FRAME, U.O.N.
 CONTRACTOR SHALL VERIFY ALL FIELD DIMENSIONS AND NOTIFY
 ARCHITECT OF ANY DISCREPANCIES BEFORE PROCEEDING.
 ARCHITECT TO REVIEW ALL CHALK LINES IN FIELD PRIOR TO
 STUD INSTALLATION.
- DOORS NOT LOCATED BY DIMENSION SHALL BE PLACED 3" OFF JAMB, U.O.N. REFER TO DOOR SCHEDULE FOR TYPES AND SIZES ON SHEET A901.
- PROVIDE & INSTALL FLASHING, COUNTERFLASHING, CAP FLASHING, METAL TRIM, OTHER FABRICATED ITEMS AND MISCELLANEOUS SHEET METALWORK AT JUNCTIONS OF A ROOF AND WALL, AT CHIMNEYS, OVER EXPOSED DOORS AND WINDOWS, AT CHANGES OF SIDING MATERIAL IN ROOF VALLEYS OR WHERE REQUIRED TO PROVIDE COMPLETE WATERTIGHT AND WATERPROOF CONSTRUCTION.
- PROVIDE & INSTALL ONE PIECE GSM PAN FLASHING AT ALL NEW AND REPLACEMENT EXTERIOR DOORS. COMPLY WITH ASTM E2112-07, STANDARD PRACTICE FOR INSTALLATION OF EXTERIOR WINDOWS, DOORS, AND SKYLIGHTS.
- WATERPROOFING SHALL OVERLAP FLASHINGS FOR POSITIVE DRAINAGE AT ALL CONDITIONS.
- FLASHING & SHEET METALWORK SHALL BE FABRICATED AND INSTALLED IN ACCORDANCE WITH SHEET METAL & AIR CONDITIONING CONTRACTORS' NATIONAL ASSOCIATION (SMACNA) ARCHITECTURAL SHEET METAL MANUAL. COMPLY WITH MINIMUM THICKNESS OR GAGE REQUIREMENTS AS
- SPECIFIED IN SMACNA ARCHITECTURAL SHEET METAL MANUAL

 ISOLATE AND PROTECT DISSIMILAR METALS FROM CONTACT
 WITH EACH OTHER BY APPLYING SPECIFIED ISOLATION
 MATERIAL TO CONTACT SURFACES. PROTECT SURFACES OF
 SHEET METAL IN CONTACT WITH CONCRETE, TREATED WOOD, OR
 ALUMINUM WITH A HEAVY COATING OF BITUMINOUS PAINT AS
 RECOMMENDED BY MANUFACTURER/FABRICATOR.
- FLASHING & SHEET METALWORK WILL NOT BE MEASURED SEPARATELY FOR PAYMENT BUT WILL BE PAID FOR AS PART OF THE CONTRACT LUMP SUM PRICE FOR ARCHITECTURAL WORK.
 PROVIDE MINIMUM OF R-19 BATT INSULATION IN EXTERIOR
- WALLS ADJACENT TO LIVING SPACE.

 12 PROVIDE CEMENT BOARD BACKING IN AREAS TO RECEIVE TILE
- FINISH.

 WOOD LOCATED NEARER THAN 6" TO EARTH SHALL BE TREATED
- WOOD.

 14 ALL DOORS AND WINDOWS NOT TAGGED ARE EXISTING TO
- REMAIN U.O.N.

 15 ALL TOILETS TO HAVE A MINIMUM CLEARANCE OF 24" IN FRONT
- AND 15" FROM CENTERLINE OF THE TOILET TO EACH SIDE.
- 16 STAIRWAYS SHALL HAVE A MINIMUM HEADROOM CLEARANCE OF 80 INCHES ABOVE THE FRONT EDGE OF THE NOSING.
 17 ALL APPLIANCES WITH QUICK-ACTING VALVES, INCLUDING BUT NOT LIMITED TO DISHWASHERS & CLOTHES WASHERS, SHALL
- HAVE WATER HAMMER ARRESTORS (CPC 609.10).

 18 ALL EXISTING NON-COMPLIANT AND NEW PLUMBING FIXTURES
 SHALL COMPLY WITH CALLEDRNIA SR-407 (2009)
- SHALL COMPLY WITH CALIFORNIA SB-407 (2009).

 19 WATER HEATERS SHALL HAVE SEISMIC STRAPPING AT A POINT WITHIN THE UPPER 1/3 AND THE LOWER 1/3 OF THE WATER HEATER'S VERTICAL DIMENSIONS. AT THE LOWER POINT, A MINIMUM DISTANCE OF FOUR (4) INCHES SHALL BE MAINTAINED
- ABOVE THE CONTROLS TO THE STRAP. (CPC 507.2).

 KITCHEN RANGES SHALL BE PROVIDED WITH A METAL VENTILATING HOOD. A VERTICAL CLEARANCE OF 24" MINIMUM BETWEEN THE COOKTOP & METAL VENTILATING HOOD SHALL BE MAINTAINED. THE HOOD SHALL BE AS WIDE AS THE RANGE AND CENTERED OVER THE UNIT. THE METAL HOOD SHALL BE 0.0122" MINIMUM THICK (2013 CMC 920.3).
- KITCHEN IS REQUIRED TO HAVE AN EXHAUST FAN DUCTED TO THE OUTSIDE WITH A MINIMUM VENTILATION RATE OF 100 CFM.
 ALL EXHAUST FAN DUCTING, INCLUDING BUT NOT LIMITED TO TO
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 23 APPLIANCES IN ATTIC AND UNDER-FLOOR SPACES SHALL BE ACCESSIBLE THROUGH AN OPENING AND PASSAGEWAY AT LEAST AS LARGE AS THE LARGEST COMPONENT OF THE
- APPLIANCE, AND NOT LESS THAN 22 INCHES BY 30 INCHES. (CPC 508.4).

 4 APPLIANCES IN ATTIC AND UNDER-FLOOR SPACES SHALL HAVE A SOLID FLOOR PASSAGEWAY OF NOT LESS THAN 24 INCHES AND A WORK PLATFORM OF NOT LESS THAN 30 INCHES BY 30 INCHES IN EPONT OF THE SERVICE SIDE OF THE APPLIANCE. (CPC
- AND A WORK PLATFORM OF NOT LESS THAN 30 INCHES BY 30 INCHES IN FRONT OF THE SERVICE SIDE OF THE APPLIANCE. (CPC 508.4.2 & 508.4.3).

 25 APPLIANCES IN ATTIC AND UNDER-FLOOR SPACES SHALL HAVE
- FIXTURE NEAR THE APPLIANCE. (CPC 508.4.4).

 26 ALL GLASS SHALL BE BIRD SAFE GLAZING PER SAN FRANCISCO STANDARDS FOR BIRD SAFE BUILDINGS.

A PERMANENT 120-VOLT RECEPTACLE OUTLET AND A LIGHTING

PLAN LEGEND (E) CONSTRUCTION TO BE REMOVED (E) CONSTRUCTION TO BE REMOVED

(E) PTN TO REMAIN

(N) NON-RATED PTN

(N) NON-RATED ACOUSTIC INT PTN.

(N) 1HR-RATED, INSULATED INT. PTN.

(N) 2HR-RATED, INSULATED INT. PTN.

(N) INT. TEMPERED GLASS PTN.

DASHED LINE INDICATES ADDITIONAL

BACKING TO BE MOUNTED. SEE 1/A111

MILLWORK A.R. ALL BACKING TO BE

FOR LOCATIONS. PROVIDE BACKING FOR

WALL TAG

(N) DOOR TAG

CONCEALED

HOSE BIB

GAS SHUTOFF VALVE

ITEMS OVERHEAD

AREA NOT IN CONTRACT.

(N) GRIPPABLE HANDRAIL @ 36" ABOVE NOSING; DESIGN SHALL

RESIST LINEAR LOAD OF 50 PLF IN ACCORDANCE W/ SECTION 4.5.1

(N) GUARDRAIL @ 42" W/ 4" MAX OPENING; DESIGN SHALL RESIST

LINEAR LOAD OF 50 PLF IN ACCORDANCE W/ SECTION 4.5.1 OF

(N) WINDOW TO BE OPERABLE AND COMPLY W/ EGRESS

C13 (N) WASHER/DRYER AND HOOK UPS. VENT DRYER TO EXTERIOR

(N) CARPENTER-BUILT STAIR; (3) 2X12 WOOD STRINGERS MIN 2/

(N) EXHAUST HOOD COMPLIANT WITH CBC 2013, EXTERIOR VENT

C21 PROVIDE 5/8" GYPSUM BOARD ON UNDERSIDE OF STAIRS

C30 MINIMUM 100 SQ. IN. LOUVER FOR MECHANICAL VENTILATION

3/4" PLYWOOD TREADS & RISERS; P.T. LUMBER AT ALL EXTERIOR

(N) SWING DOOR

CONSTRUCTION

(N) APPLIANCES AND EQUIPMENT

(N) FULL HEIGHT BUILT-IN CASEWORK

(N) BASE CABINETS AND COUNTERS

C10 (N) TEMPERED GLASS SHOWER ENCLOSURE

REQUIREMENTS PER CBC 1029

(N) PLUMBING FIXTURES, TYP.

(N) BUILT-IN CASEWORK

(N) UPPER CABINETS

OF ASCE 7 PER CBC 1607.8.1

ASCE 7 PER CBC 1607.8.1

C14 (N) GAS SHUTOFF

C23 (N) FLOOR INFILL

C20 (N) PASSENGER ELEVATOR

C24 (N) MECHANICAL SPACE

C29 (N) PAINTED WOOD GUARDRAIL

KEYNOTES

33-35 ALADDIN TERRACE SAN FRANCISCO, CA 94133

33-35 ALADDIN

TERRACE


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ADDITION




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SITE PERMIT SET REVISION 1

Drawn By: AW
Checked By: BE
Project Number: 1639.1

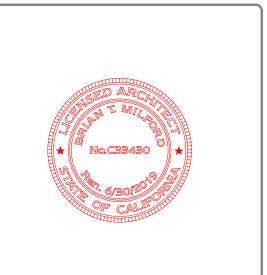3RD & 4TH FLOOR CONSTRUCTION PLANS


A112

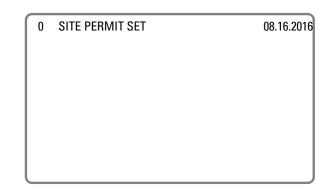SHEET NUMBER

2 FOURTH FLOOR CONSTRUCTION PLAN

1/4" = 1'.0"

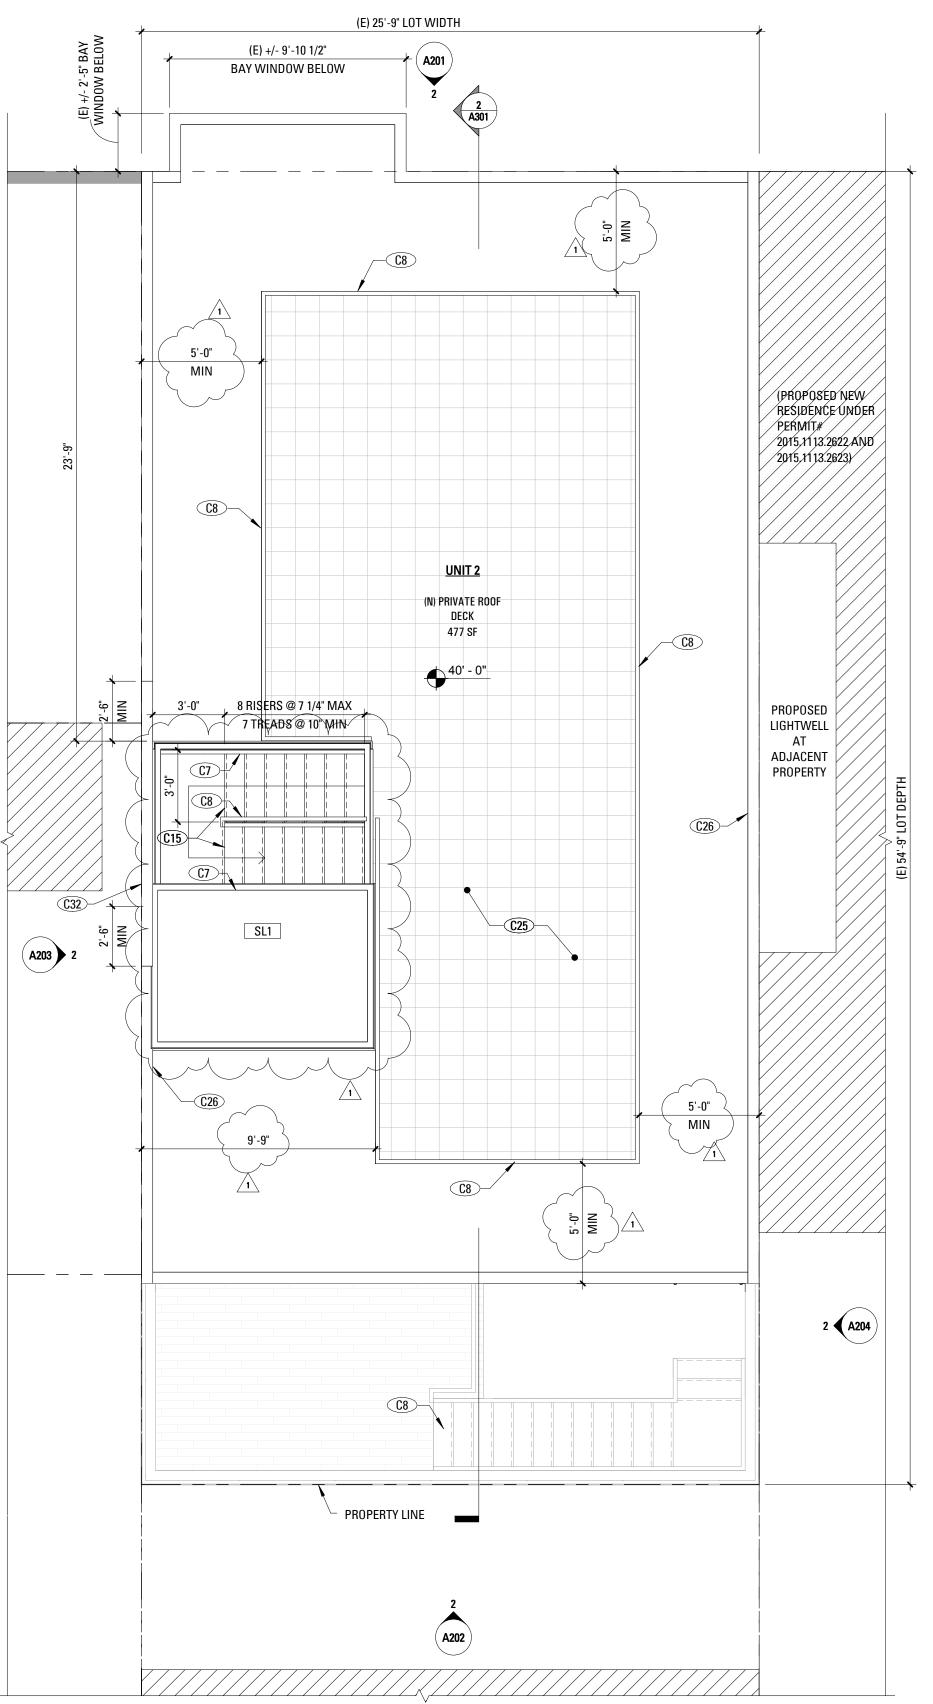1 THIRD FLOOR CONSTRUCTION PLAN




CONSTRUCTION PLAN (RES) GENERAL NOTES


SEE SHEET A004 FOR ACCESSIBLE CLEARANCES & FURTHER INFORMATION ON RECEPTION DESK SEE GENERAL NOTES ON SHEET A002.

STUD INSTALLATION.

- ALL (N) WALLS TYPE "A" U.O.N. SEE SCHEDULE, A901. ALL DIMENSIONS ARE TO FACE OF FINISH, CENTERLINE OF
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- PROVIDE & INSTALL FLASHING, COUNTERFLASHING, CAP FLASHING, METAL TRIM, OTHER FABRICATED ITEMS AND MISCELLANEOUS SHEET METALWORK AT JUNCTIONS OF A ROOF AND WALL, AT CHIMNEYS, OVER EXPOSED DOORS AND WINDOWS, AT CHANGES OF SIDING MATERIAL IN ROOF VALLEYS OR WHERE REQUIRED TO PROVIDE COMPLETE WATERTIGHT AND WATERPROOF CONSTRUCTION.
- PROVIDE & INSTALL ONE PIECE GSM PAN FLASHING AT ALL NEW AND REPLACEMENT EXTERIOR DOORS. COMPLY WITH ASTM E2112-07, STANDARD PRACTICE FOR INSTALLATION OF EXTERIOR WINDOWS, DOORS, AND SKYLIGHTS.
- WATERPROOFING SHALL OVERLAP FLASHINGS FOR POSITIVE DRAINAGE AT ALL CONDITIONS.
- FLASHING & SHEET METALWORK SHALL BE FABRICATED AND INSTALLED IN ACCORDANCE WITH SHEET METAL & AIR CONDITIONING CONTRACTORS' NATIONAL ASSOCIATION (SMACNA) ARCHITECTURAL SHEET METAL MANUAL. COMPLY WITH MINIMUM THICKNESS OR GAGE REQUIREMENTS AS SPECIFIED IN SMACNA ARCHITECTURAL SHEET METAL MANUAL
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- W00D.
- REMAIN U.O.N.
- AND 15" FROM CENTERLINE OF THE TOILET TO EACH SIDE.
- 16 STAIRWAYS SHALL HAVE A MINIMUM HEADROOM CLEARANCE OF 80 INCHES ABOVE THE FRONT EDGE OF THE NOSING.
- NOT LIMITED TO DISHWASHERS & CLOTHES WASHERS, SHALL HAVE WATER HAMMER ARRESTORS (CPC 609.10).
- SHALL COMPLY WITH CALIFORNIA SB-407 (2009).
- WATER HEATERS SHALL HAVE SEISMIC STRAPPING AT A POINT WITHIN THE UPPER 1/3 AND THE LOWER 1/3 OF THE WATER HEATER'S VERTICAL DIMENSIONS. AT THE LOWER POINT, A MINIMUM DISTANCE OF FOUR (4) INCHES SHALL BE MAINTAINED ABOVE THE CONTROLS TO THE STRAP. (CPC 507.2).
- **20** KITCHEN RANGES SHALL BE PROVIDED WITH A METAL VENTILATING HOOD. A VERTICAL CLEARANCE OF 24" MINIMUM BETWEEN THE COOKTOP & METAL VENTILATING HOOD SHALL BE MAINTAINED. THE HOOD SHALL BE AS WIDE AS THE RANGE AND CENTERED OVER THE UNIT. THE METAL HOOD SHALL BE 0.0122" MINIMUM THICK (2013 CMC 920.3).
- KITCHEN AND BATHROOM EXHAUST FANS, SHALL BE SIZED
- ACCORDING TO ASHRAE STANDARD 62.2 TABLE 7.1. ACCESSIBLE THROUGH AN OPENING AND PASSAGEWAY AT LEAST AS LARGE AS THE LARGEST COMPONENT OF THE APPLIANCE, AND NOT LESS THAN 22 INCHES BY 30 INCHES. (CPC
- A SOLID FLOOR PASSAGEWAY OF NOT LESS THAN 24 INCHES AND A WORK PLATFORM OF NOT LESS THAN 30 INCHES BY 30
- 25 APPLIANCES IN ATTIC AND UNDER-FLOOR SPACES SHALL HAVE A PERMANENT 120-VOLT RECEPTACLE OUTLET AND A LIGHTING FIXTURE NEAR THE APPLIANCE. (CPC 508.4.4).
- **26** ALL GLASS SHALL BE BIRD SAFE GLAZING PER SAN FRANCISCO STANDARDS FOR BIRD SAFE BUILDINGS.

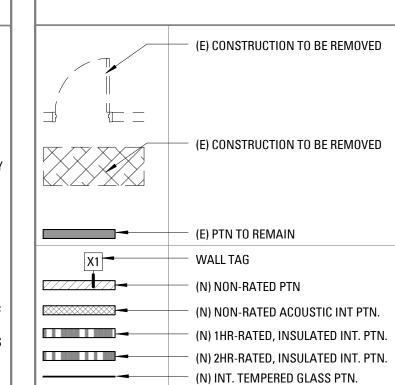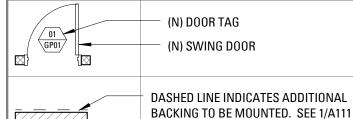PLAN LEGEND





CONCEALED

AREA NOT IN CONTRACT.

C7 (N) GRIPPABLE HANDRAIL @ 36" ABOVE NOSING; DESIGN SHALL

RESIST LINEAR LOAD OF 50 PLF IN ACCORDANCE W/ SECTION 4.5.1

(N) GUARDRAIL @ 42" W/ 4" MAX OPENING; DESIGN SHALL RESIST

LINEAR LOAD OF 50 PLF IN ACCORDANCE W/ SECTION 4.5.1 OF

(N) CARPENTER-BUILT STAIR; (3) 2X12 WOOD STRINGERS MIN 2/

3/4" PLYWOOD TREADS & RISERS; P.T. LUMBER AT ALL EXTERIOR

NONCOMBUSTABLE PER SFBC SECTIONS 104A.2.8 AND 1509.6

C25 (N) DECK PAVERS ON ADJUSTABLE PEDASTALS - PAVERS TO BE

C26 (N) RATED PARAPETS @ 42" ABOVE FINISHED DECK

C32 (N) 1-HOUR FIRE-RATED PARAPET. MINIMUM 30" A.F.R.

FOR LOCATIONS. PROVIDE BACKING FOR

MILLWORK A.R. ALL BACKING TO BE

HOSE BIB GAS SHUTOFF VALVE

_ _ _ _ _ _ _ ITEMS OVERHEAD

CONSTRUCTION

OF ASCE 7 PER CBC 1607.8.1

ASCE 7 PER CBC 1607.8.1

KEYNOTES

CONDITIONS

12 PROVIDE CEMENT BOARD BACKING IN AREAS TO RECEIVE TILE

- 13 WOOD LOCATED NEARER THAN 6" TO EARTH SHALL BE TREATED
- 14 ALL DOORS AND WINDOWS NOT TAGGED ARE EXISTING TO
- 15 ALL TOILETS TO HAVE A MINIMUM CLEARANCE OF 24" IN FRONT
- ALL APPLIANCES WITH QUICK-ACTING VALVES, INCLUDING BUT
- ALL EXISTING NON-COMPLIANT AND NEW PLUMBING FIXTURES

- KITCHEN IS REQUIRED TO HAVE AN EXHAUST FAN DUCTED TO THE OUTSIDE WITH A MINIMUM VENTILATION RATE OF 100 CFM. ALL EXHAUST FAN DUCTING, INCLUDING BUT NOT LIMITED TO TO
- 23 APPLIANCES IN ATTIC AND UNDER-FLOOR SPACES SHALL BE
- **24** APPLIANCES IN ATTIC AND UNDER-FLOOR SPACES SHALL HAVE INCHES IN FRONT OF THE SERVICE SIDE OF THE APPLIANCE. (CPC
- 508.4.2 & 508.4.3).

MARTINKOVIC MILFORD ARCHITECTS 101 Montgomery Street Suite 650 San Francisco, CA 94104

33-35 ALADDIN

TERRACE

REMODEL &


ADDITION

33-35 ALADDIN TERRACE

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SITE PERMIT SET REVISION 1

AW Drawn By: BE Checked By: 1639.1 Project Number:

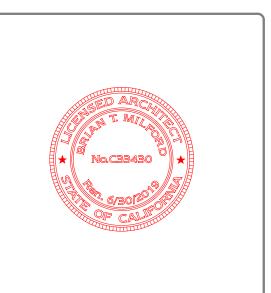ROOF CONSTRUCTION PLAN

A113

SHEET NUMBER

ROOF CONSTRUCTION PLAN



EXTERIOR ELEVATION **33-35 ALADDIN TERRACE** KEYNOTES **REMODEL &** (D) (E) DOOR OR WINDOW TO REMAIN

> 33-35 ALADDIN TERRACE SAN FRANCISCO, CA 94133

ADDITION



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SITE PERMIT SET REVISION 1 AW Drawn By: BE Checked By: 1639.1 Project Number:

EXTERIOR ELEVATIONS

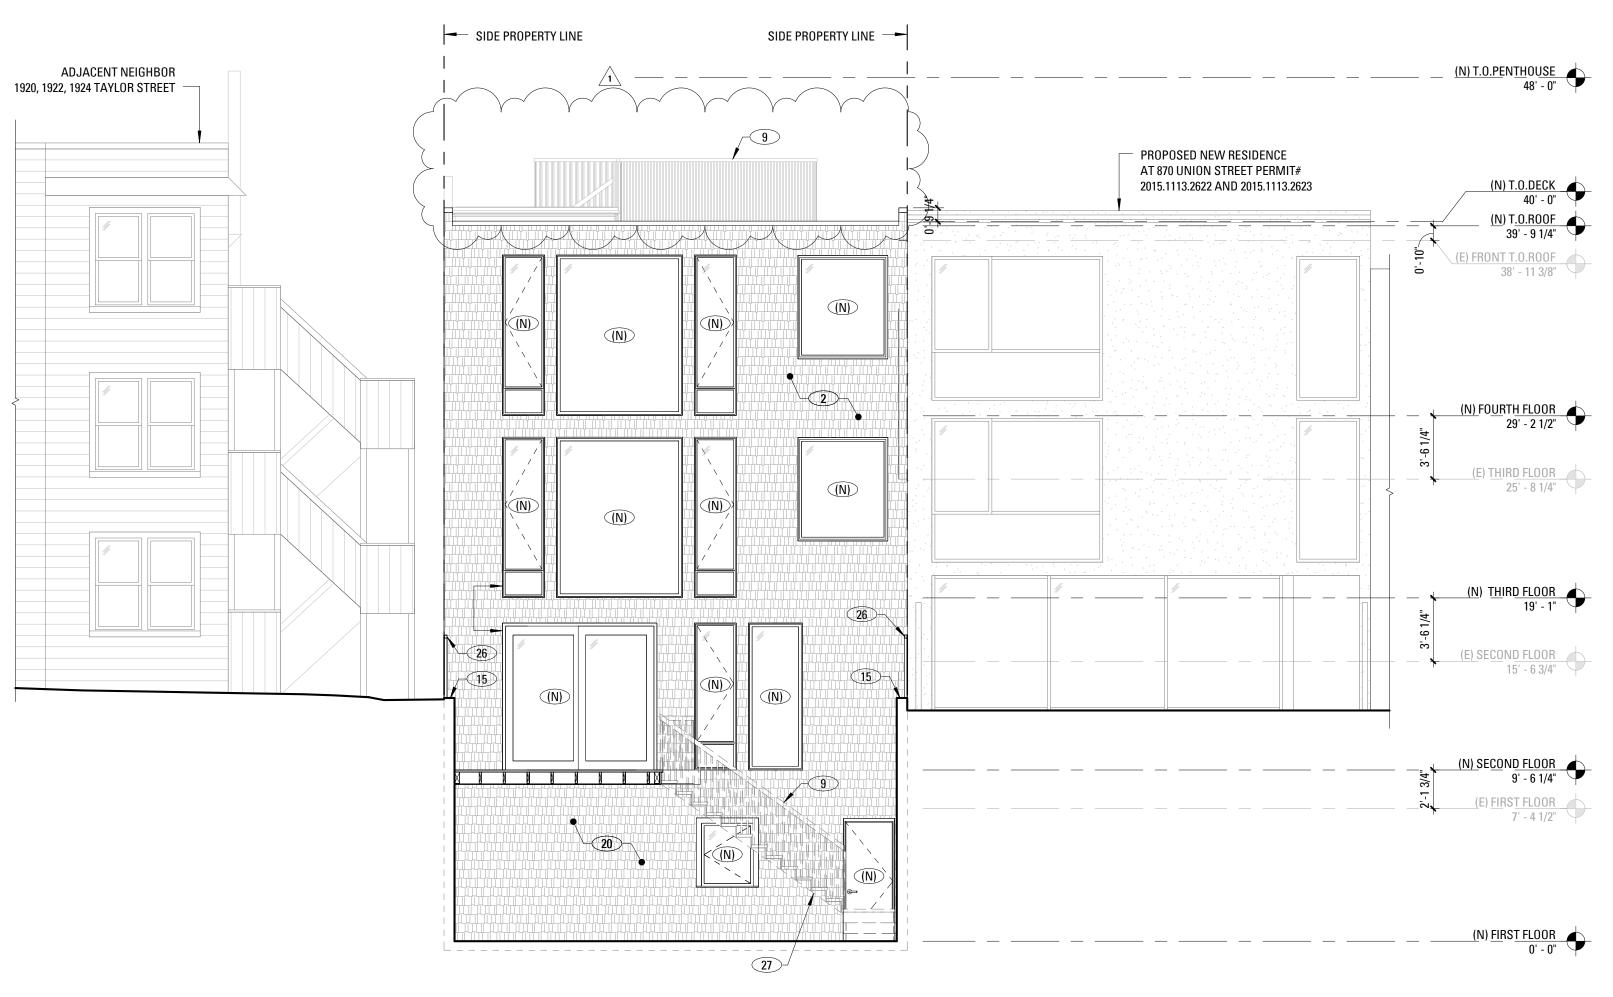
SHEET NUMBER

A201

2 PROPOSED FRONT ELEVATION (SOUTH)


3/16" - 1'-0"





PROPOSED REAR ELEVATION (NORTH)

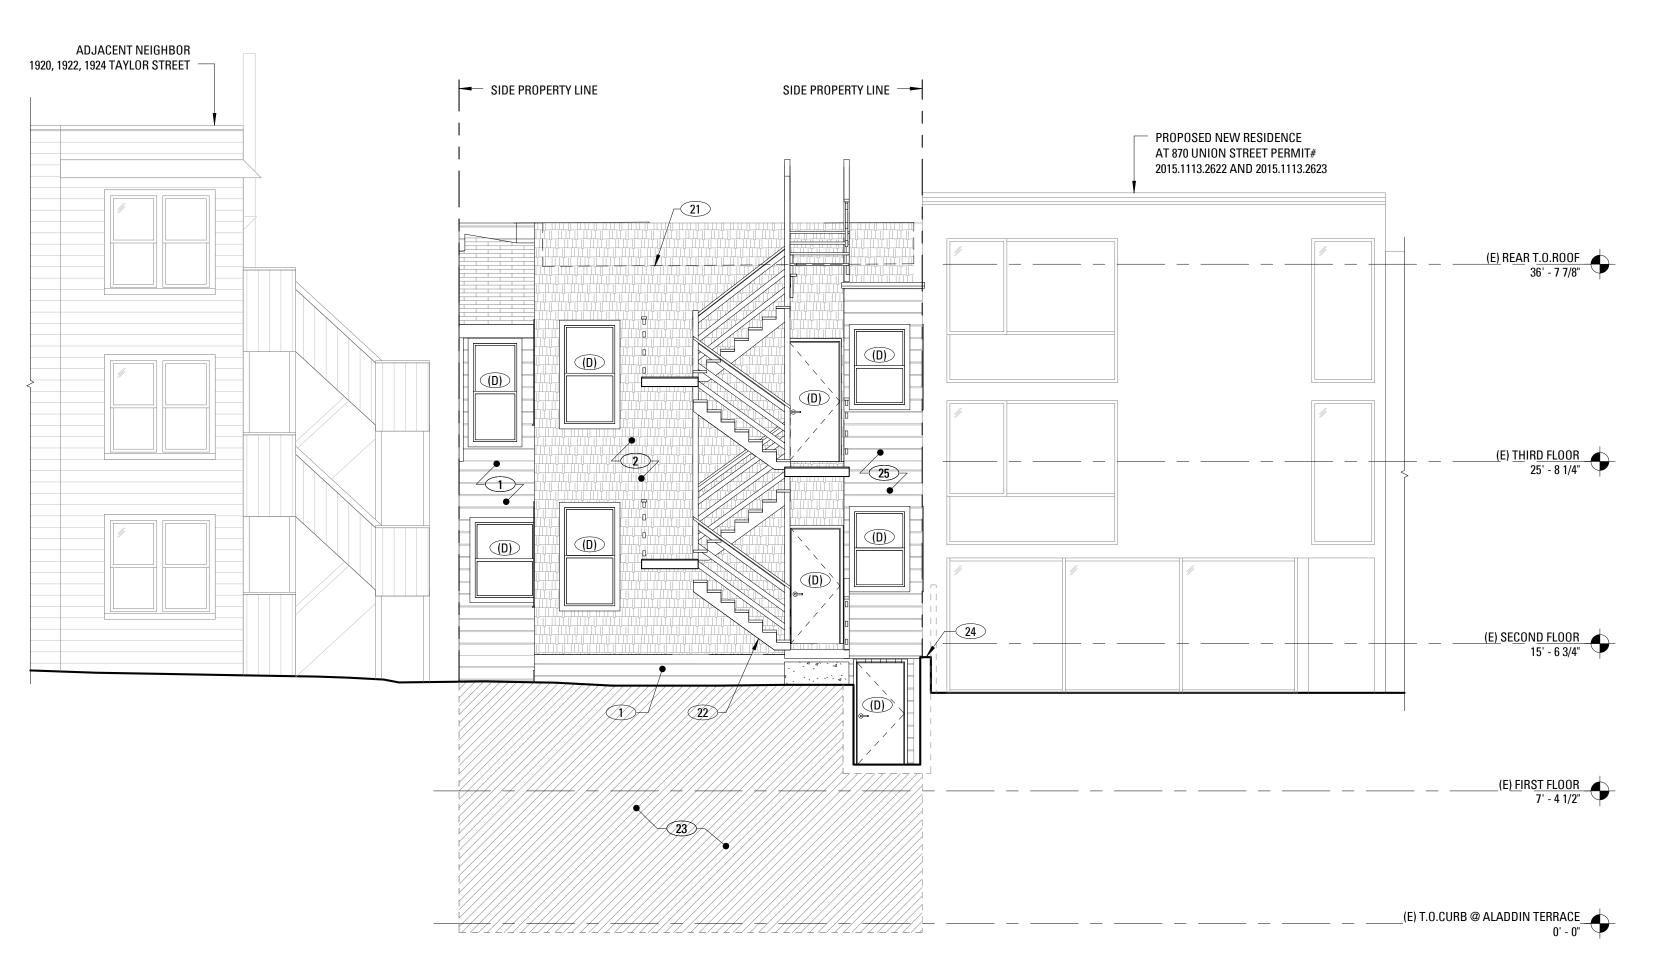3/16" = 1'.0"



EXTERIOR ELEVATION

KEYNOTES

(D) (E) DOOR OR WINDOW TO REMAIN

(D) (E) DOOR OR WINDOW TO REMAIN
(N) (N) DOOR OR WINDOW, SEE SCHEDULE A901 AND A902

1 (E) PAINTED WOOD SIDING TO BE REMOVED

(E) PAINTED WOOD SIDING TO BE REMOVED

(E) PAINTED WOOD SHINGLE SIDING TO BE REPLACED IN KIND

(N) PAINTED METAL GUARDRAIL

15 (N) CONCRETE RETAINING WALL
20 (N) PAINTED WOOD SHINGLE SIDING

21 ROOF LINE BEYOND
22 (E) WOOD STAIRS TO BE REMOVED
23 AREA OF REAR YARD TO BE EXCAVATED TO ACCOMM

AREA OF REAR YARD TO BE EXCAVATED TO ACCOMMODATE (N)
WORK

24 (E) LOW BRICK WALL TO BE REMOVED
25 (E) BAY TO BE REMOVED
26 (N) PAINTED WOOD GUARDRAIL

27 (N) CARPENTER-BUILT STAIR; (3) 2X12 WOOD STRINGERS MIN 2/3/4" PLYWOOD TREADS & RISERS; P.T. LUMBER AT ALL EXTERIOR CONDITIONS

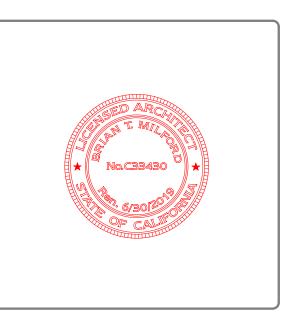
33-35 ALADDIN TERRACE REMODEL & ADDITION

33-35 ALADDIN TERRACE SAN FRANCISCO, CA 94133



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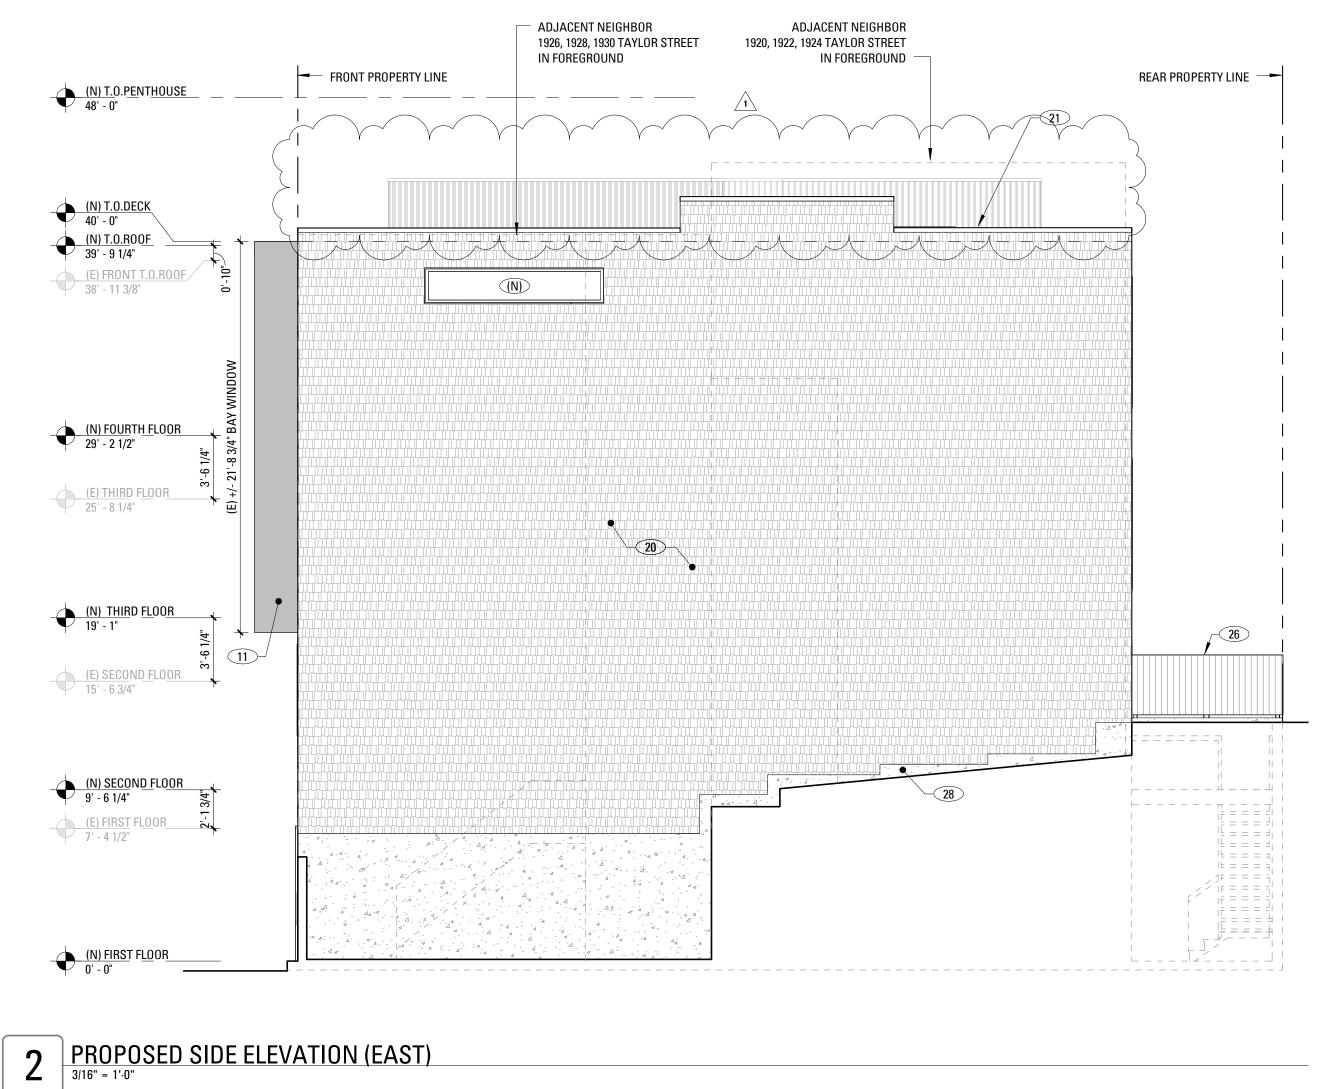






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EXTERIOR E	ELEVATIONS
	ELEVATIONS NUMBER



— ADJACENT NEIGHBOR 1926, 1928, 1930 TAYLOR STREET IN FOREGROUND

FRONT PROPERTY LINE

ADJACENT NEIGHBOR

IN FOREGROUND

1920, 1922, 1924 TAYLOR STREET

PROPOSED NEW RESIDENCE
AT 870 UNION STREET PERMIT#
2015.1113.2622 AND 2015.1113.2623 IN
BACKGROUND

REAR PROPERTY LINE -

(E) <u>REAR T.O.ROOF</u> 36' - 7 7/8"

EXTERIOR ELEVATION KEYNOTES (D) (E) DOOR OR WINDOW TO REMAIN (N) DOOR OR WINDOW, SEE SCHEDULE A901 AND A902 (E) PAINTED WOOD SIDING TO BE REMOVED (E) PAINTED WOOD SHINGLE SIDING TO BE REPLACED IN KIND (E) CONCRETE FINISH TO REMAIN (N) PAINTED METAL FINISH PORTION OF (E) BAY WINDOW TO BE REMOVED TO ACCOMMODATE (N) CONSTRUCTION (N) PAINTED WOOD SHINGLE SIDING ROOF LINE BEYOND (E) WOOD STAIRS TO BE REMOVED AREA OF REAR YARD TO BE EXCAVATED TO ACCOMMODATE (N) WORK (E) BAY TO BE REMOVED 26 (N) PAINTED WOOD GUARDRAIL 28 (N) STEPPED CONCRETE FOUNDATION

33-35 ALADDIN TERRACE REMODEL & ADDITION

SED IN KIND


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08.16.2016
08.22.2017

SITE PERMIT SET REVISION 1

Drawn By:	AW
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Project Number:	1639.1

EXTERIOR ELEVATIONS

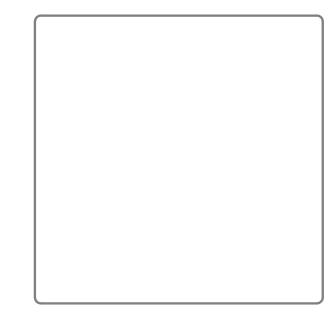A203

1 EXISTING SIDE ELEVATION (EAST)
3/16" = 1'-0"

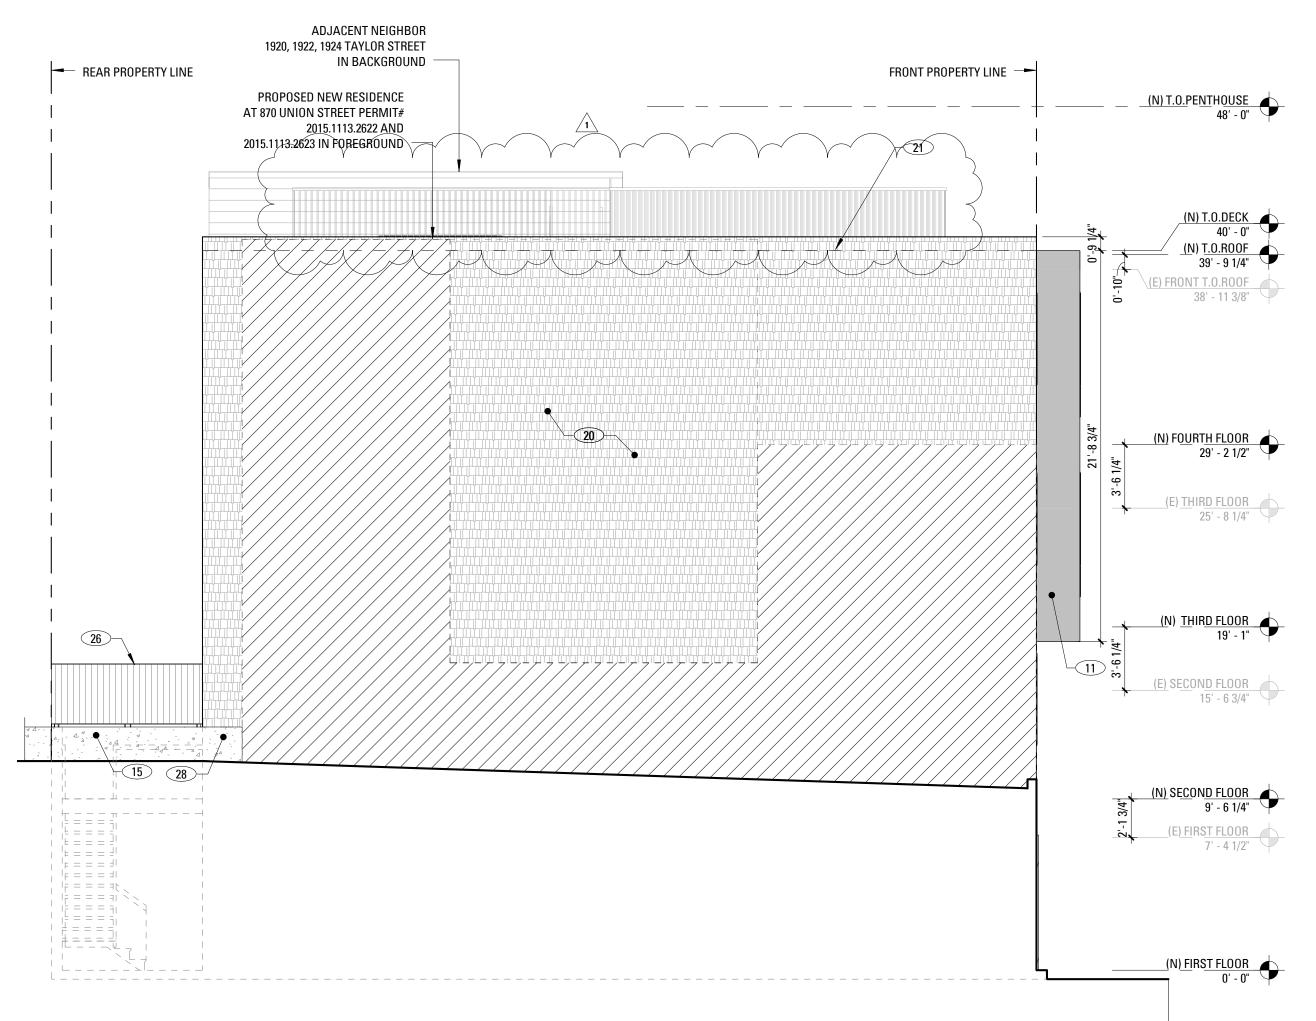
13

(E) FRONT_T.0.ROOF 38' - 11 3/8"

(E) THIRD FLOOR 25' - 8 1/4"


(E) SECOND FLOOR 2

(E) FIRST FLOOR 7' - 4 1/2"



PROPOSED SIDE ELEVATION (WEST)

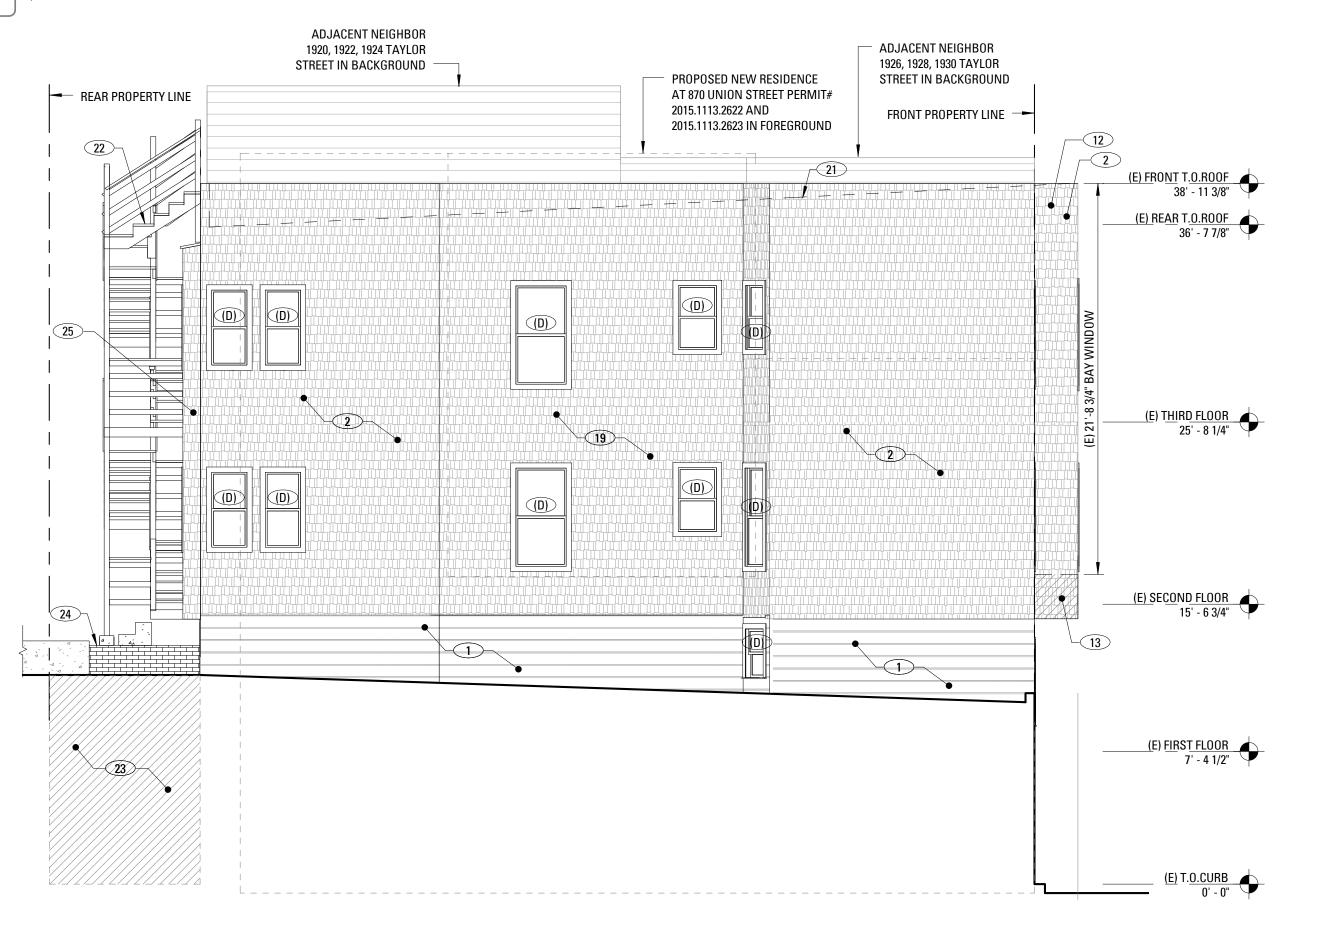3/16" = 1'.0"



EXISTING SIDE ELEVATION (WEST)

EXTERIOR ELEVATION KEYNOTES (D) (E) DOOR OR WINDOW TO REMAIN (E) PAINTED WOOD SIDING TO BE REMOVED (E) PAINTED WOOD SHINGLE SIDING TO BE REPLACED IN KIND (N) PAINTED METAL FINISH (E) BAY TO REMAIN PORTION OF (E) BAY WINDOW TO BE REMOVED TO ACCOMMODATE (N) CONSTRUCTION (N) CONCRETE RETAINING WALL (E) PAINTED WOOD SHINGLE SIDING TO BE REMOVED (N) PAINTED WOOD SHINGLE SIDING ROOF LINE BEYOND (E) WOOD STAIRS TO BE REMOVED AREA OF REAR YARD TO BE EXCAVATED TO ACCOMMODATE (N) (E) LOW BRICK WALL TO BE REMOVED

(E) BAY TO BE REMOVED
(N) PAINTED WOOD GUARDRAIL
(N) STEPPED CONCRETE FOUNDATION

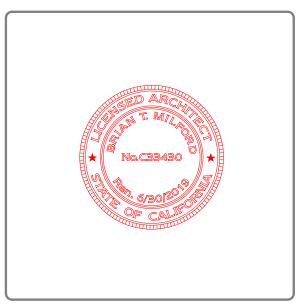
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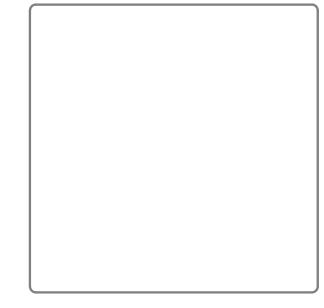
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Project Number: 1639.1

EXTERIOR ELEVATIONS

SHEET NUMBER



PROPOSED BUILDING SECTION

3/16" = 1'-0"



1 EXISTING BUILDING SECTION
3/16" = 1'-0"

EXCAVATION AREA

FIRST FLOOR 25'-9 LOT WIDTH x 498 SQ.FT = 12,823.5 CU.FT
12,823.5 CU.FT x 1 CU.YD/27 CU.FT= 474.9 CU.YD


33-35 ALADDIN TERRACE REMODEL & ADDITION


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0 SITE PERMIT SET	08.16.201

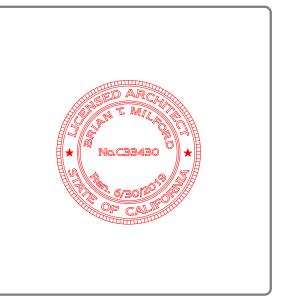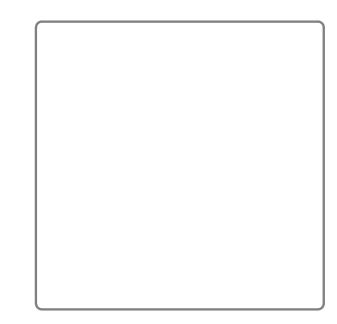SITE PERMIT SET REVISION 1				
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Checked By:	BE			
Project Number:	1639.1			
BUILDING SECTIONS				
SHEET NUMBER				
A301				