


Julia Laue - Principal Architect/Division Manager
 30 Van Ness Avenue Suite 4100
 San Francisco, CA (415) 557-4700
 94102-6028 Fax (415) 5574701

Project _____

**LOMBARD PARKING GARAGE
 IMPROVEMENTS**


2055 LOMBARD STREET
 SAN FRANCISCO
 CALIFORNIA 94133

Consultant _____

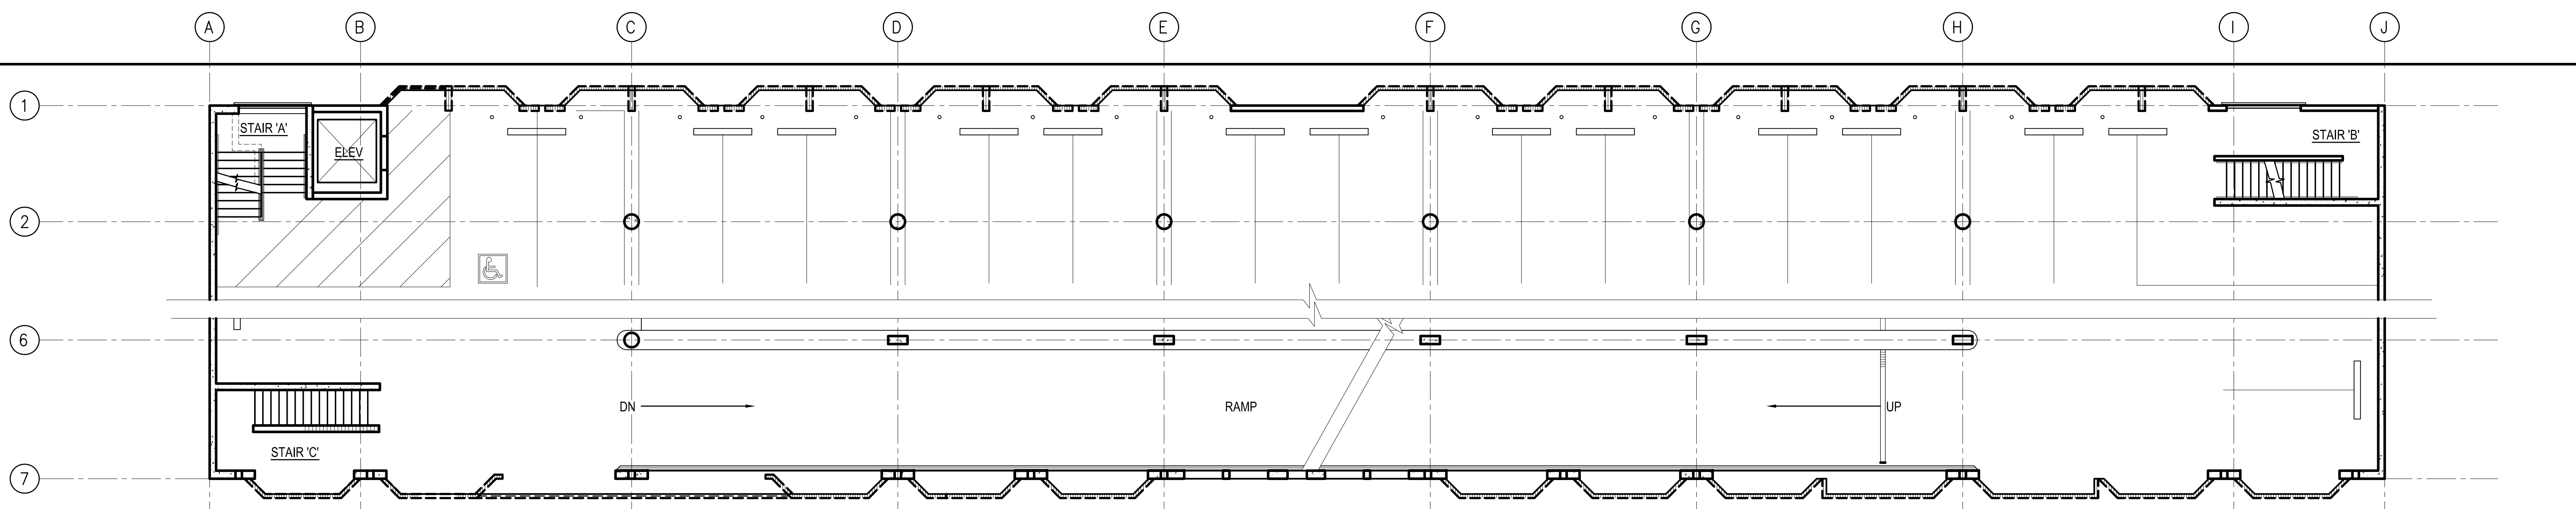


1 2ND FLOOR DEMOLITION PLAN

SCALE: 1/8" = 1'-0"

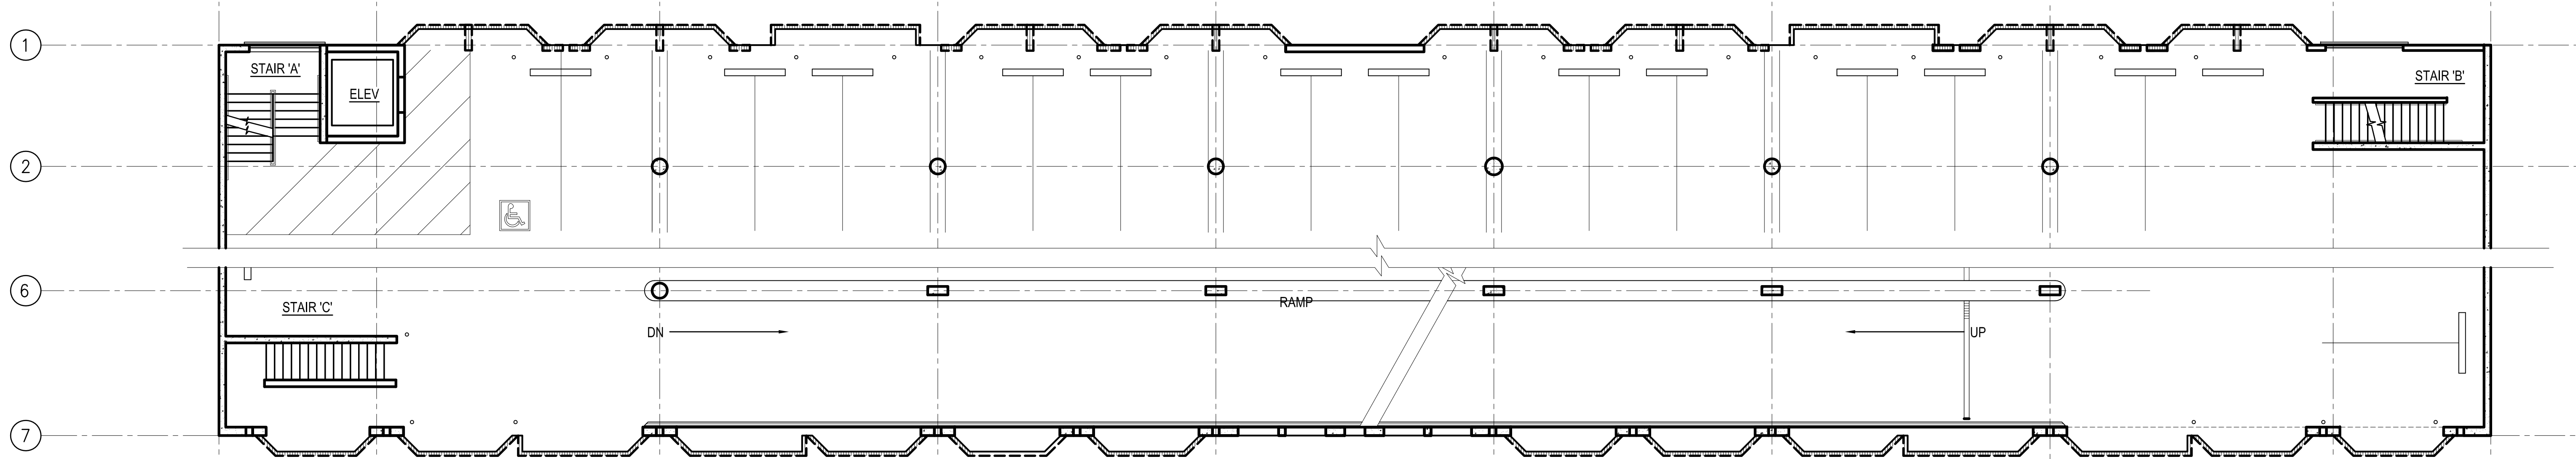


2 3RD FLOOR DEMOLITION PLAN

SCALE: 1/8" = 1'-0"

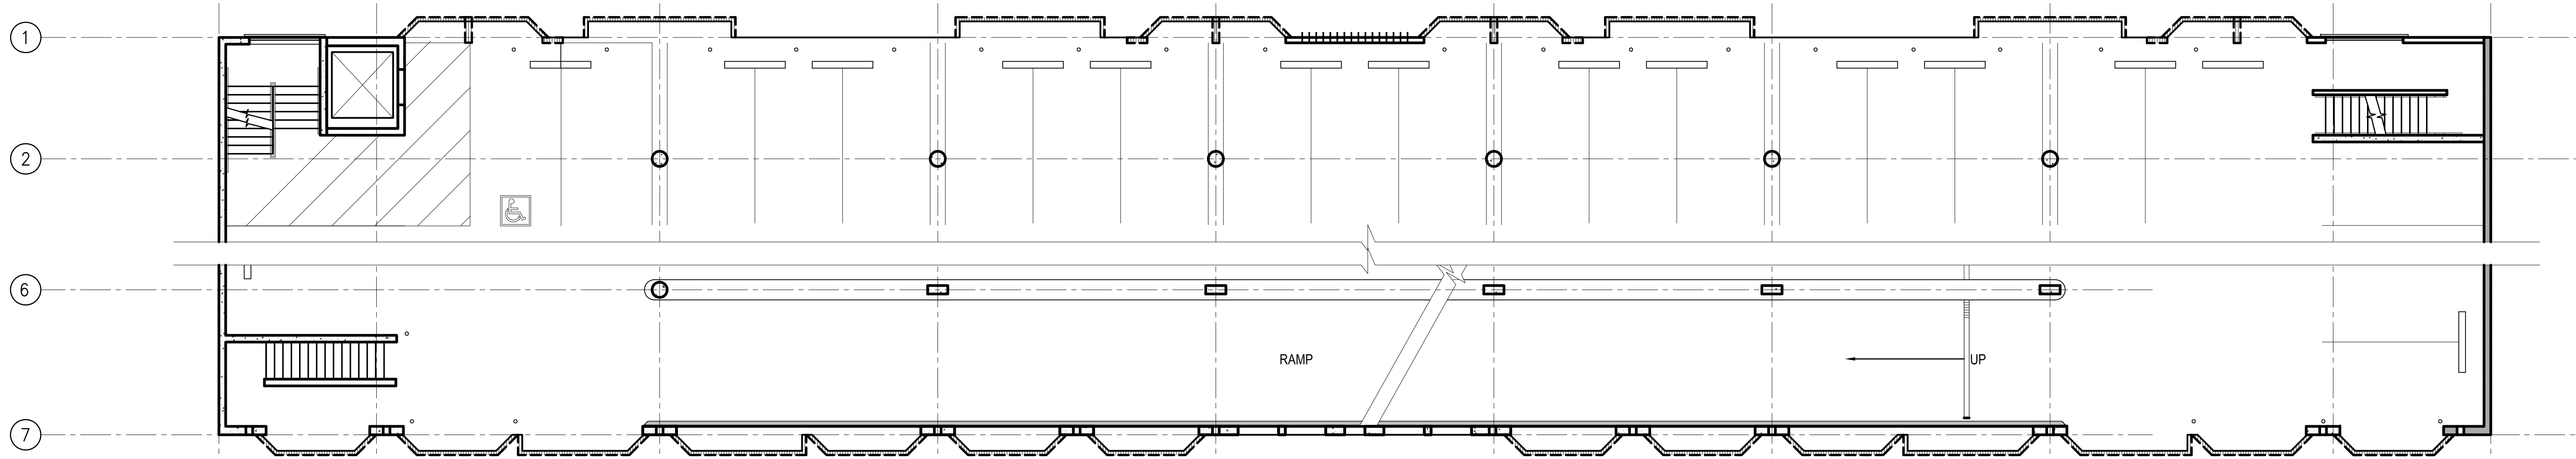

3 4TH FLOOR DEMOLITION PLAN

SCALE: 1/8" = 1'-0"

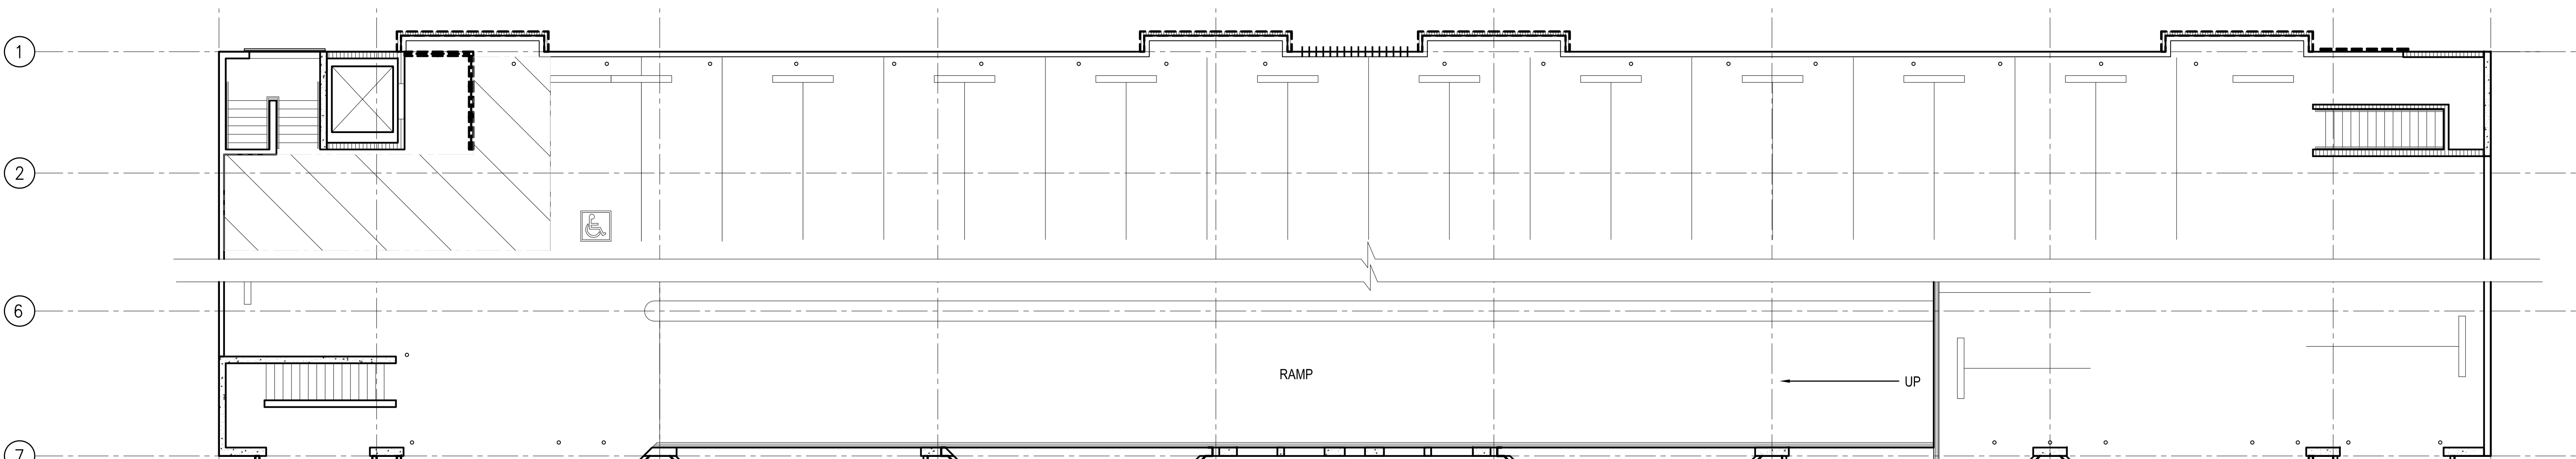

4 ROOF DEMOLITION PLAN

SCALE: 1/8" = 1'-0"


Issue _____

**BUILDING PERMIT ADDENDUM
 AUGUST 4, 2016**

No.	Date	Revisions

Mark Dorian - Manager, Architecture Services

Drawn	SK
Proj. Arch.	JOR
Proj. Mgr.	DU
Section Head	TL
Phase	CD
Drawing Title	ARCHITECT OF RECORD

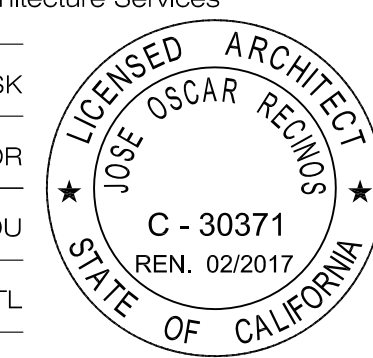

DEMOLITION FLOOR PLANS

Sheet No. _____


A1.1

Scale AS NOTED

Job No. _____

8026A

Original Drawing Size: 30" x 42" Drawing name: P:\0206A Lombard Street Garage Waterproofing\5.0_Design\5.01_Current\ACD\Floor\PLANNING\A1_1_DEMOLITION PLANS.dwg Plotted on: Aug 09, 2016 - 12:10pm

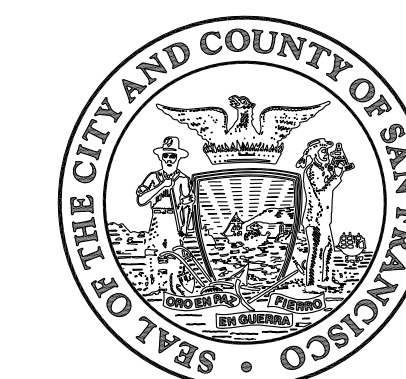



Julia Laue - Principal Architect/Division Manager
 30 Van Ness Avenue Suite 4100
 San Francisco, CA (415) 557-4700
 94102-6028 Fax (415) 5574701

Project


**LOMBARD PARKING GARAGE
 IMPROVEMENTS**

2055 LOMBARD STREET
 SAN FRANCISCO
 CALIFORNIA 94133


Consultant

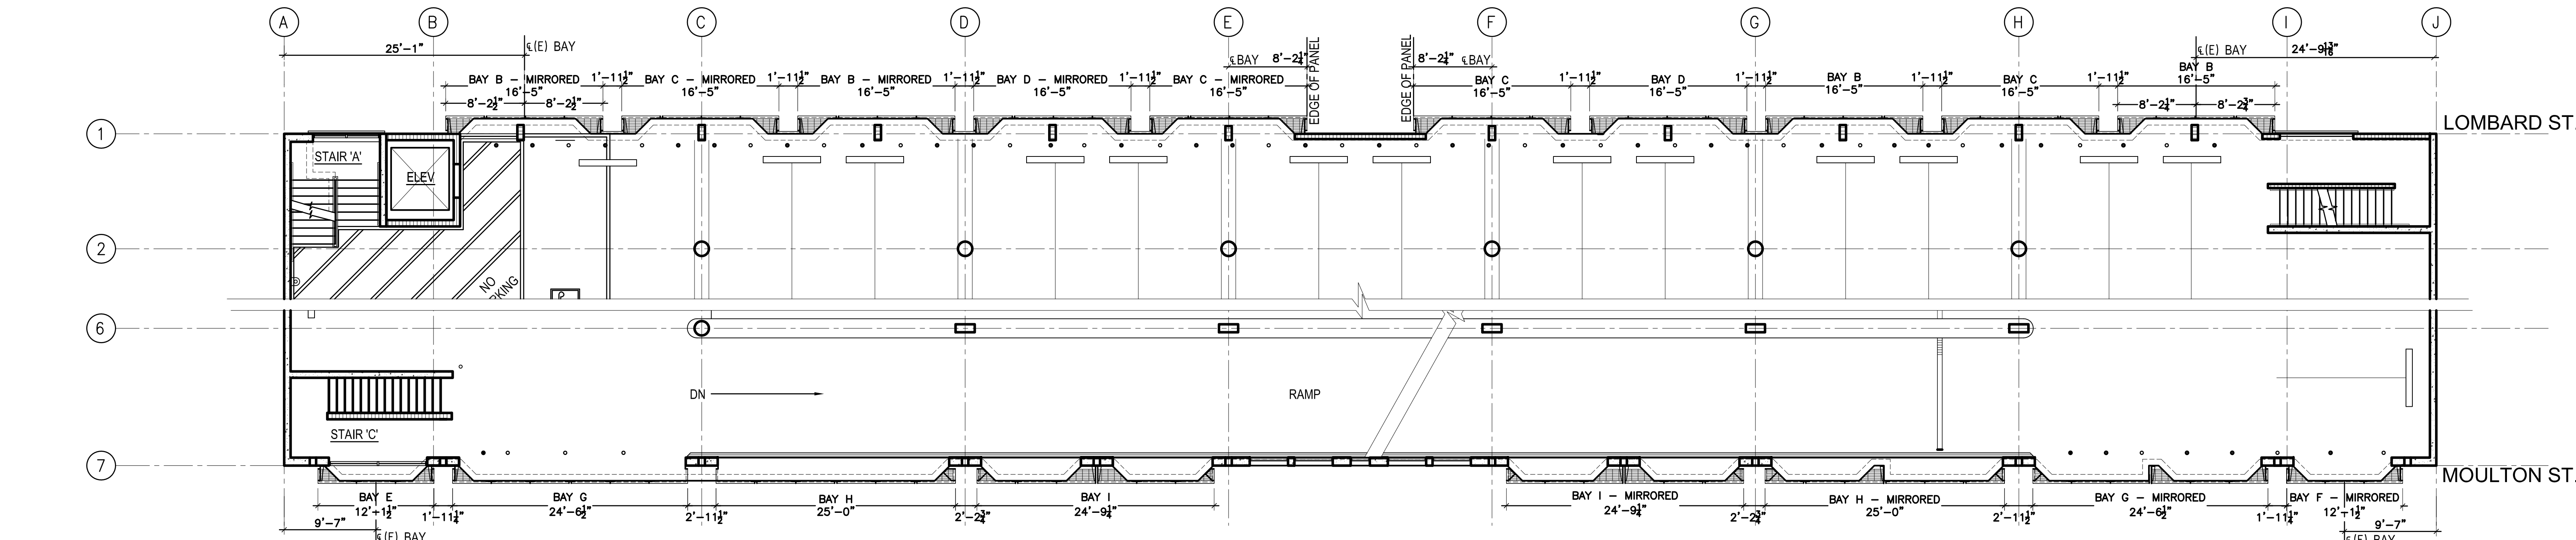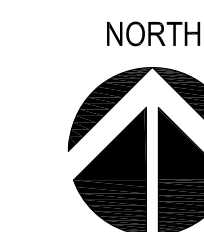


1 SECOND FLOOR PLAN
 SCALE: 1/8" = 1'-0"

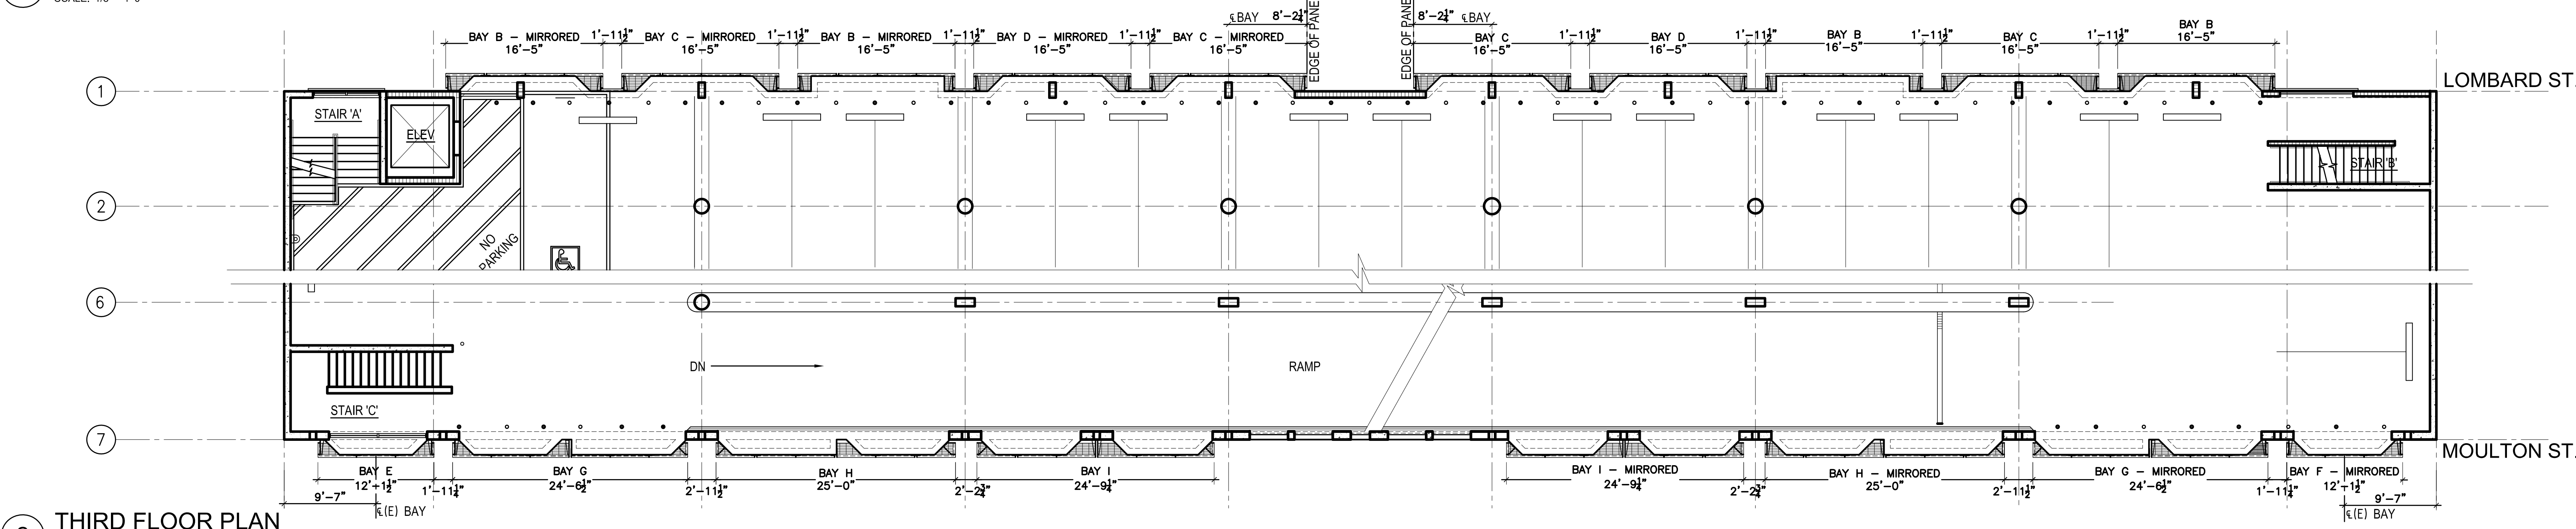

2 THIRD FLOOR PLAN
 SCALE: 1/8" = 1'-0"

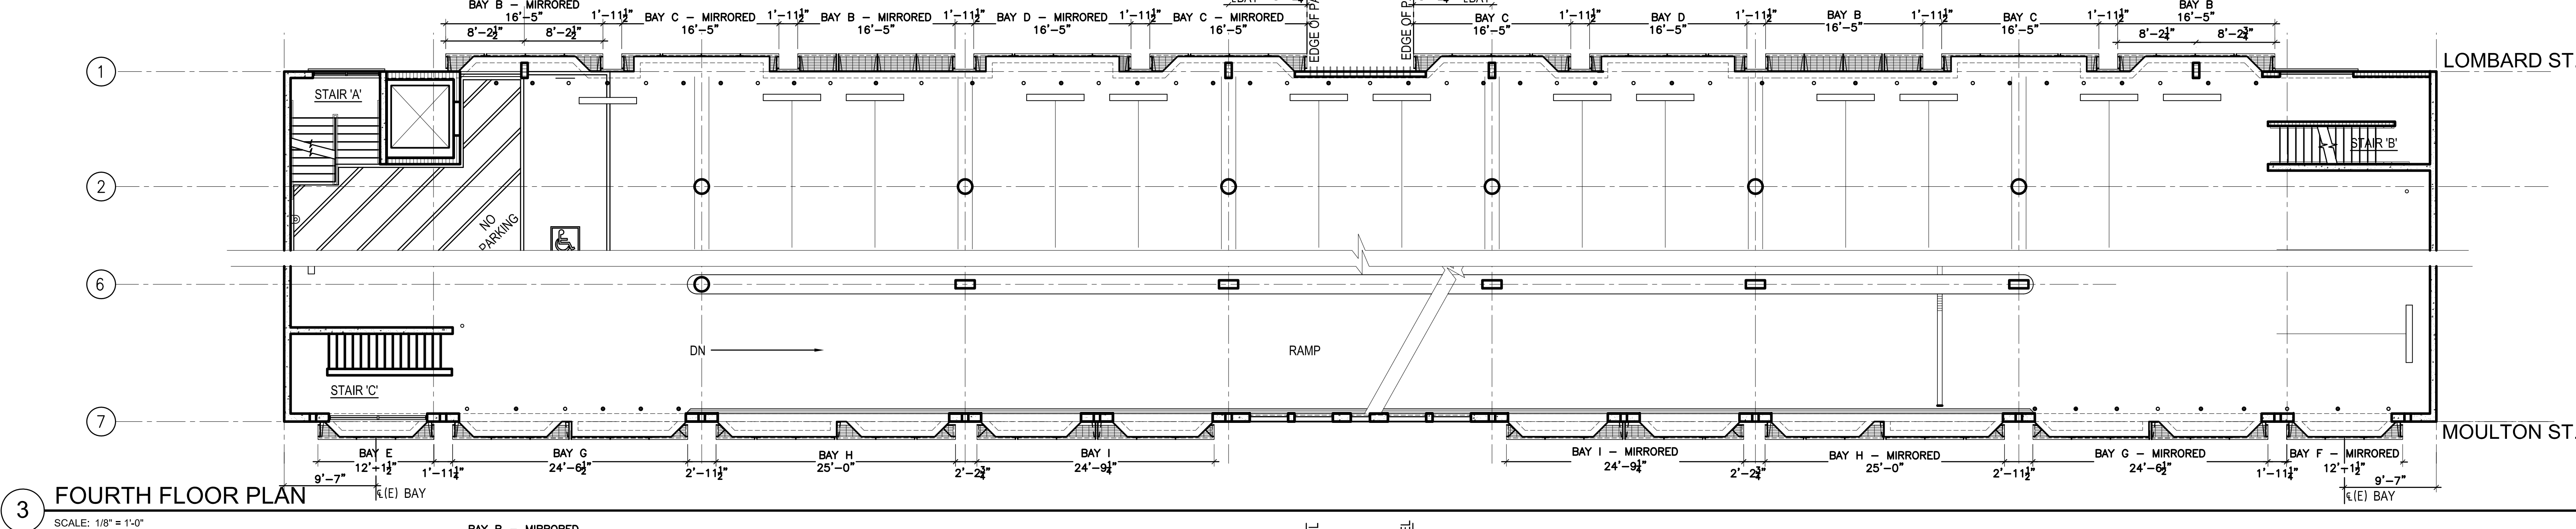

3 FOURTH FLOOR PLAN
 SCALE: 1/8" = 1'-0"

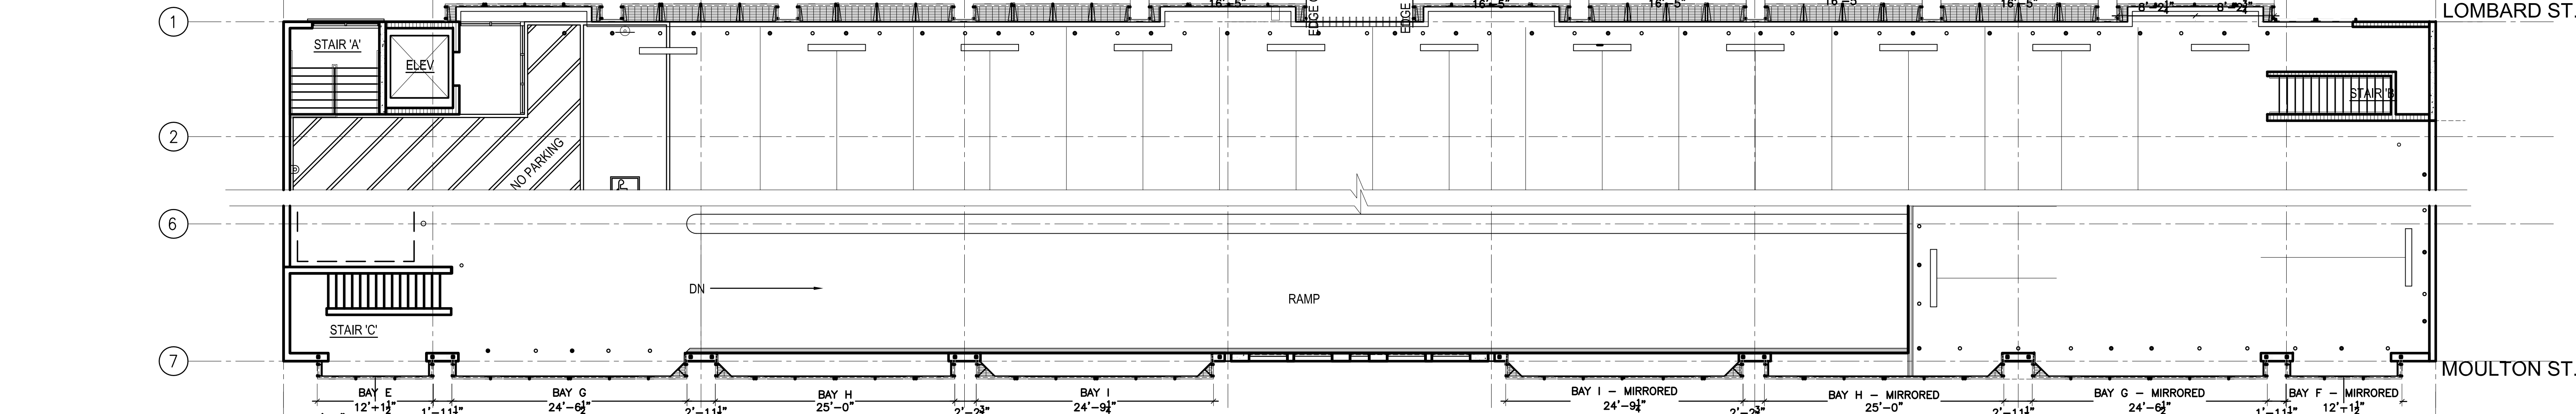


4 ROOF FLOOR PLAN
 SCALE: 1/8" = 1'-0"

Issue
**BUILDING PERMIT ADDENDUM
 AUGUST 4, 2016**

No.	Date	Revisions


Mark Dorian - Manager, Architecture Services
 Drawn: SK
 Proj. Arch.: JOR
 Proj. Mgr.: DU
 Section Head: TL
 Phase: CD
 Drawing Title: ARCHITECT OF RECORD

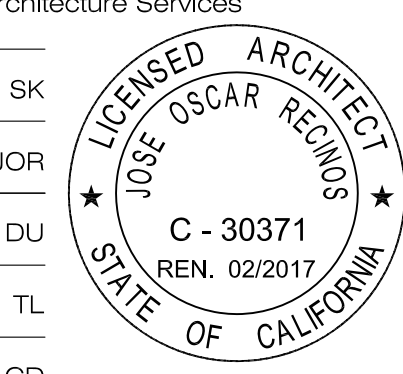

PROPOSED FLOOR PLANS

Sheet No. **A2.2**
 Scale: AS NOTED
 Job No. 8026A

Original Drawing Size: 30" x 42"
 Drawing name: P:\8026A Lombard Street Garage Waterproofing\5.0_Design\5.01_Current\ACD\Floor Plans\A2.2_FLOOR PLANS.dwg
 Plotted on: Aug 09, 2016 - 12:39pm

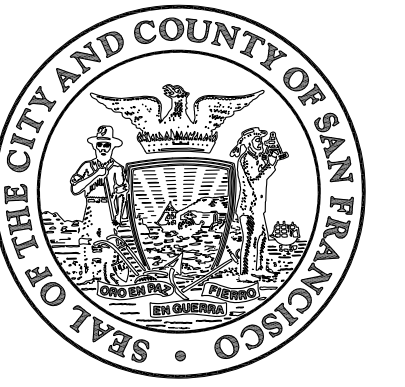


Julia Laue - Principal Architect/Division Manager
30 Van Ness Avenue Suite 4100
San Francisco, CA (415) 557-4700
94102-6028 Fax (415) 5574701

Project _____


**LOMBARD PARKING GARAGE
IMPROVEMENTS**

2055 LOMBARD STREET
SAN FRANCISCO
CALIFORNIA 94133

Consultant _____

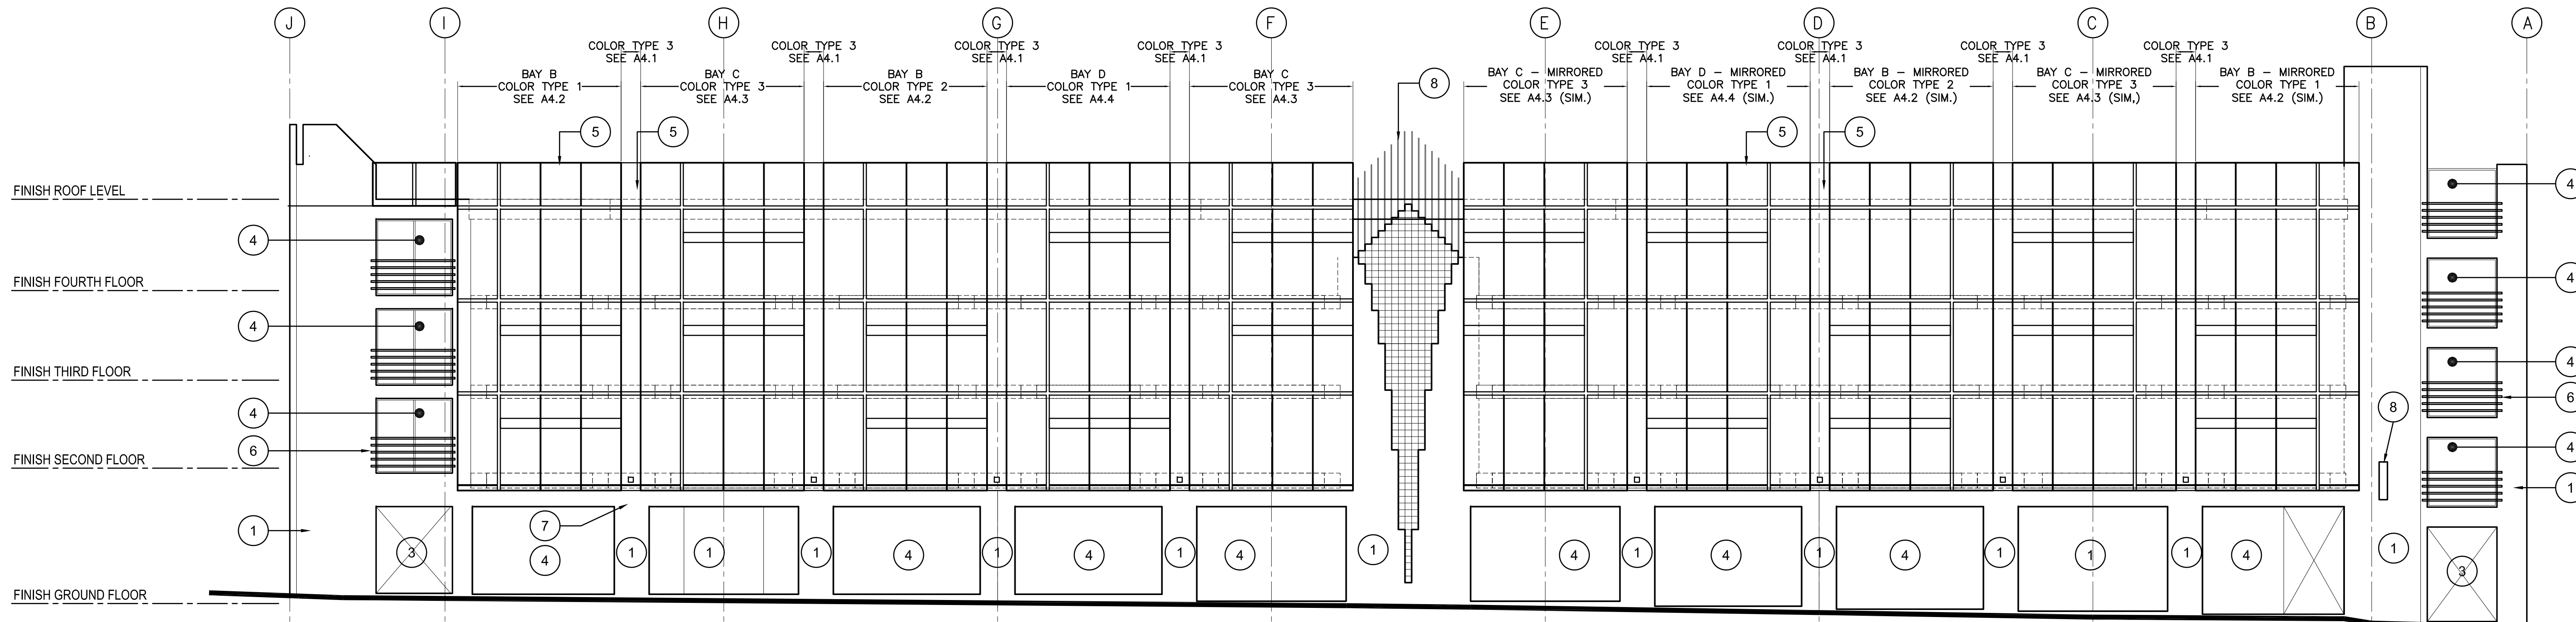

1 BUILDING ELEVATION - LOMBARD ST.
SCALE: 1/8" = 1'-0"

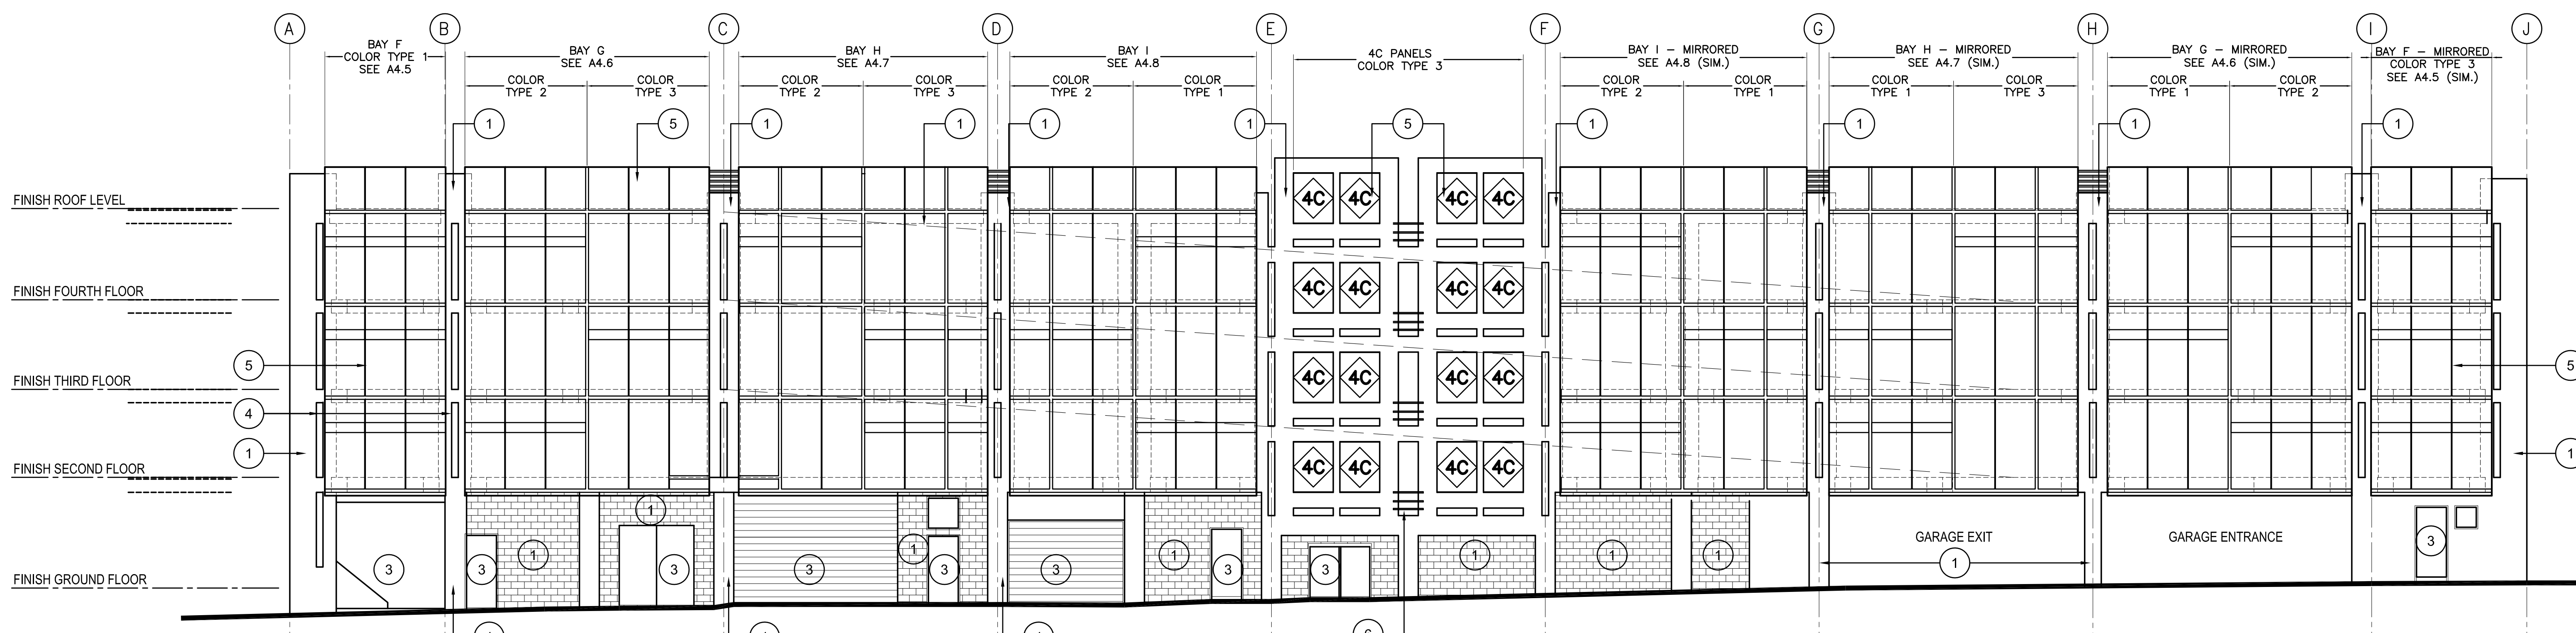

2 BUILDING ELEVATION - MOULTON ST.
SCALE: 1/4" = 1'-0"

GENERAL NOTES

- ALL CONSTRUCTION AND INSTALLATION WORK SHOWN IN DRAWINGS OR INDICATED IN SPECIFICATIONS SHALL CONFORM TO ALL APPLICABLE CODES AND ORDINANCES OF GOVERNMENTAL AGENCIES HAVING JURISDICTION OVER THE PROJECT.
- PROTECT ALL UTILITIES, IMPROVEMENTS AND STRUCTURES AND RESTORE TO NEW CONDITION AT NO ADDITIONAL COST TO THE CITY IF DAMAGED DURING THE COURSE OF WORK.
- VERIFY THAT EXISTING CONDITIONS ARE AS INDICATED ON THE DRAWINGS AND SPECIFICATIONS. VERIFY ALL (E) BUILDING DIMENSIONS PRIOR TO STARTING CONSTRUCTION. NOTIFY THE CITY REPRESENTATIVE IMMEDIATELY OF VARIATIONS OR DISCREPANCIES. DO NOT PROCEED WITH AFFECTED WORK UNTIL THE VARIATIONS OR DISCREPANCIES ARE RESOLVED BY THE CITY REPRESENTATIVE.
- PROVIDE AND MAINTAIN TEMPORARY BARRICADES, CLOSURE WALLS, ETC., AS REQUIRED TO PROTECT THE PUBLIC DURING PERIOD OF CONSTRUCTION.
- INSTALL MANUFACTURED MATERIALS AND EQUIPMENT ACCORDING TO MANUFACTURER'S RECOMMENDATIONS AND INSTRUCTIONS. (U.O.N.)
- WORK REQUIRED UNDER THIS CONTRACT INCLUDES ALL LABOR, MATERIALS, EQUIPMENT, ETC. NECESSARY TO COMPLETE THE PROJECT.
- DO NOT SCALE DRAWINGS. USE DIMENSIONS SHOWN.
- THE CONTRACTOR SHALL BE SOLELY RESPONSIBLE FOR SECURITY OF THE SITE DURING THE TERM OF THE CONTRACT. ANY DAMAGE OR LOSS OF PROPERTY DURING THE TERM OF THE CONTRACT SHALL BE REPAIRED OR REPLACED BY THE CONTRACTOR AT NO COST TO THE CITY.
- IT IS THE CONTRACTORS RESPONSIBILITY TO REVIEW ROOF IN DETAIL TO ASSURE THAT ITEMS NOT SPECIFICALLY NOTED OR DETAILED, BUT REQUIRED FOR A COMPLETE AND PROFESSIONAL INSTALLATION, ARE PROVIDED. ITEMS NOT SPECIFICALLY NOTED BUT IDENTIFIED IN LIKE, TYPICAL, OR SIMILAR IN FASHION, REMAIN THE RESPONSIBILITY OF THE CONTRACTOR AND ARE PART OF THE SCOPE OF WORK.
- LIMIT THE AMOUNT OF DUST AND DIRT RISING AND SCATTERING IN THE AIR TO COMPLY WITH GOVERNMENTAL REGULATIONS. KEEP CONSTRUCTION AREAS BROOM CLEAN FROM ALL DUST, DIRT, AND DEBRIS CAUSED BY DEMOLITION OPERATIONS.
- CONTRACTOR IS RESPONSIBLE FOR TOUCH UP, REPAIR, AND PROTECTION OF ALL ADJACENT AREAS OF THE SCOPE OF WORK. COLORS AND FINISHES TO MATCH (E).
- WHERE DISSIMILAR METALS ARE IN CONTACT, OR WHERE ALUMINUM IS IN CONTACT WITH CONCRETE, MORTAR, MASONRY OR ABSORPTIVE MATERIALS SUBJECT TO WETTING, THE SURFACES SHALL BE PROTECTED WITH A HEAVY COAT OF BITUMINOUS PAINT. BITUMINOUS PAINT SHALL BE APPLIED SO AS NOT TO BE EXPOSED TO VIEW.**

- FIELD VERIFY LOCATIONS OF ALL POST TENSION SLAB TENDONS, REBAR AND STIRRUPS IN CONCRETE PRIOR TO ANY CORING, DRILLING OR REMOVAL OF CONCRETE.
- POWER WASH, CLEAN & REPAIR ALL SURFACES, PATCH & REPAIR ANY DENTS AND CRACKS. PREPARE AND PRIME SURFACES TO BE PAINTED AS SPECIFIED. IMMEDIATELY NOTIFY ARCHITECT OF ANY CRACKS WIDER THAN 1/8".
- REVIEW ALL JOINTS, INCLUDED BUT NOT LIMITED TO, AT GROUND, DOOR & WINDOW FRAME AND CONTROL JOINTS. CAULK & SEAL ALL HORIZONTAL AND VERTICAL JOINTS. CAULK WITHIN PAINTED AREAS TO BE PAINTABLE AND COMPATIBLE WITH SPECIFIED COATINGS. COLOR TO MATCH EXISTING ADJ. SEALANT.
- REVIEW AND COORDINATE WITH CM AND PM HAZARDOUS MATERIALS REPORT PRIOR START OF WORK.
- WHERE AN ITEM OR SURFACE IS NOT SPECIFICALLY MENTIONED, PAINT THE SAME AS SIMILAR ADJACENT MATERIALS OR SURFACES. CONFIRM WITH ARCHITECT AND CM PRIOR TO PAINTING.
- PAINT ALL EXPOSED AND EXISTING PAINTED SURFACES NOT LIMITED TO; MECHANICAL, PLUMBING AND ELECTRICAL CONDUITS / PIPES, AND ACCESSORIES, U.O.N.
- DOCUMENT AND CATALOG & REMOVE HARDWARE & HARDWARE ACCESSORIES, PLATES, MACHINED SURFACES, LIGHTING FIXTURES, PLACARDS, SIGNS, BIRD DETERRENTS & SIMILAR ITEMS ALREADY INSTALLED THAT ARE NOT TO BE PAINTED, OR PROVIDE SURFACE-APPLIED PROTECTION PRIOR TO SURFACE PREP. & PAINTING. REMOVE THESE ITEMS, IF NECESSARY, TO COMPLETELY PAINT THE ITEMS & ADJACENT SURFACES. FOLLOWING COMPLETION OF PAINTING OPERATIONS, HAVE ITEMS REINSTALLED, AS CONFIRMED BY CM AND SFFD, BY WORKERS SKILLED IN THE TRADES INVOLVED.
- FOR DRILLING INTO CONCRETE BEAMS AND SLAB SEE "DRILLING NOTES FOR CONCRETE SLABS AND BEAMS" UNDER GENERAL NOTES ON SHEET A0.1.
- BOLLARDS AND CABLES SHALL BE DESIGNED AND BUILT BY CONTRACTOR'S ENGINEER WHO IS REGISTERED IN STATE OF CALIFORNIA.
- PROVIDE SHOP DRAWINGS FOR BOLLARDS AND CABLES TO CITY REPRESENTATIVE FOR REVIEW.

SHEET NOTES

- (N) HIGH PERFORMANCE WALL COATING OVER (E) CMU, CONCRETE AND STUCCO WALLS, TYP. REPAIR ANY DAMAGED CMU, CONCRETE AND STUCCO THAT COMPROMISES THE WATERPROOFING OF THE EXTERIOR WALL PRIOR TO APPLICATION OF HIGH PERFORMANCE WALL COATING, TYP.
- (E) WALL TO REMAIN AS-IS, TYP.
- (E) DOOR / OVERHEAD DOOR TO REMAIN AS-IS, TYP.
- (E) STOREFRONT TO REMAIN AS-IS, TYP.
- (N) ALUMINUM PANELS, TYP.
- PAINT (E) PIPE RAIL, TYP.
- (N) LIGHT FIXTURE, QTY=8, SED
- (N) ILLUMINATED PARKING SIGN (OSCI), SED

LEGEND

PANEL TYPE, REFER TO DRAWING A4.1

**BUILDING PERMIT ADDENDUM
AUGUST 4, 2016**


No.	Date	Revisions

Mark Dorian - Manager, Architecture Services
 Drawn _____ SK
 Proj. Arch. _____ JOR
 Proj. Mgr. _____ DU
 Section Head _____ TL
 Phase _____ CD
 ARCHITECT OF RECORD

BUILDING ELEVATIONS

Sheet No. _____
A3.1
Scale AS NOTED
Job No. _____
8026A

Original Drawing Size: 30" x 42" Drawing name: P:\0206 Lombard Street Garage Waterproofing\5_Design\5_01_Concrete\A4\Drawings\1_BUILDING ELEVATIONS.dwg Plotted on: Aug 09, 2016 - 12:08pm

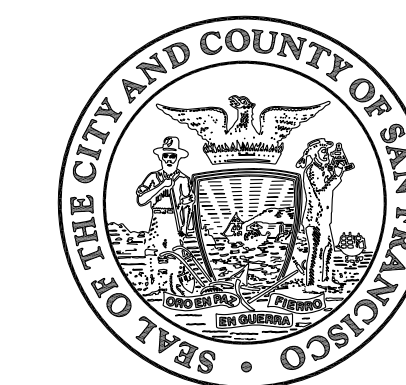

Julia Laue - Principal Architect/Division Manager
30 Van Ness Avenue Suite 4100
San Francisco, CA (415) 557-4700
94102-6028 Fax (415) 5574701

Project

**LOMBARD PARKING GARAGE
IMPROVEMENTS**

2055 LOMBARD STREET
SAN FRANCISCO
CALIFORNIA 94133

Consultant

Issue

**BUILDING PERMIT ADDENDUM
AUGUST 4, 2016**

No.	Date	Revisions

Mark Dorian - Manager, Architecture Services

Drawn	SK
Proj. Arch.	JOR
Proj. Mgr.	DU
Section Head	TL
Phase	CD
Drawing Title	ARCHITECT OF RECORD









PANEL BAY TYPE B

Sheet No.

A4.2

Scale AS NOTED


Job No. 8026A

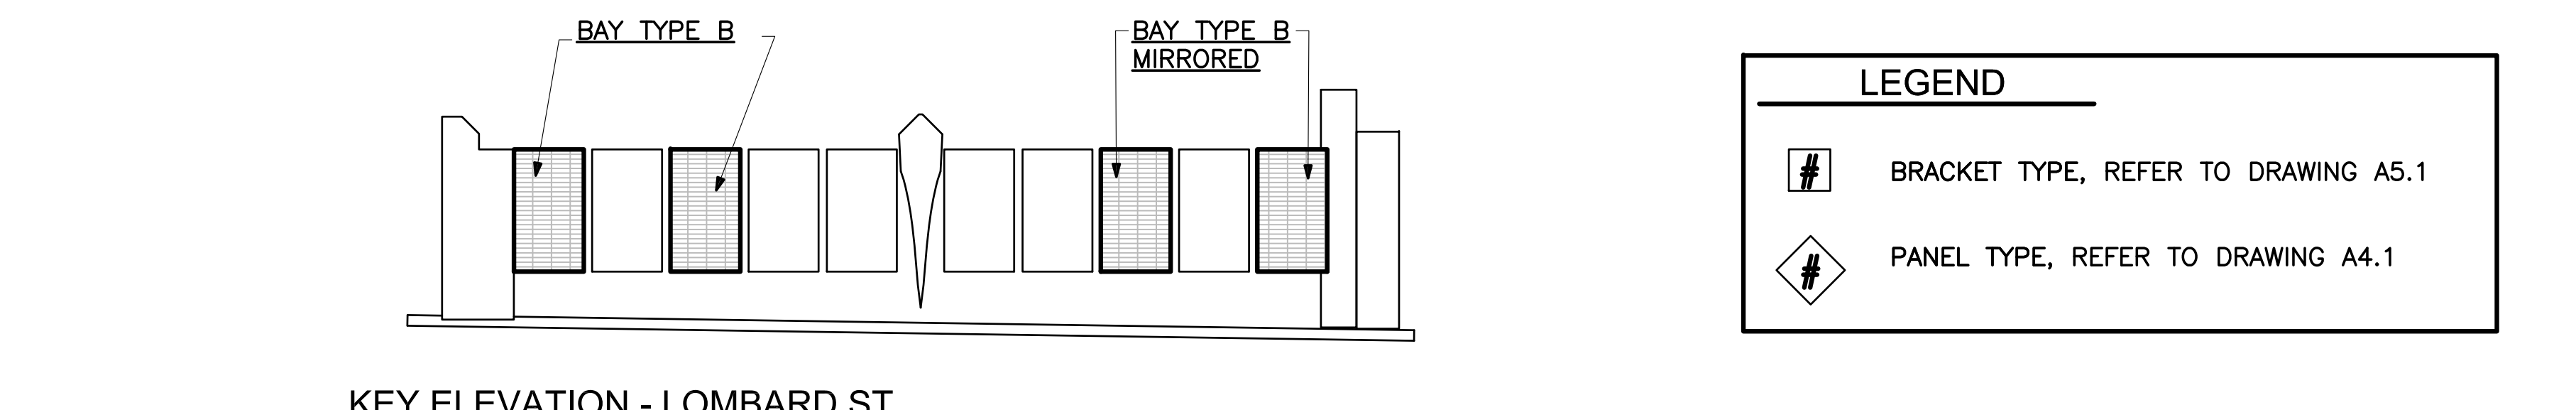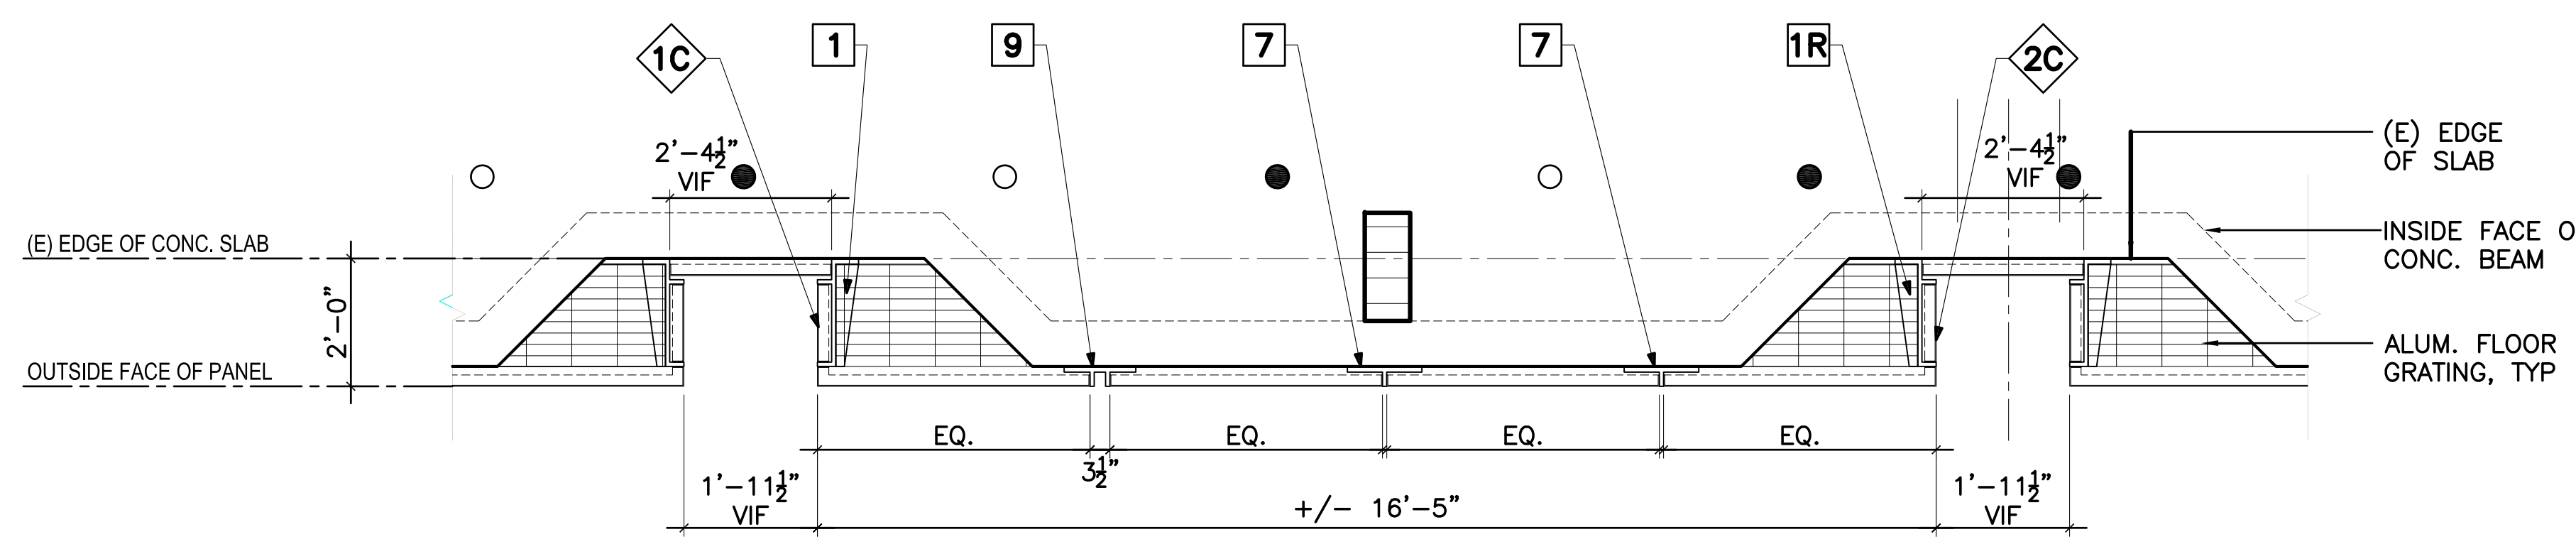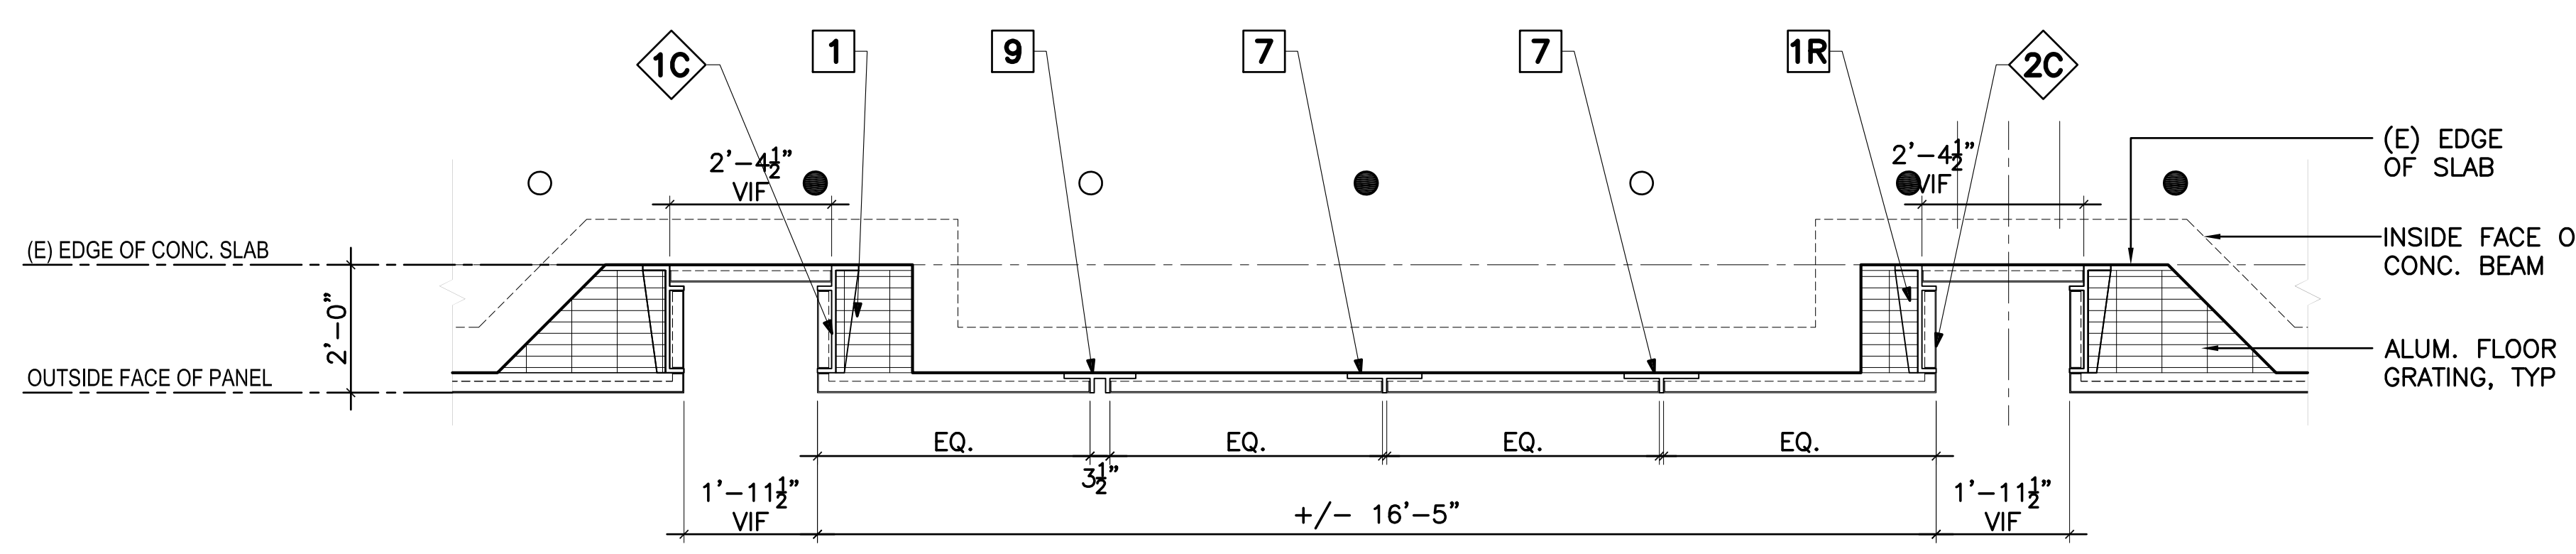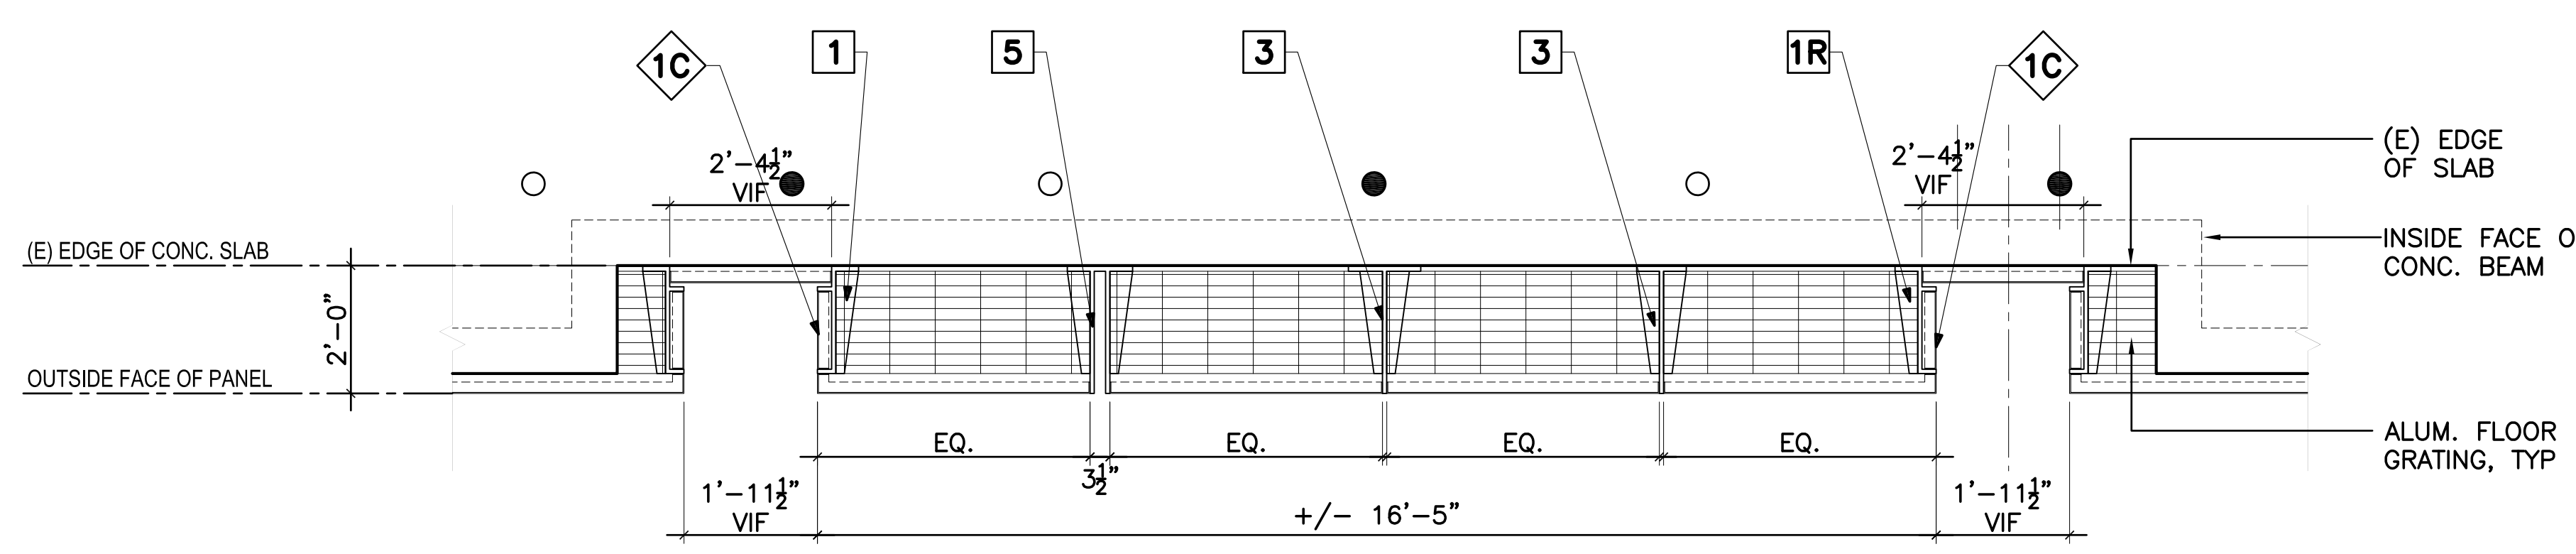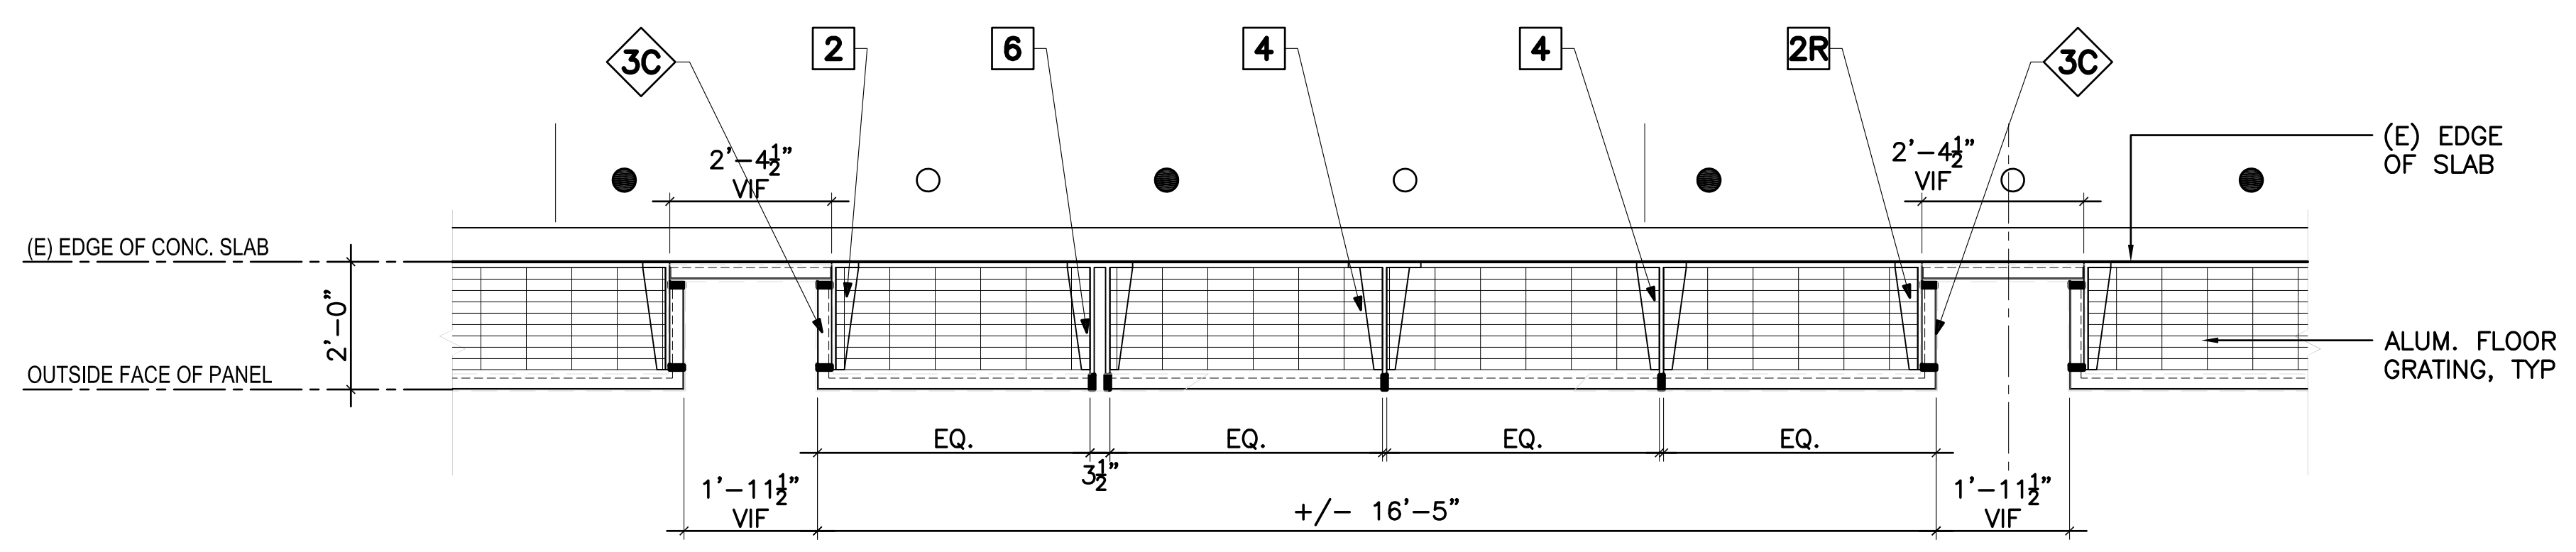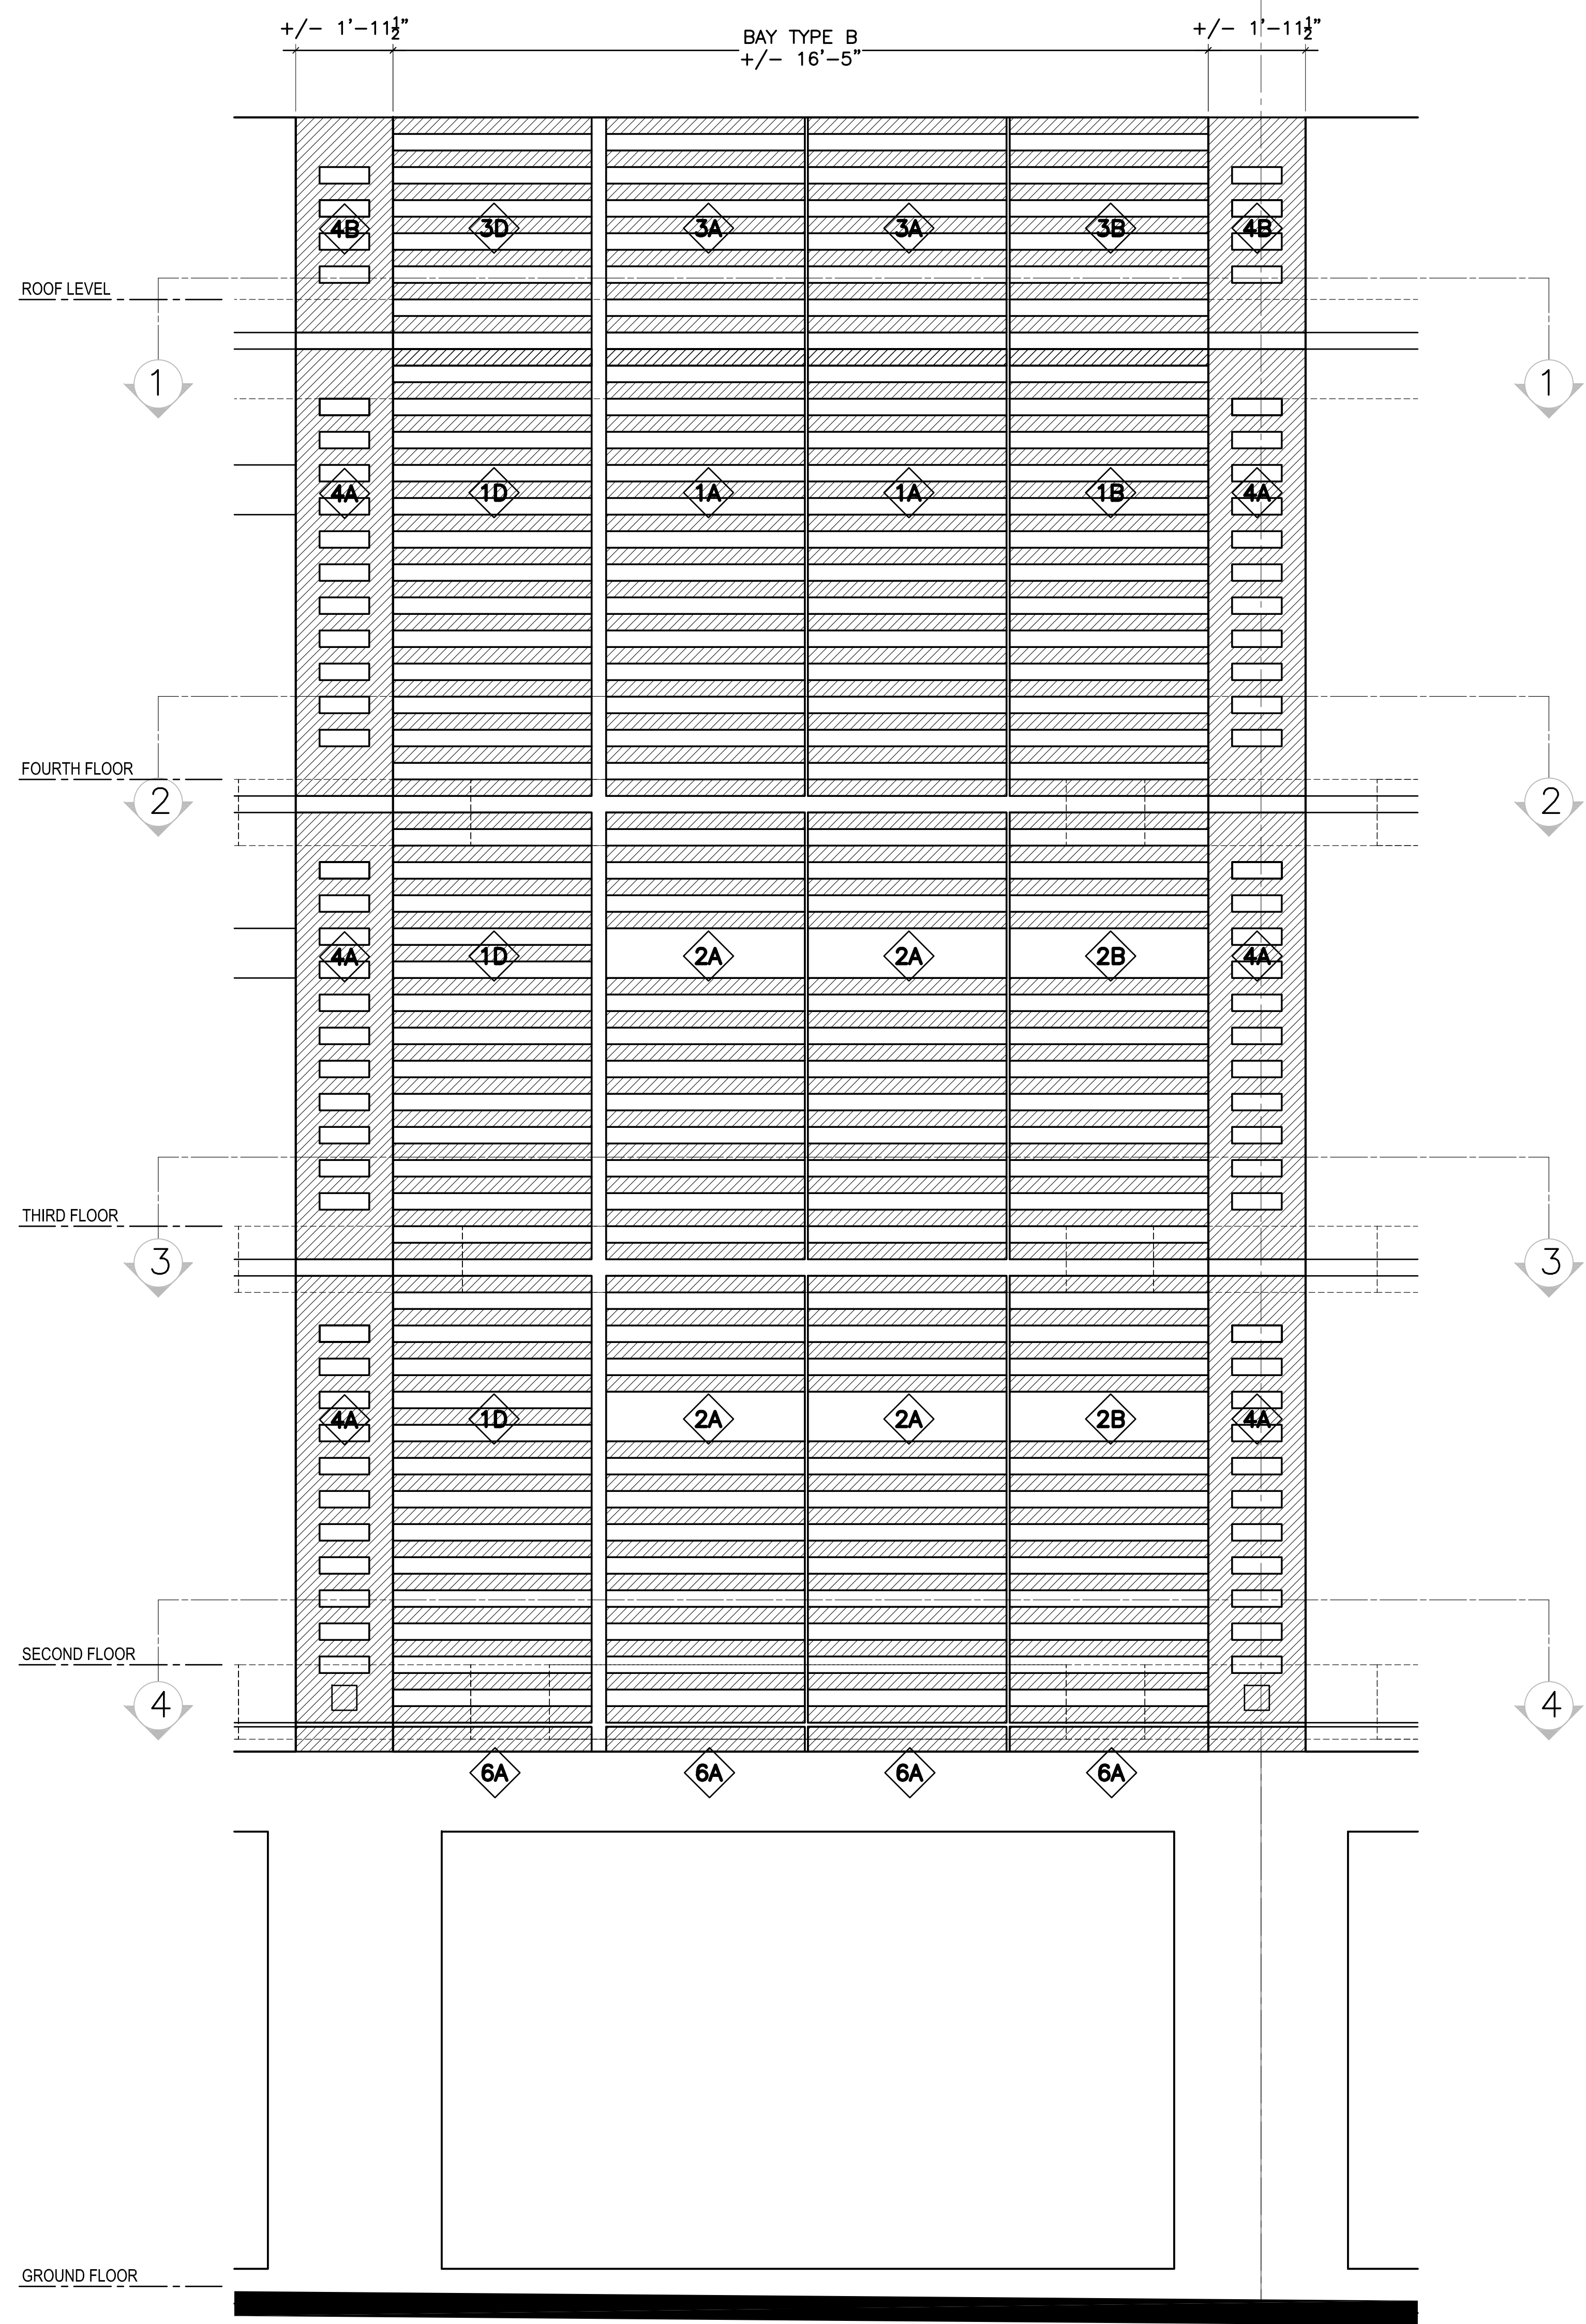

- GENERAL NOTES**
- ALL PANELS MUST COMPLY WITH 2013 CALIFORNIA BUILDING CODE SECTION 1013 GUARDS
 - ALUMINUM FLOOR PANELS TO BE PROVIDED BY ALUMINUM PANEL MANUFACTURER AS PART OF THE ALUMINUM PANEL SYSTEM


Original Drawing Size: 30" x 42" Drawing name: P:\2026A Lombard Street Garage Waterproofing\5.0_Design\5.01_Current\CAD\Floor\A4.2_ENLARGED BAY TYPE B ELEVATION.dwg Plotted on: Aug 09, 2016 - 12:38pm

5 PANEL BAY TYPE B
SCALE: 1/2" = 1'-0"

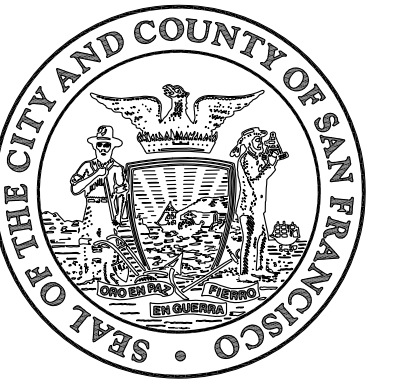


Julia Laue - Principal Architect/Division Manager
30 Van Ness Avenue Suite 4100
San Francisco, CA (415) 557-4700
94102-6028 Fax (415) 5574701


Project
**LOMBARD PARKING GARAGE
IMPROVEMENTS**
2055 LOMBARD STREET
SAN FRANCISCO
CALIFORNIA 94133
Consultant

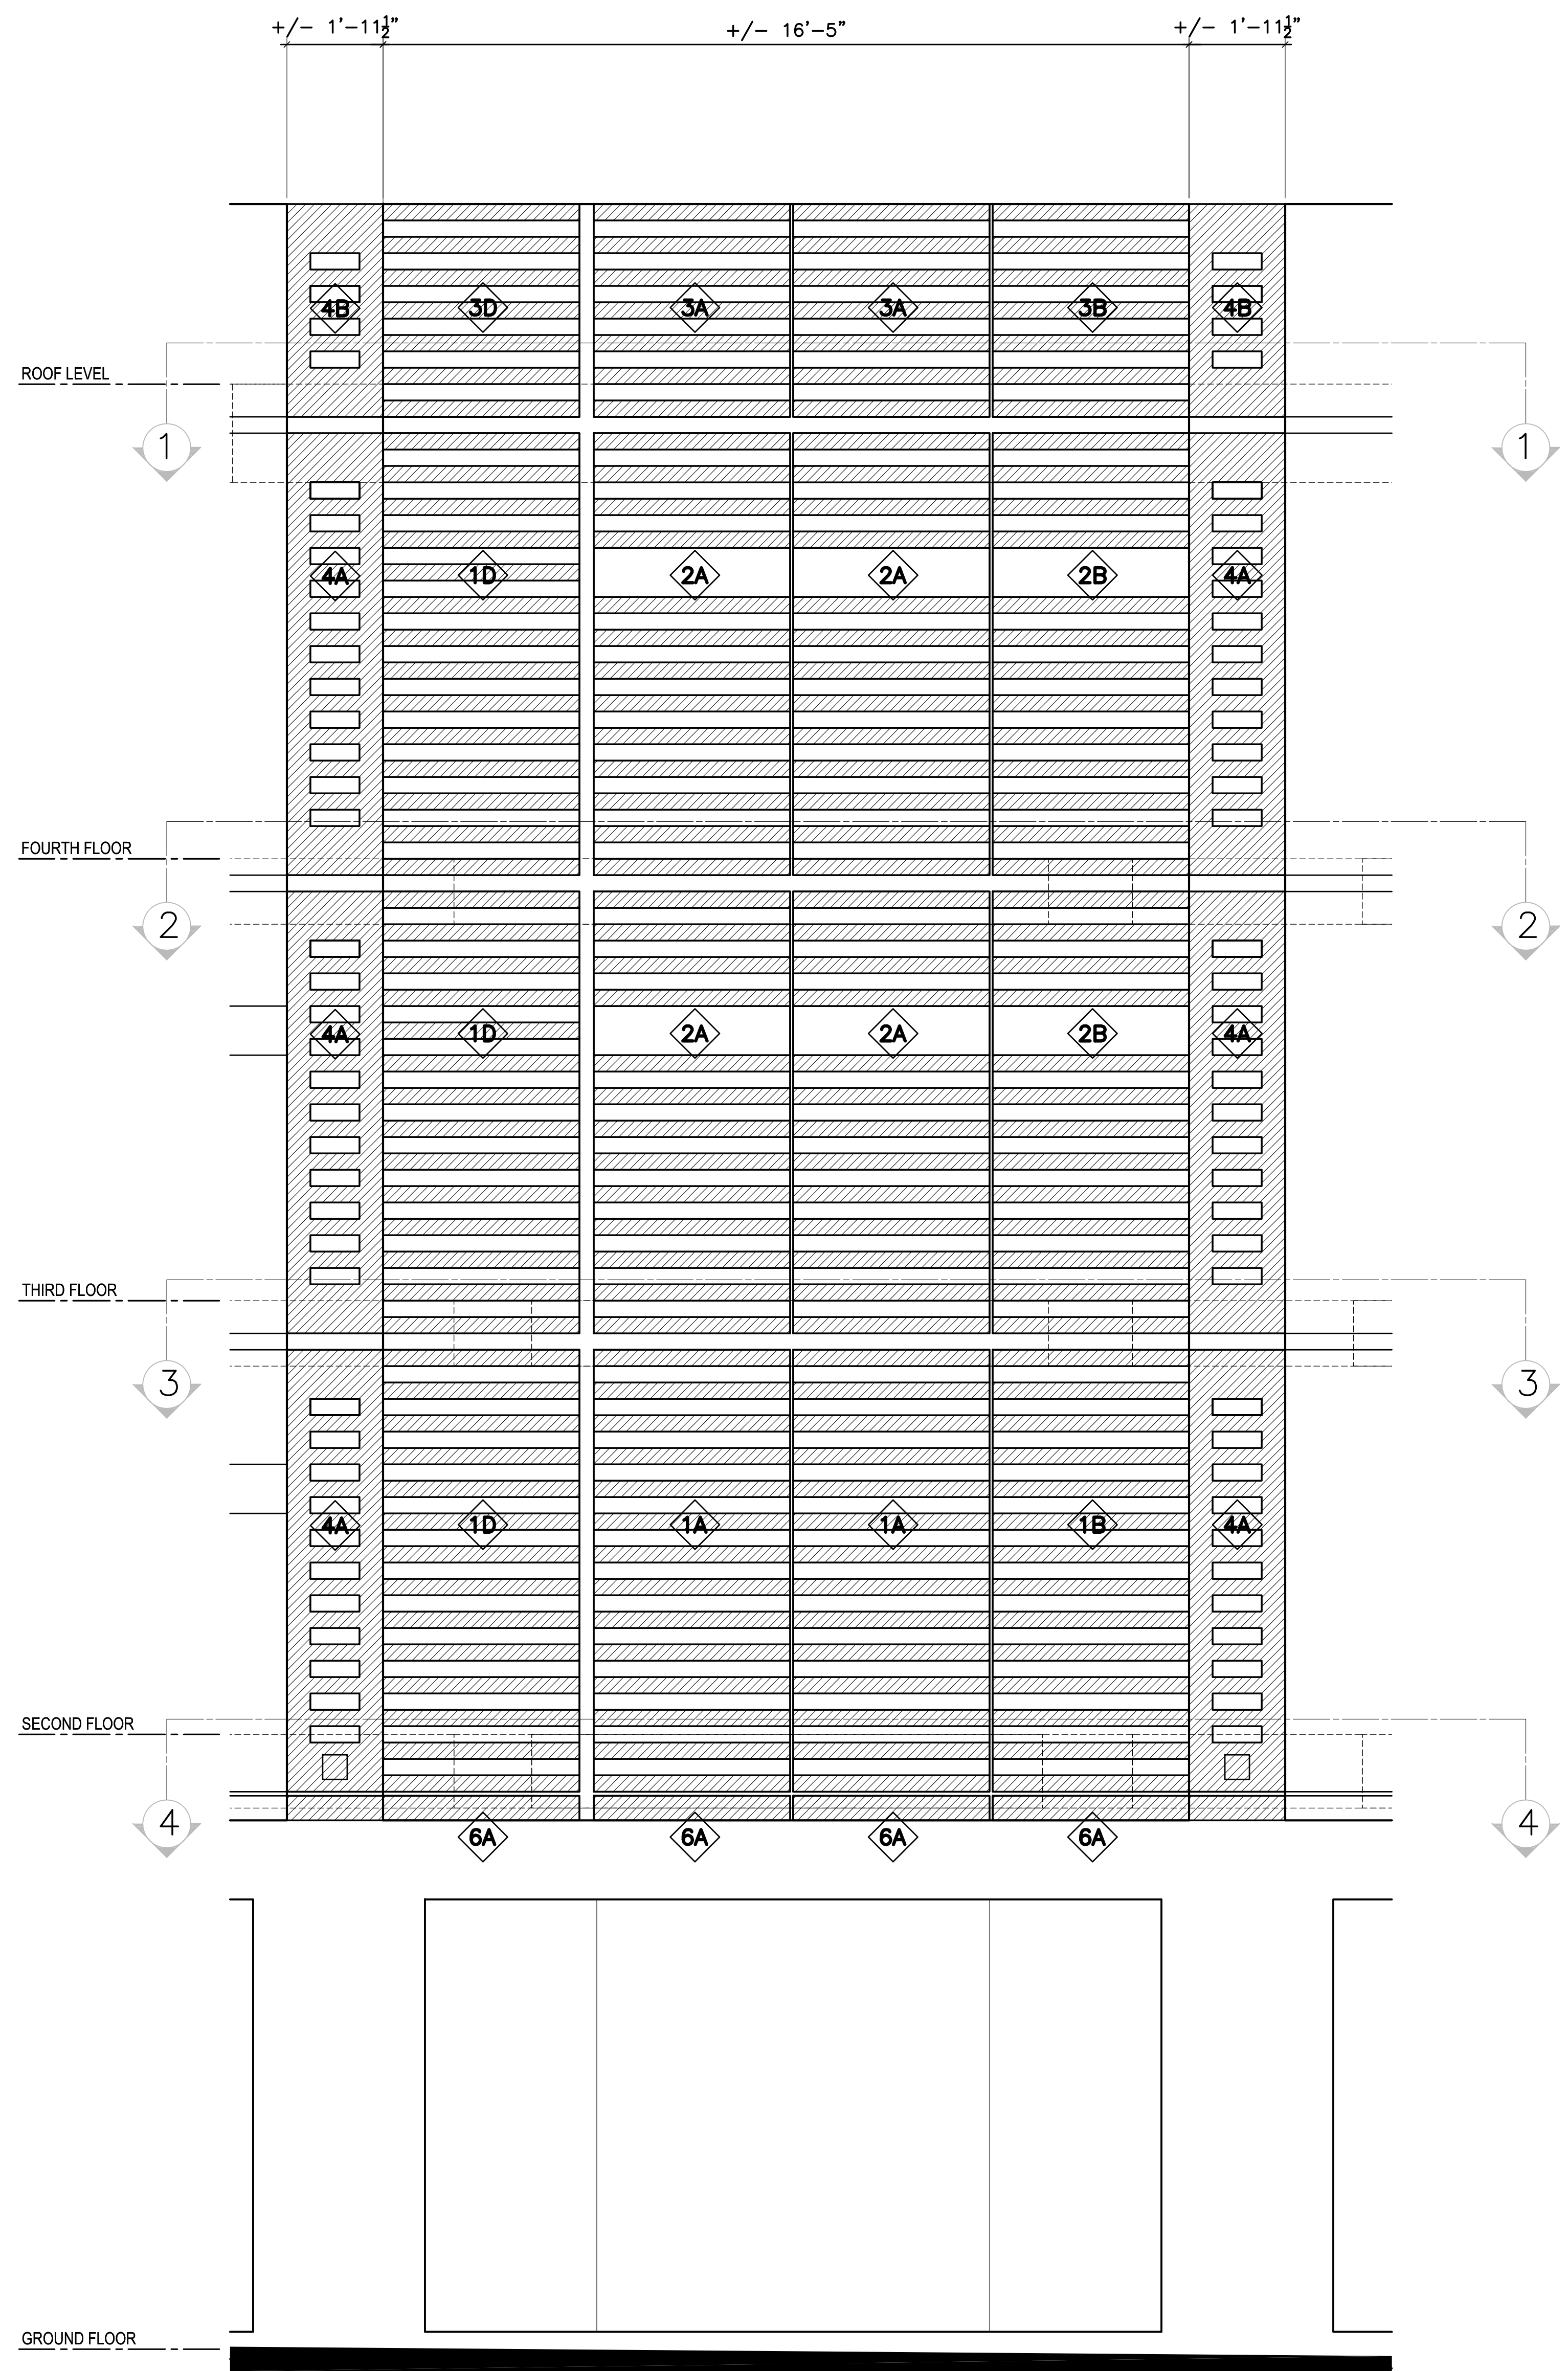


6 PANEL BAY TYPE C
SCALE: 1/2" = 1'-0"

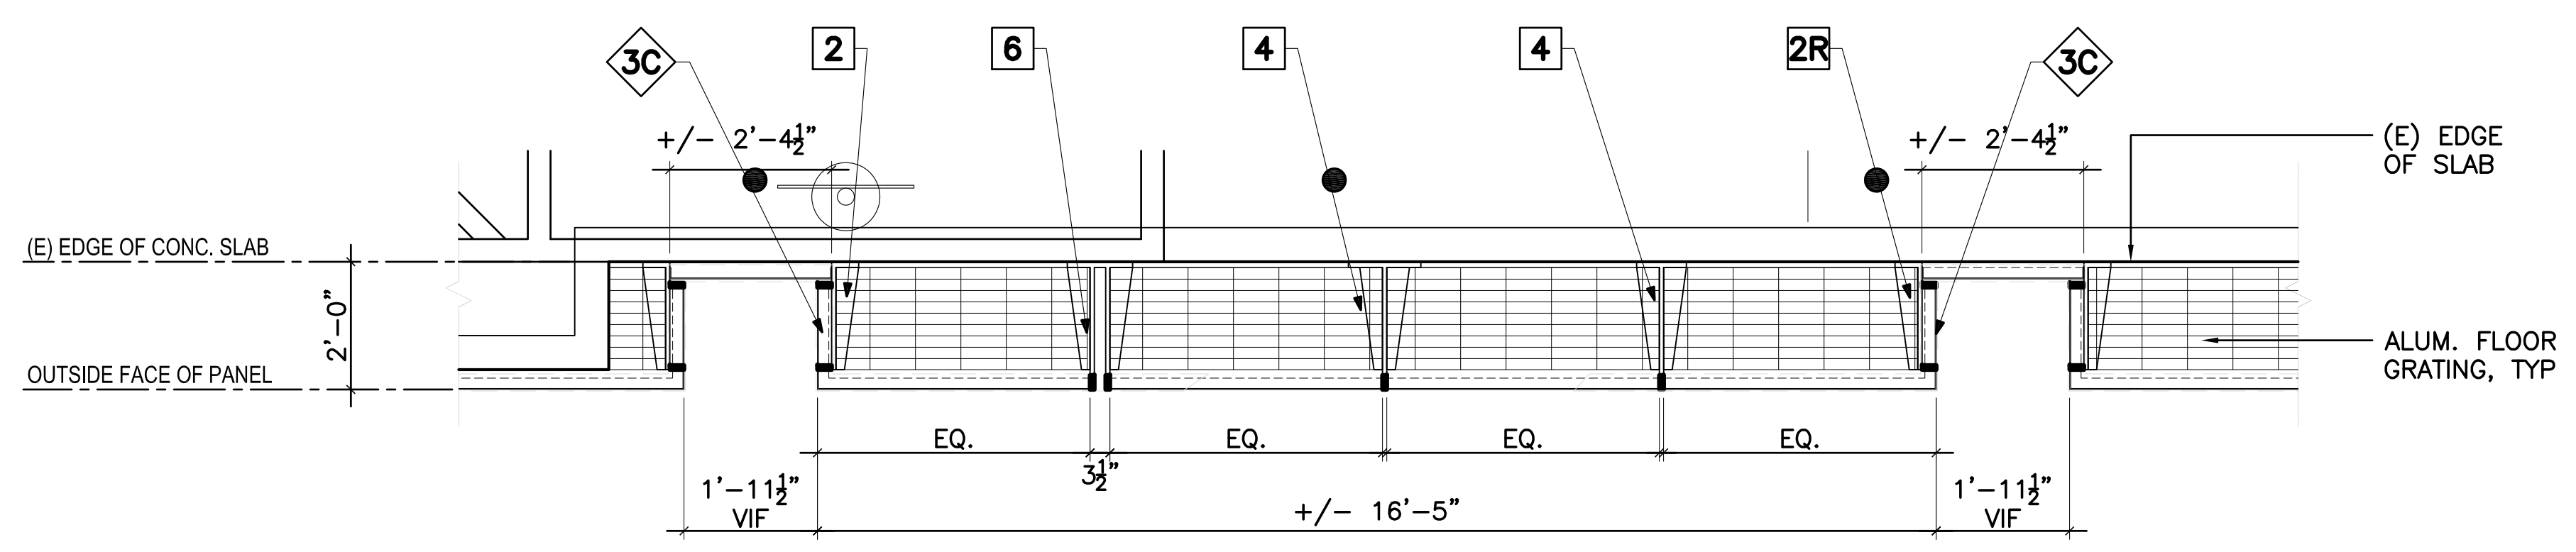


1 ROOF PLAN - LOMBARD ST
SCALE: 1/2" = 1'-0"

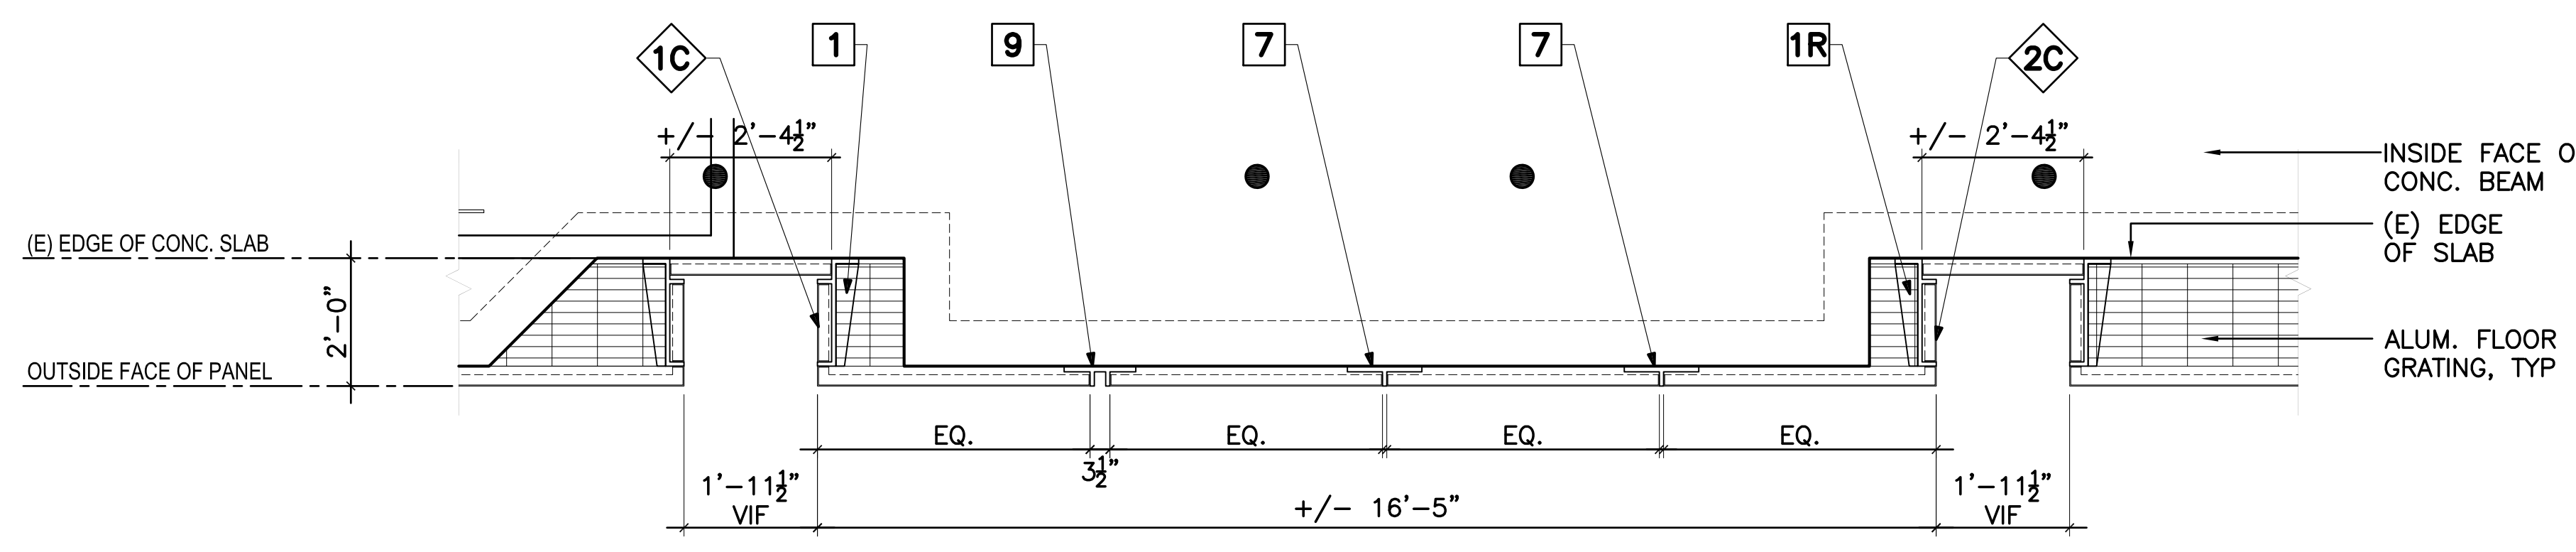


2 FOURTH FLOOR PLAN - LOMBARD ST
SCALE: 1/2" = 1'-0"

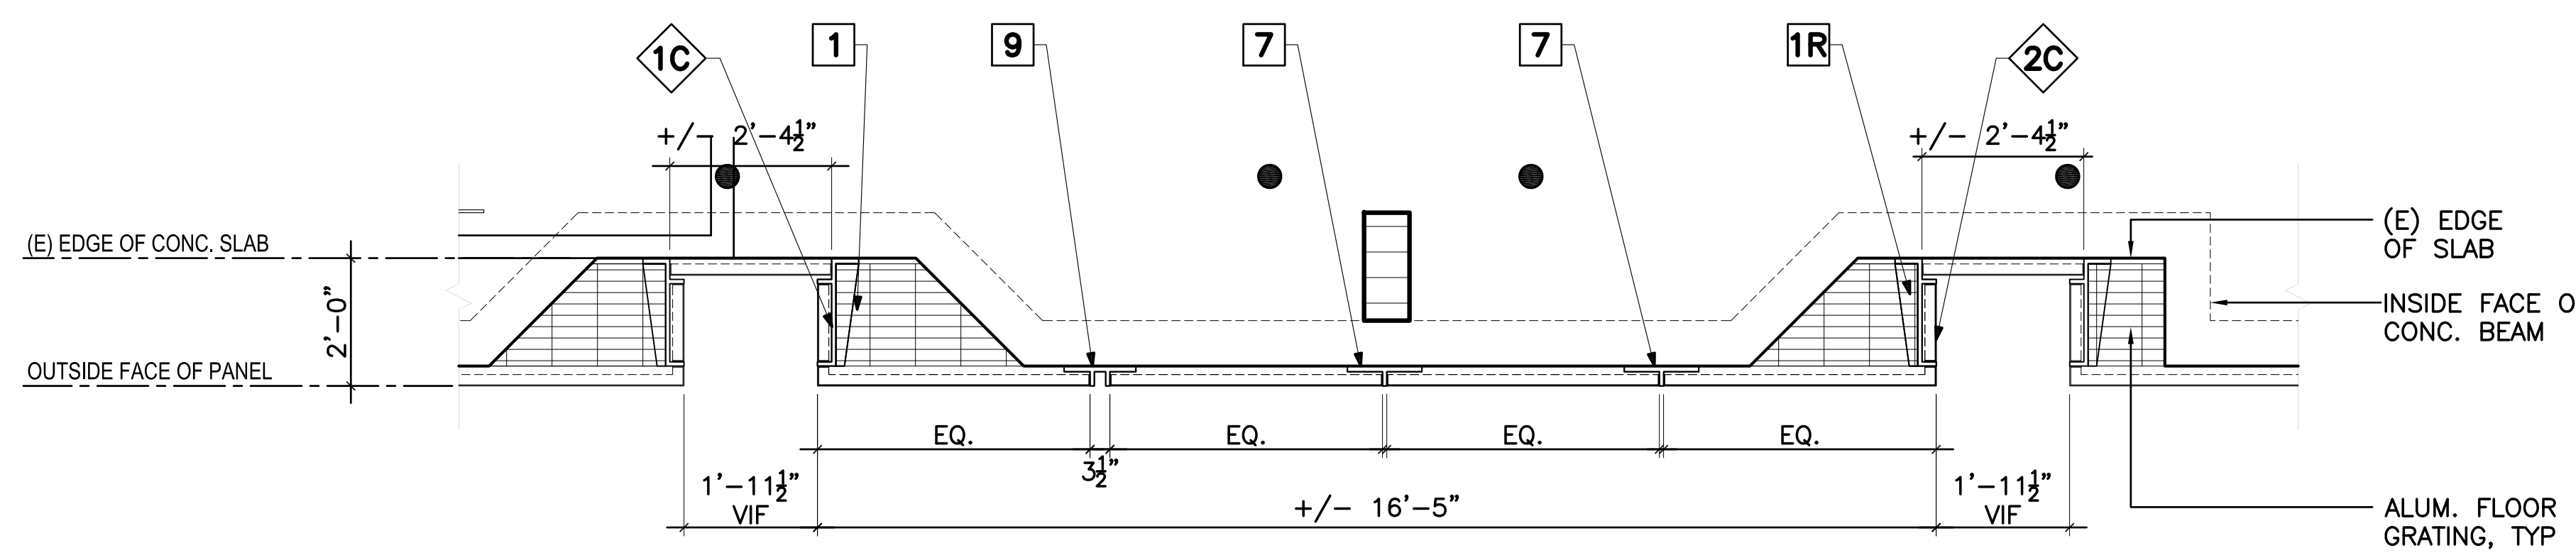

3 THIRD FLOOR PLAN - LOMBARD ST
SCALE: 1/2" = 1'-0"

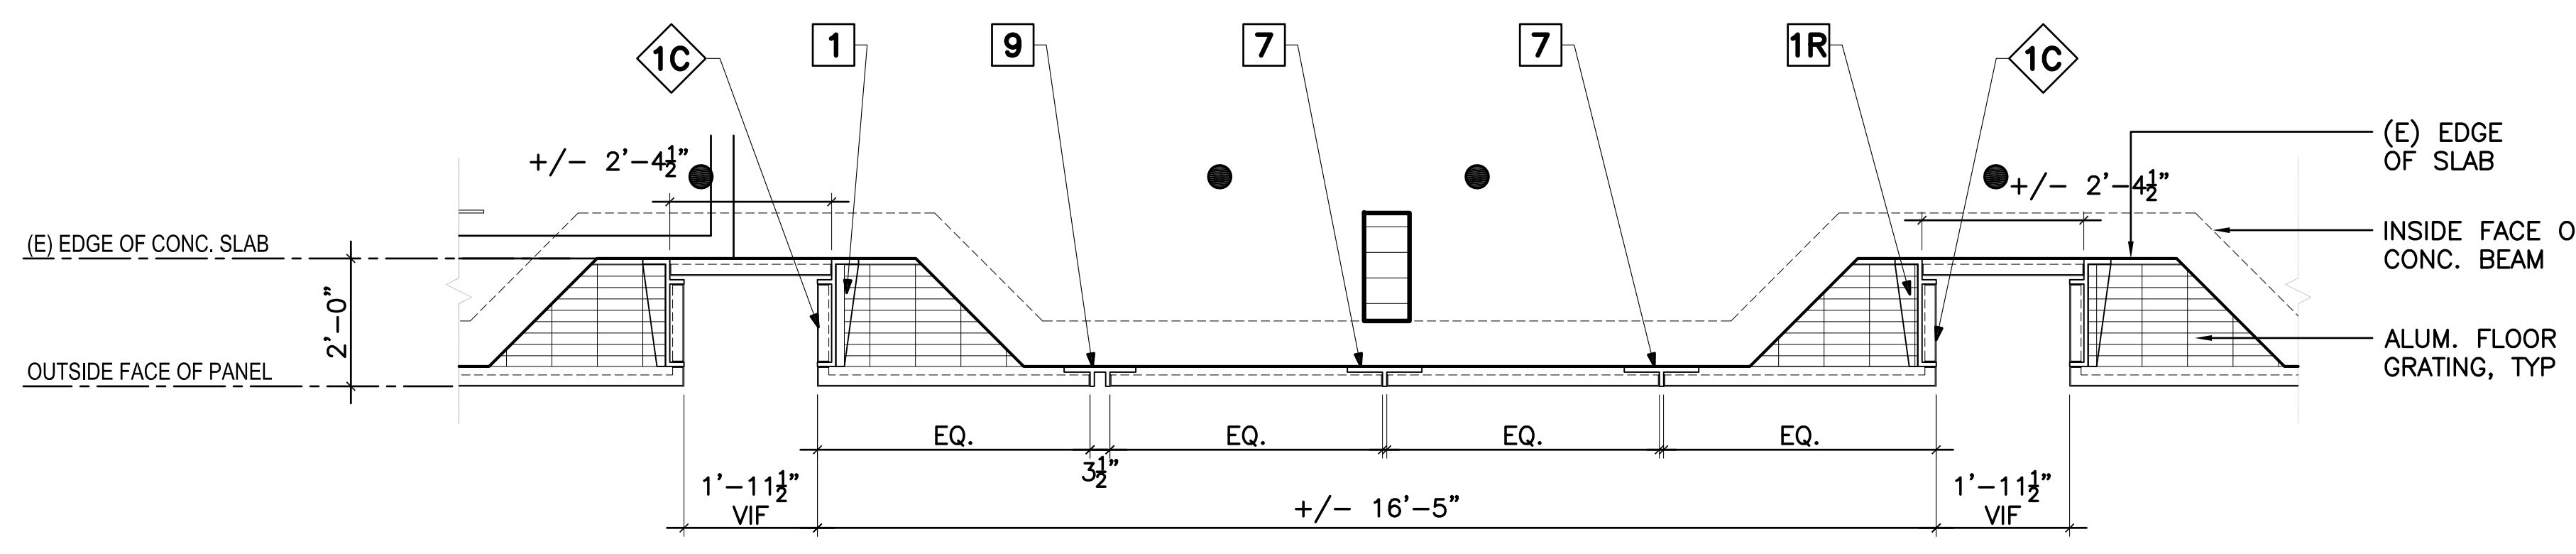

4 SECOND FLOOR PLAN - LOMBARD ST
SCALE: 1/2" = 1'-0"

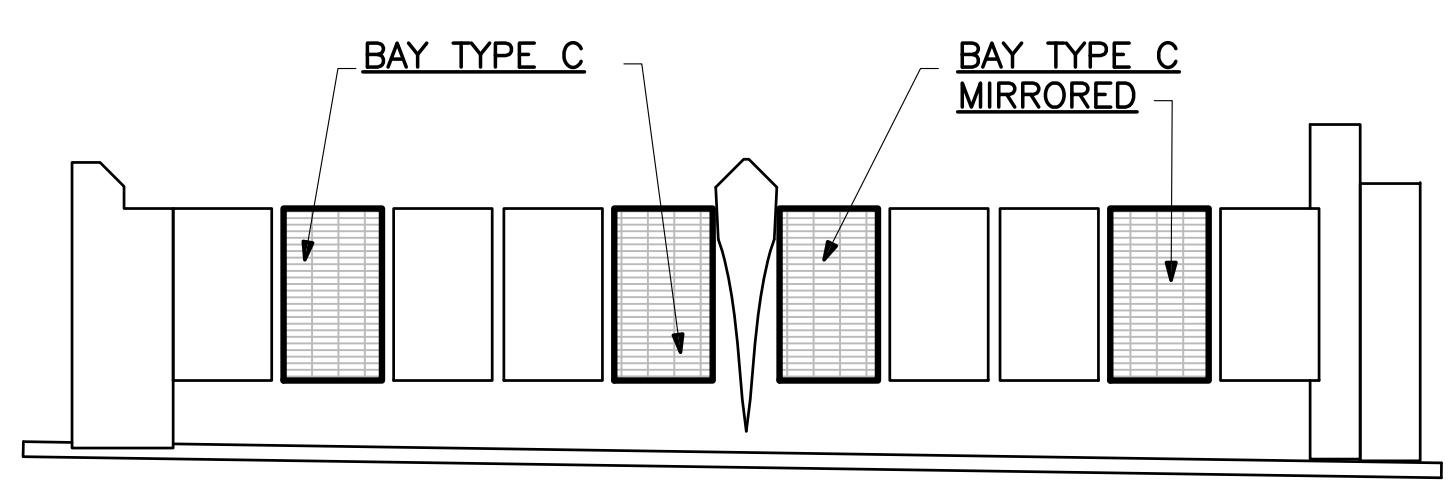

KEY ELEVATION - LOMBARD ST

LEGEND	
	BRACKET TYPE, REFER TO DRAWING A5.1
	PANEL TYPE, REFER TO DRAWING A4.1

GENERAL NOTES

- ALL PANELS MUST COMPLY WITH 2013 CALIFORNIA BUILDING CODE SECTION 1013 GUARDS
- ALUMINUM FLOOR PANELS TO BE PROVIDED BY ALUMINUM PANEL MANUFACTURER AS PART OF THE ALUMINUM PANEL SYSTEM

Issue
**BUILDING PERMIT ADDENDUM
AUGUST 4, 2016**

No.	Date	Revisions


Mark Dorian - Manager, Architecture Services
Drawn: SK
Proj. Arch: JOR
Proj. Mgr: DU
Section Head: TL
Phase: CD
ARCHITECT OF RECORD



PANEL BAY TYPE C

Sheet No. **A4.3**
Scale: AS NOTED
Job No. 8026A

Original Drawing Size: 30" x 42" Drawing name: P:\2026A Lombard Street Garage Waterproofing\5.0_Design\5.01_Current\CAD\Floor\A4.3_ENLARGED.BAY TYPE C ELEVATION.dwg Plotted on: Aug 09, 2016 - 12:07pm


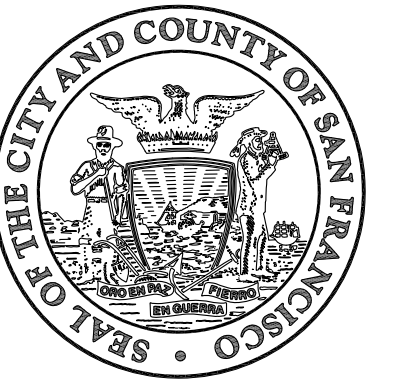


Julia Laue - Principal Architect/Division Manager
30 Van Ness Avenue Suite 4100
San Francisco, CA (415) 557-4700
94102-6028 Fax (415) 557-4701


Project
**LOMBARD PARKING GARAGE
IMPROVEMENTS**

2055 LOMBARD STREET
SAN FRANCISCO
CALIFORNIA 94133


Consultant

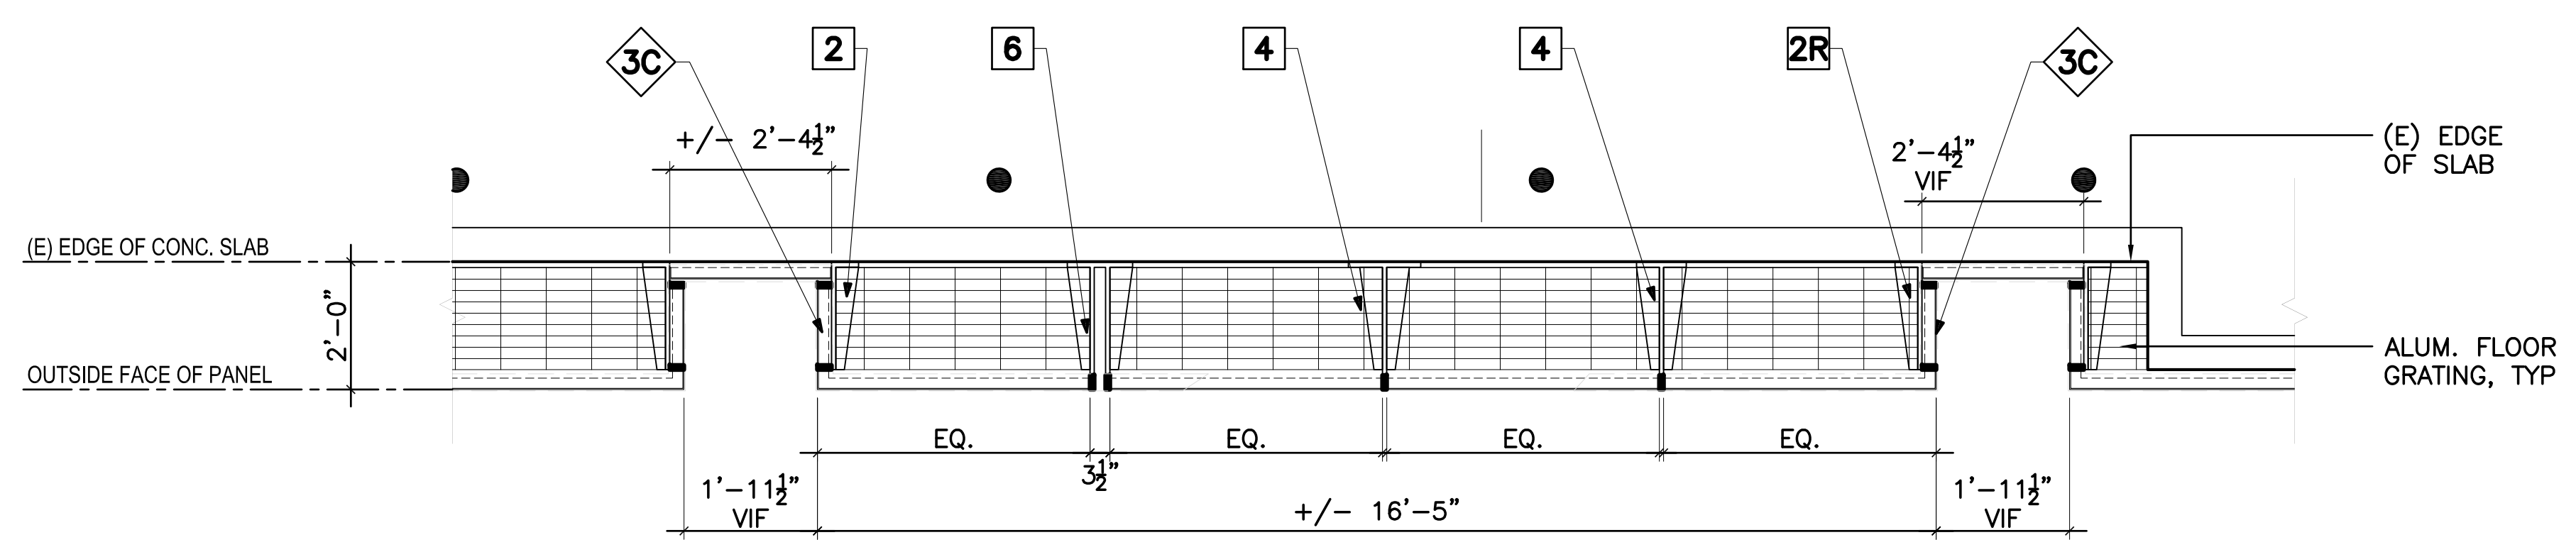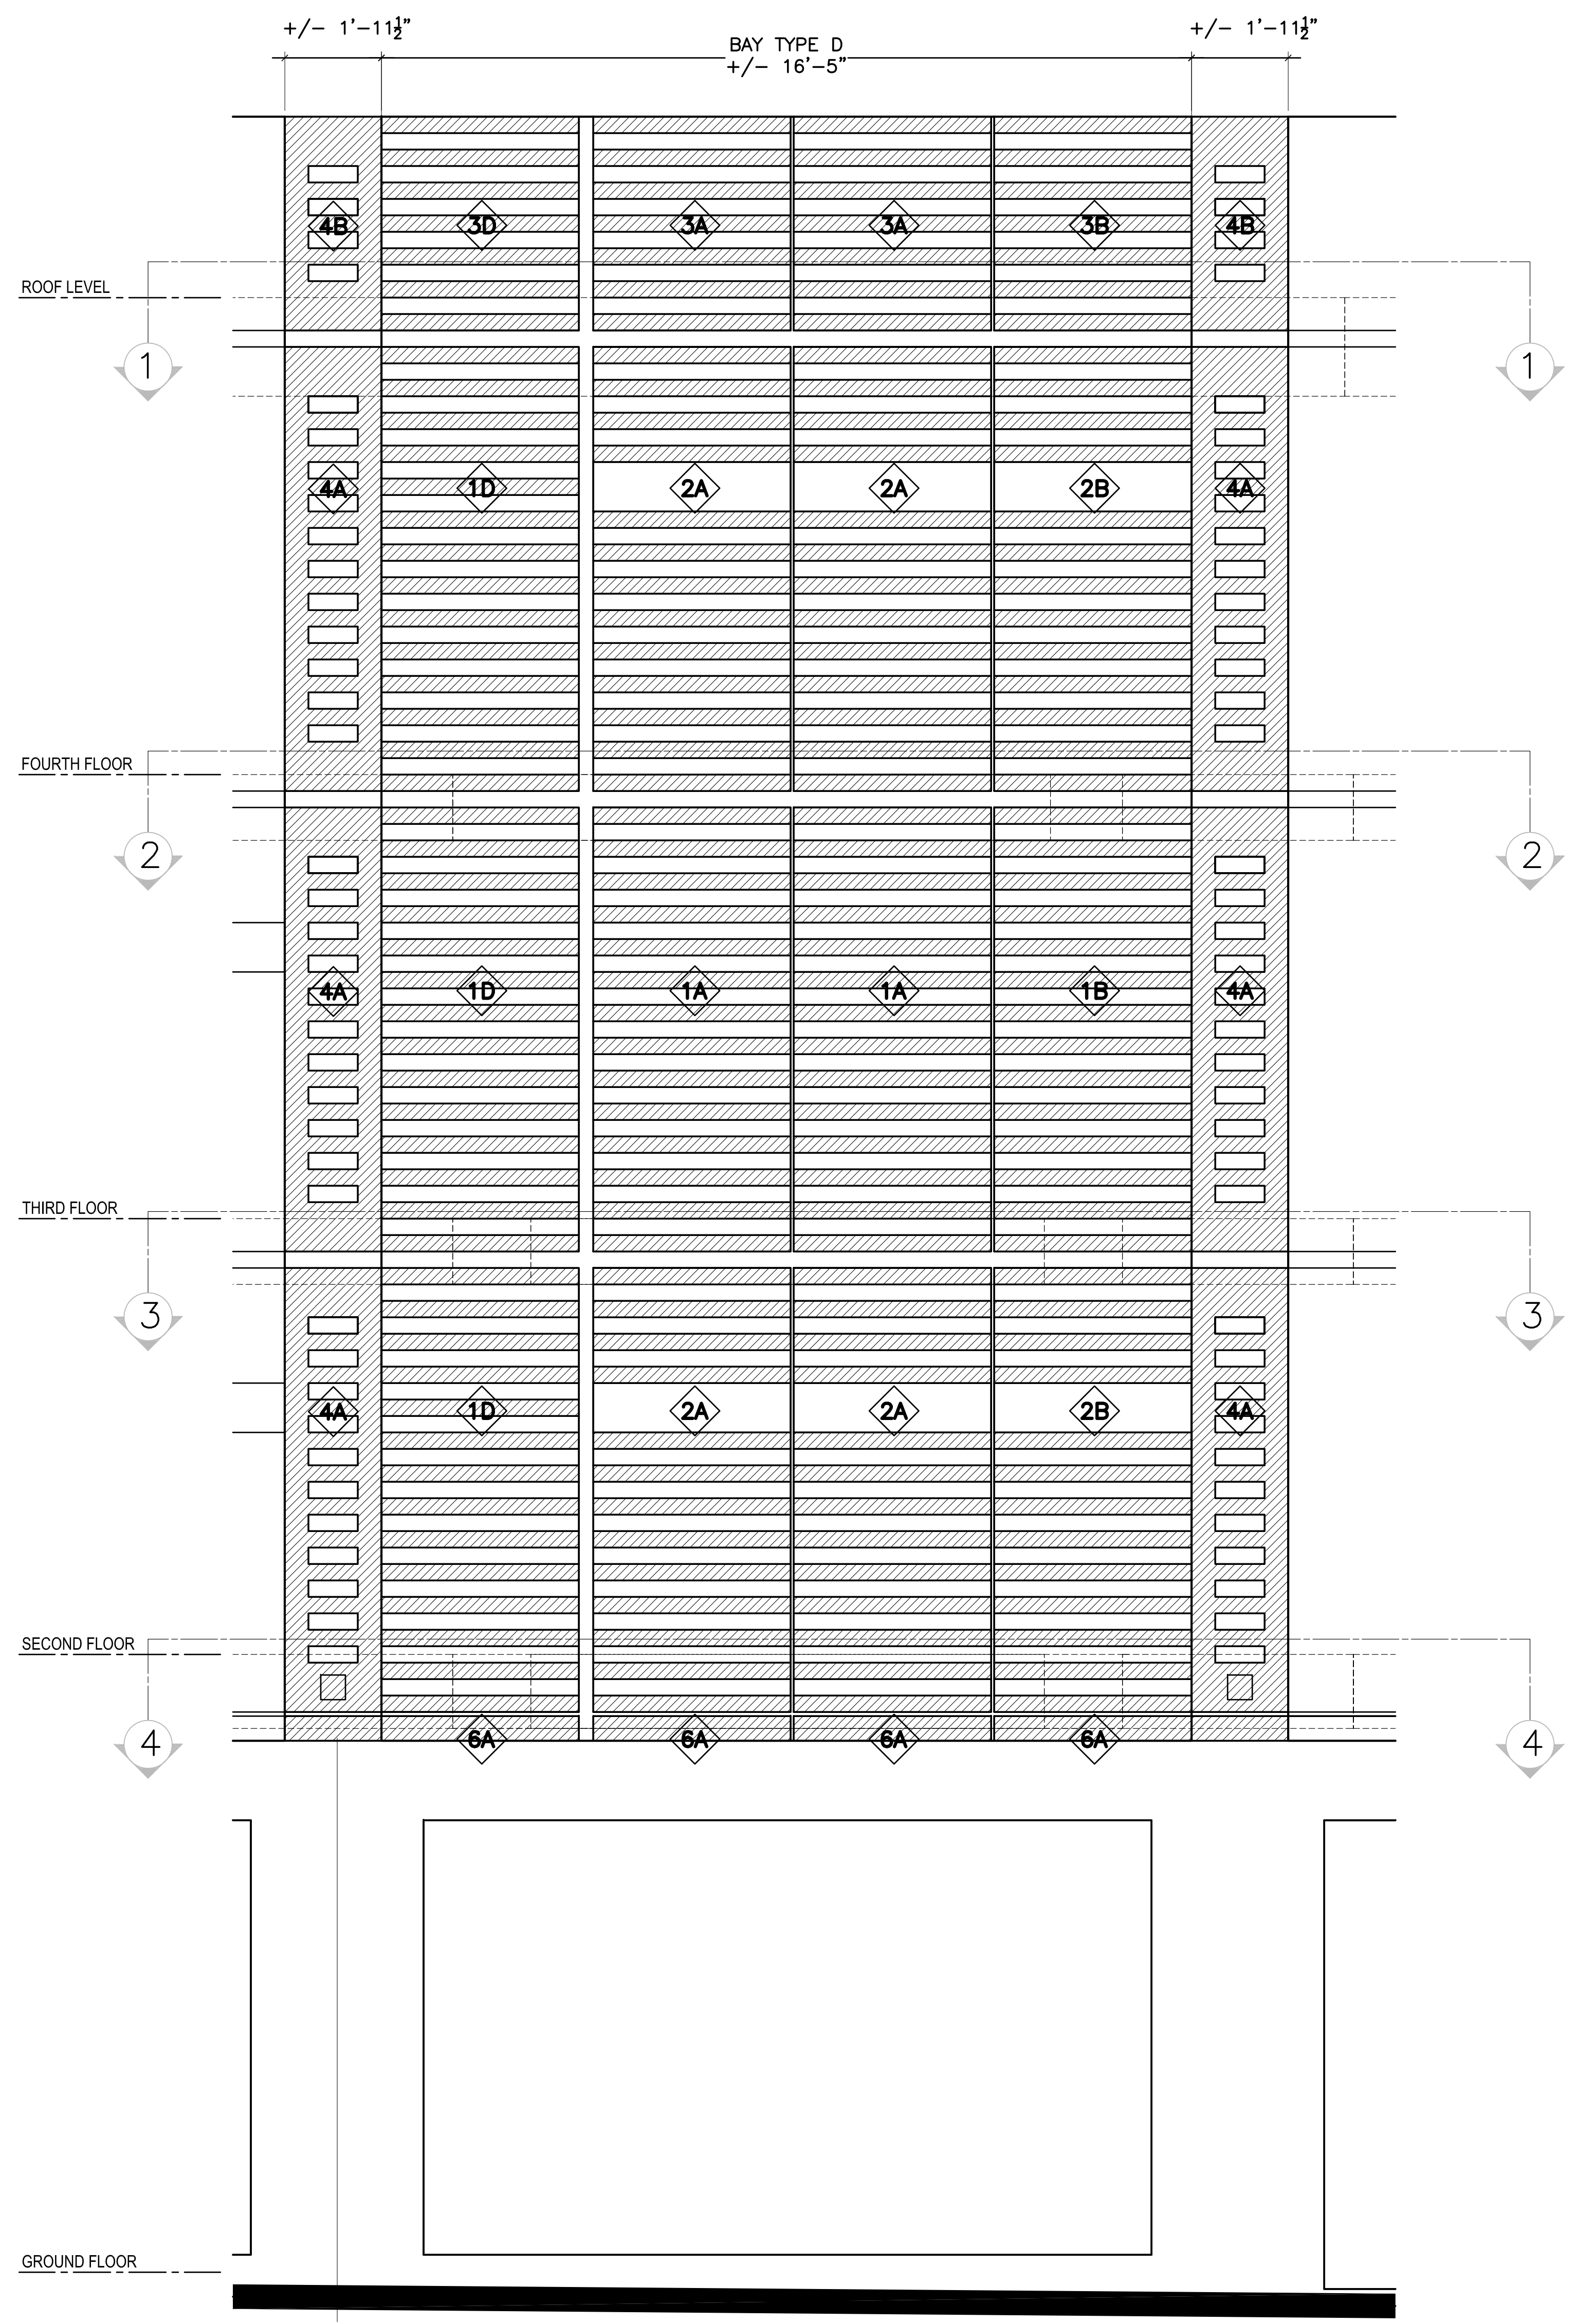


1 ROOF PLAN - LOMBARD ST
SCALE: 1/2" = 1'-0"

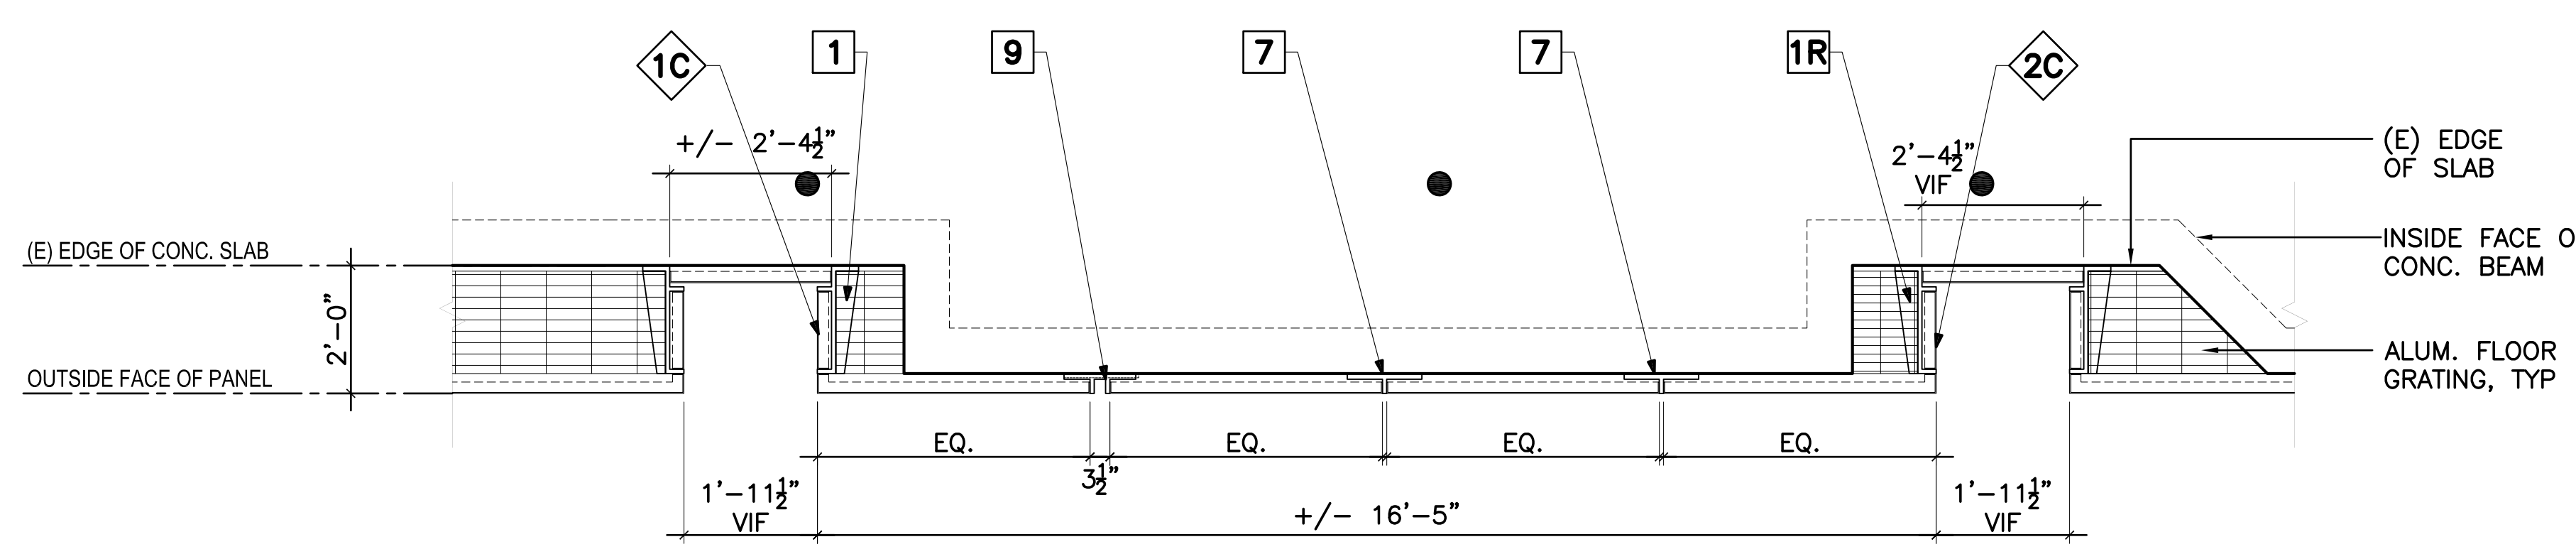


2 FOURTH FLOOR PLAN - LOMBARD ST
SCALE: 1/2" = 1'-0"

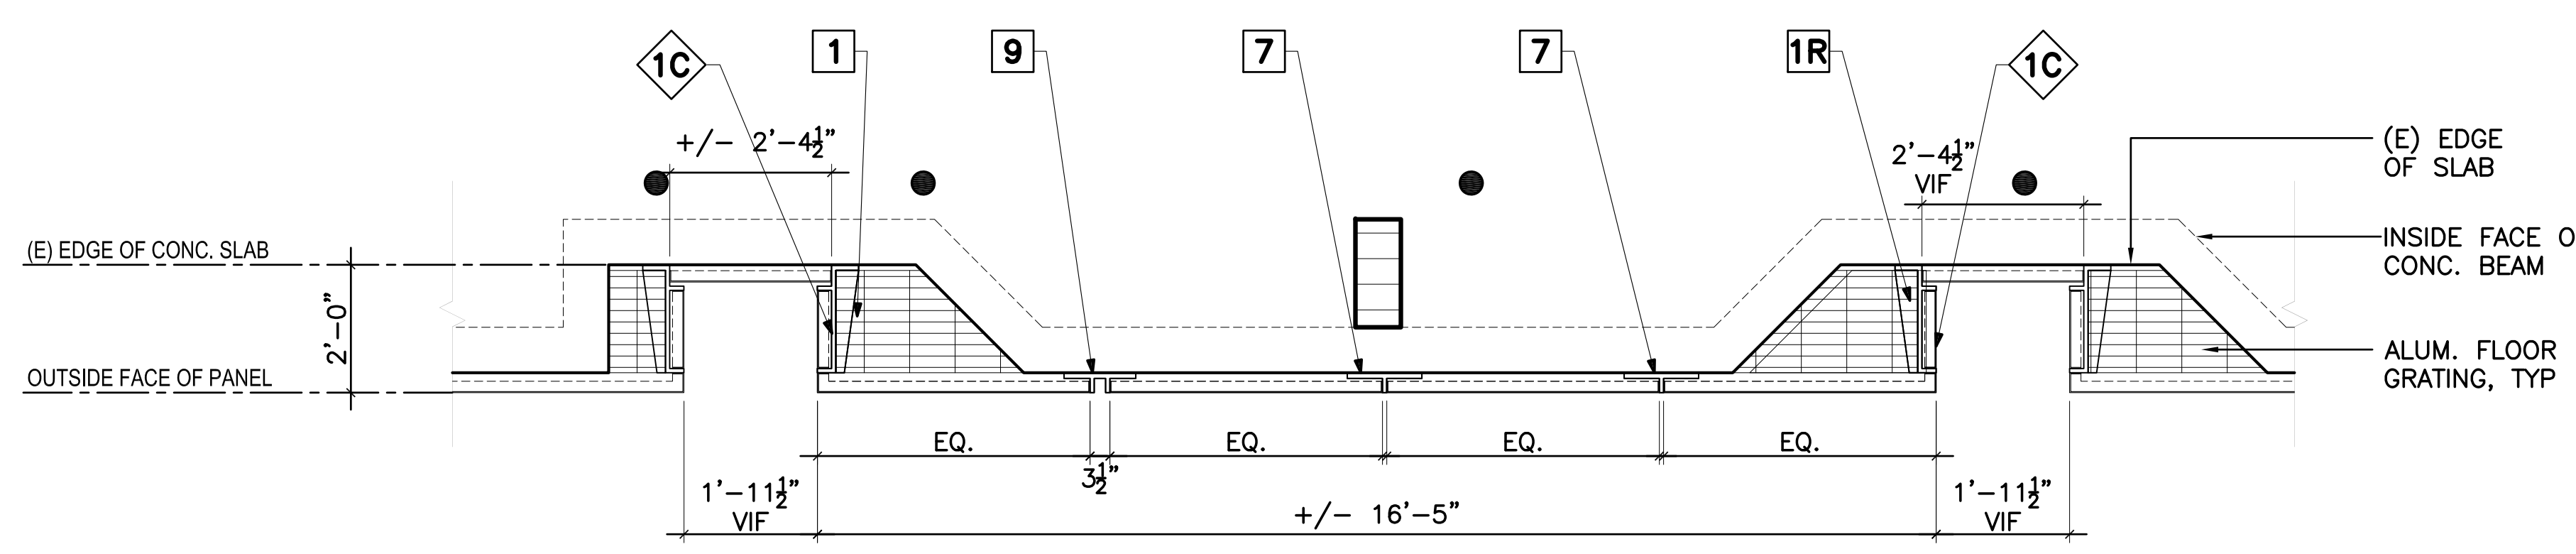

3 THIRD FLOOR PLAN - LOMBARD ST
SCALE: 1/2" = 1'-0"

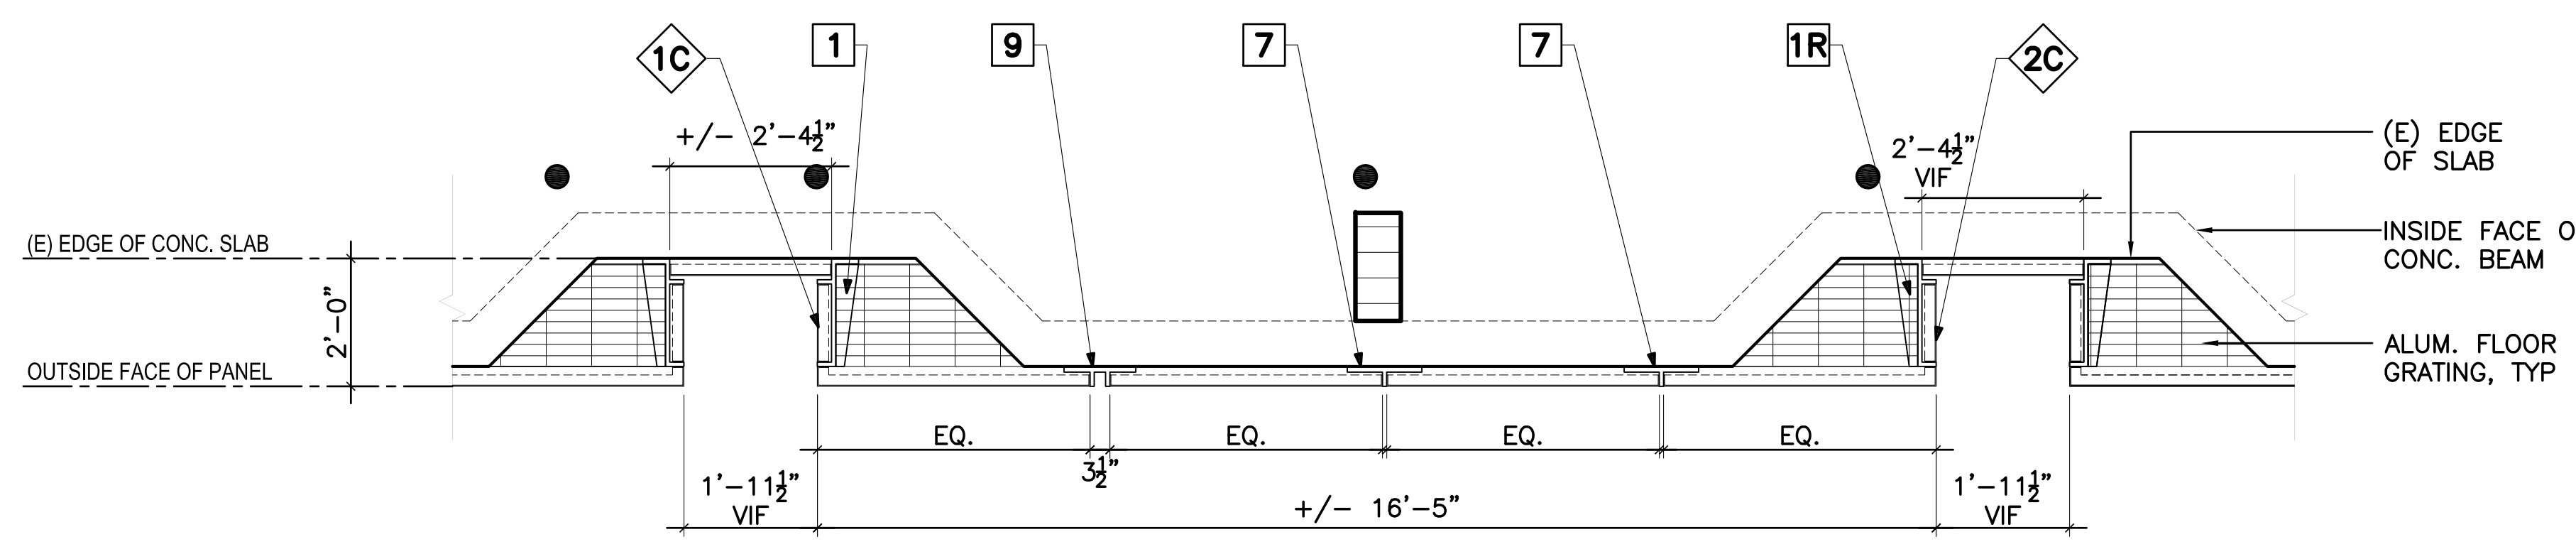

4 SECOND FLOOR PLAN - LOMBARD ST
SCALE: 1/2" = 1'-0"

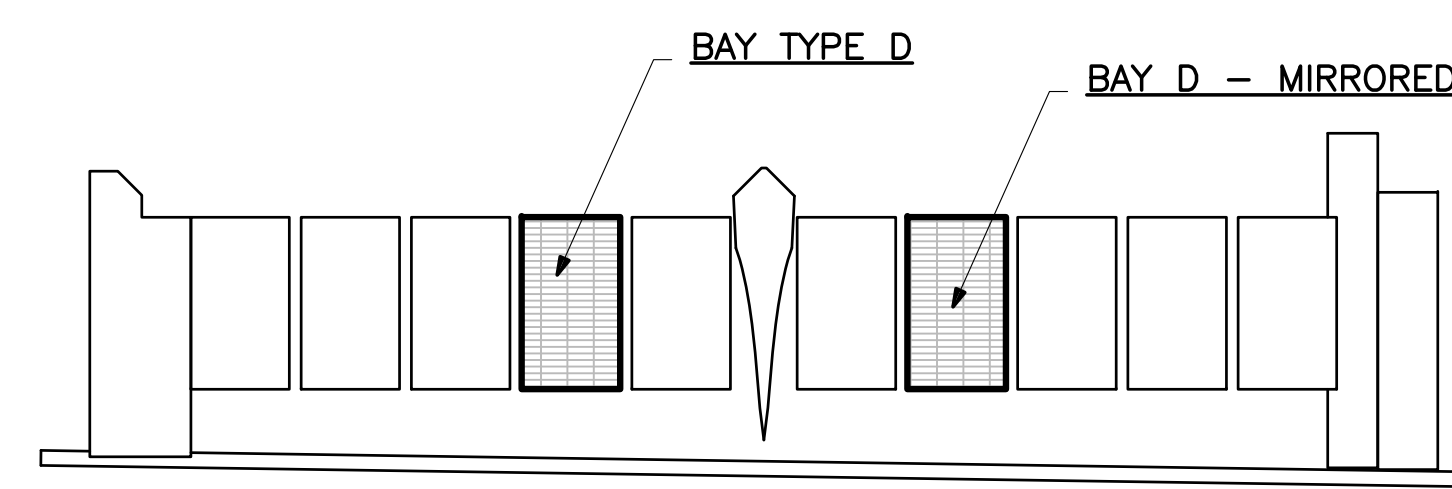

KEY ELEVATION - LOMBARD ST

LEGEND	
#	BRACKET TYPE, REFER TO DRAWING A5.1
◆	PANEL TYPE, REFER TO DRAWING A4.1

5 PANEL BAY TYPE D
SCALE: 1/2" = 1'-0"

GENERAL NOTES

- ALL PANELS MUST COMPLY WITH 2013 CALIFORNIA BUILDING CODE SECTION 1013 GUARDS
- ALUMINUM FLOOR PANELS TO BE PROVIDED BY ALUMINUM PANEL MANUFACTURER AS PART OF THE ALUMINUM PANEL SYSTEM

Issue
**BUILDING PERMIT ADDENDUM
AUGUST 4, 2016**

No.	Date	Revisions

Mark Dorian - Manager, Architecture Services
Drawn SK
Proj. Arch. JOR
Proj. Mgr. DU
Section Head TL
Phase CD
ARCHITECT OF RECORD



PANEL BAY TYPE D


Sheet No.

A4.4

Scale AS NOTED


Job No. 8026A

Original Drawing Size: 30" x 42" Drawing name: P:\2026A Lombard Street Garage Waterproofing\5.0_Design\5.01_Current\CAD\Fig44_4_ENLARGED_BAY_TYPE_D_ELEVATION.dwg Plotted on: Aug 09, 2016 - 12:06pm

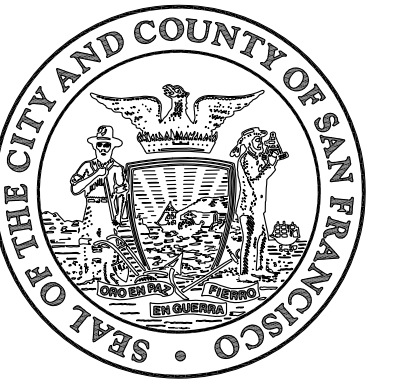


Julia Laue - Principal Architect/Division Manager
30 Van Ness Avenue, Suite 4100
San Francisco, CA 94102-6028 (415) 557-4700
Fax (415) 5574701


Project: **LOMBARD PARKING GARAGE
IMPROVEMENTS**
2055 LOMBARD STREET
SAN FRANCISCO
CALIFORNIA 94133
Consultant:

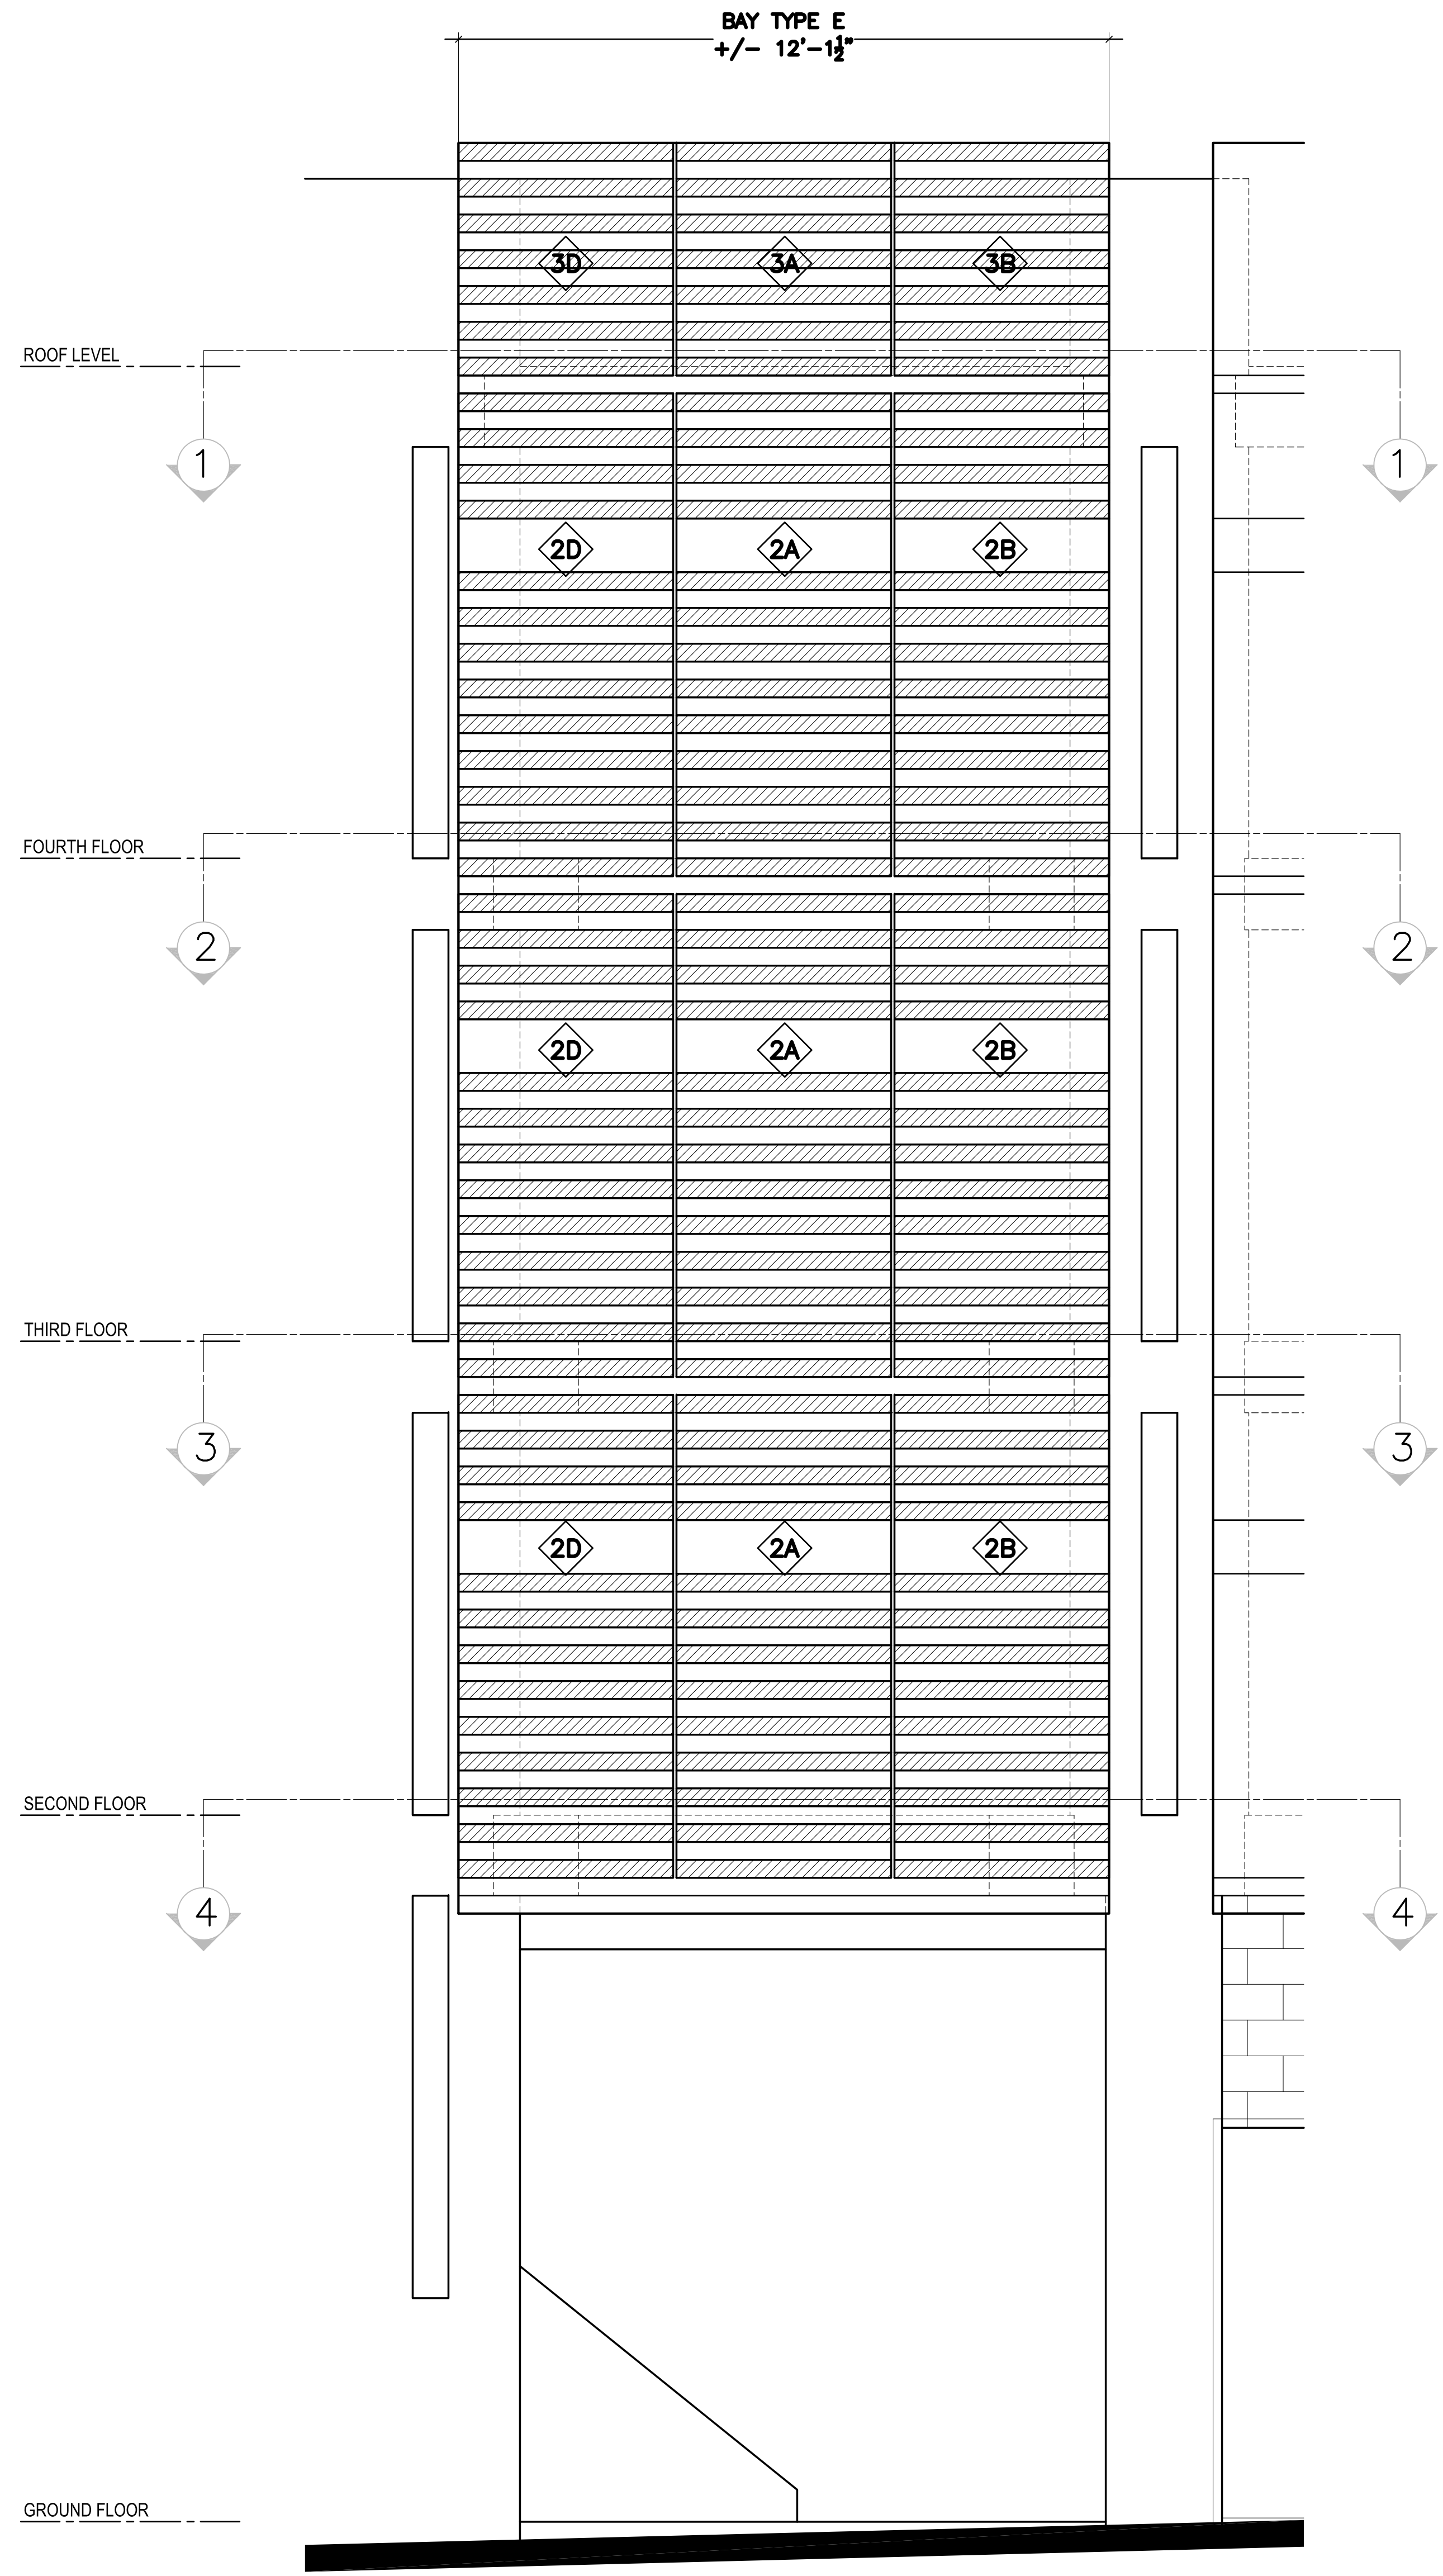


6 PANEL BAY TYPE F
SCALE: 1/2" = 1'-0"

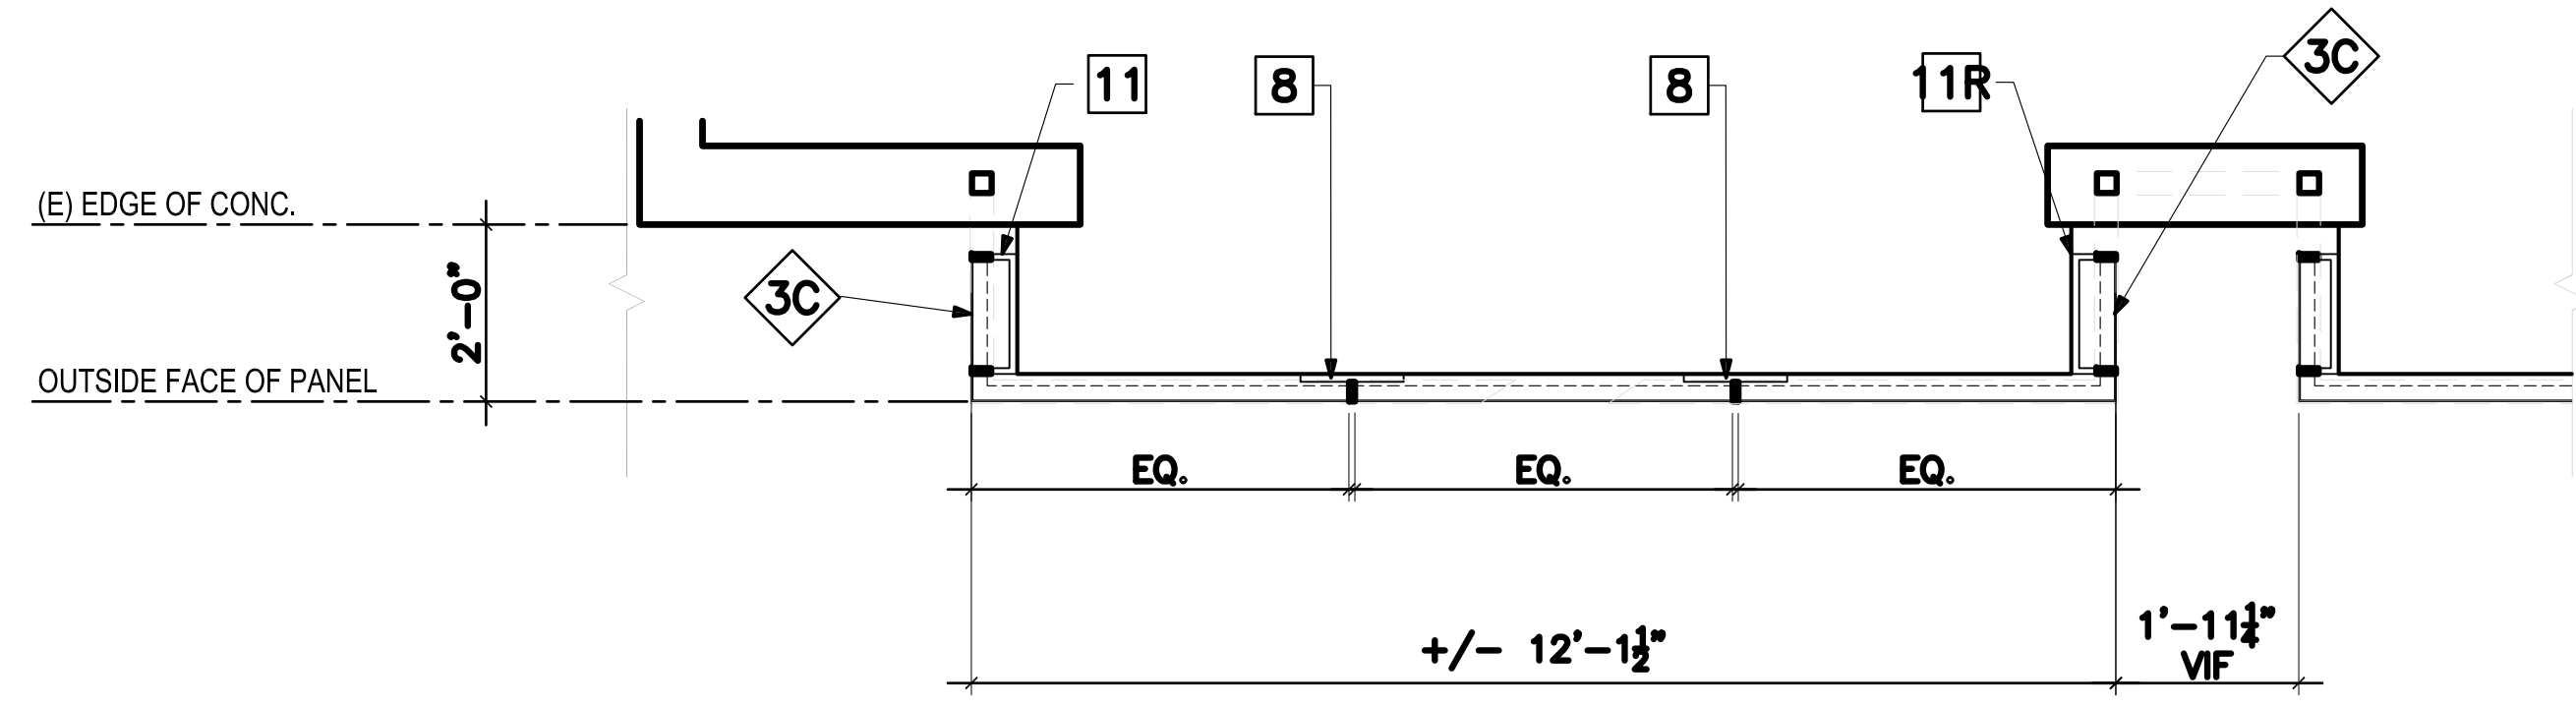


1 ROOF PLAN - MOULTON ST
SCALE: 1/2" = 1'-0"

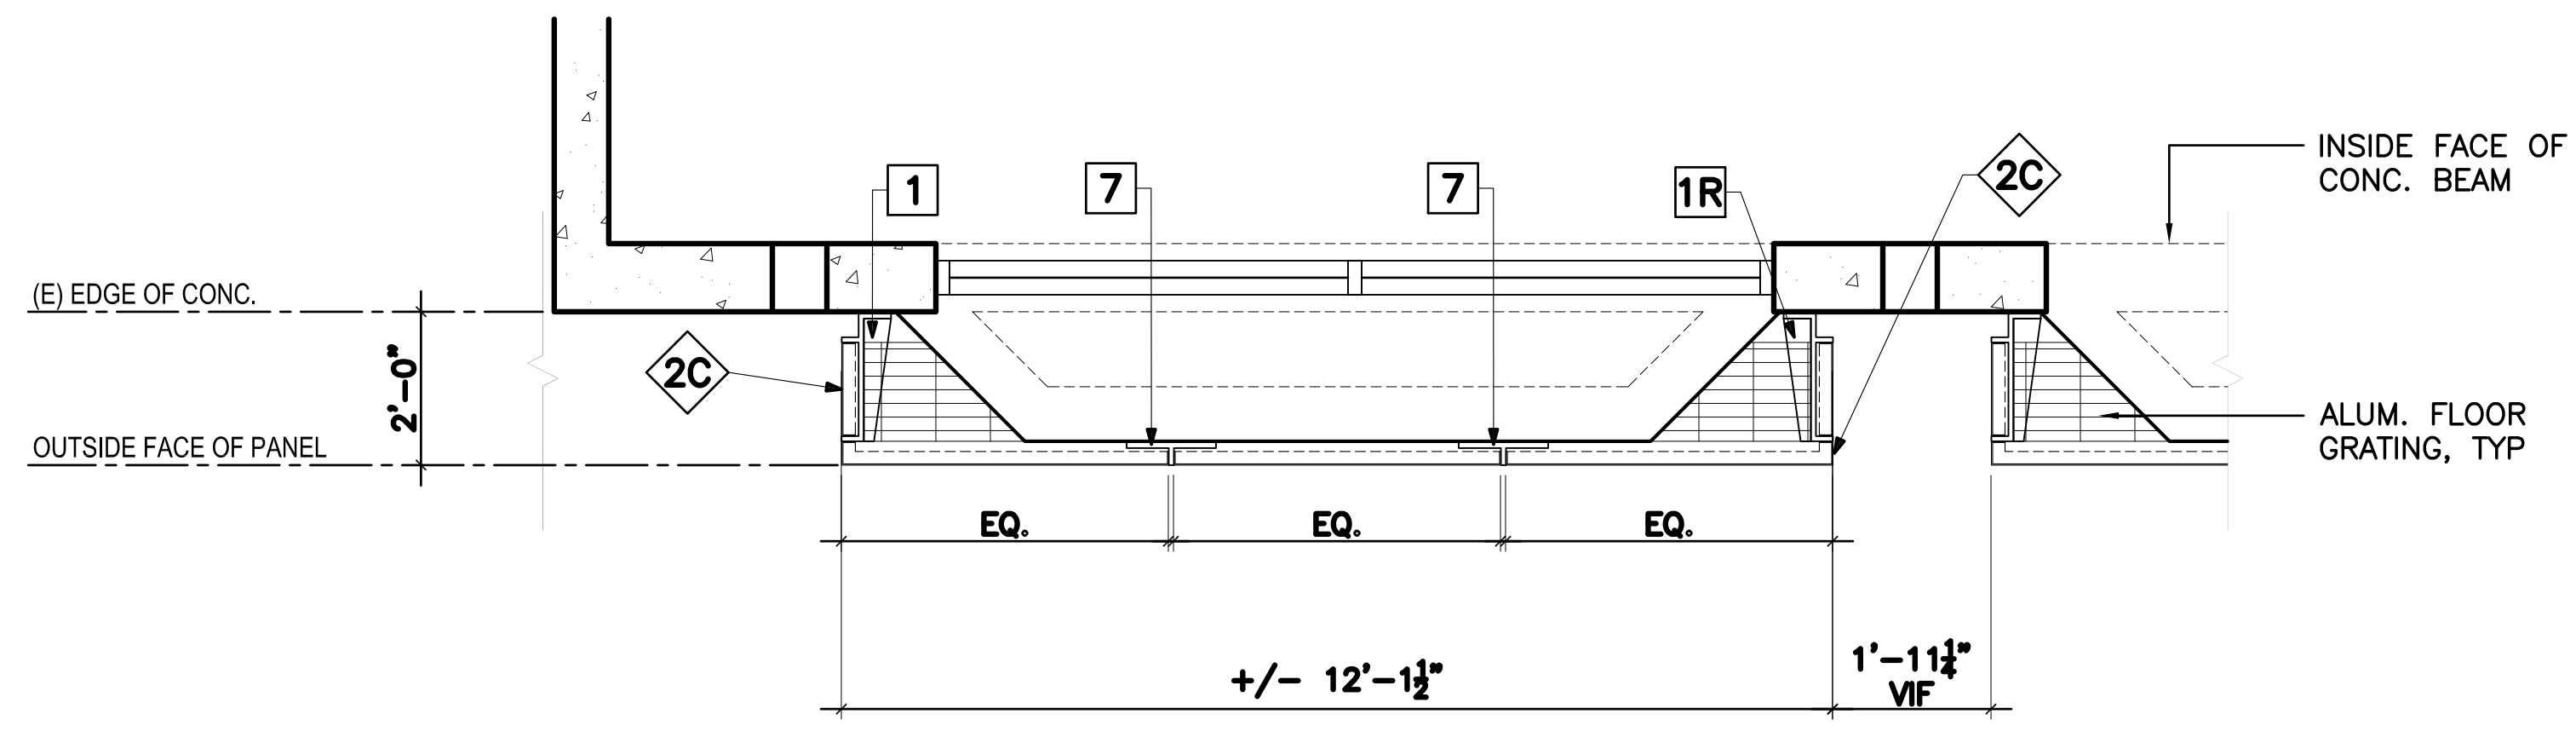


2 FOURTH FLOOR PLAN - MOULTON ST
SCALE: 1/2" = 1'-0"

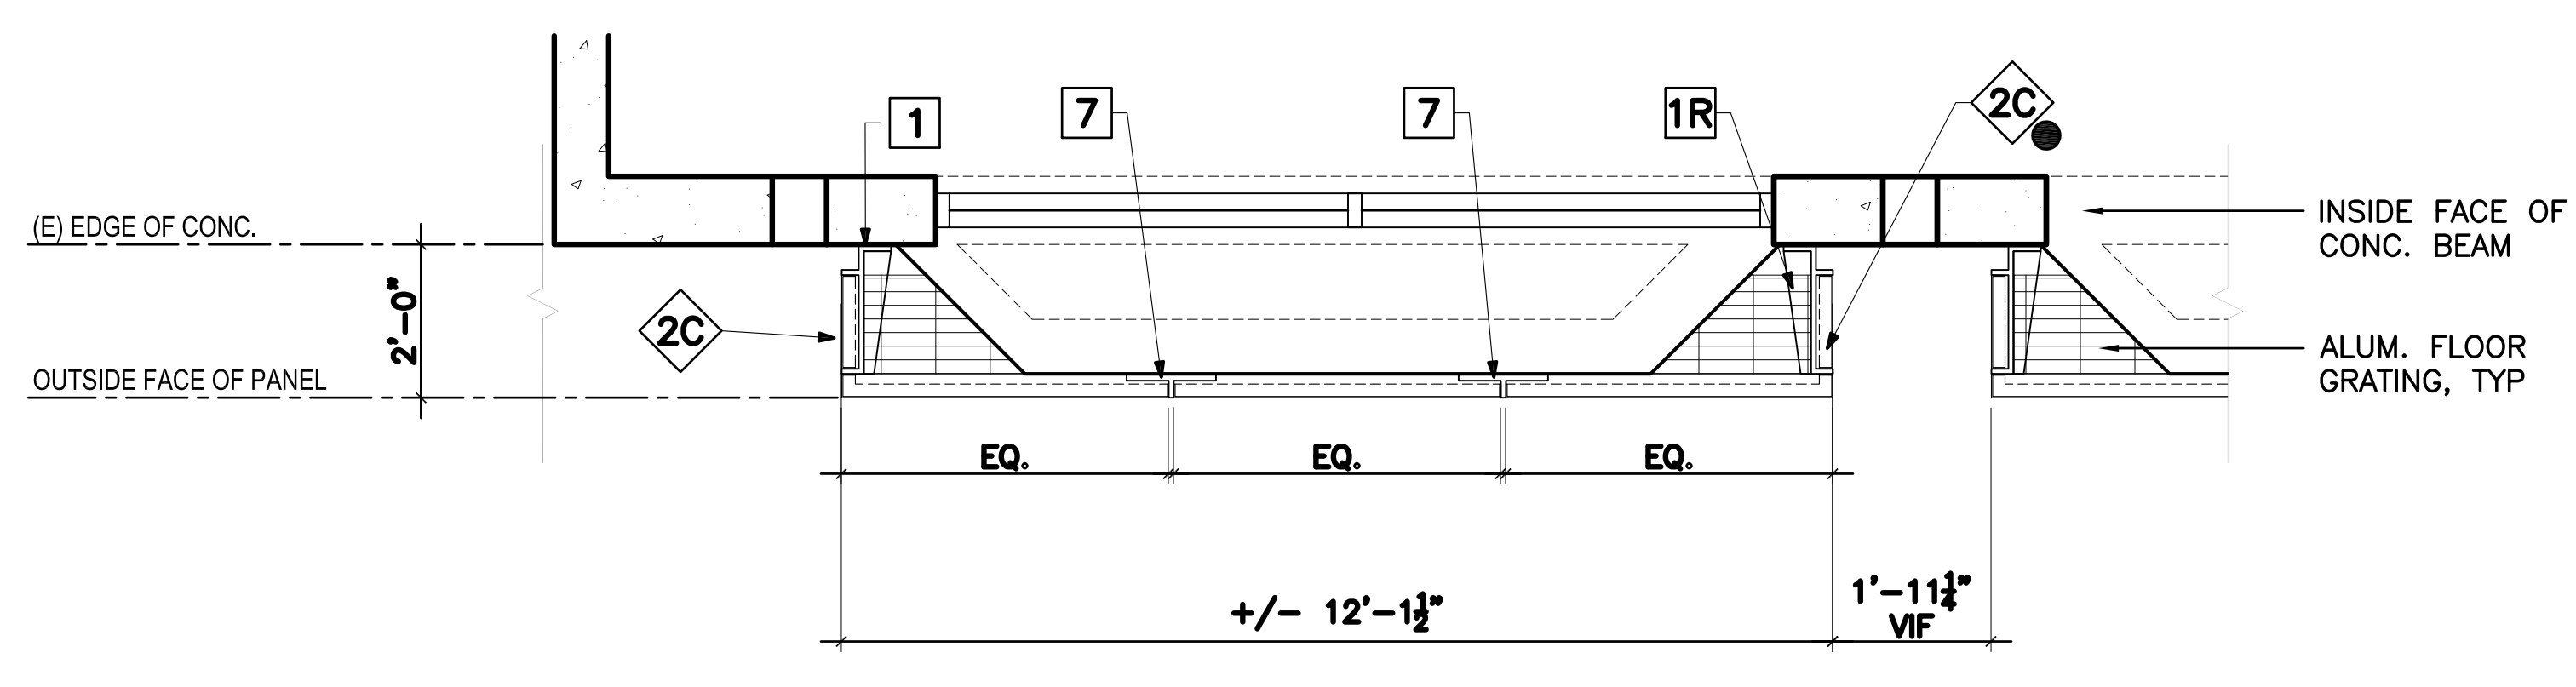

3 THIRD FLOOR PLAN - MOULTON ST
SCALE: 1/2" = 1'-0"

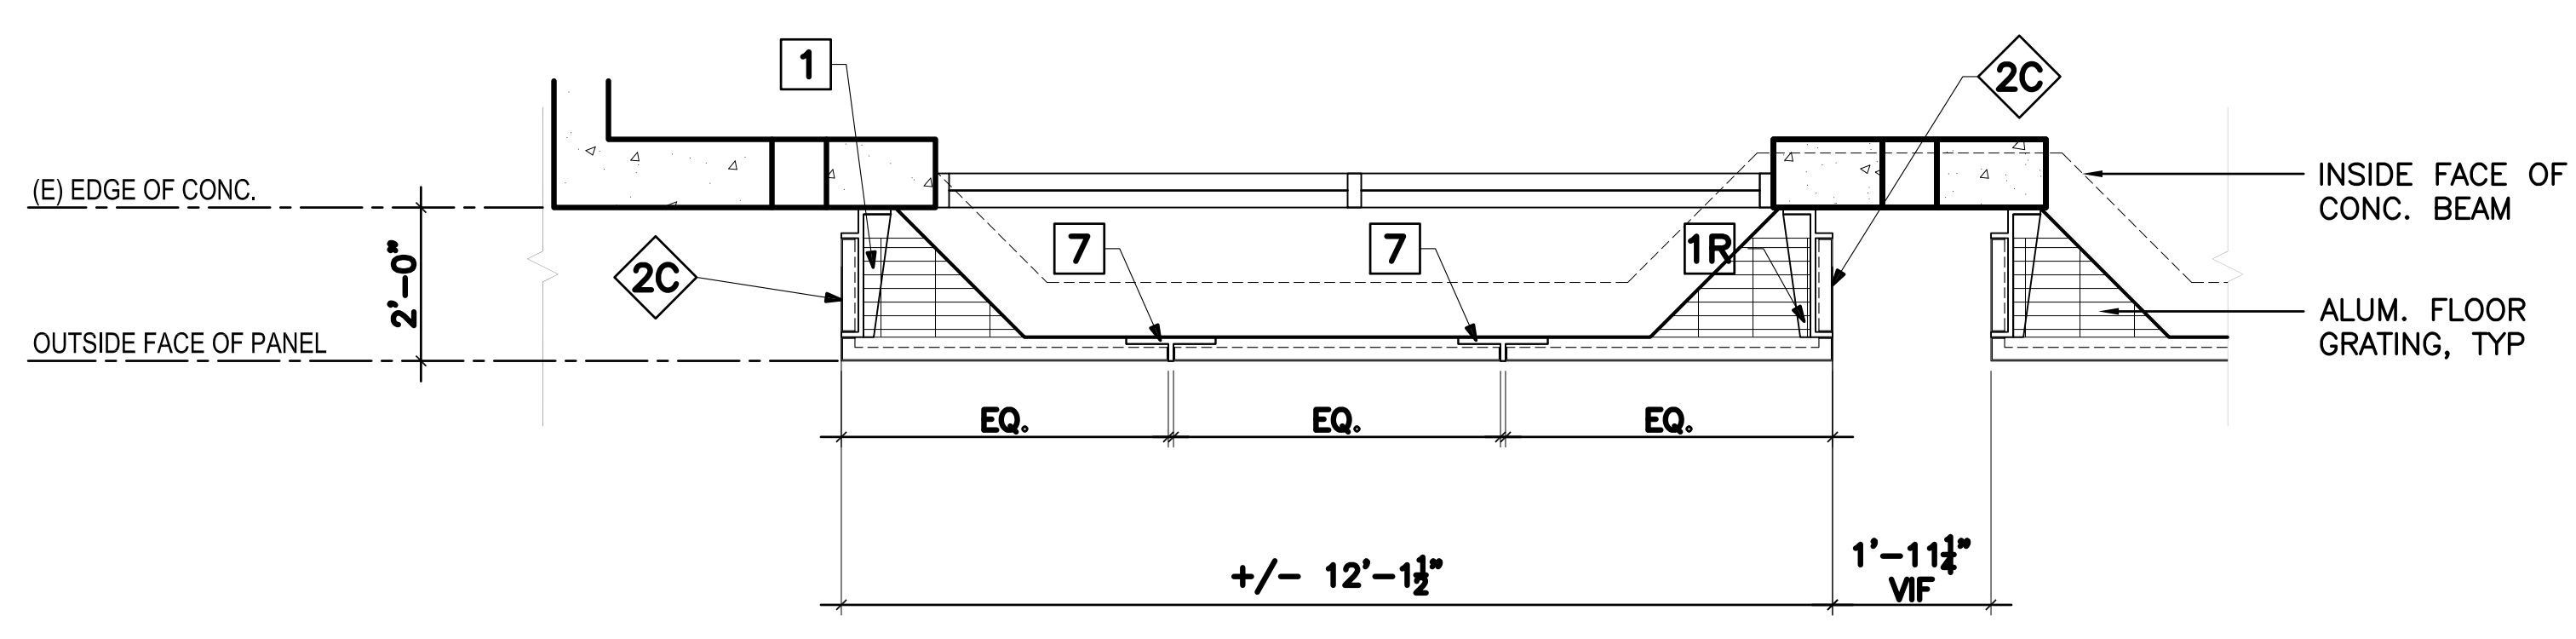

4 SECOND FLOOR PLAN - MOULTON ST
SCALE: 1/2" = 1'-0"

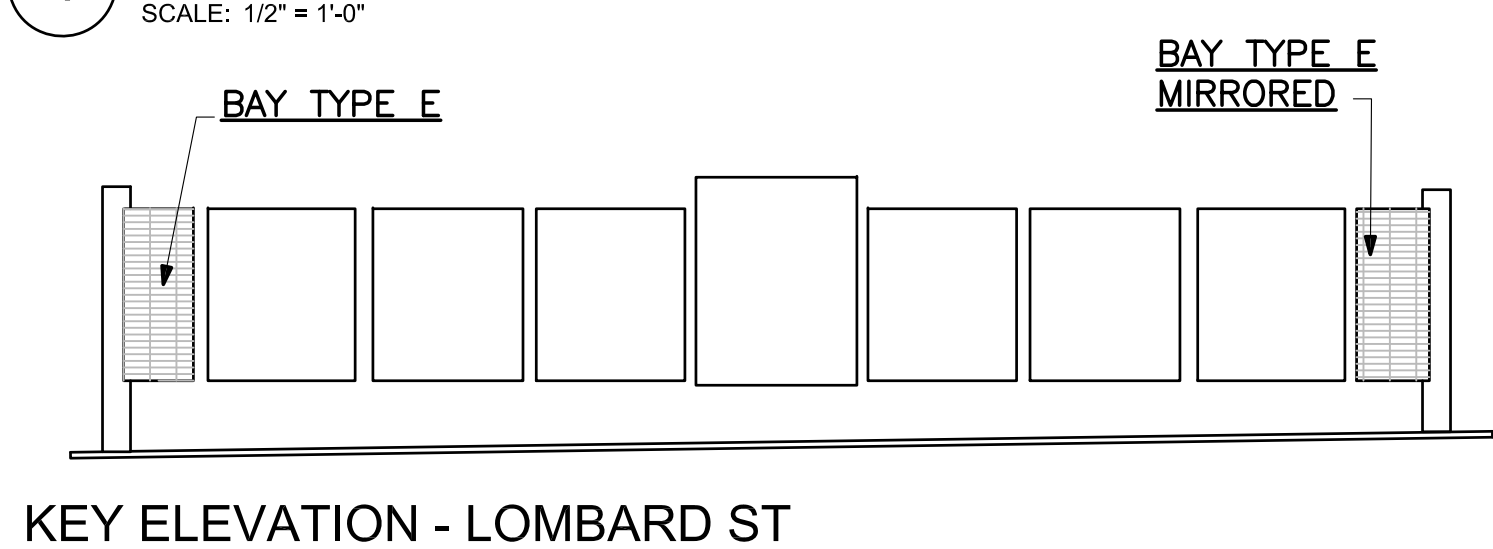

KEY ELEVATION - LOMBARD ST

LEGEND	
	BRACKET TYPE, REFER TO DRAWING A5.1
	PANEL TYPE, REFER TO DRAWING A4.1

GENERAL NOTES

- ALL PANELS MUST COMPLY WITH 2013 CALIFORNIA BUILDING CODE SECTION 1013 GUARDS
- ALUMINUM FLOOR PANELS TO BE PROVIDED BY ALUMINUM PANEL MANUFACTURER AS PART OF THE ALUMINUM PANEL SYSTEM

Issue: **BUILDING PERMIT ADDENDUM
AUGUST 4, 2016**

No.	Date	Revisions


Mark Dorian - Manager, Architecture Services
Drawn: SK
Proj. Arch: JOR
Proj. Mgr: DU
Section Head: TL
Phase: CD
ARCHITECT OF RECORD



Drawing Title: **PANEL BAY TYPE F**

Sheet No. **A4.5**
Scale: AS NOTED
Job No. 8026A

Original Drawing Size: 30" x 42" Drawing name: P:\2026A Lombard Street Garage Waterproofing\5.0_Design\5.01_Current\CAD\Fig44-5_ENLARGED_BAY TYPE F ELEVATION.dwg Plotter on: Aug 09, 2016 - 12:09pm

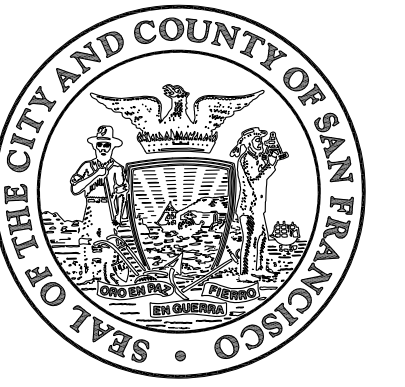

Julia Laue - Principal Architect/Division Manager
30 Van Ness Avenue Suite 4100
San Francisco, CA (415) 557-4700
94102-6028 Fax (415) 557-4701

Project _____

**LOMBARD PARKING GARAGE
IMPROVEMENTS**

2055 LOMBARD STREET
SAN FRANCISCO
CALIFORNIA 94133

Consultant _____


Issue _____

**BUILDING PERMIT ADDENDUM
AUGUST 4, 2016**

No.	Date	Revisions

Mark Dorian - Manager, Architecture Services

Drawn	SK
Proj. Arch.	JOR
Proj. Mgr.	DU
Section Head	TL
Phase	CD

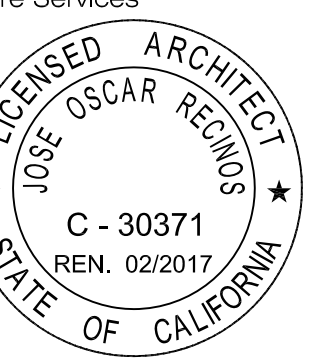

ARCHITECT OF RECORD

Drawing Title _____

PANEL BAY TYPE G



Sheet No. _____

A4.6


Scale AS NOTED

Job No. _____


8026A

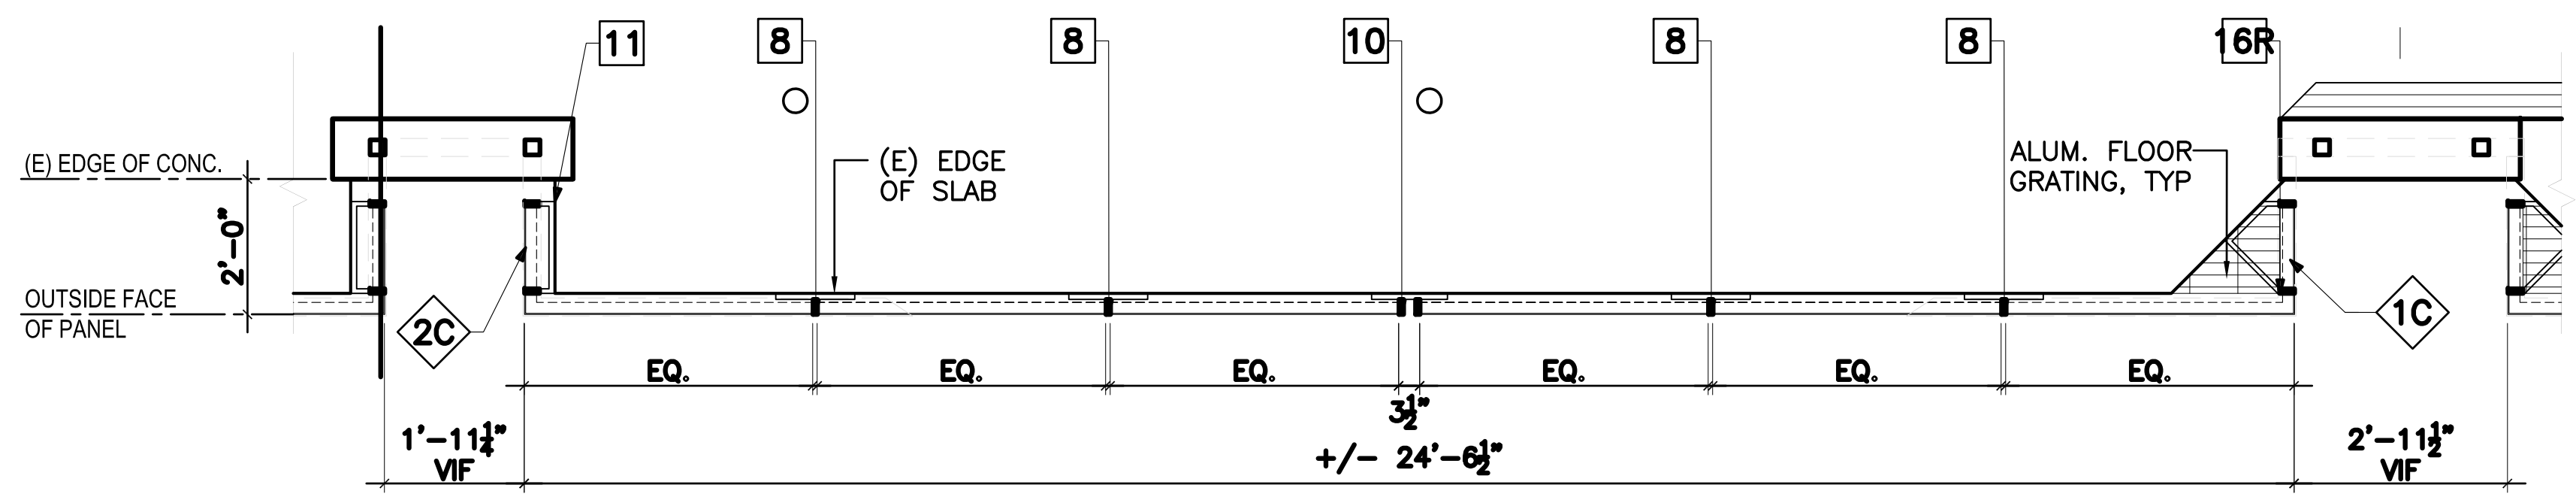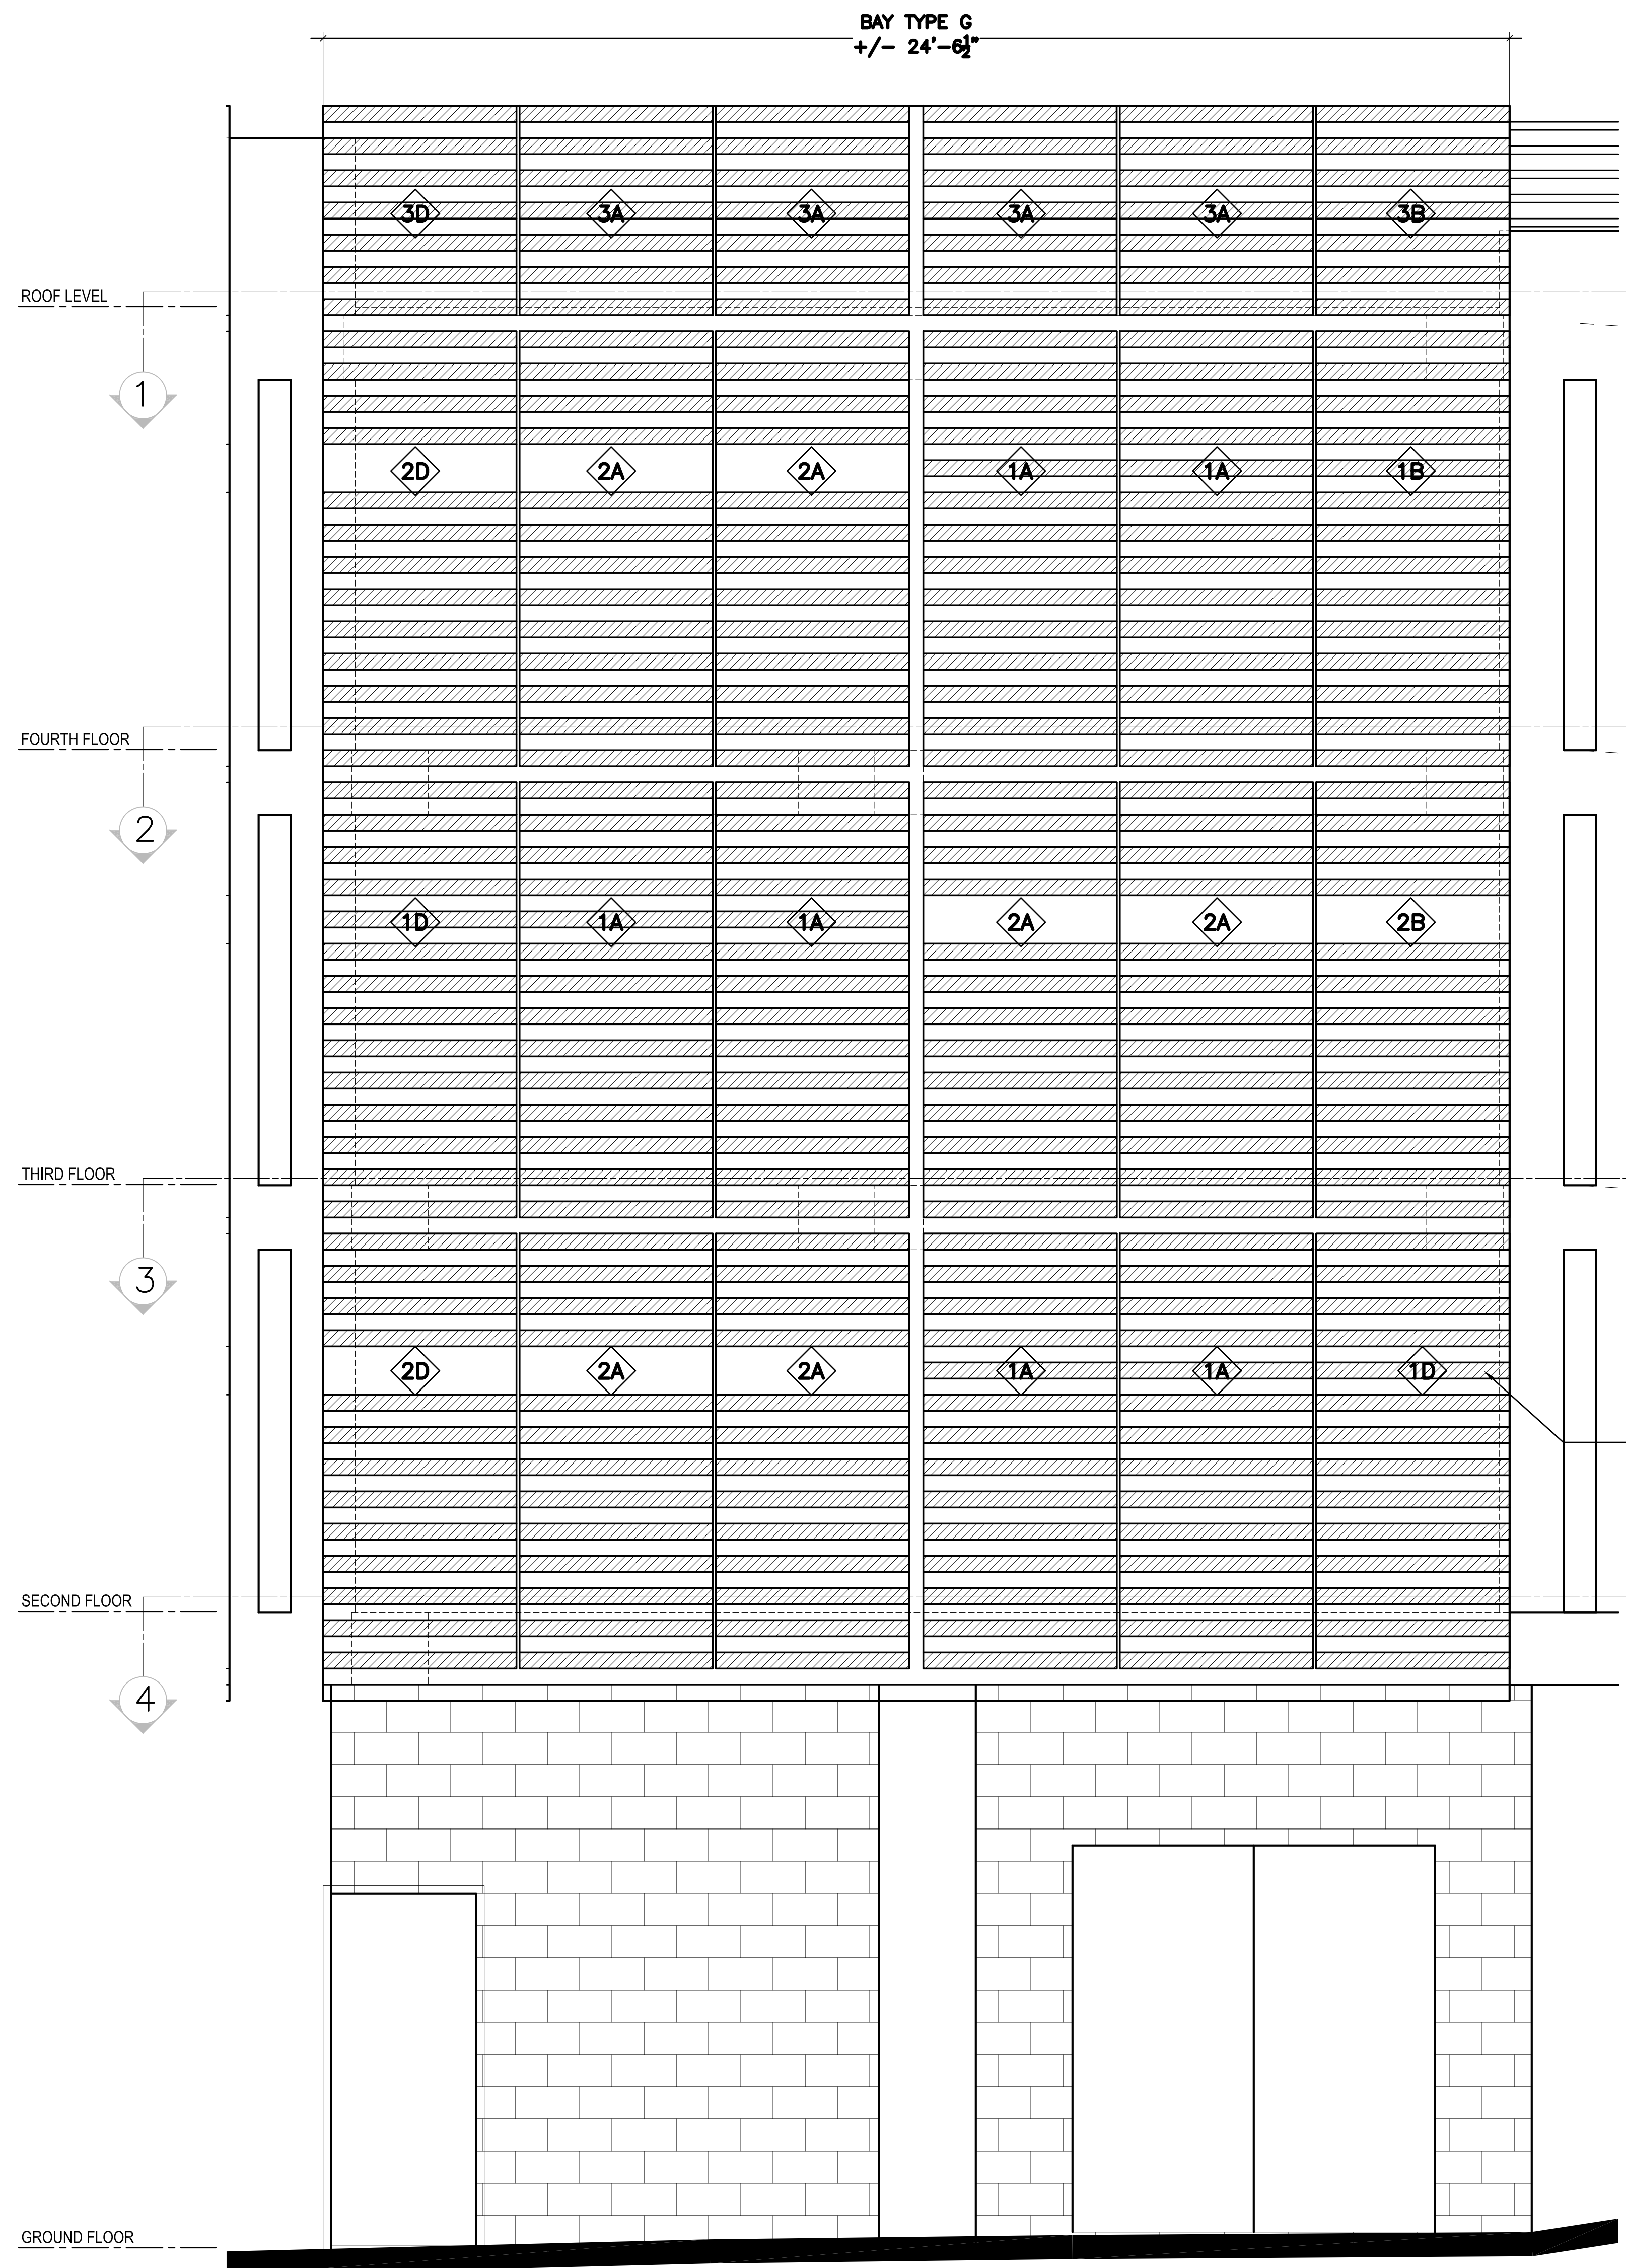


1 ROOF PLAN - MOULTON ST
SCALE: 1/2" = 1'-0"

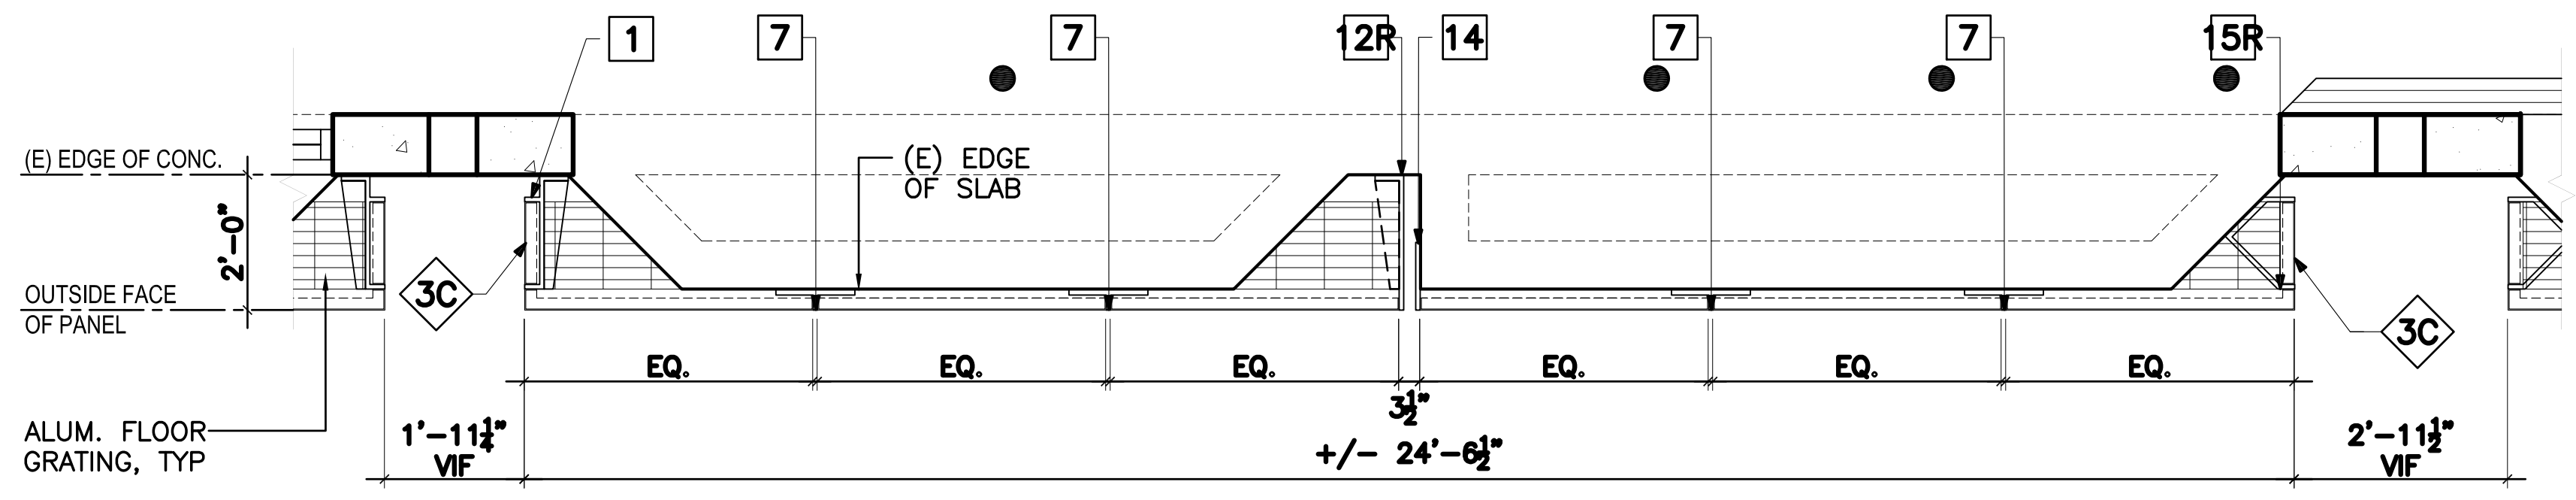


2 FOURTH FLOOR PLAN - MOULTON ST
SCALE: 1/2" = 1'-0"

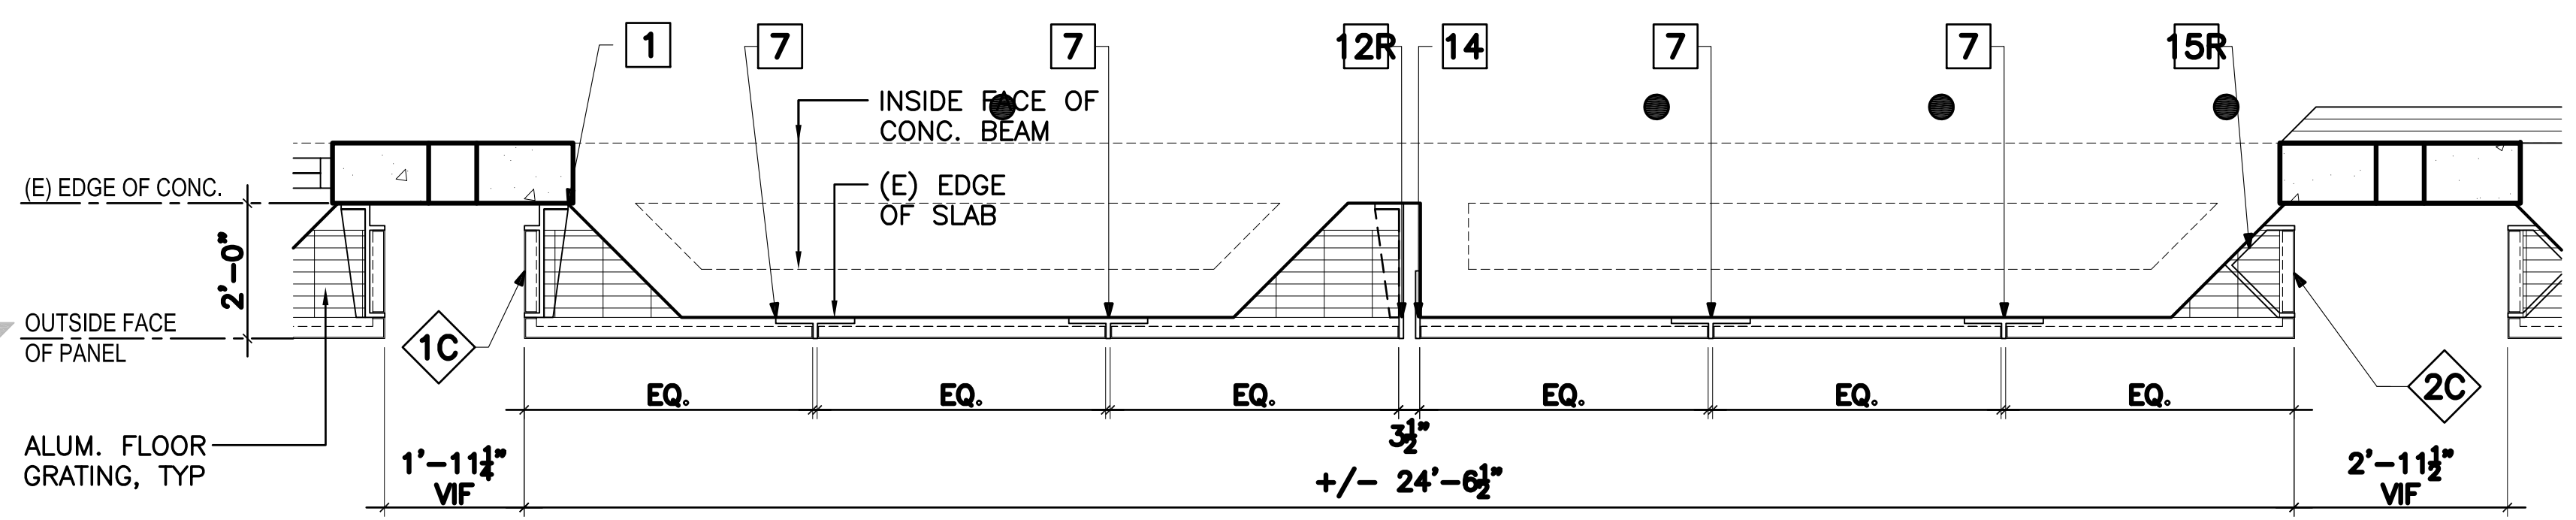

3 THIRD FLOOR PLAN - MOULTON ST
SCALE: 1/2" = 1'-0"

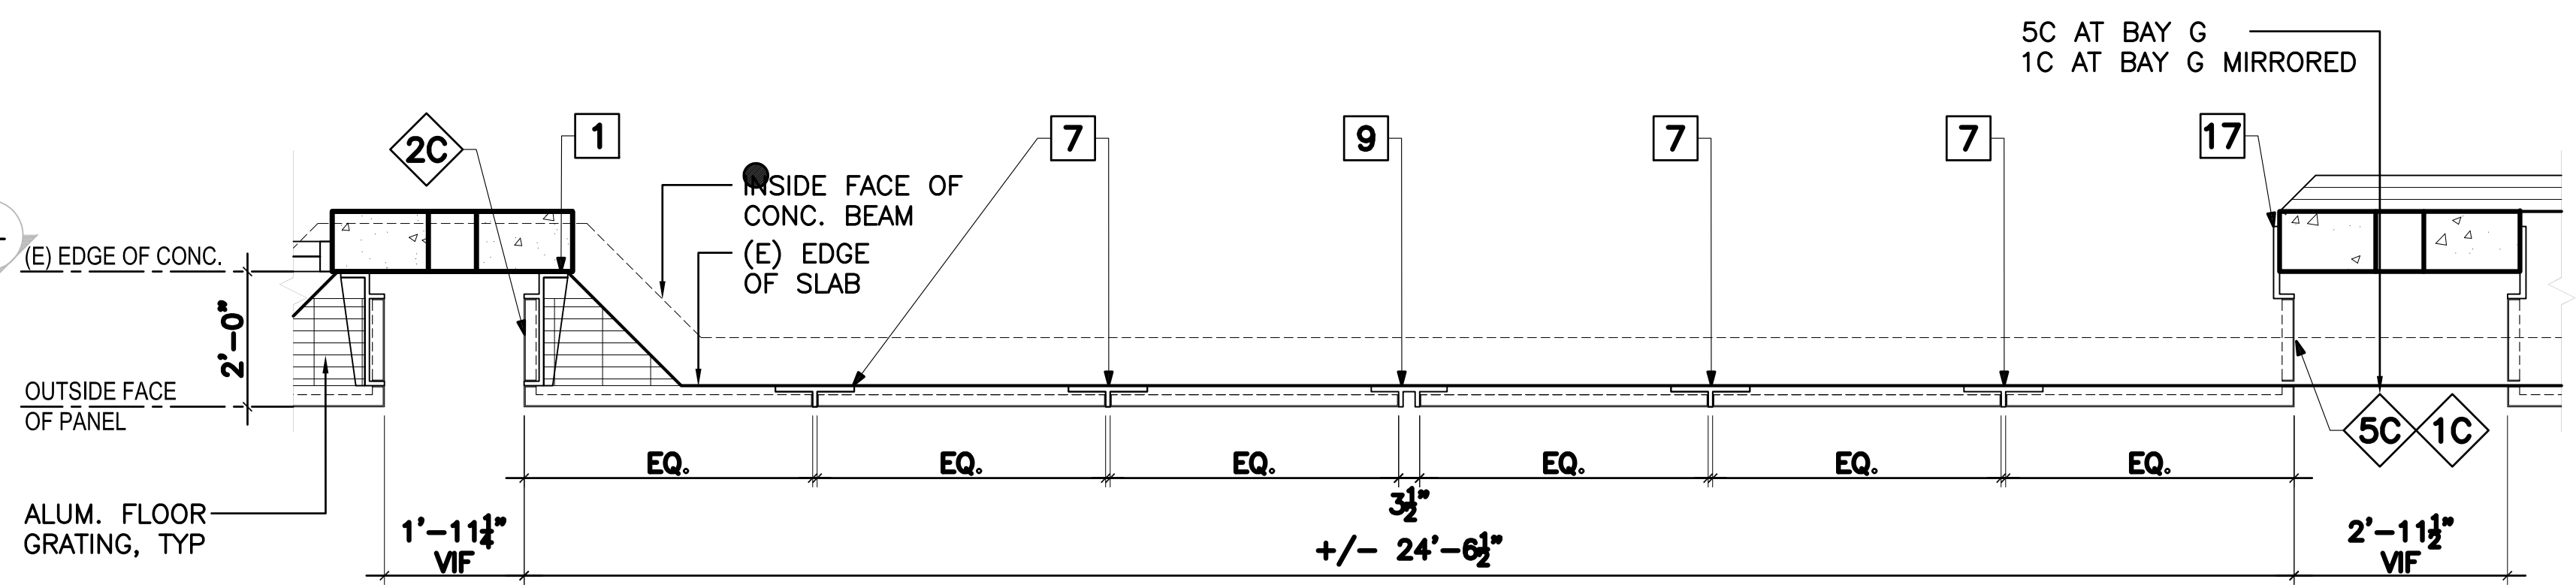

4 SECOND FLOOR PLAN - MOULTON ST
SCALE: 1/2" = 1'-0"

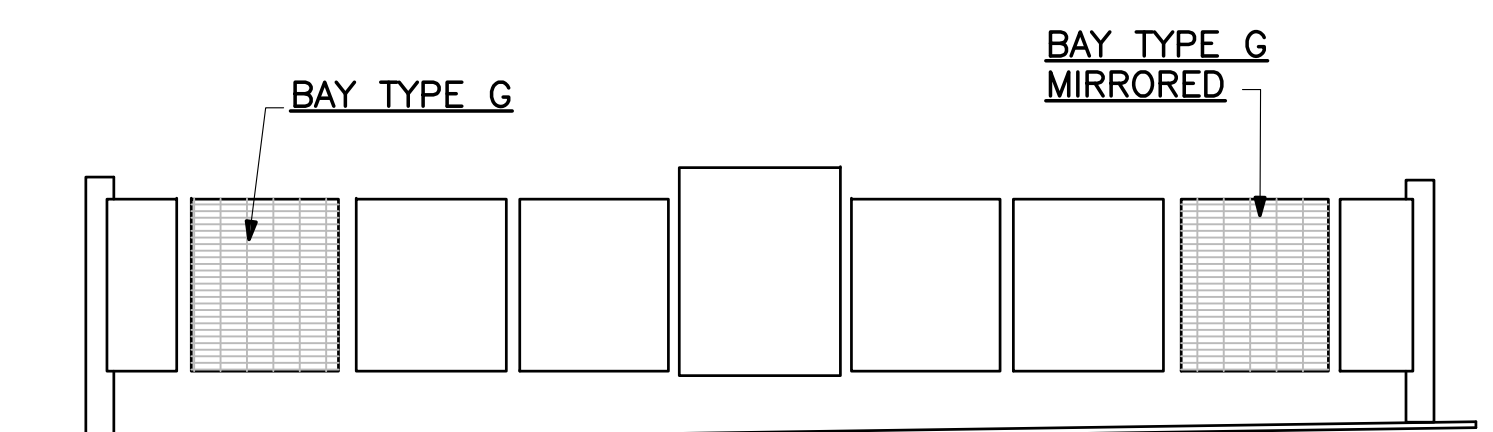

KEY EVELATION - MOULTON ST


LEGEND	
[Bracket Symbol]	BRACKET TYPE, REFER TO DRAWING A5.1
[Diamond Symbol]	PANEL TYPE, REFER TO DRAWING A4.1

5 PANEL BAY TYPE G
SCALE: 1/2" = 1'-0"

GENERAL NOTES

- ALL PANELS MUST COMPLY WITH 2013 CALIFORNIA BUILDING CODE SECTION 1013 GUARDS
- ALUMINUM FLOOR PANELS TO BE PROVIDED BY ALUMINUM PANEL MANUFACTURER AS PART OF THE ALUMINUM PANEL SYSTEM

Original Drawing Size: 30" x 42"
Drawing name: P:\0206A Lombard Street Garage Waterproofing\5.0_Design\5.01_Current\CAD\Fig44-L_ENLARGED_BAY_TYPE_G_ELEVATION.dwg
Plotted on: Aug 09, 2016 - 12:05pm

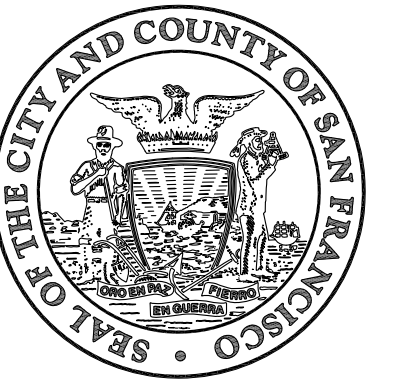

Julia Laue - Principal Architect/Division Manager
30 Van Ness Avenue Suite 4100
San Francisco, CA (415) 557-4700
94102-6028 Fax (415) 5574701

Project _____

**LOMBARD PARKING GARAGE
IMPROVEMENTS**

2055 LOMBARD STREET
SAN FRANCISCO
CALIFORNIA 94133

Consultant _____


Issue _____

**BUILDING PERMIT ADDENDUM
AUGUST 4, 2016**

No.	Date	Revisions

Mark Dorian - Manager, Architecture Services

Drawn	SK
Proj. Arch.	JOR
Proj. Mgr.	DU
Section Head	TL
Phase	CD
Drawing Title	ARCHITECT OF RECORD

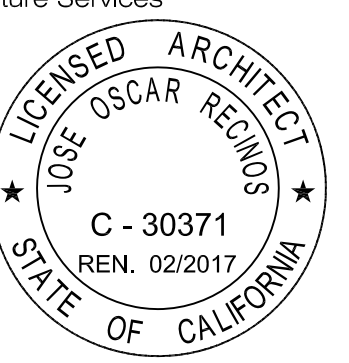

PANEL BAY TYPE H


Sheet No. _____

A4.7






Scale AS NOTED

Job No. _____

8026A

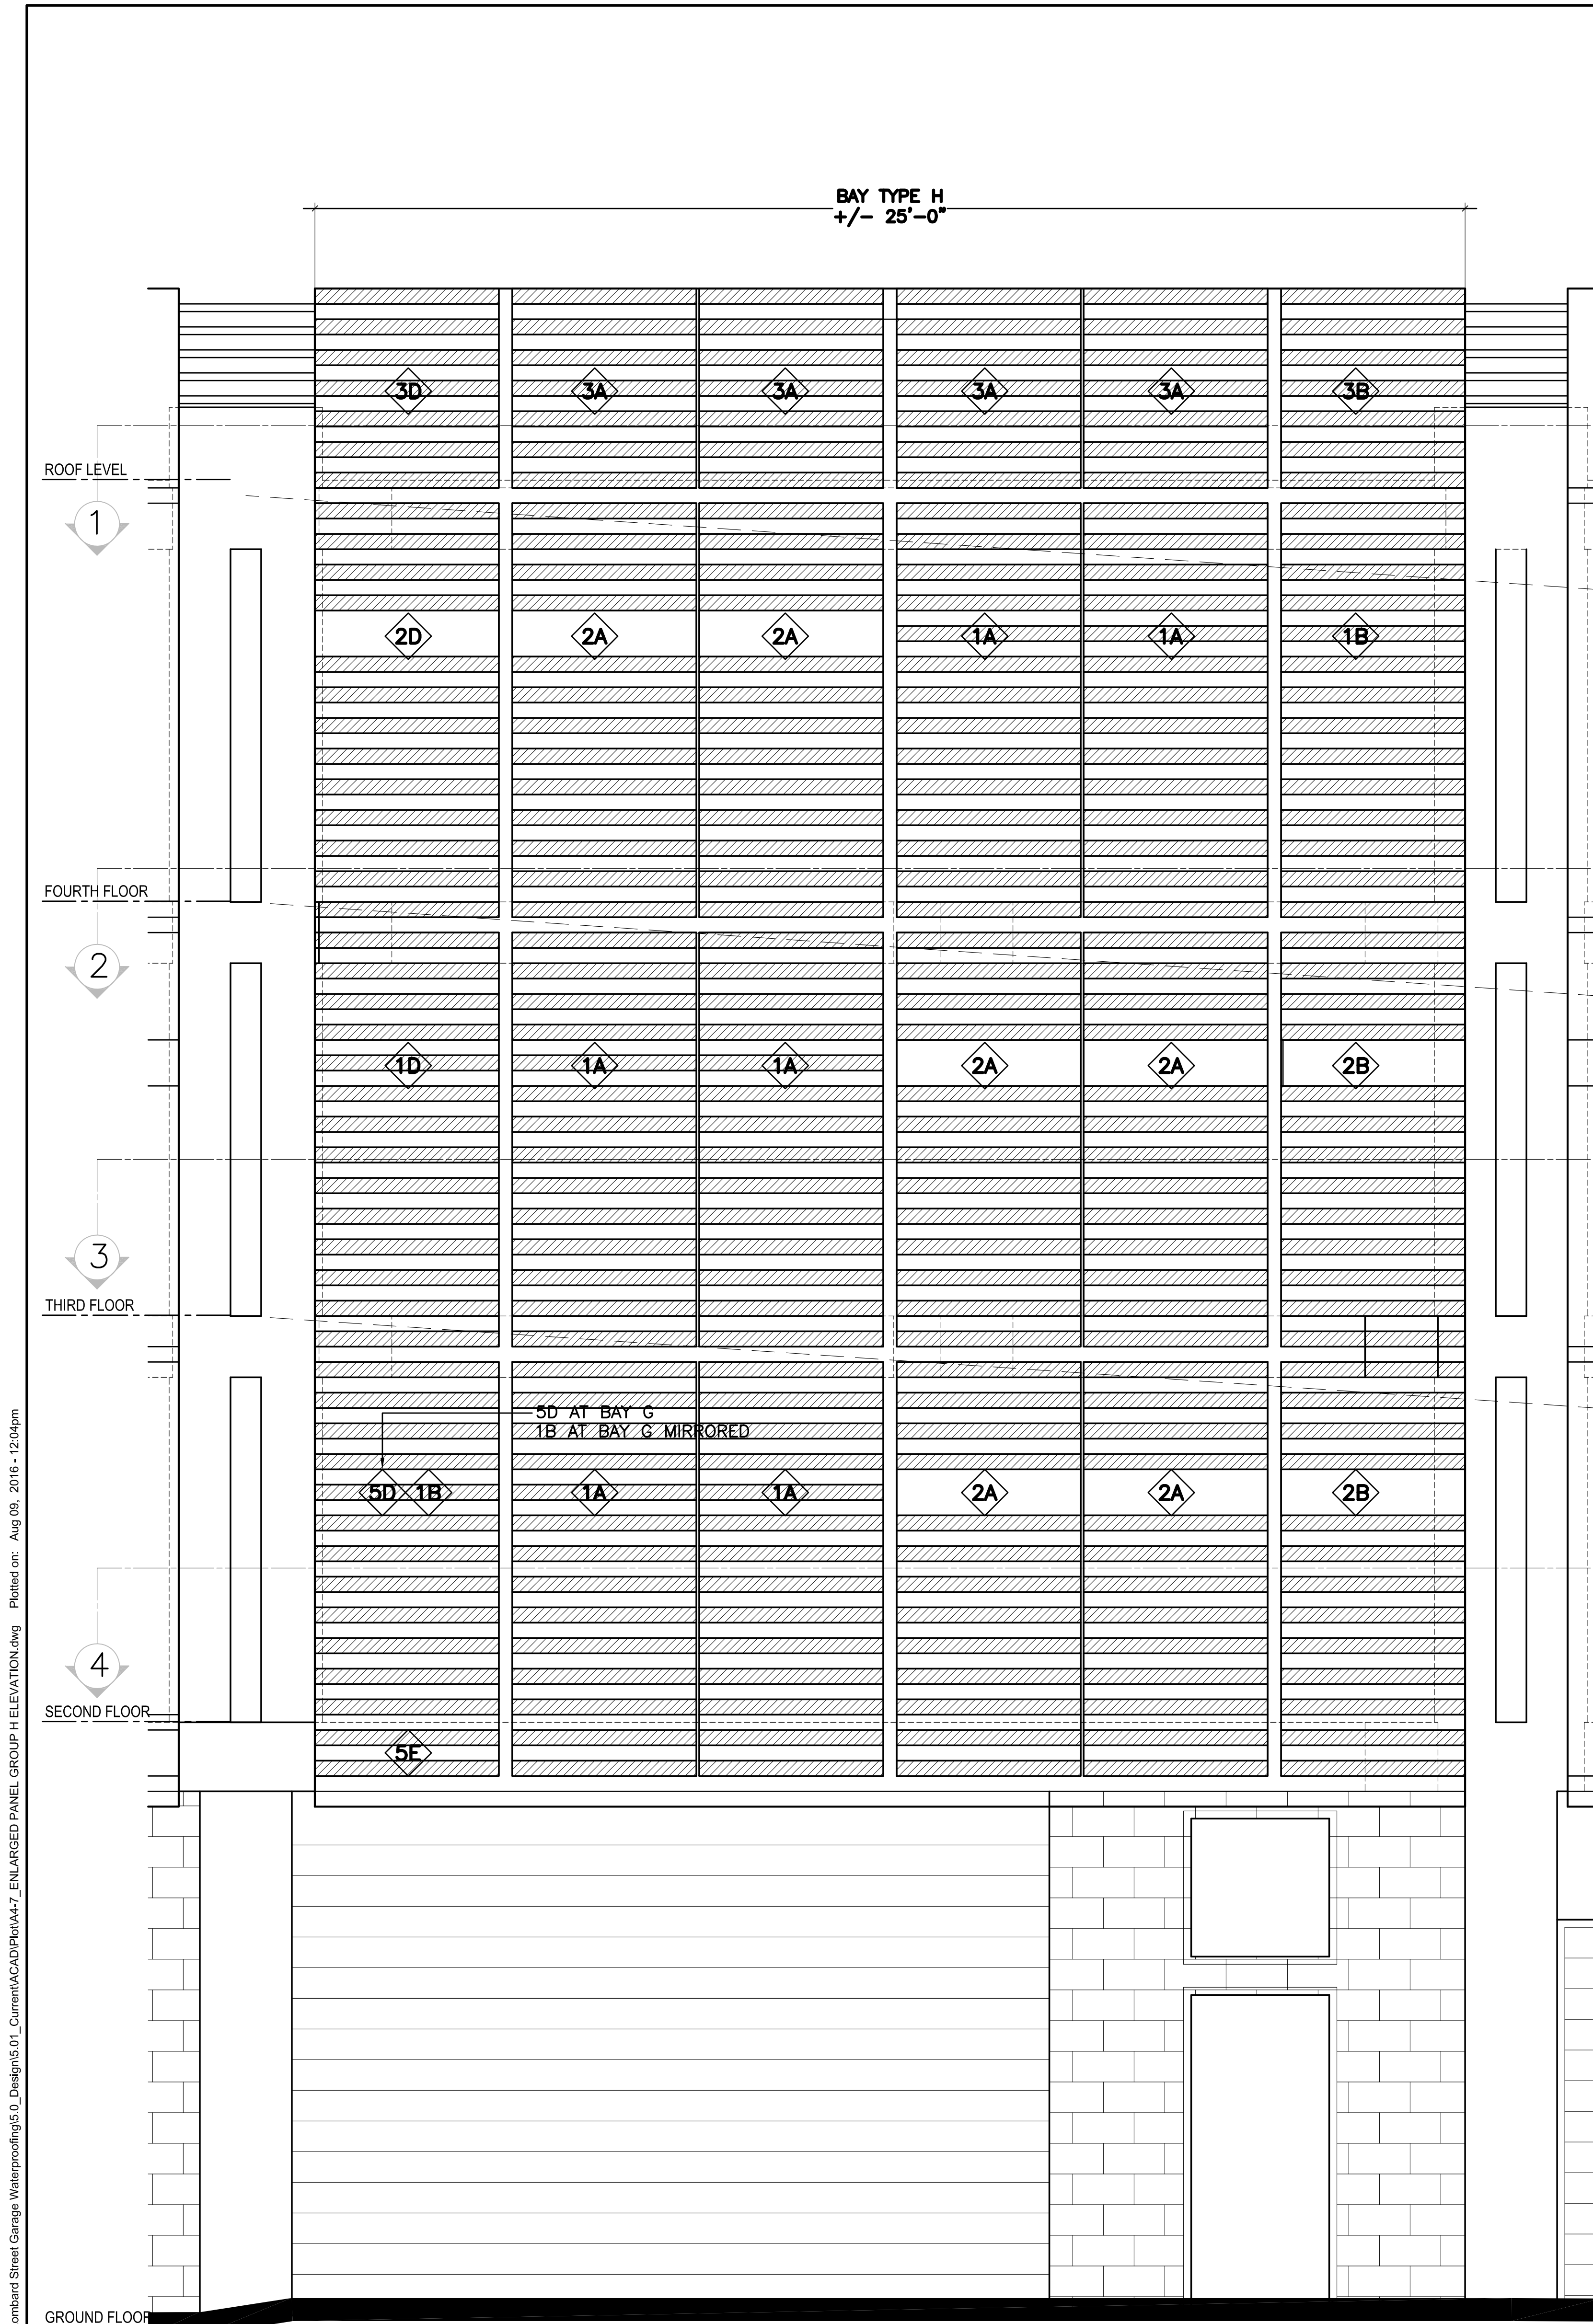

5 PANEL BAY TYPE H
SCALE: 1/2" = 1'-0"

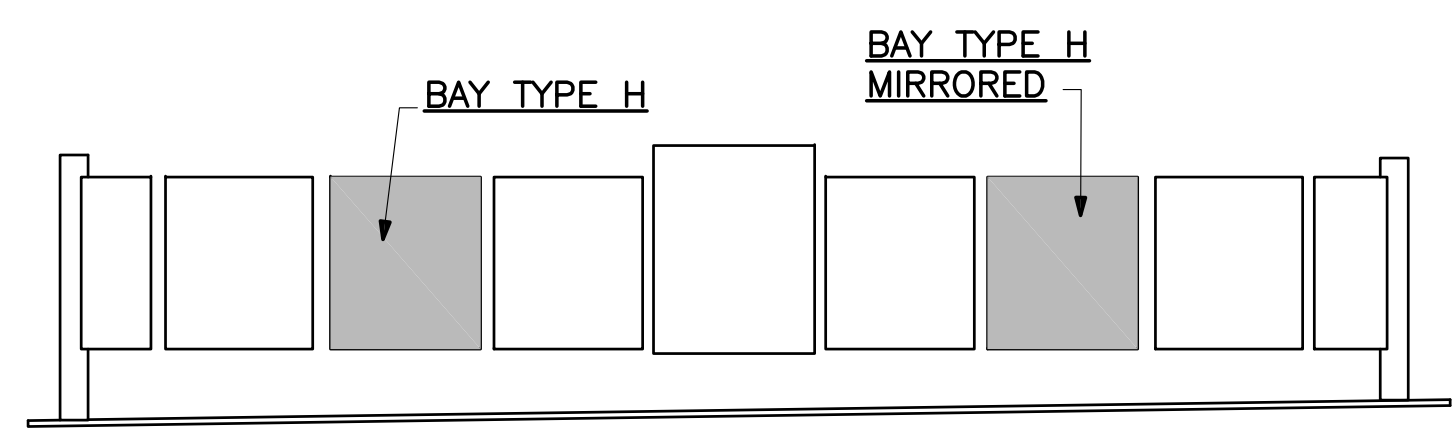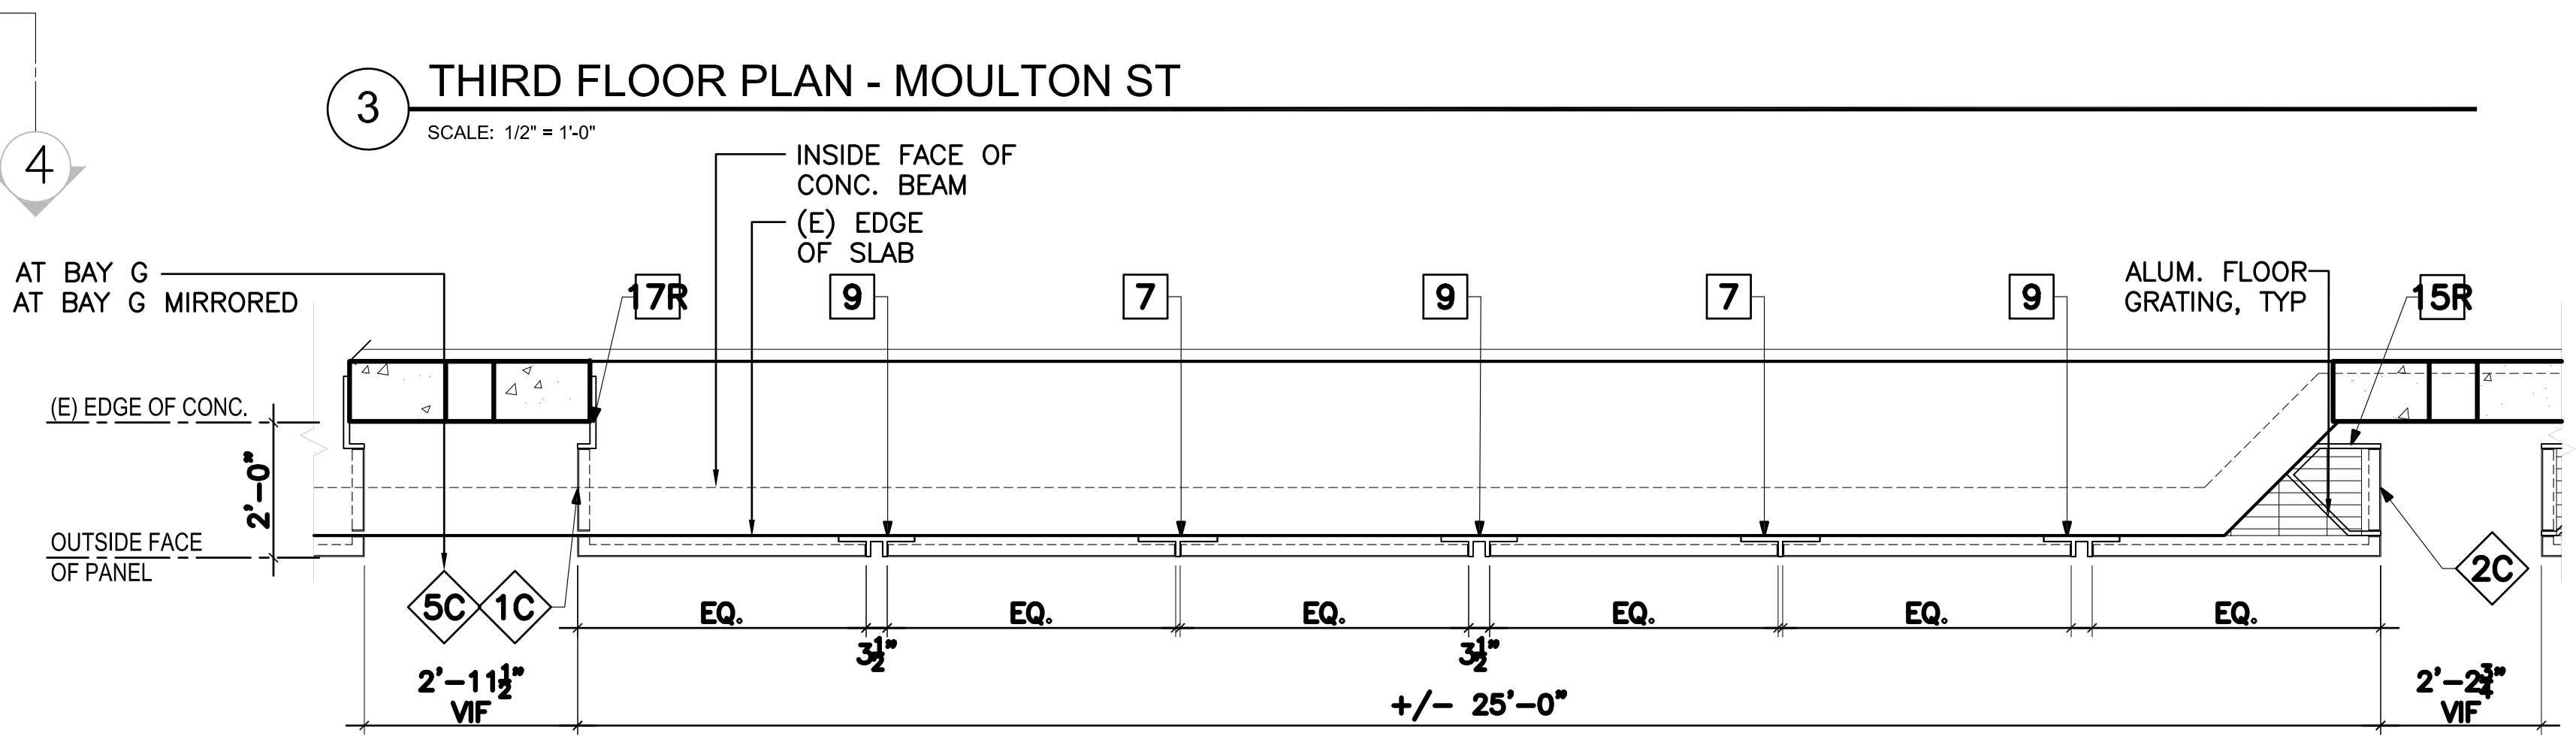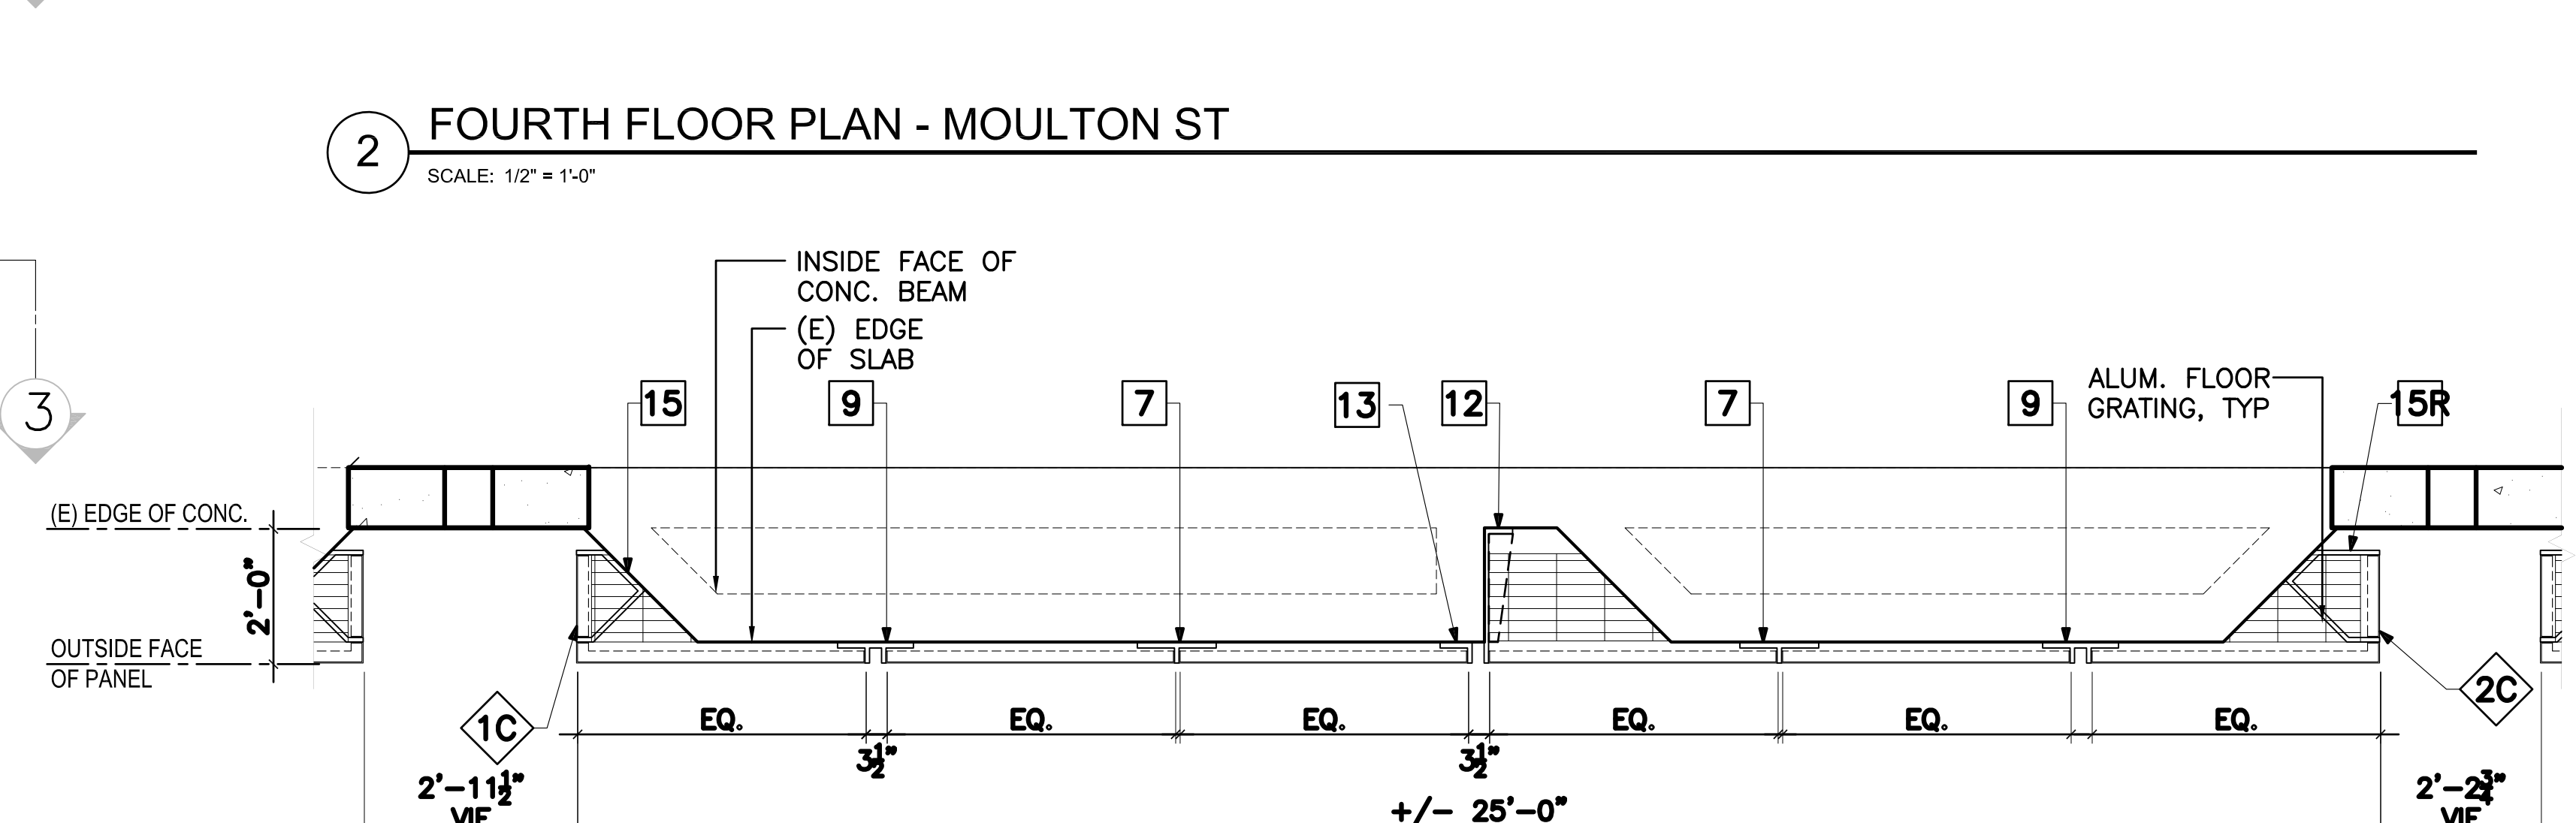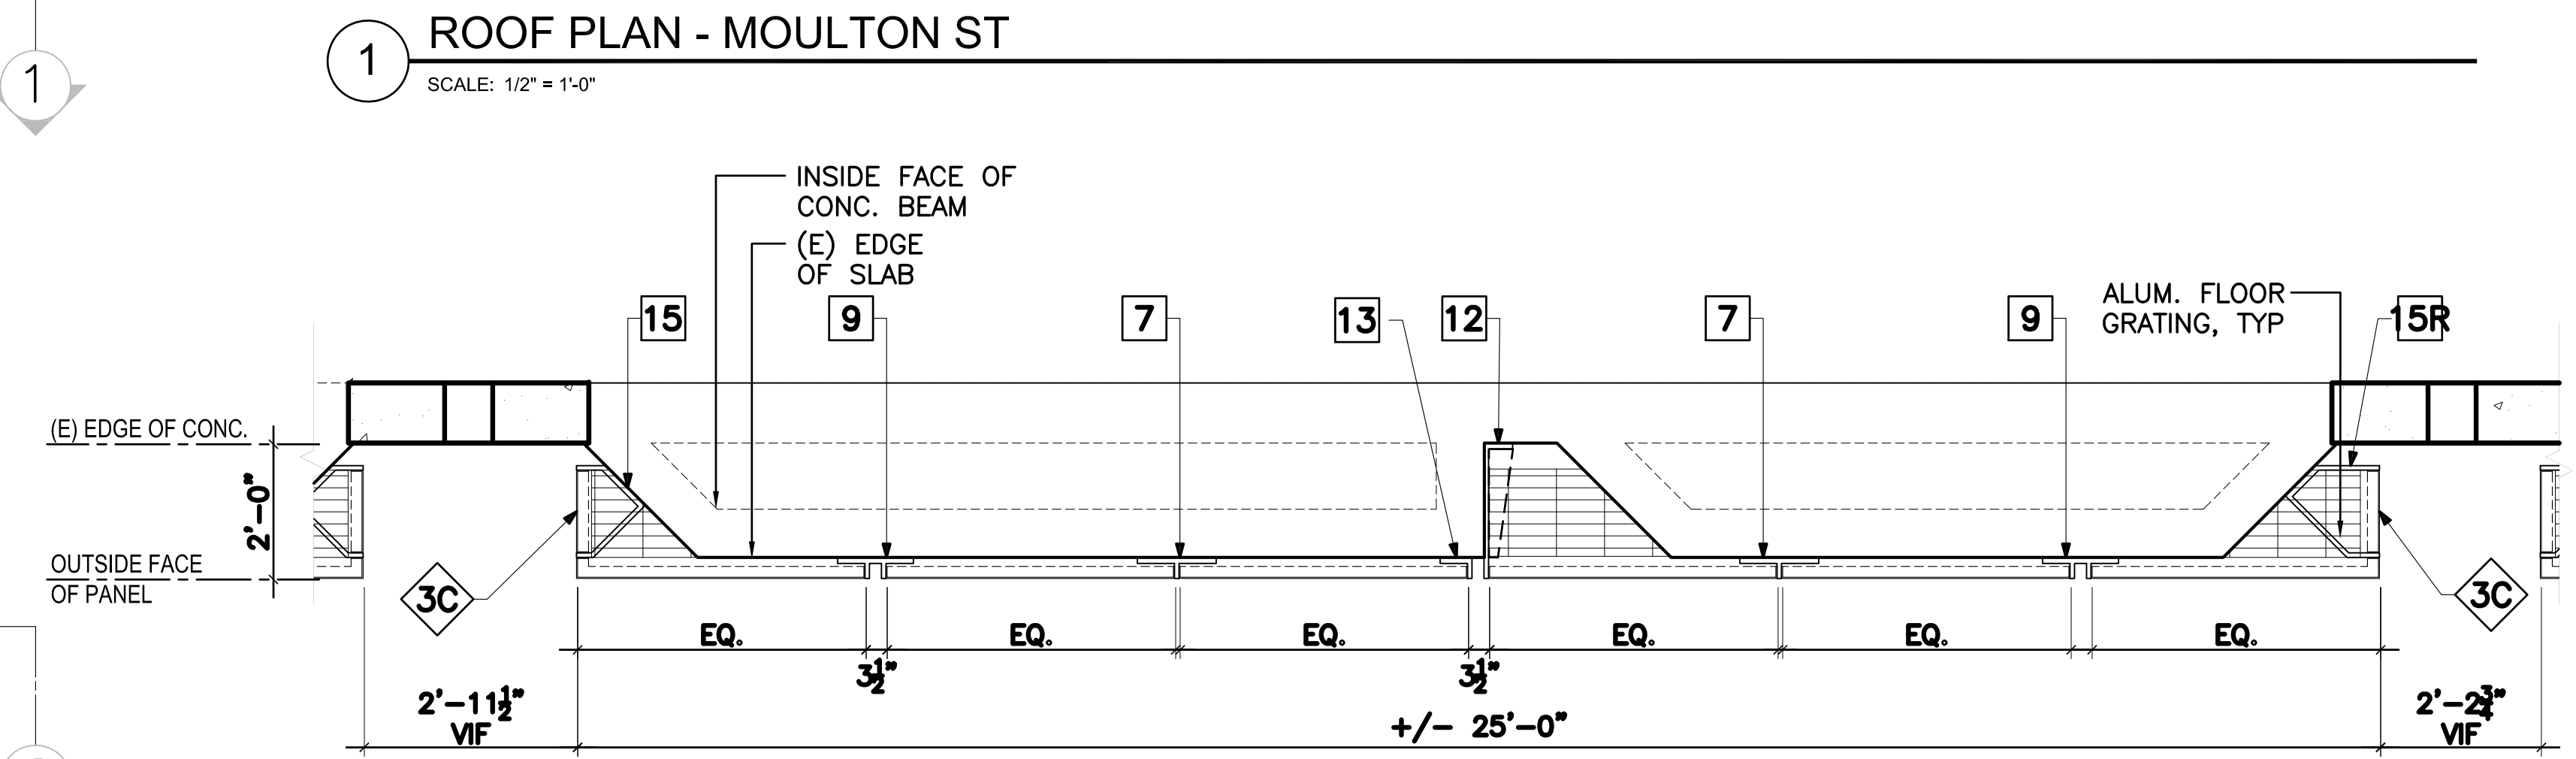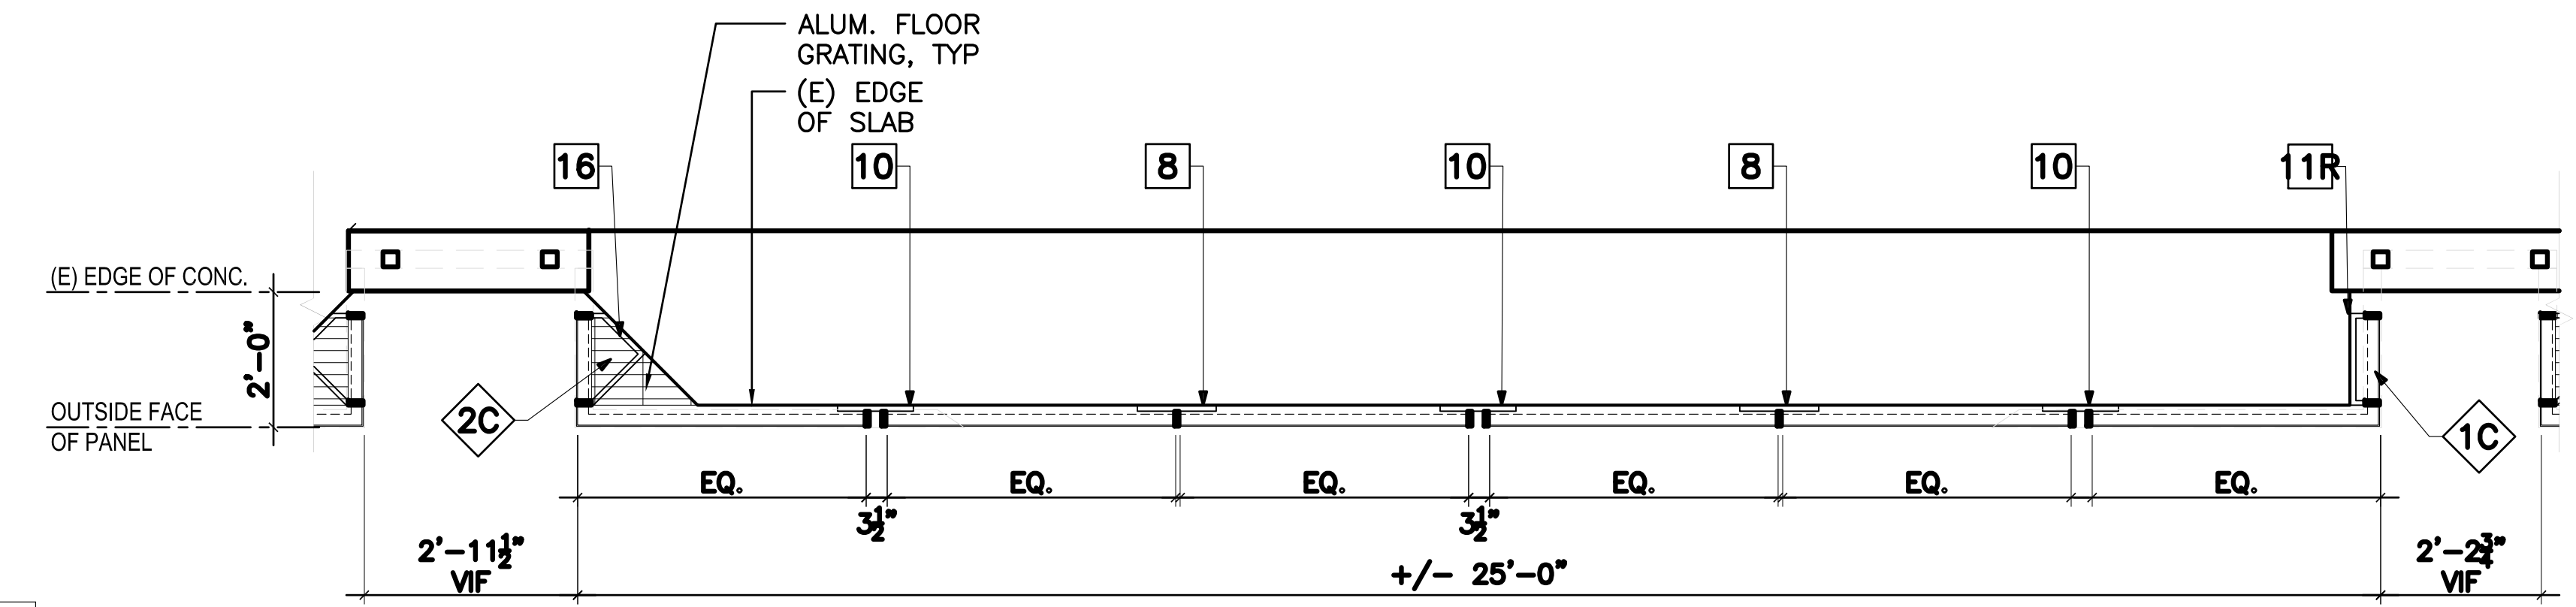


LEGEND

#	BRACKET TYPE, REFER TO DRAWING A5.1
◆	PANEL TYPE, REFER TO DRAWING A4.1

GENERAL NOTES






- ALL PANELS MUST COMPLY WITH 2013 CALIFORNIA BUILDING CODE SECTION 1013 GUARDS
- ALUMINUM FLOOR PANELS TO BE PROVIDED BY ALUMINUM PANEL MANUFACTURER AS PART OF THE ALUMINUM PANEL SYSTEM

Original Drawing Size: 30" x 42" Drawing name: P:\8026A Lombard Street Garage Waterproofing\5.0_Design\5.01_Current\CAD\Panel Group H ELEVATION.dwg Printed on: Aug 09, 2016 - 12:04pm

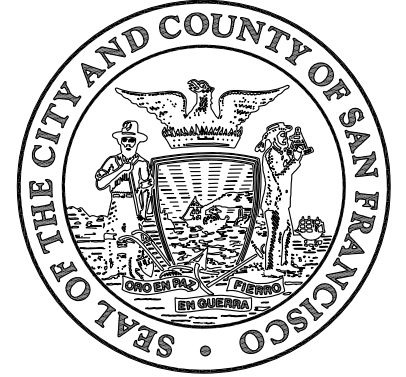


Julia Laue - Principal Architect/Division Manager
30 Van Ness Avenue Suite 4100
San Francisco, CA (415) 557-4700
94102-6028 Fax (415) 5574701

Project
**LOMBARD PARKING GARAGE
IMPROVEMENTS**
2055 LOMBARD STREET
SAN FRANCISCO
CALIFORNIA 94133
Consultant

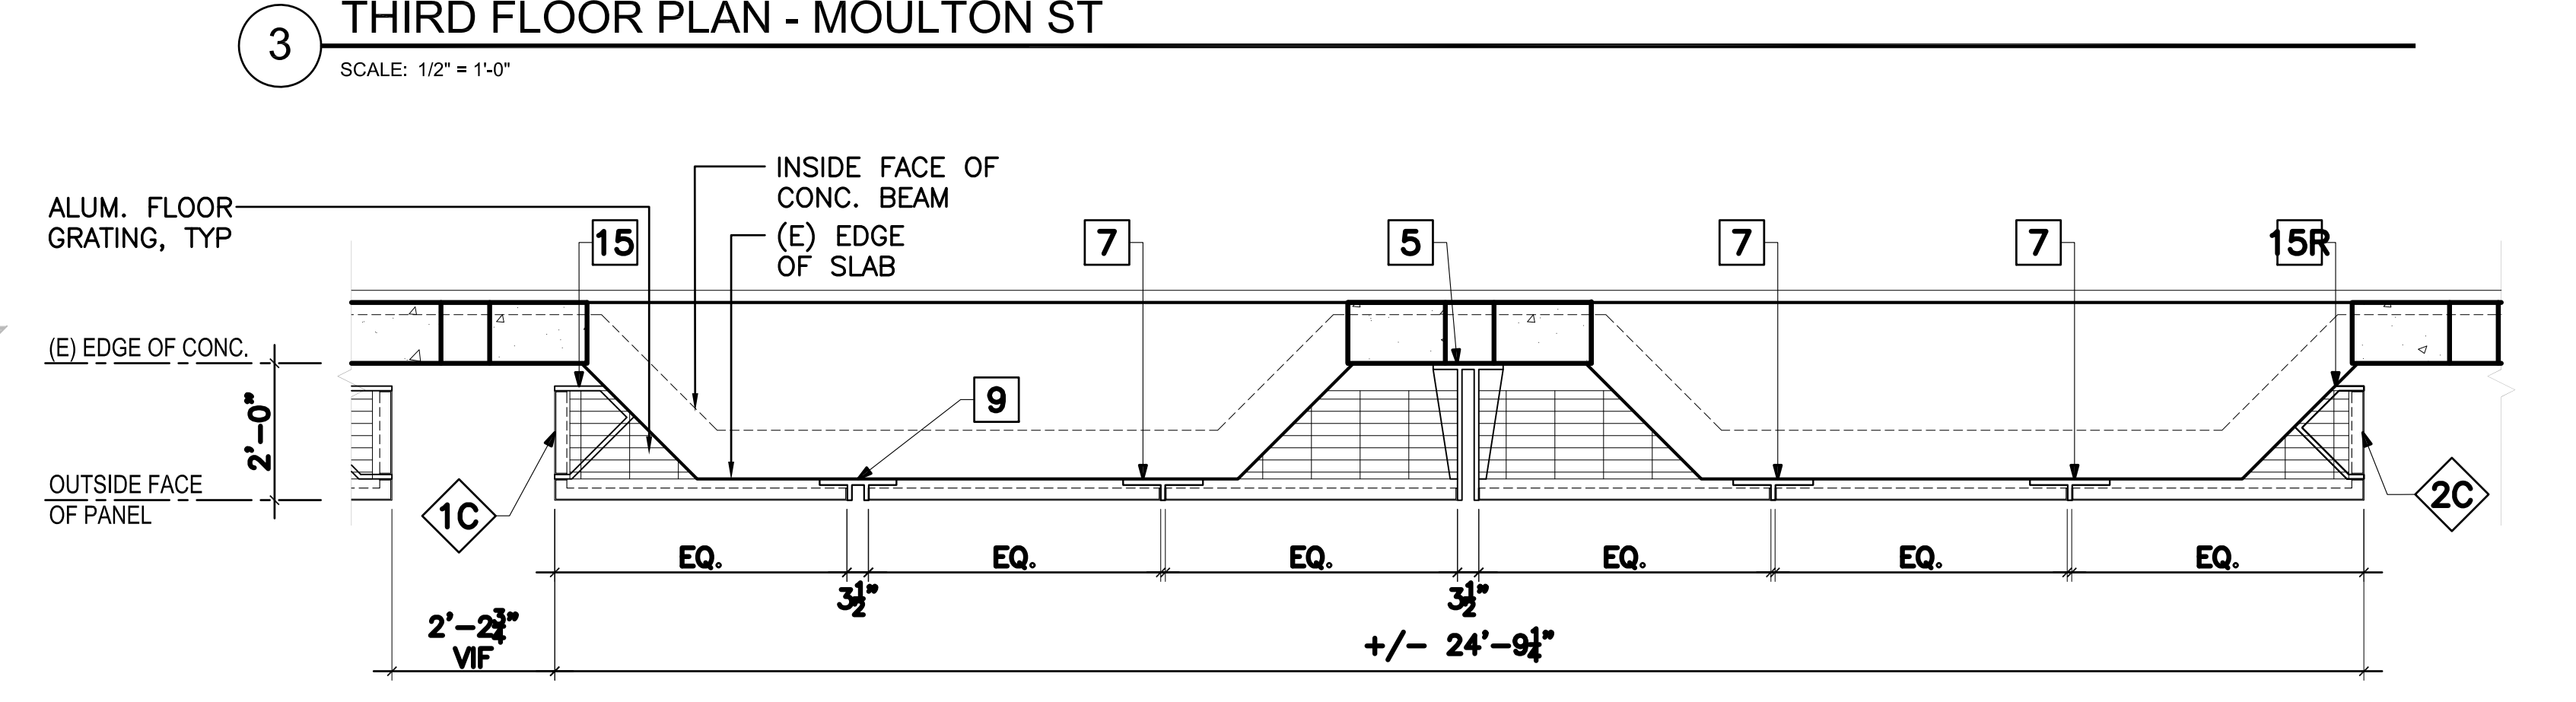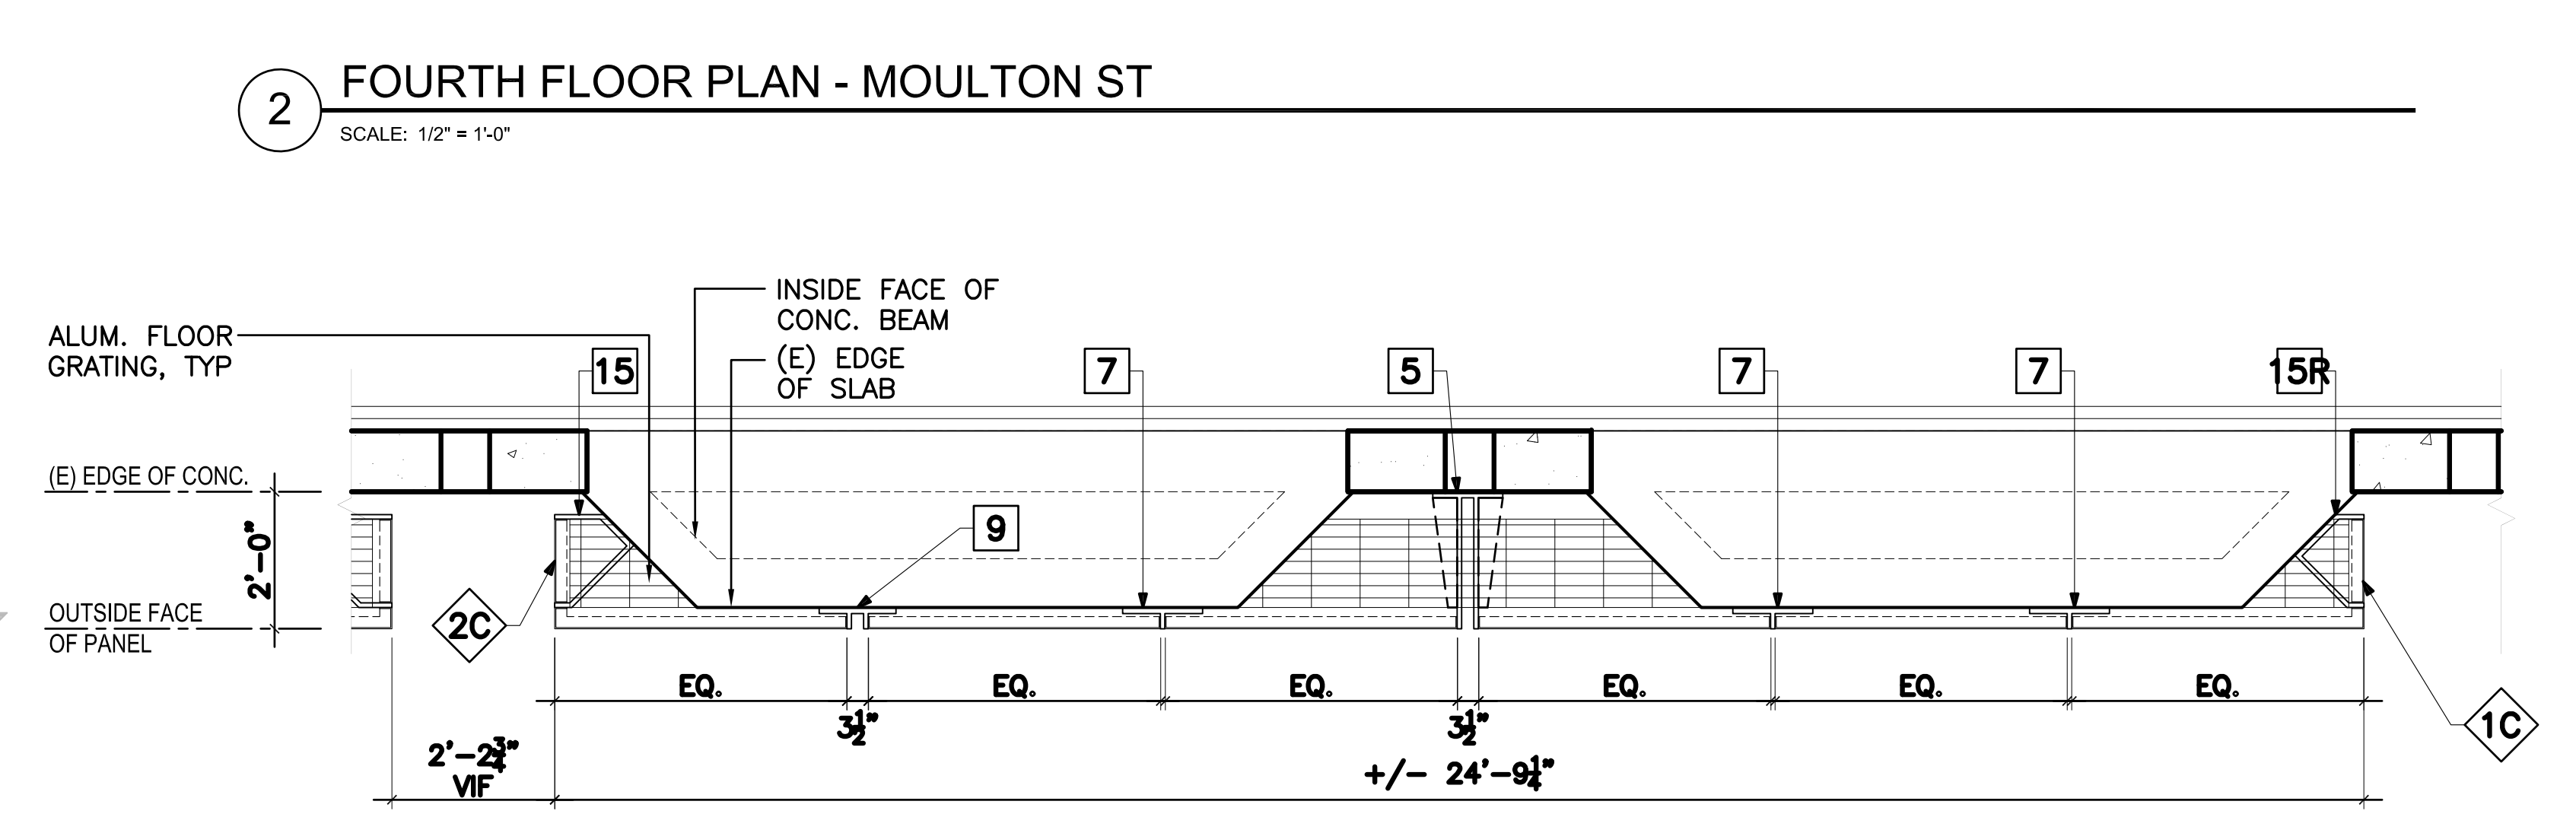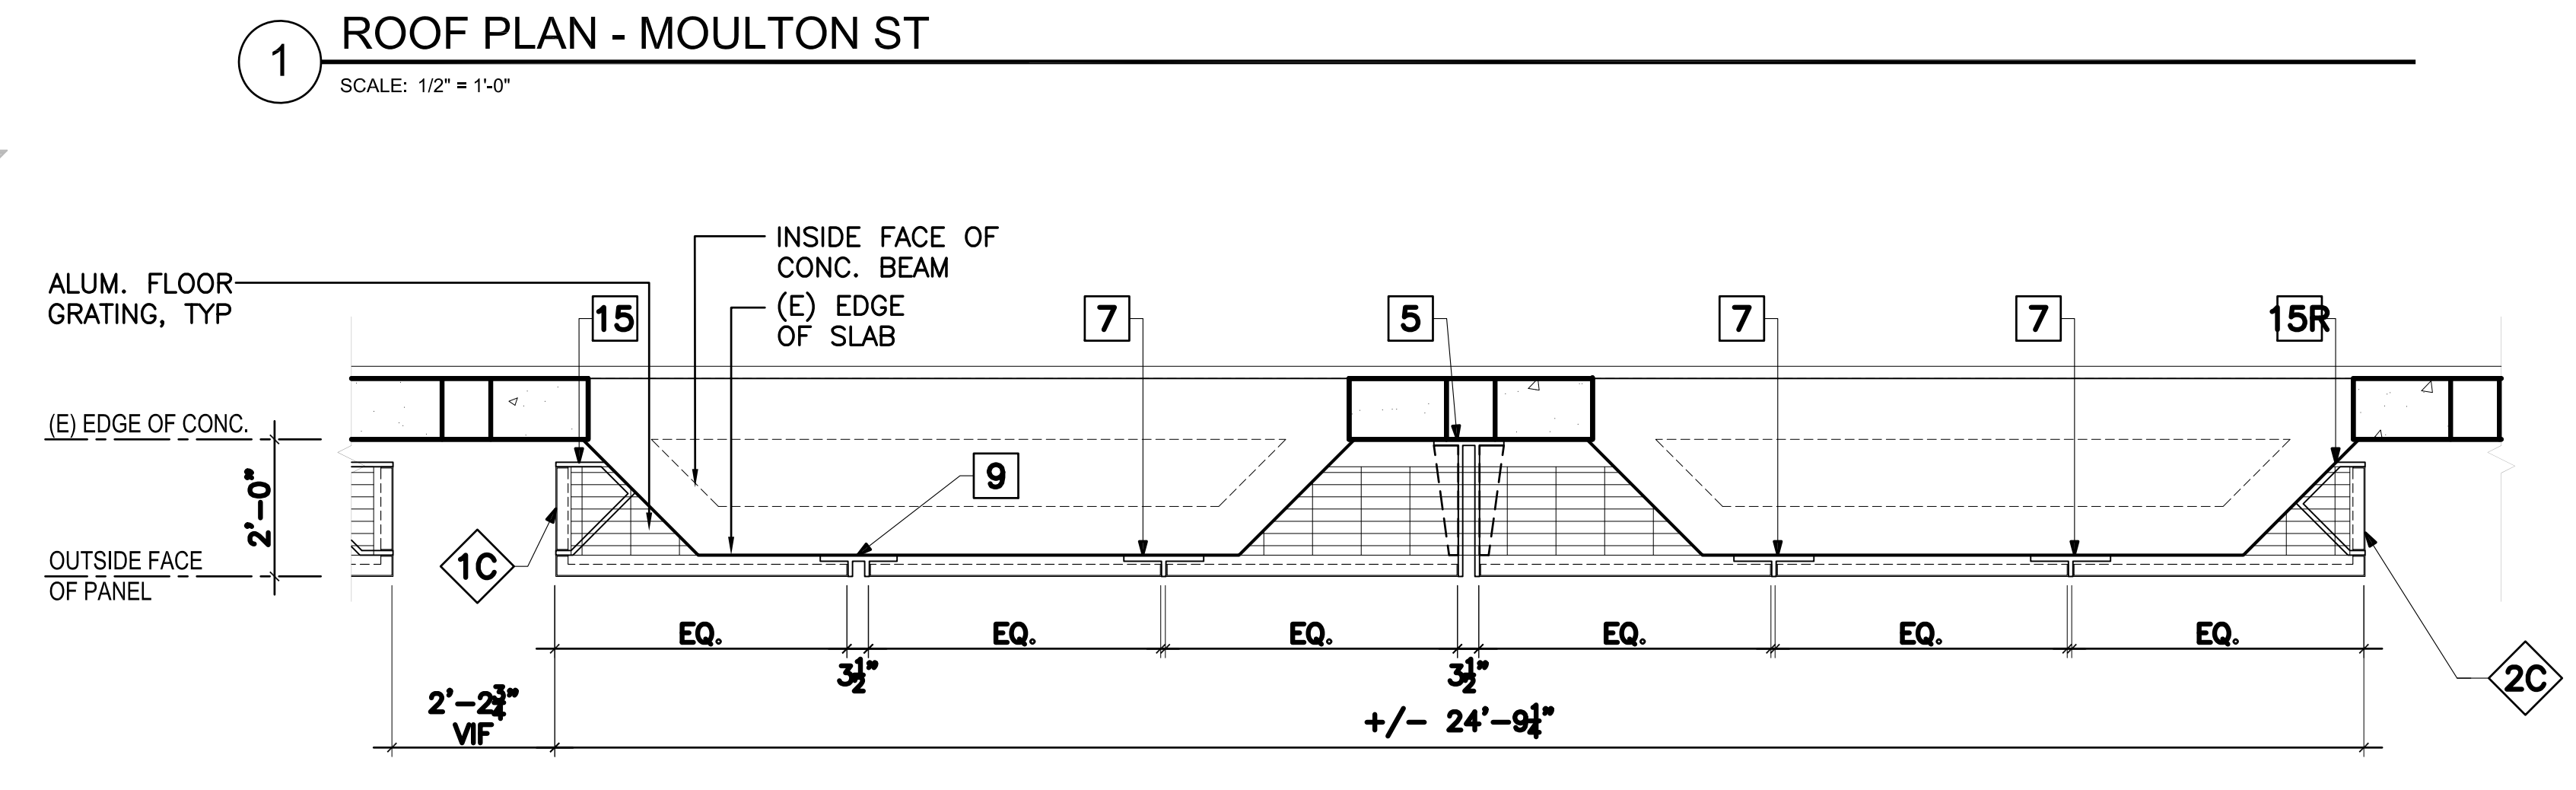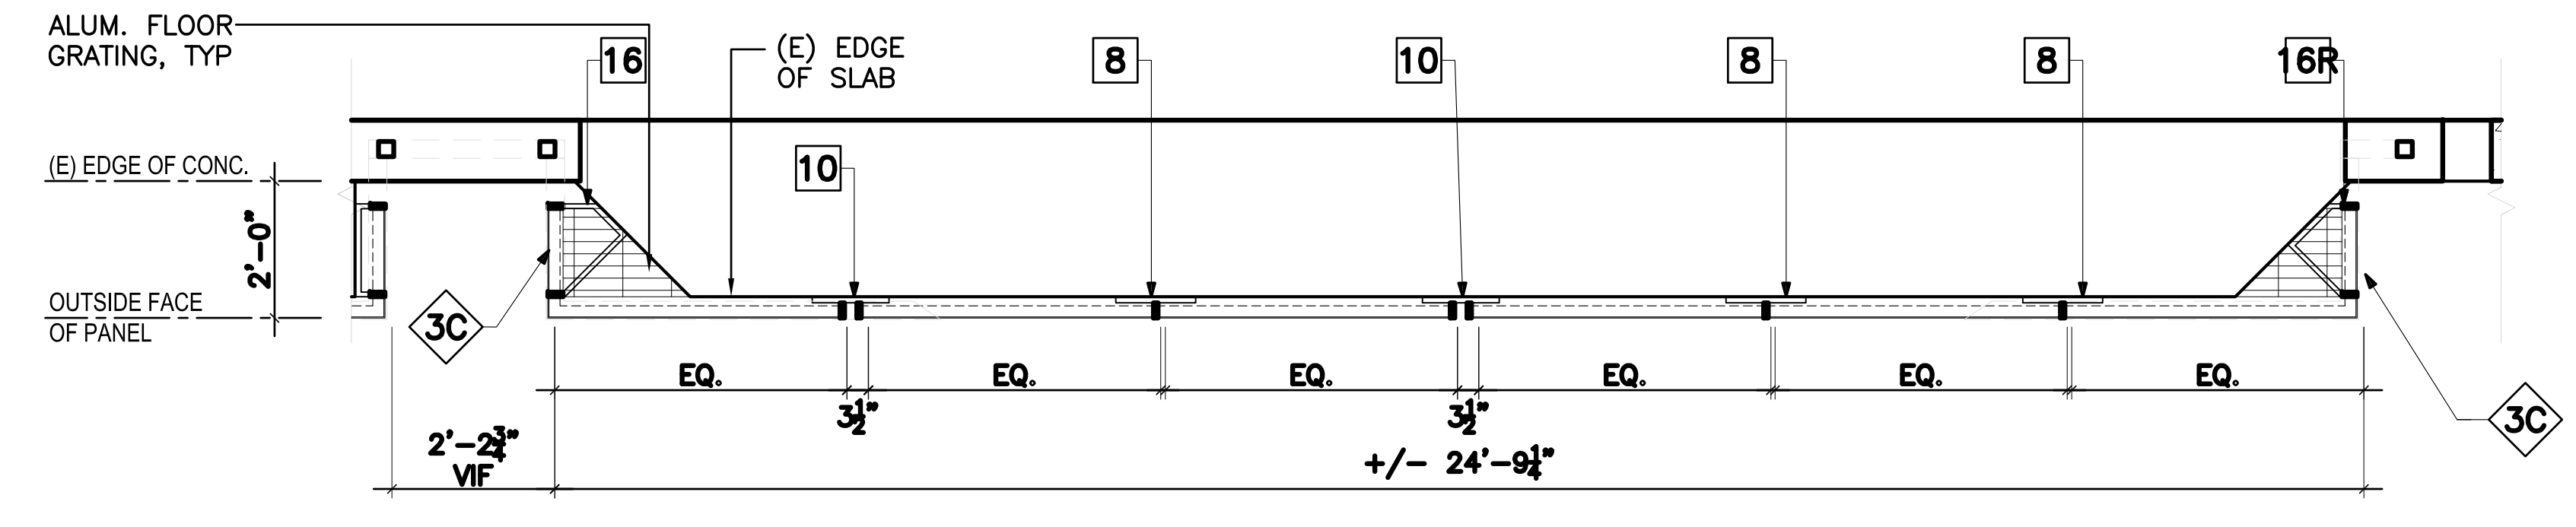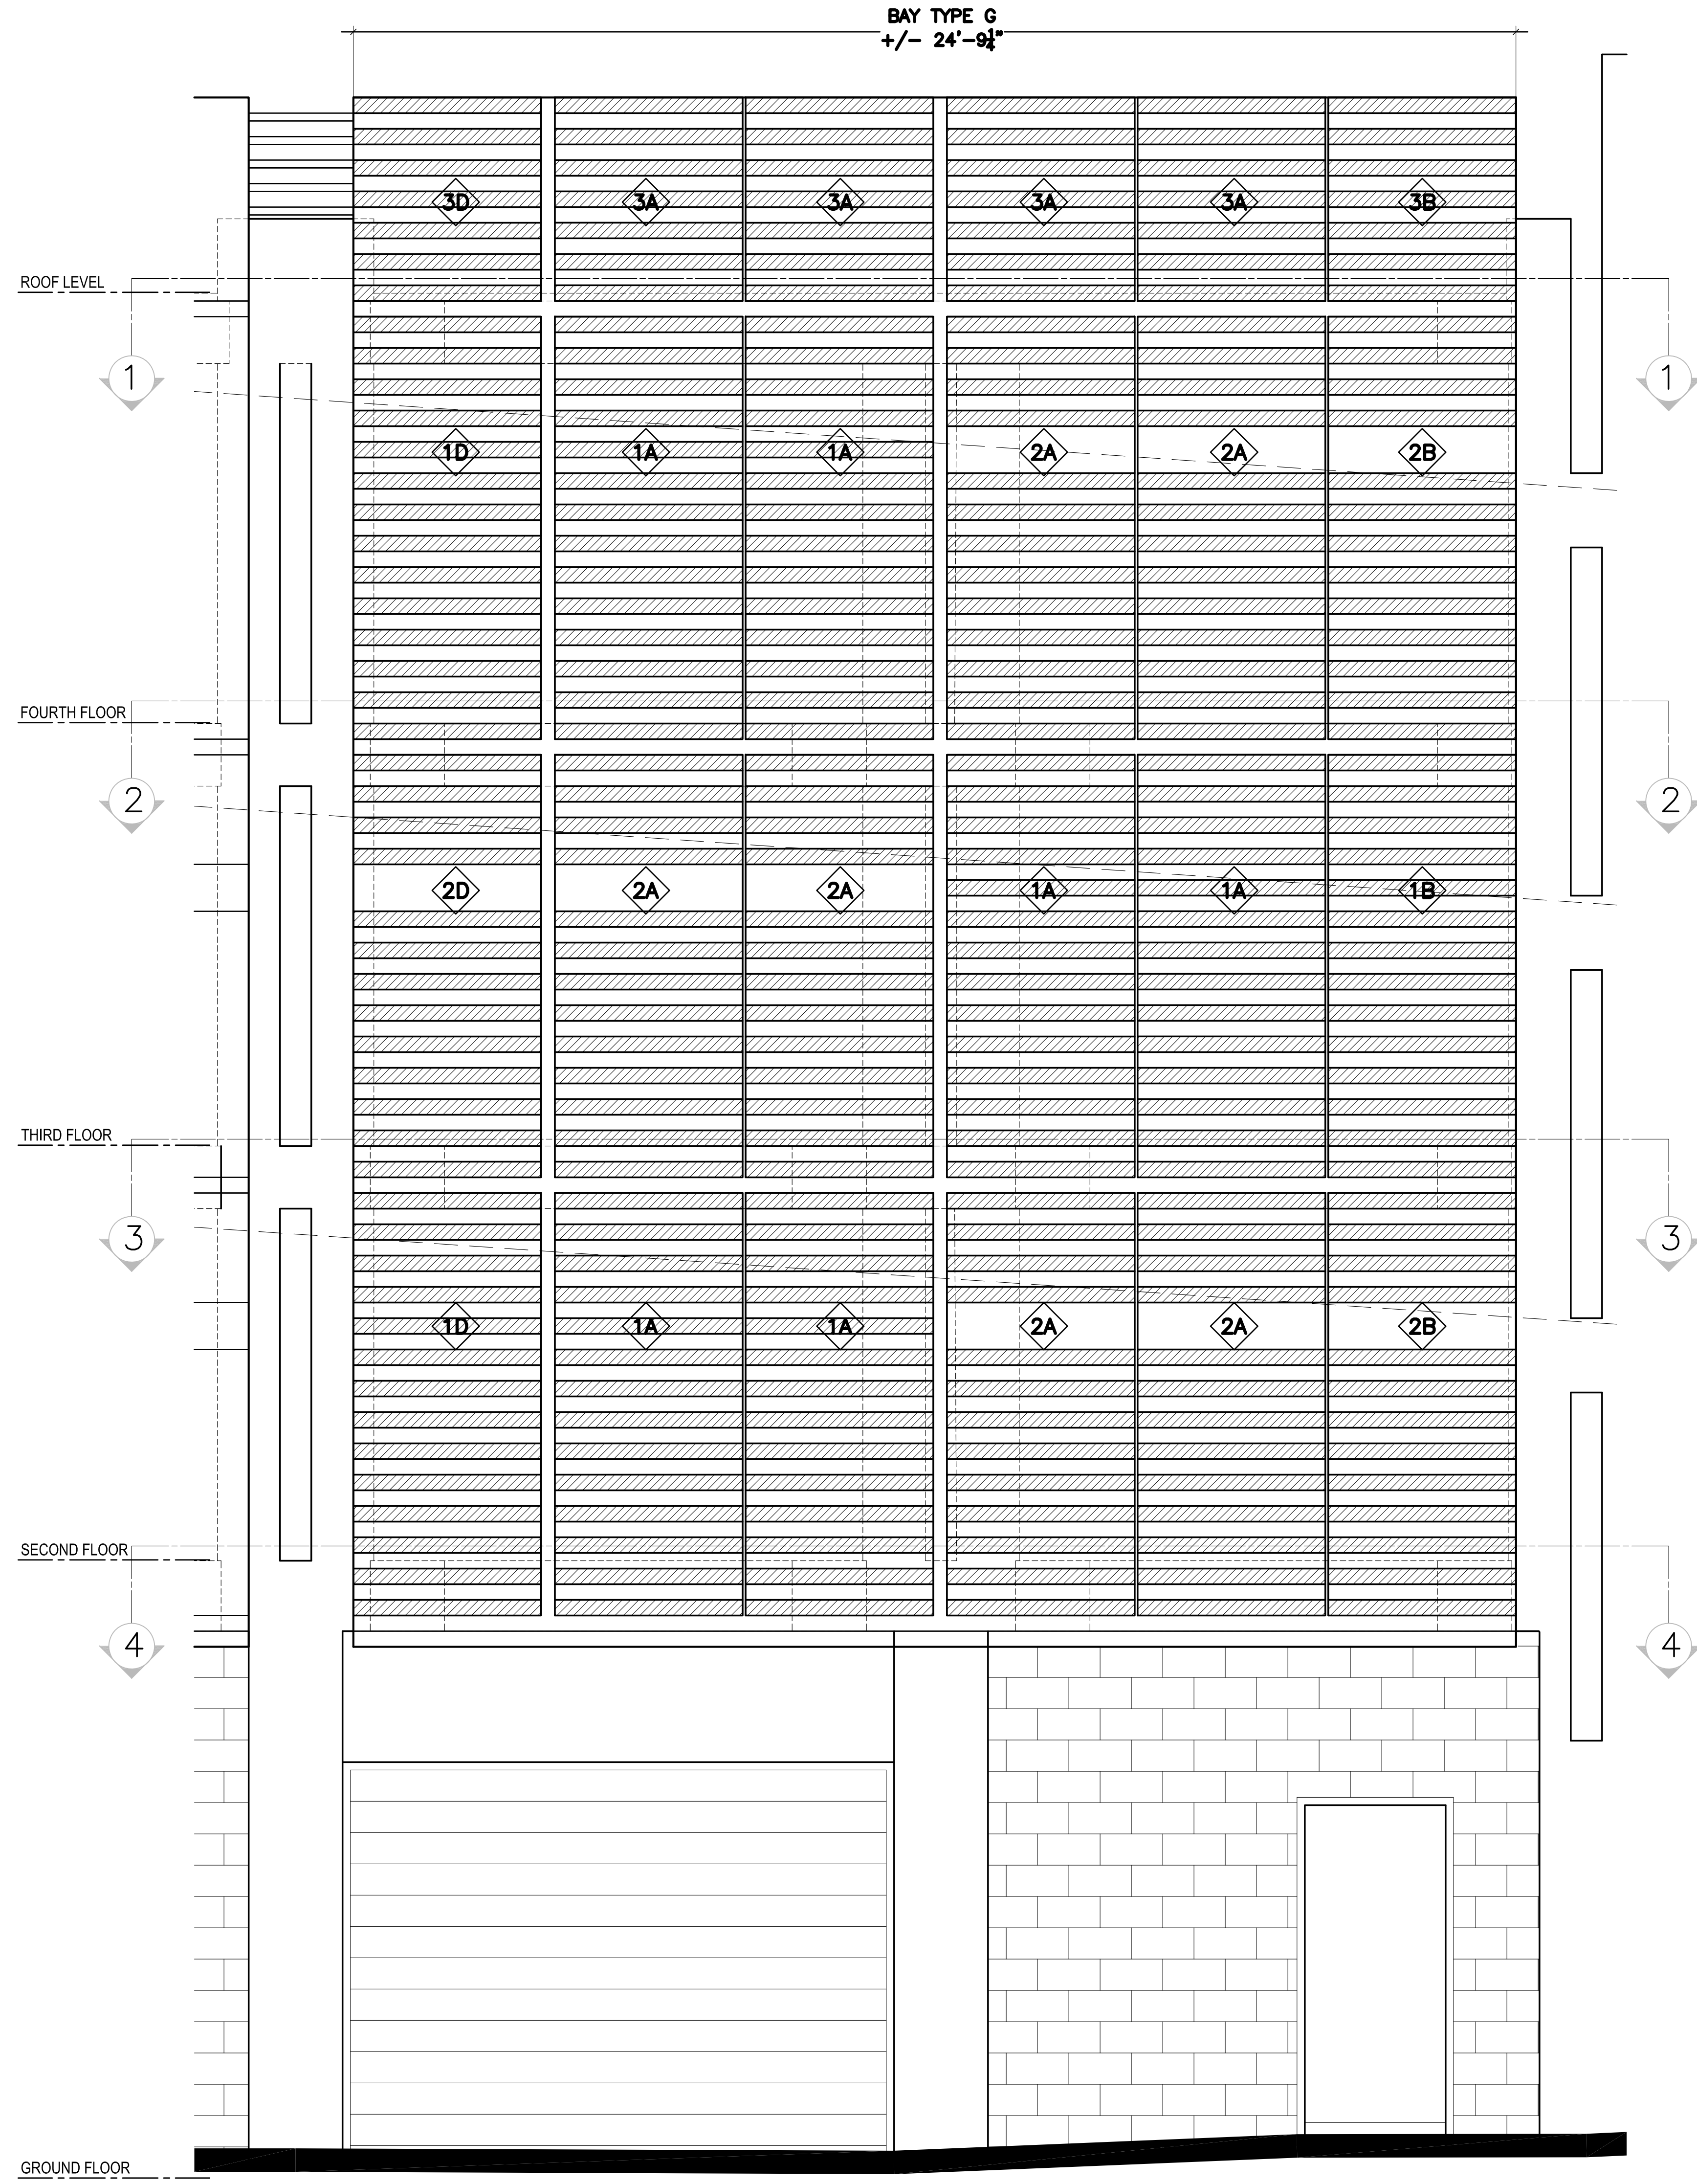

5 PANEL BAY TYPE I
SCALE: 1/2" = 1'-0"

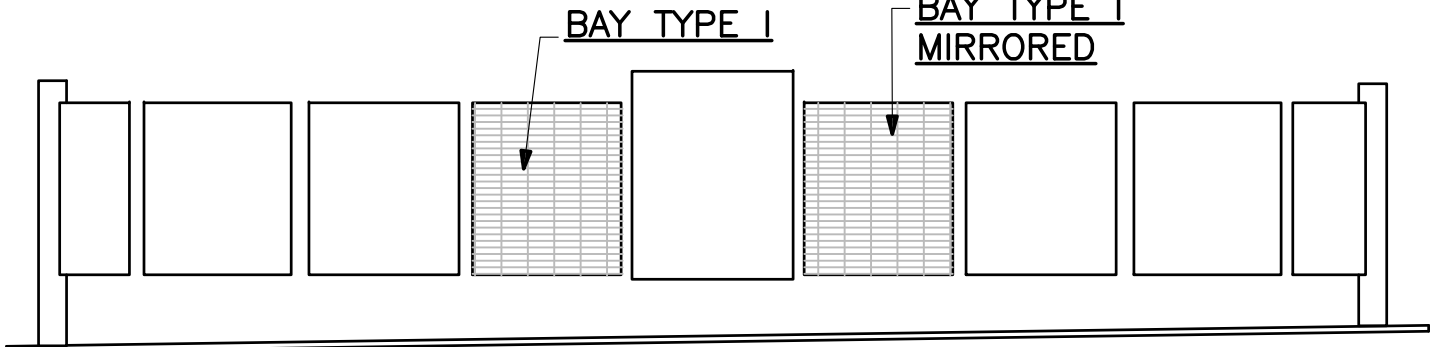

LEGEND	
#	BRACKET TYPE, REFER TO DRAWING A5.1
◆	PANEL TYPE, REFER TO DRAWING A4.1

GENERAL NOTES

- ALL PANELS MUST COMPLY WITH 2013 CALIFORNIA BUILDING CODE SECTION 1013 GUARDS
- ALUMINUM FLOOR PANELS TO BE PROVIDED BY ALUMINUM PANEL MANUFACTURER AS PART OF THE ALUMINUM PANEL SYSTEM

Issue
**BUILDING PERMIT ADDENDUM
AUGUST 4, 2016**

No.	Date	Revisions

Mark Dorian - Manager, Architecture Services
Drawn SK
Proj. Arch. JOR
Proj. Mgr. DU
Section Head TL
Phase CD
ARCHITECT OF RECORD



PANEL BAY TYPE I

Sheet No.
A4.8
Scale AS NOTED
Job No. 8026A

Original Drawing Size: 30" x 42" Drawing name: P:\2026 Lombard Street Garage Waterproofing\5.0_Design\5.01_Current\ACAD\Floor\A4.8_ENLARGED_PANEL_GRID\ELEVATION.dwg Printed on: Aug 09, 2016 - 12:02pm