MEMO

Disclaimer for Review of Plans

The San Francisco Planning Code requires that the plans of certain proposed projects be provided to members of the public prior to the City's approval action on the project. Accordingly, any images of plans featured on this website are provided for the primary purpose of facilitating public input prior to the City's action. The City and County of San Francisco does not own the copyright to these images. Please be aware that the unauthorized reproduction, distribution, or alteration of these images may result in a violation of Federal Copyright Law (17 U.S.C.A. Sections 101 et seq.) and that any party who seeks to reproduce or alter these images does so at his or her own risk.

Additionally, plans provided on this website are limited to site plans, elevations and/or section details (floor plans and structural details may not be included). These are DRAFT PLANS being provided for public review PRIOR to the City's approval action on the project. Final plans may differ from those that are currently available for review.

1650 Mission St. Suite 400 San Francisco, CA 94103-2479

Reception: 415.558.6378

Fax: 415.558.6409

Planning Information: 415.558.6377 NOTICE OF PUBLIC HEARING

Hearing Date: Wednesday, December 07, 2016

Time: **9:30 AM**

Location: City Hall, 1 Dr. Carlton B. Goodlett Place, Room 408

Case Type: Variance(Rear Yard and Exposure)

Hearing Body: Zoning Administrator

PORPERTY INFORMATION		APPLICATION INFORMATION	
Project Address:	18-20 Shotwell Street	Case No.:	2016-005711VAR
Cross Street(s):	14th Street	Building Permit:	201606240833
Block / Lot No.:	3549/051	Applicant/Agent:	Antonio Prado
Zoning District(s):	UMU / 50-X	Telephone:	415-889-0878
Area Plan:	Mission	E-Mail:	pradoenfineering@yahoo.com

PROJECT DESCRIPTION

The subject lot contains two buildings. The proposed project is to demolish an existing illegal structure and build a new structure to contain 3 units increasing the number of dwelling units on the subject property from 2 to 5.

PER SECTION 134 of the Planning Code the subject property is required to provide a rear yard equal to 30 feet. The existing legal two-family dwelling building at the front complies with this requirement and has a rear yard of 62 feet. However, the proposed new three-family dwelling unit structure would be entirely within the rear yard and therefore requires a variance from the Planning Code's rear yard requirements.

PER SECTION 140 OF THE PLANNING CODE each dwelling unit must have one room of at least 120 square feet that looks out onto a code complying open area or street. The project does not provide a code complying rear yard or open space. Therefore, the new dwelling units require a variance from the exposure requirement.

ADDITIONAL INFORMATION

FOR MORE INFORMATION, PLEASE CONTACT PLANNING DEPARTMENT STAFF:

Planner: kimberly durandet Telephone: 415-575-6816 Mail: kimberly.durandet@sfgov.org

ARCHITECTURAL PLANS: The site plan and elevations of the proposed project are available on the Planning Department's website at: http://sf-planning.org/ftp/files/notice/2016-005711VAR.pdf

GENERAL INFORMATION ABOUT PROCEDURES

VARIANCE HEARING INFORMATION

Under Planning Code Section 306.3, you, as a property owner or resident within 300 feet of this proposed project or interested party on record with the Planning Department, are being notified of this Variance Hearing. You are not obligated to take any action. For more information regarding the proposed work, or to express concerns about the project, please contact the Applicant/Agent or Planner listed on this notice as soon as possible. Additionally, you may wish to discuss the project with your neighbors and neighborhood association or improvement club, as they may already be aware of the project.

Persons who are unable to attend the public hearing may submit written comments regarding this application to the Zoning Administrator, Planning Department, 1650 Mission Street, Suite 400, San Francisco, CA 94103, by 5:00pm the day prior to the hearing. These comments will be made a part of the official public record, and will be brought to the attention of the person or persons conducting the public meeting or hearing

BUILDING PERMIT APPLICATION INFORMATION

Under Planning Code Section 311/312, the Building Permit Application for this proposal is also subject to a 30-day notification to occupants and owners within 150-feet of the subject property. **The mailing of such notification will be perfromed separately.**

BOARD OF APPEALS

An appeal of the approval (or denial) of a **variance application** by the Zoning Administrator may be made to the **Board of Appeals within 10 days** after the **Variance Decision Letter** is issued by the Zoning Administrator.


An appeal of the approval (or denial) of a **building permit application** by the Planning Department may be made to the **Board of Appeals within 15 days** after the **building permit** is issued (or denied) by the Director of the Department of Building Inspection.

Appeals must be submitted in person at the **Board's office at 1650 Mission Street, 3rd Floor, Room 304**. For further information about appeals to the Board of Appeals, including current fees, **contact the Board of Appeals** at **(415) 575-6880**.

ABOUT THIS NOTICE

The Planning Department is currently reviewing its processes and procedures for public notification as part of the Universal Planning Notification (UPN) Project. The format of this Public Hearing notice was developed through the UPN Project and is currently being utilized in a limited trial-run for notification of Variance Hearings.

If you have any comments or questions related to the UPN Project or the format of this notice, please visit our website at http://upn.sfplanning.org for more information.

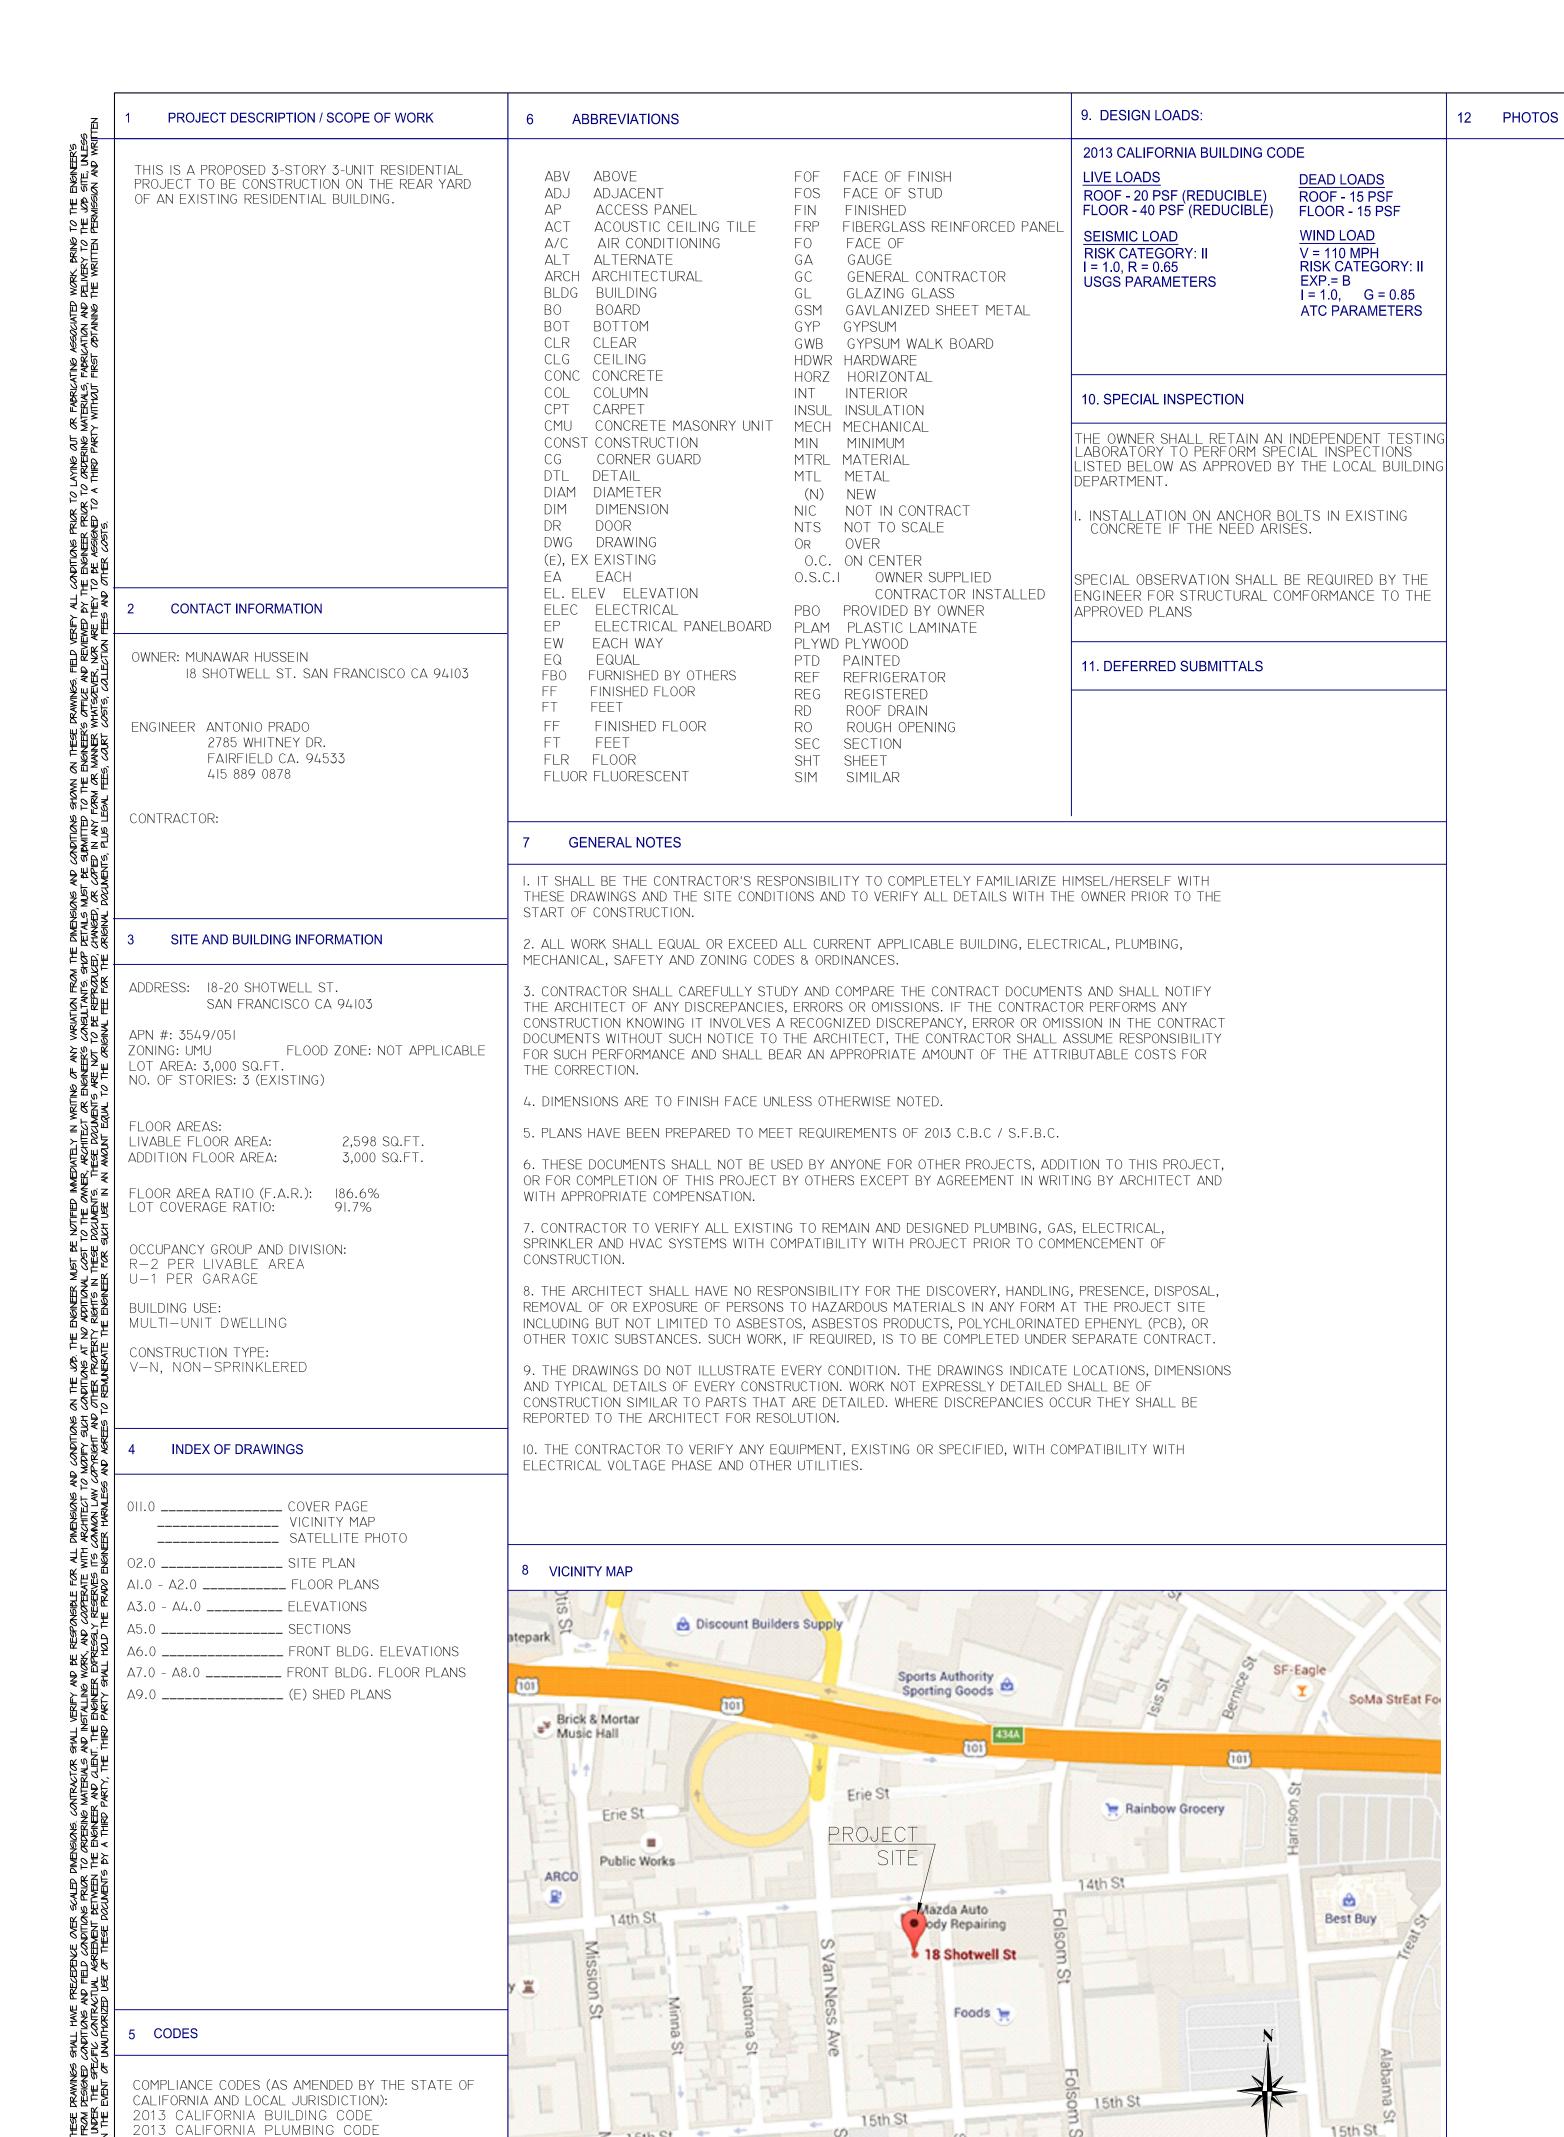


Marshall

SF MUNI; Flynn Division 🏦

2013 CALIFORNIA MECHANICAL CODE 013 CALIFORNIA ELECTRICAL CODE 2013 CALIFORNIA RESIDENTIAL CODE

2013 CALIFORNIA ENERGY CODE


013 CALIFORNIA GREEN BLDG. STANDARDS CODE

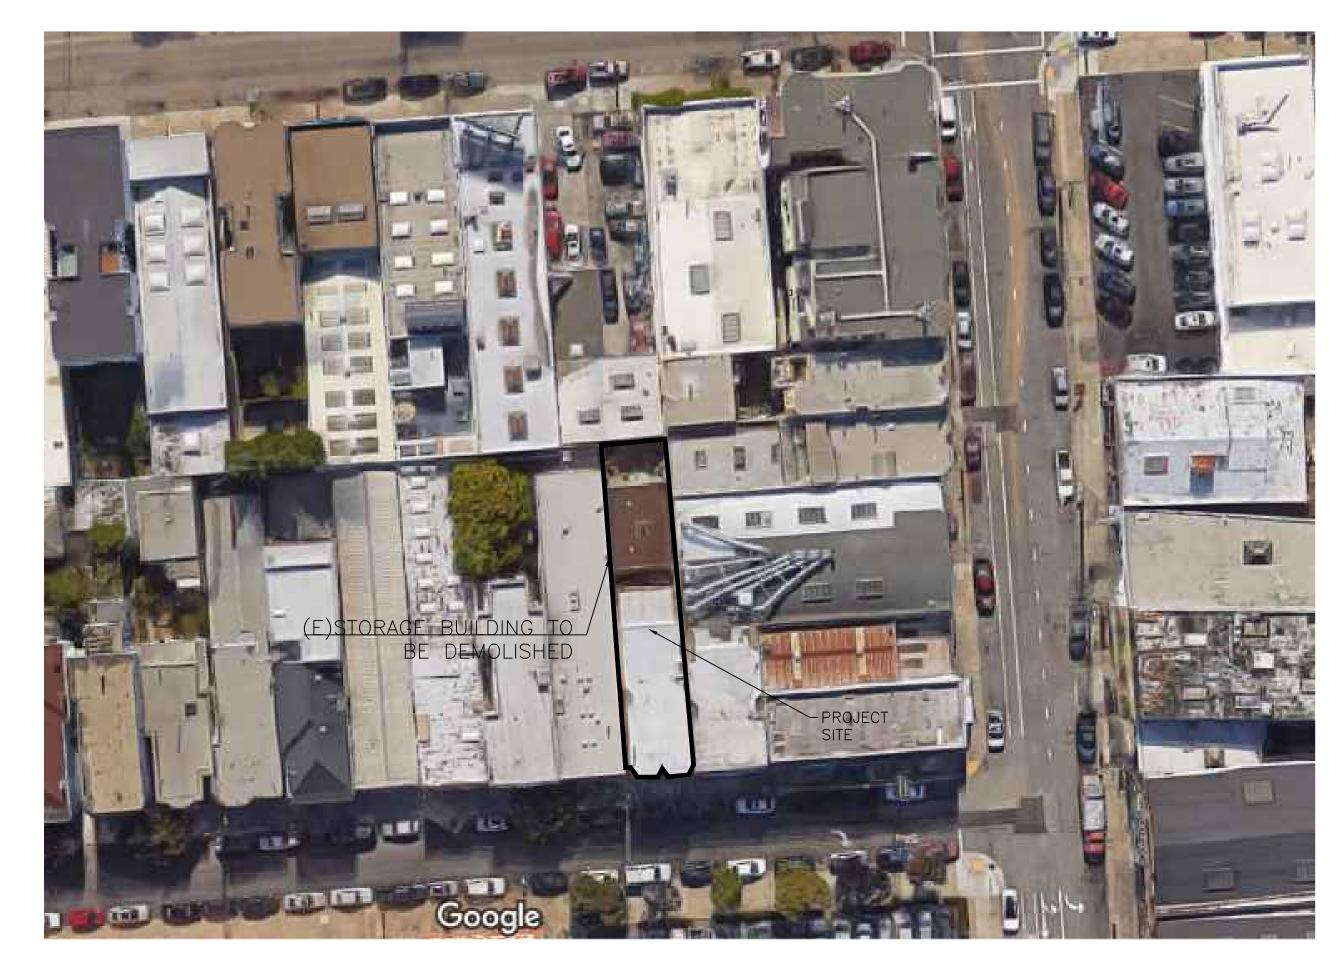





PROJECT SITE

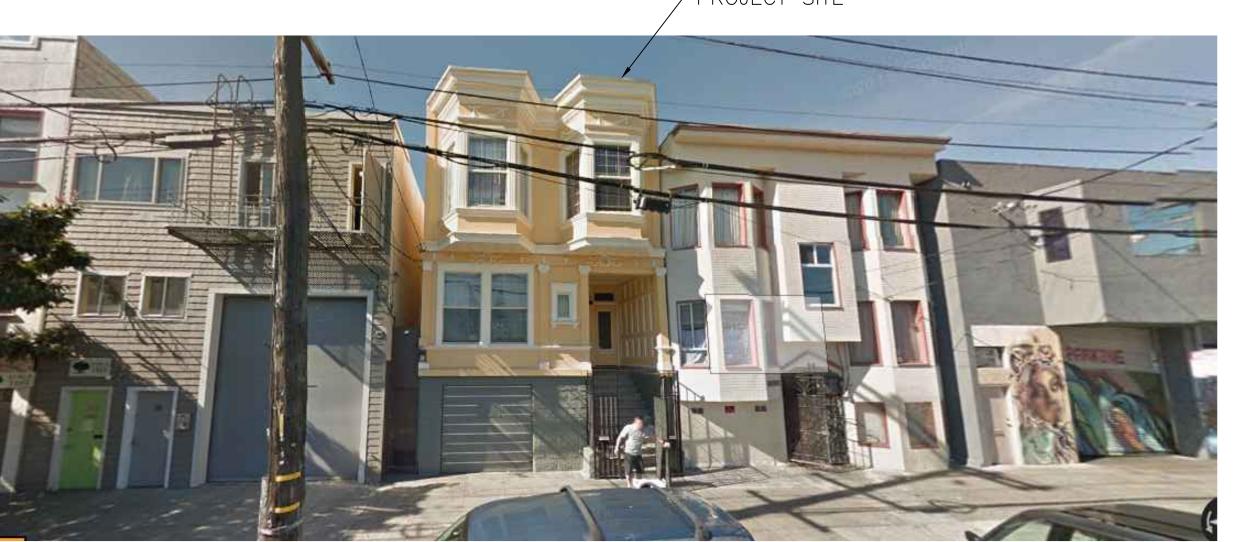

702 FRONT ELEVATION PHOTO \O1.0 / SCALE:

CONSULTANT



PRADO ENGINEERING 2785 WHITNEY DR. FAIRFIELD CA 94533 TEL. (415) 889-0878

 $+ \times Exp. <u>6/30/16</u>$

PROJECT TITLE

NEW 3-STORY 3-UNIT APARTMENT

ADDRESS

18 SHOTWELL ST. SAN FRANCISCO CA 94103


OWNER

MUNAWAR HUSSEIN


REVISIONS DATE DESCRIPTION DRAWN BY: ABP ABP CHECKED BY 1.06.2016

SHEET#

JOB NUMBER :

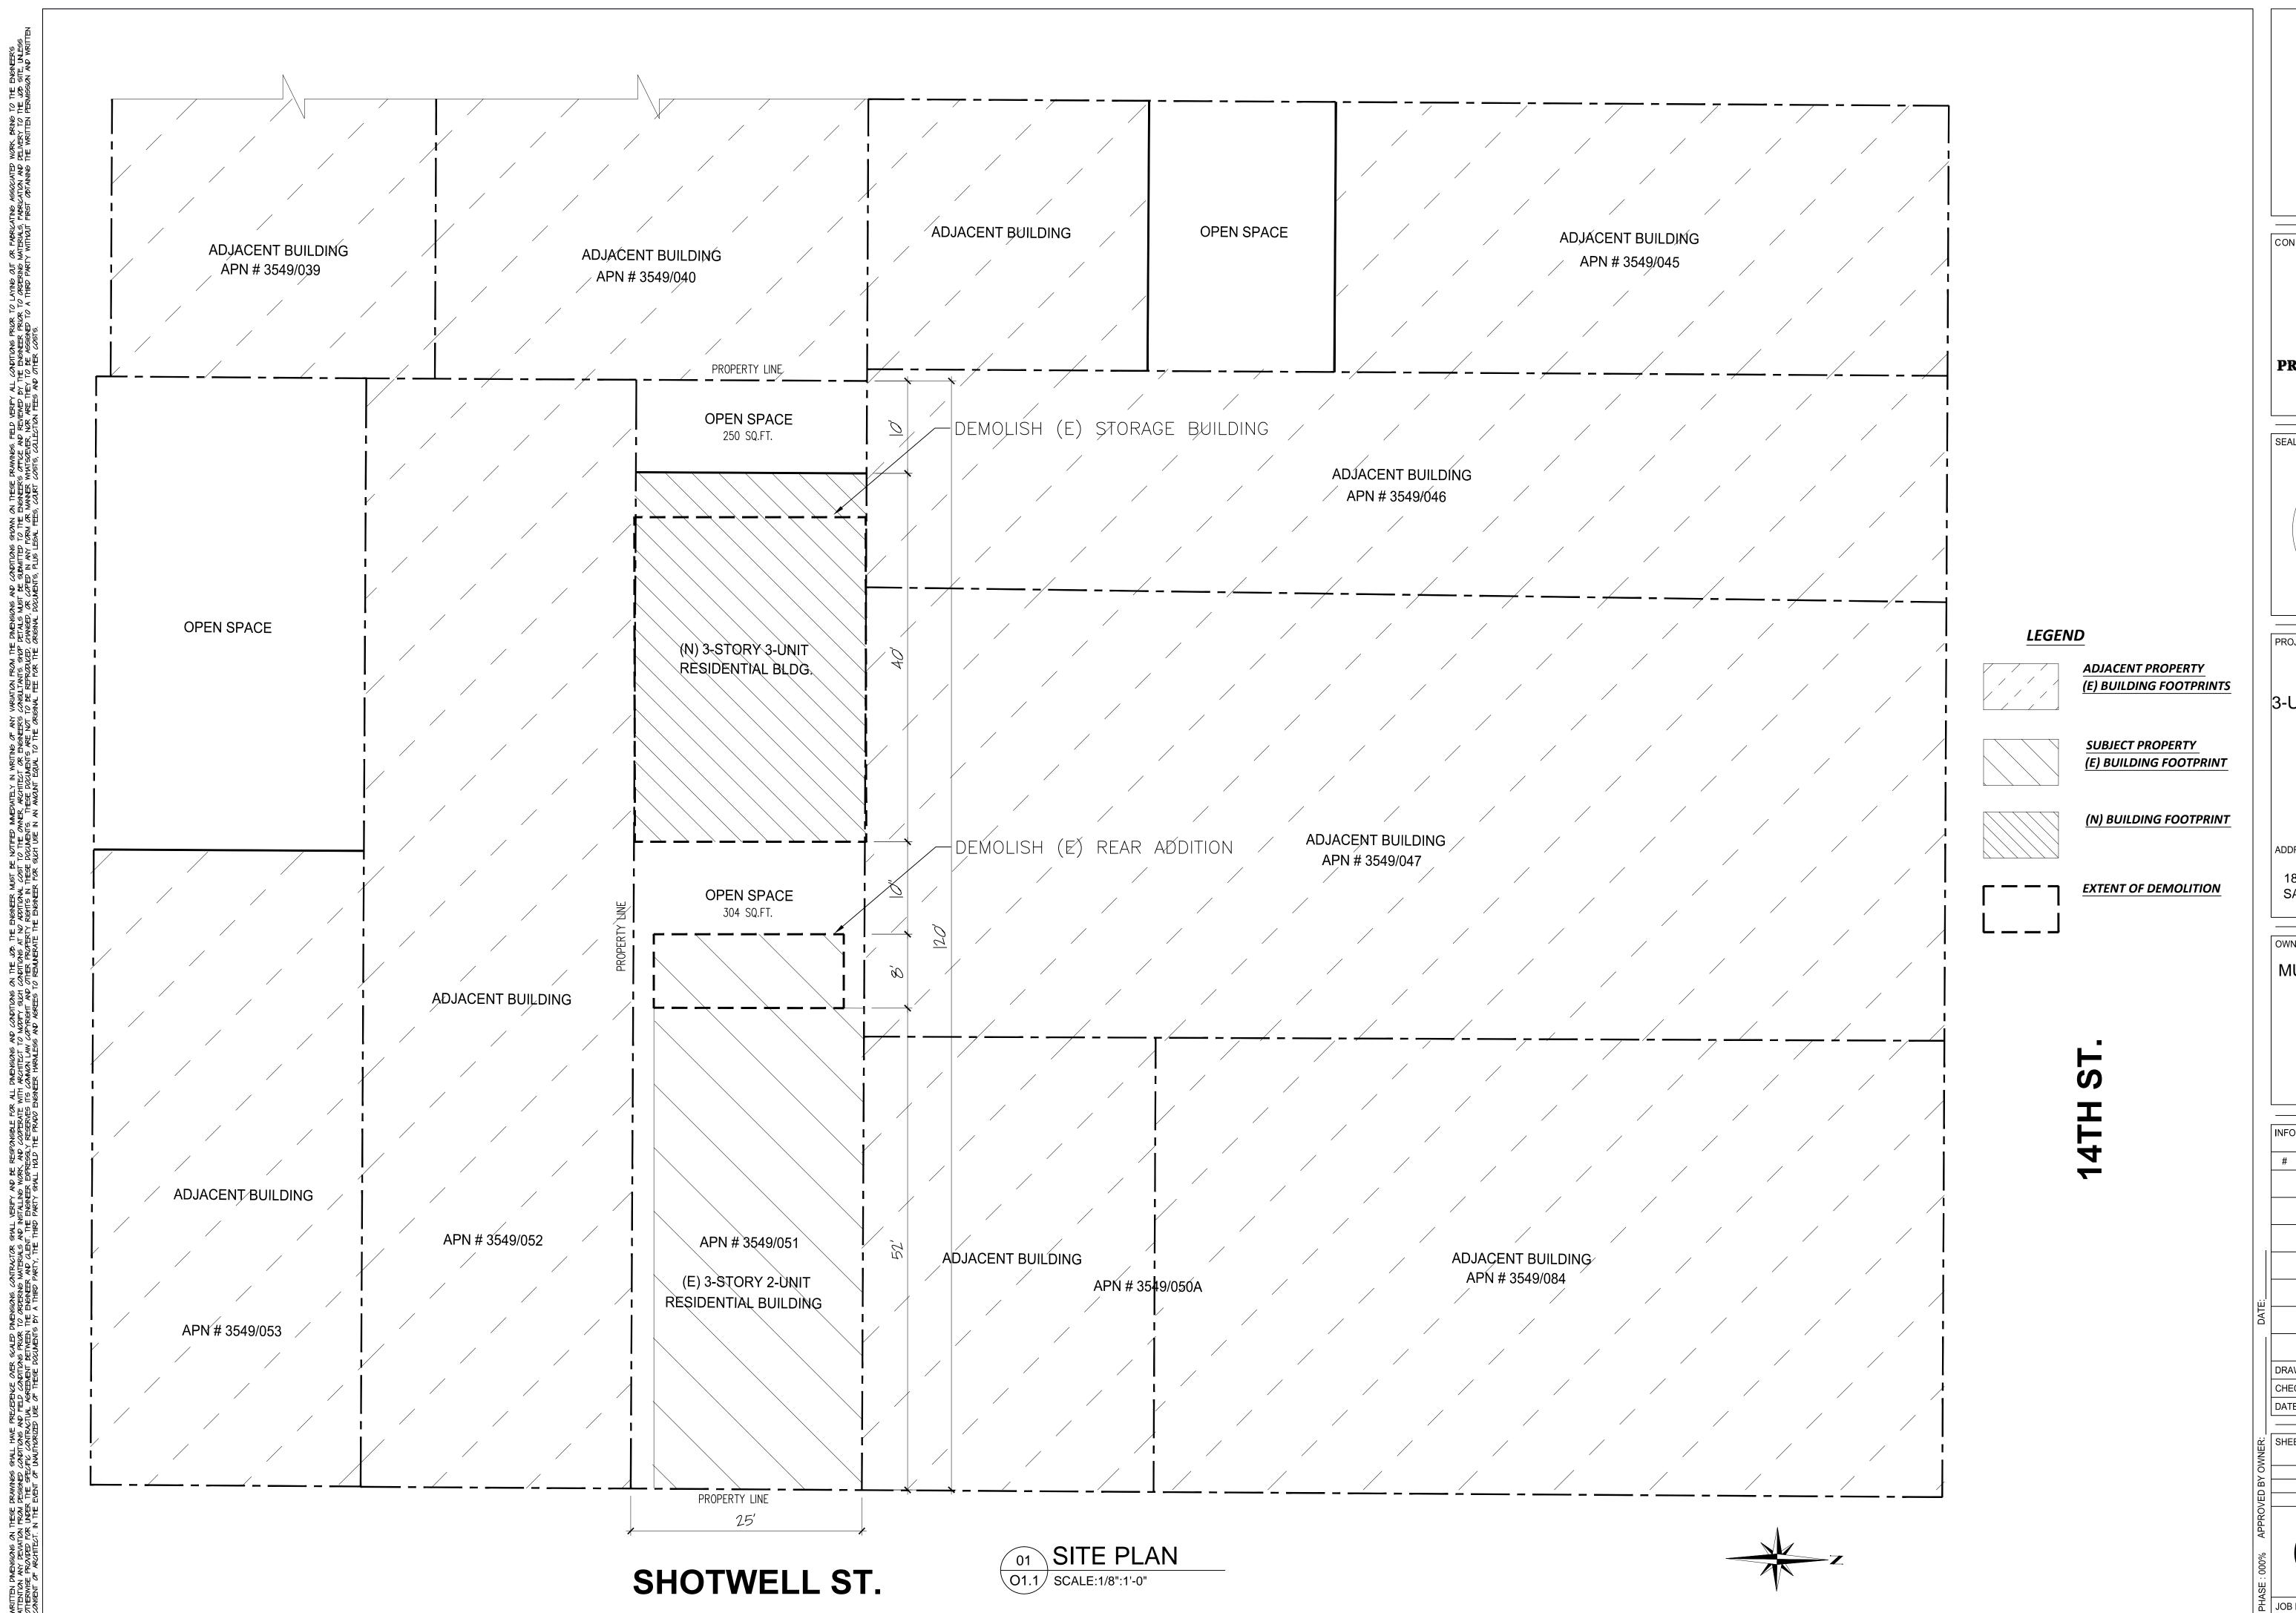

CONSULTANT

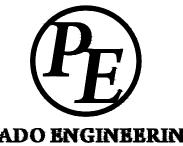

PRADO ENGINEERING
2785 WHITNEY DR.
FAIRFIELD CA 94533
TEL. (415) 889-0878

Exp. 6/30/16

CIVIL

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NEW 3-STORY 3-UNIT APARTMENT

ADDRESS

18 SHOTWELL ST. SAN FRANCISCO CA 94103

MUNAWAR HUSSEIN

REVISIONS DATE DESCRIPTION

DRAWN BY : ABP ABP CHECKED BY 1.06.2016

SHEET#

JOB NUMBER :

ELEVATION NOTES:

- 1 24" X 24" ALUMINUM CLADDING BY "NORTHCLAD" OR EQUIVALENT.
- 2 6" THICK ONE HR. FIRE RATED WALL
- RAMP GUARD RAIL $|\frac{1}{2}$ " ϕ GALV. STEEL POWDER COATED FINISH.
- 4 STAINLESS STEEL HAND RAIL AND CABLE RAILING SYSTEM.
- 5 STEEL STAIRCASE STRINGER AND STEPS POWDER COATED FINISH.
- 6 16" X 24" DIAMOND PATTERN GLASS BLOCK WINDOW
- 7 16" X 16" NAILUP2 ICE PATTERN SOLID GLASS BLOCK WINDOW.


LEGEND & SYMBOLS:

- WINDOW TAG NUMBER (SEE WINDOW SCHEDULE.)
- DOOR TAG NUMBER (SEE D*OO*R SCHEDULE.)
- INDICATES ELEVATION KEYNOTE: REFER TO NUMBERED ITEMS LISTED ON THIS SHEET

NOTES:

- |. ALUMINUM CLADDING 24" X 24" & 7.5" W X L (RAINSCREEN SIDING ADVANTAGELUMBER.COM)
- 2. ANY CHANGES TO THE SHAPE, SIZE AND DIVISIONS OF WINDOWS & DOORS MUST BE REVIEWED & APPROVED BY DESIGNER.
- 2. THE MUNTIN BARS FOR ALL THE DOOR AND WINDOW BREAK-UPS SHALL BE PROVIDED
- 3. RIDGE ELEVATIONS ARE TAKEN AT THE TOP
- 4. ROOF VENTS MUST BE WELL HIDDEN
- 5. ALL PLUMBING & EQUIPMENT VENTS MUST BE CONSOLIDATED & LOCATED IN AREAS THAT MINIMIZE THEIR VISIBILITY. VENTS MUST BE AS LOW IN HEIGHT AS ALLOWED BY CODE & SATISFY THE REQUIREMENTS OF THE DESIGN
- 6. ROOFING SHALL BE FIRE-STOPPED AT EAVE ENDS TO PRECLUDE ENTRY OF FLAME OR EMBERS UNDER THE ROOFING MATERIALS.
- 8. EAVES & SOFFITS SHALL BE PROTECTED BY IGNITION-RESISTANT MATERIALS OR NANCAMBUSTIBLE CONSTRUCTION ON THE EXP*os*ed underside
- 9. EXTERIOR WALLS SHALL | HOUR FIRE RATED
- O. STAIRWAYS SHALL BE WATERPROOFED. PROVIDE WITH RUBBER NON SLIP TREAD
- MINIMUM ONE TEMPERED PANE OR 20-MINUTE
- 12. EXTERIOR DOORS SHALL BE APPROVED NON-COMBUSTIBLE OR MINIMUM OF 1-3/8" SOLID CORE OR 20-MINUTE RATED.
- WITH AWPA M4. CRC R3|7-|.|

LPAVEMENT FFL±0.00

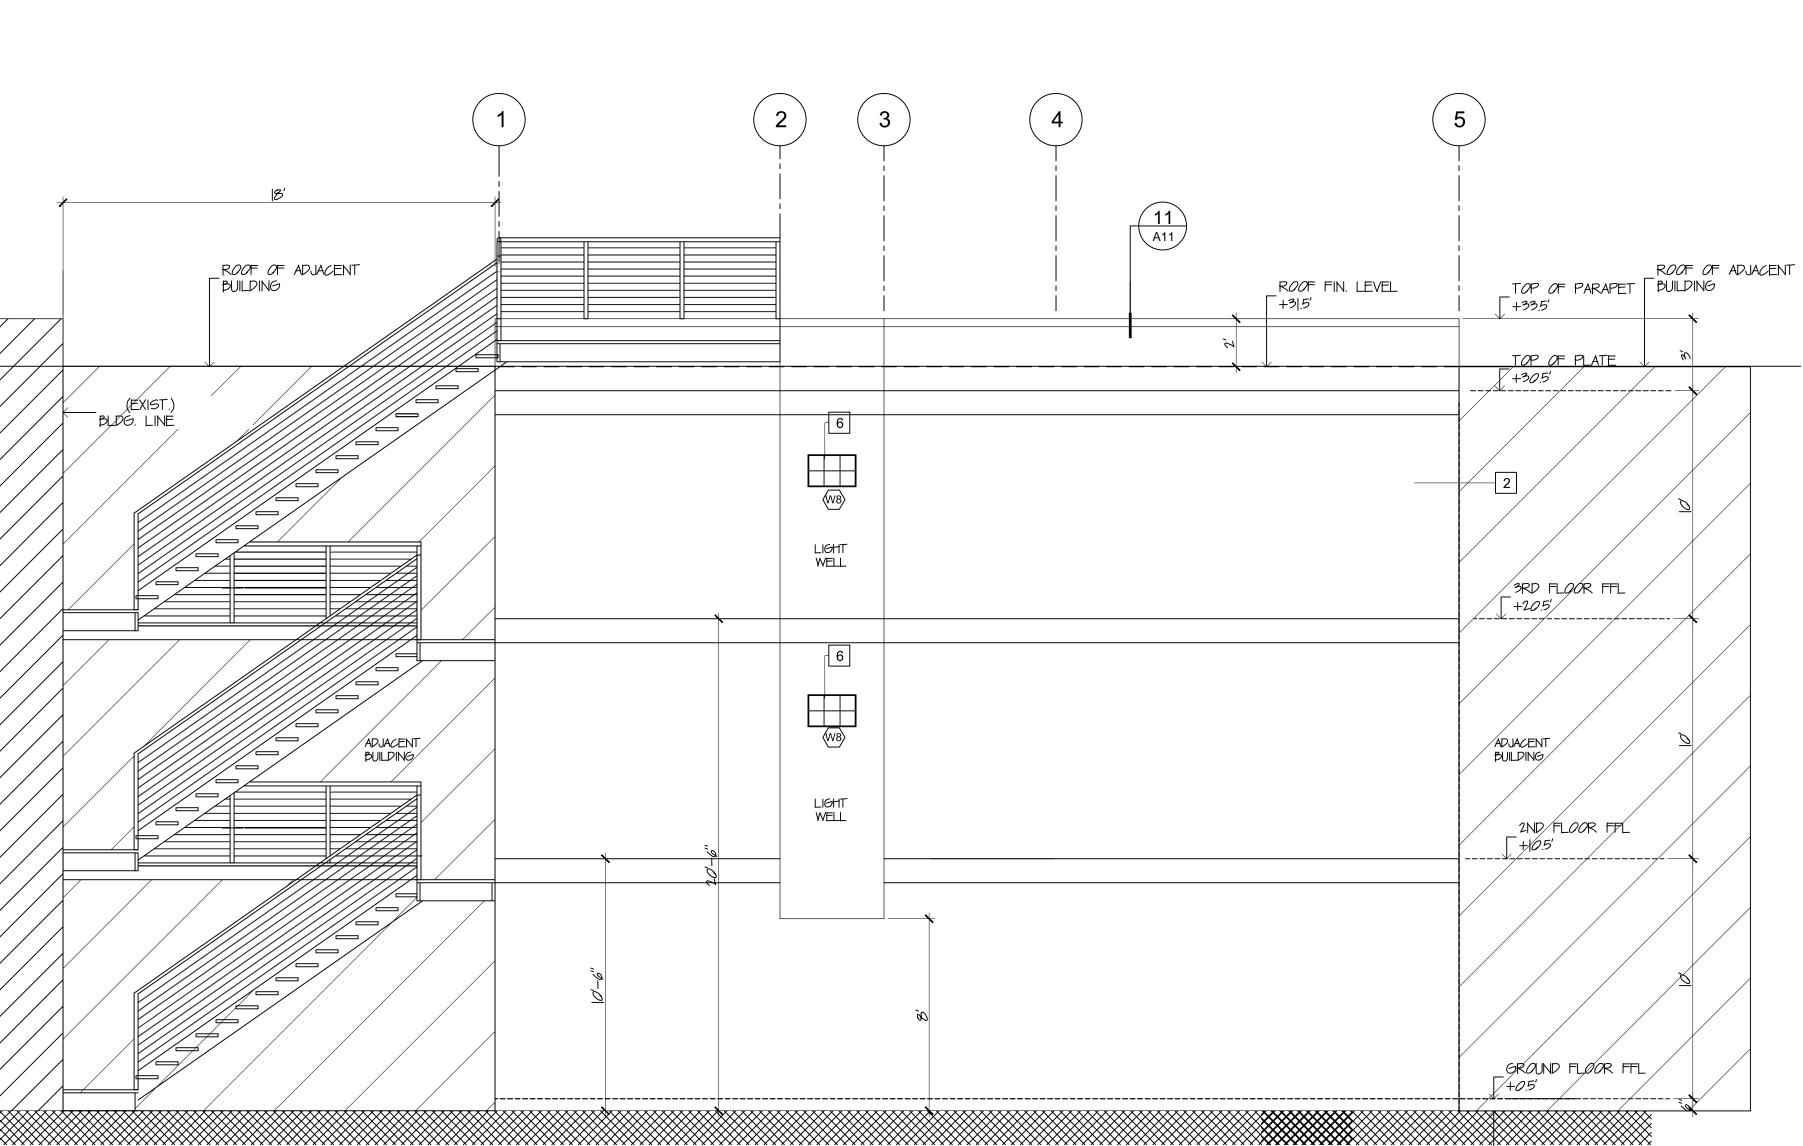



9 A10

R*00*F *0*F — ADJACENT

BUILDING

8 A10

ADJACENT BUILDING/

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ROOF OF ADJACENT

_BUILDING

TOP OF PARAPET

TOP OF PLATE

3RD FLOOR FFL

ADJACENT

2ND FLØOR FFL

BUILDING

_ _+|*0.5'/*

T+33.5'

R*00*F FIN. LEVEL

-+3|.5'

RIGHT SIDE ELEVATION SCALE : 1/4"=1'-0"

WITH A MINIMUM OF 1-1/4".

*O*F FINISH MATERIAL. (e.g. R*00*F TILES)

FROM NEIGHBORING VIEWS AND THE STREET. CONCEALED ROOF VENTS ARE PREFERRED.

GUIDELINES.

7. CHIMNEYS SHALL EXTEND AT LEAST 2 FEET ABOVE ROOF LEVEL WITHIN 10 FEET OF CHIMNEY, AND NOT LESS THAN 3 FEET FROM POINT WHERE CHIMNEY PASSES THROUGH R*00*F(CRC R1*00*3.9.1)

||. WINDOWS SHALL BE MULTI-GLAZED WITH

13. FIELD CUTTING ENDS, NOTCHES, AND DRILLED HOLES OF PRESERVATIVE TREATED WOOD SHALL BE TREATED IN FIELD IN ACCORDANCE

PROJECT TITLE

CONSULTANT

SEAL

NEW 3 STOREY RESIDENTIAL BUILDING

PRADO ENGINEERING 100 Faithorne Lane, Folsom CA 95630.

Tel 415-244-1257

18 SHOTWELL STREET SAN FRANCISCO, CA. 94103

MUNAWAR HUSSEIN

REVISIONS DESCRIPTION DRAWN BY CHECKED BY 10 OCT 15

FRONT & RIGHT ELEVATION

JOB NUMBER

ELEVATION NOTES:

- 1 24" X 24" ALUMINUM CLADDING BY "NORTHCLAD" OR EQUIVALENT.
- 2 6" THICK ONE HR. FIRE RATED WALL
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- I. ALUMINUM CLADDING 24" X 24" & 7.5" W X L (RAINSCREEN SIDING ADVANTAGELUMBER.COM)
- 2. ANY CHANGES TO THE SHAPE, SIZE AND DIVISIONS OF WINDOWS & DOORS MUST BE
- REVIEWED & APPROVED BY DESIGNER. 2. THE MUNTIN BARS FOR ALL THE DOOR AND WINDOW BREAK-UPS SHALL BE PROVIDED
- 3. RIDGE ELEVATIONS ARE TAKEN AT THE TOP *o*f finish material. (e.g. R*oo*f tiles)

WITH A MINIMUM OF 1-1/4".

- 4. ROOF VENTS MUST BE WELL HIDDEN FROM NEIGHBORING VIEWS AND THE STREET. CONCEALED ROOF VENTS ARE PREFERRED.
- 5. ALL PLUMBING & EQUIPMENT VENTS MUST BE CONSOLIDATED & LOCATED IN AREAS THAT MINIMIZE THEIR VISIBILITY. VENTS MUST BE AS LOW IN HEIGHT AS ALLOWED BY CODE & SATISFY THE REQUIREMENTS OF THE DESIGN GUIDELINES.
- 6. ROOFING SHALL BE FIRE-STOPPED AT EAVE ENDS TO PRECLUDE ENTRY OF FLAME OR EMBERS UNDER THE ROOFING MATERIALS.
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- 8. EAVES & SOFFITS SHALL BE PROTECTED BY IGNITION-RESISTANT MATERIALS OR NONCOMBUSTIBLE CONSTRUCTION ON THE EXP*os*ed underside
- 9. EXTERIOR WALLS SHALL I HOUR FIRE RATED
- O. STAIRWAYS SHALL BE WATERPROOFED. PROVIDE WITH RUBBER NON SLIP TREAD
- ||. WINDOWS SHALL BE MULTI-GLAZED WITH MINIMUM ONE TEMPERED PANE OR 20-MINUTE
- 12. EXTERIOR DOORS SHALL BE APPROVED NON-COMBUSTIBLE OR MINIMUM OF 1-3/8" SOLID CORE OR 20-MINUTE RATED.
- 13. FIELD CUTTING ENDS, NOTCHES, AND DRILLED HOLES OF PRESERVATIVE TREATED WOOD SHALL BE TREATED IN FIELD IN ACCORDANCE WITH AWPA M4. CRC R3|7-|.|

CONSULTANT

PRADO ENGINEERING 100 Faithorne Lane, Folsom CA 95630.

Tel 415-244-1257

SEAL

PROJECT TITLE

NEW 3 STOREY RESIDENTIAL BUILDING

18 SHOTWELL STREET

SAN FRANCISCO, CA. 94103

MUNAWAR HUSSEIN


REVISIONS DESCRIPTION DRAWN BY

REAR & LEFT ELEVATION

10 OCT 15

CHECKED BY

JOB NUMBER

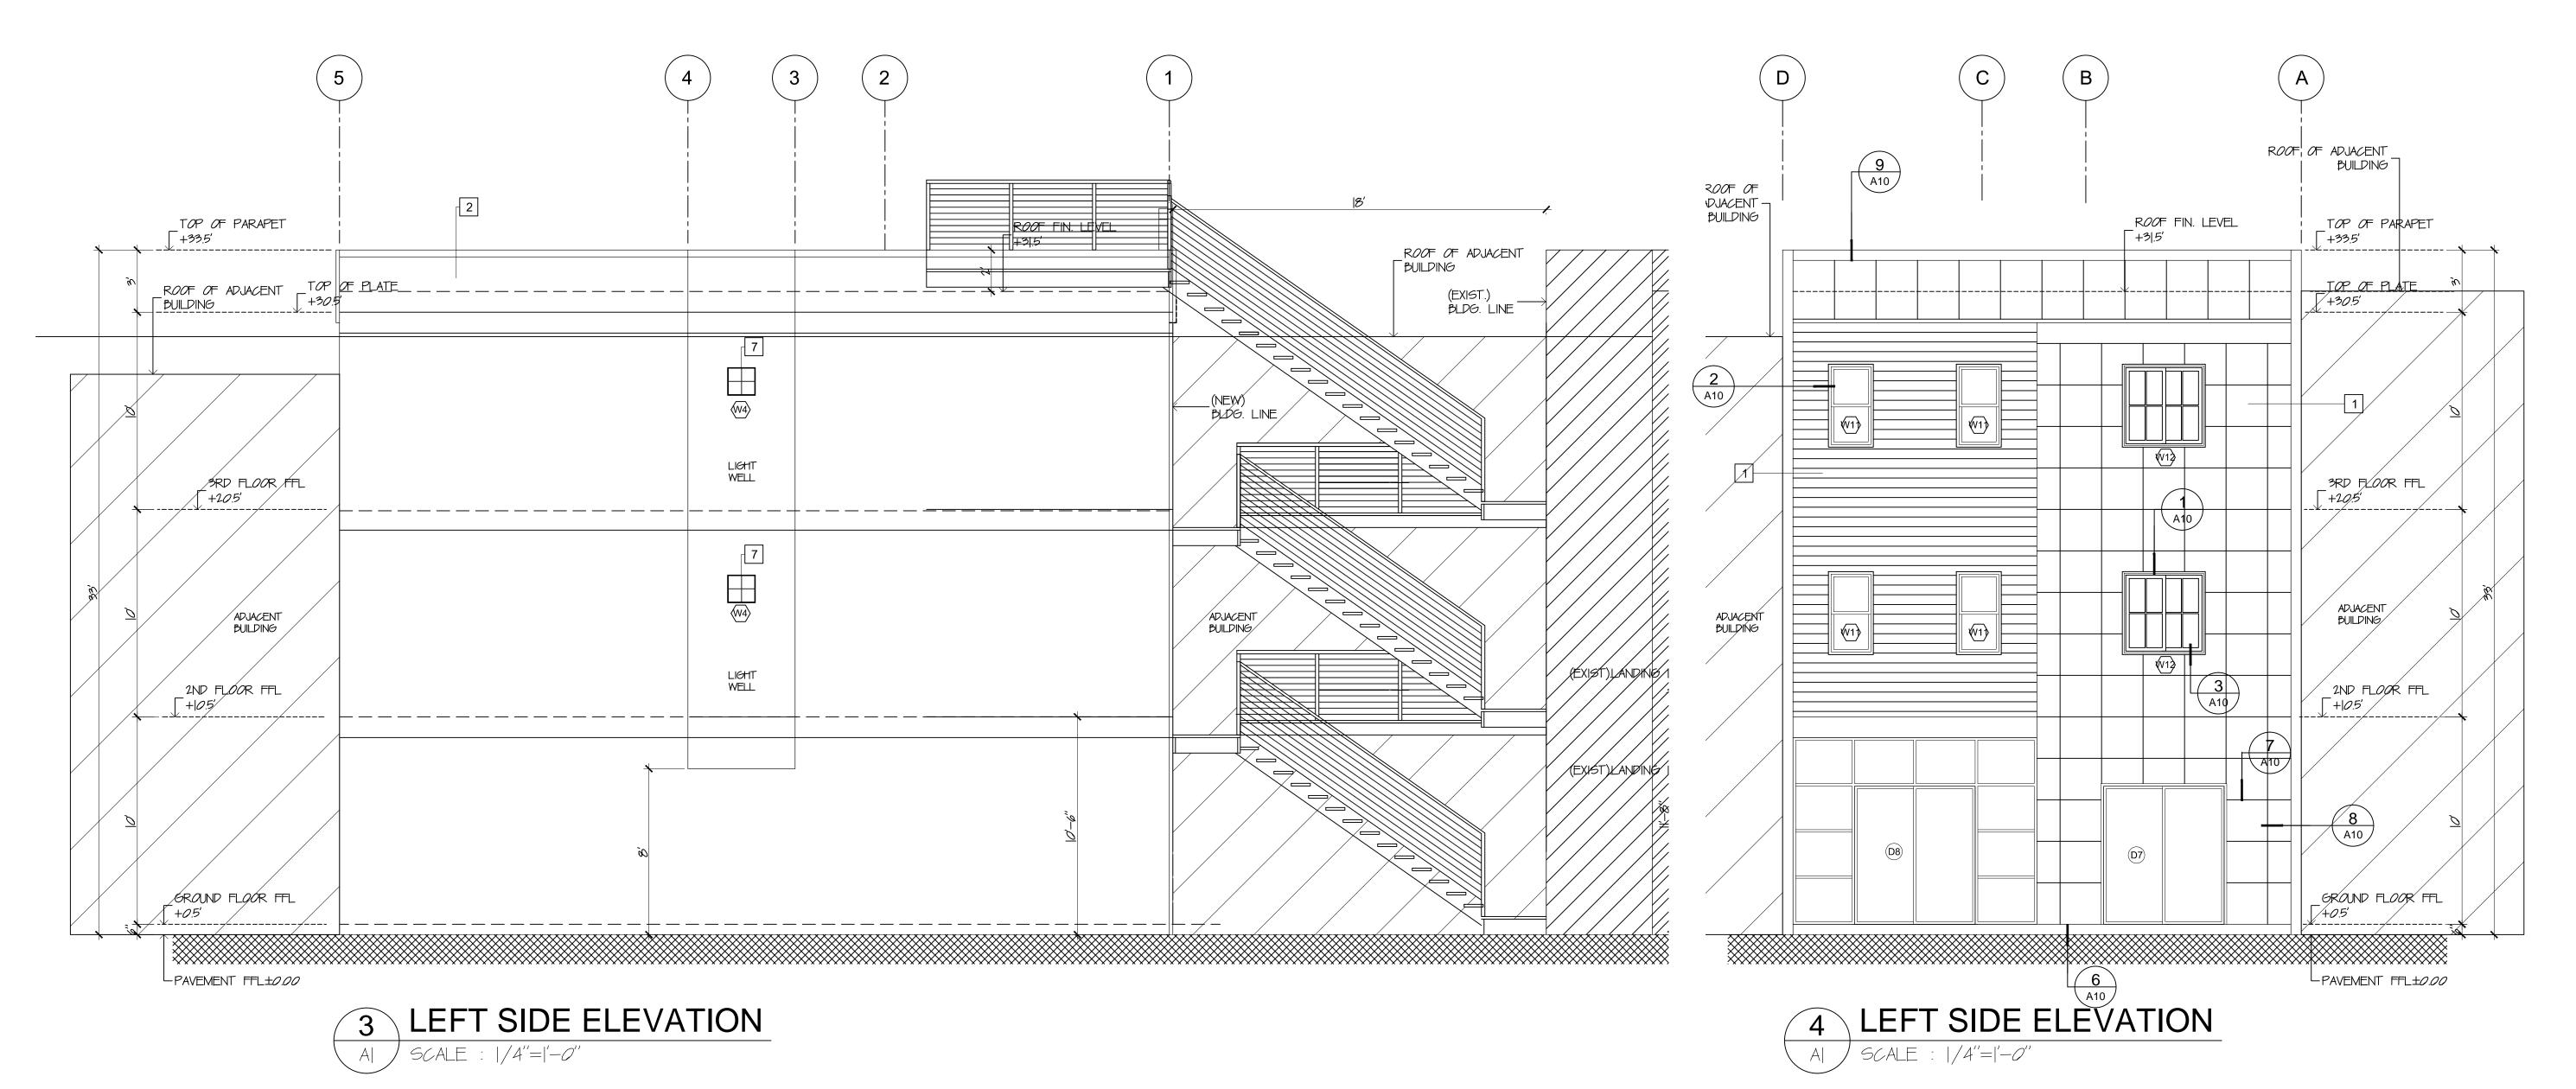

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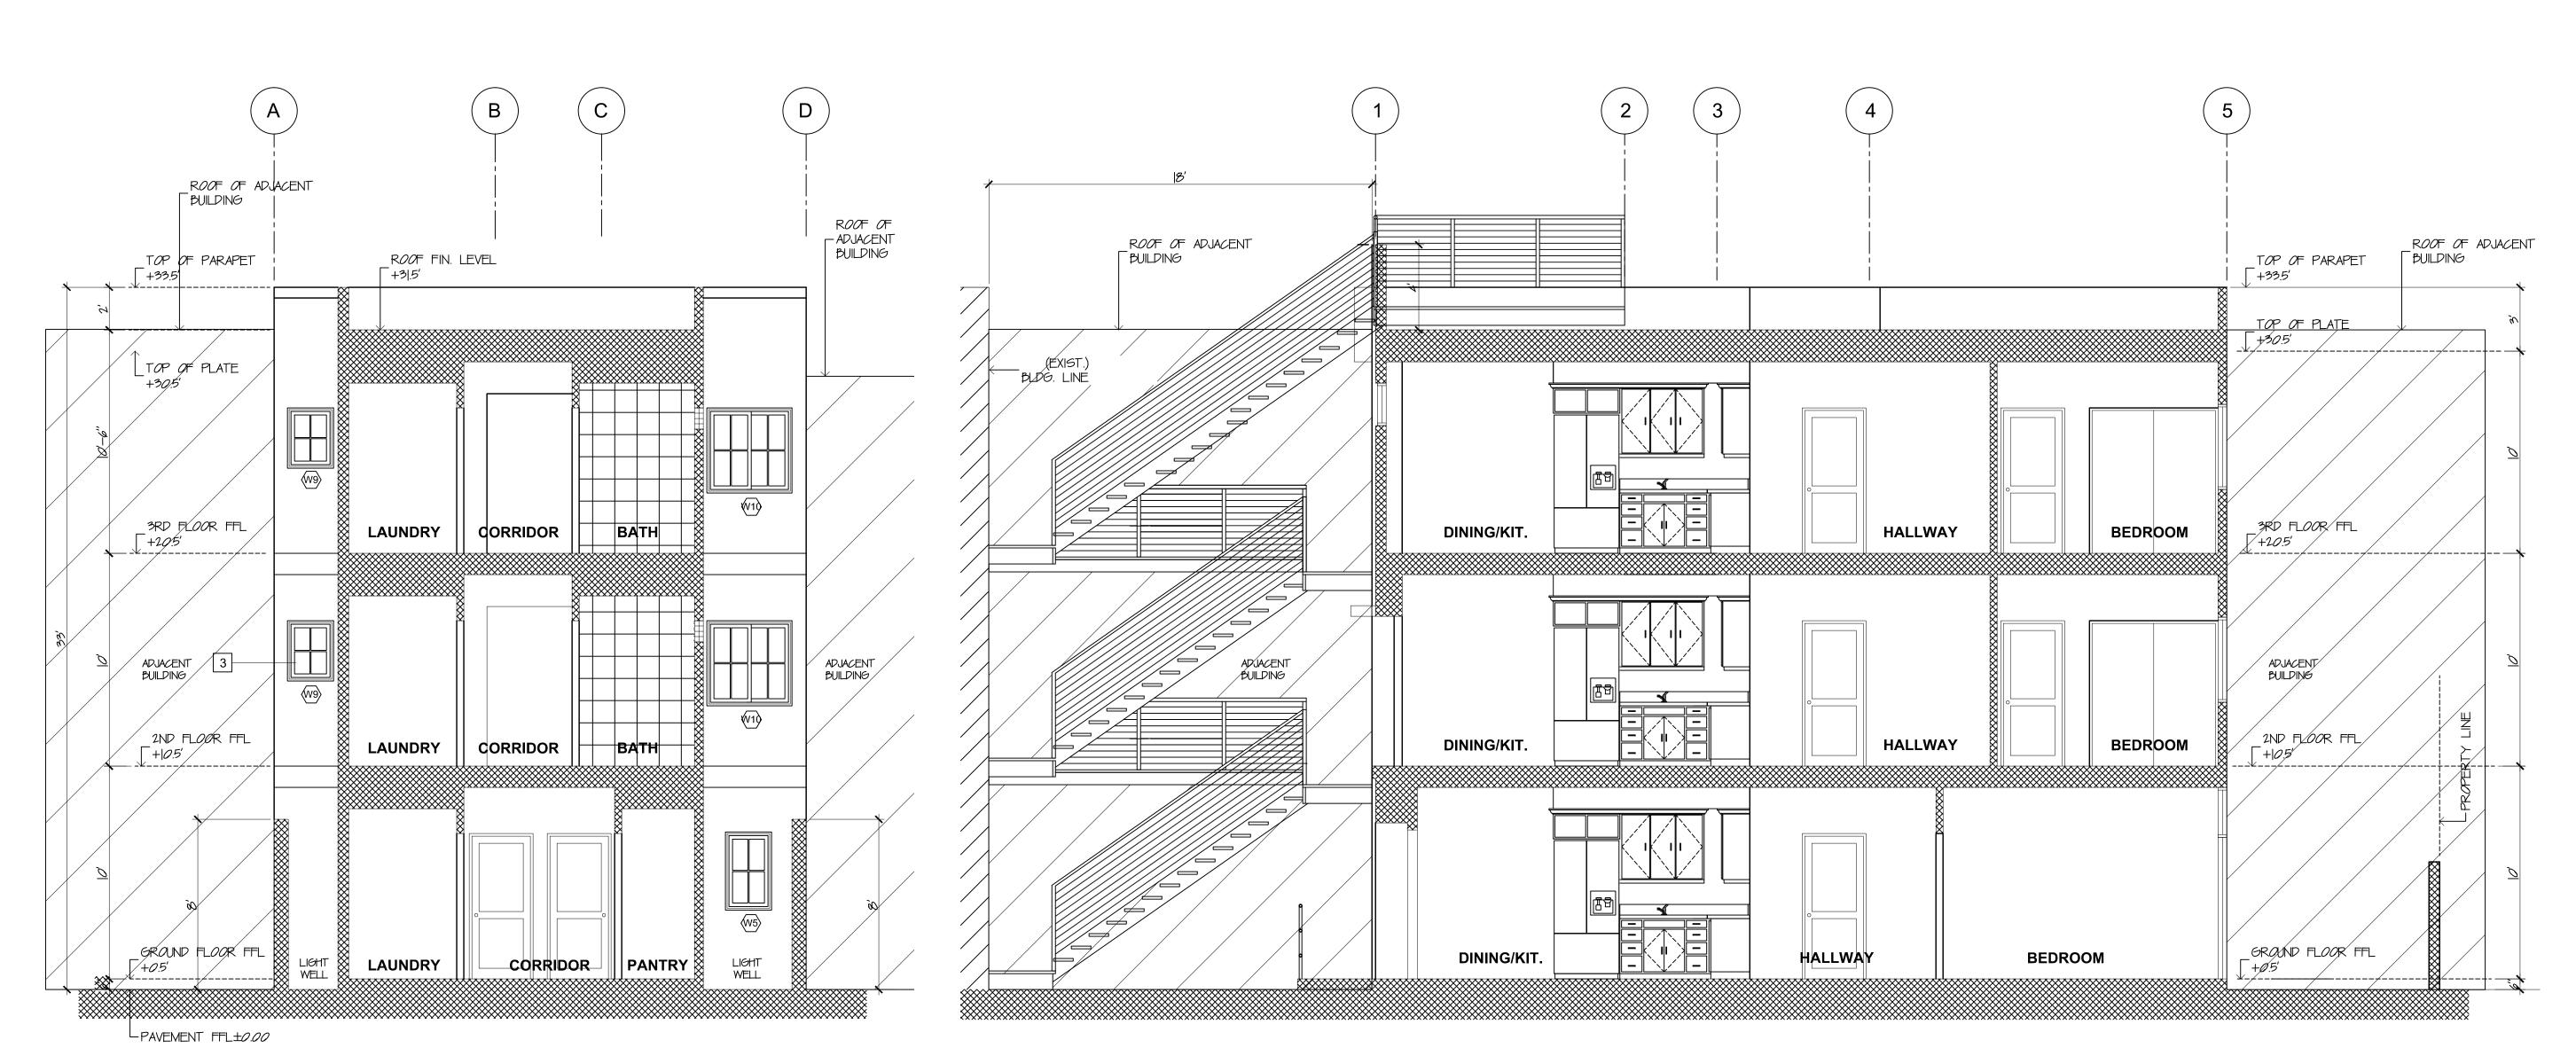
SECTION NOTES:

- I. PROPERTY WALL SHALL 6" THICK ONE HOUR FIRE RATED.
- 2. PROVIDE 1/2" MINIMUM CLEARANCE BETWEEN TOP PLATE OF INTERIOR PARTITIONS AND BOTTOM CHORD OF TRUSSES (TO INSURE LOADING WILL BE AS DESIGNED)
- 3. PROVIDE FIRE BLOCKING / STOPS AT THE FOLLOWING LOCATIONS (PER CRC R302.||):
 a. IN CONCEALED SPACES |0' O.C.
 HORIZONTAL, VERTICALLY AT THE

CEILING AND FLOOR LEVELS;


- b. AT ALL CONNECTIONS BETWEEN
 HORIZONTAL & VERTICAL SPACES;
 c. IN CONCEALED SPACES BETWEEN STAIR
 & LANDING;
- d. IN OPENINGS AROUND VENTS, PIPES, DUCTS, CABLES, WIRES, CHIMNEYS & FIREPLACES.
- 4. FIELD CUTTING ENDS, NOTCHES, AND DRILLED HOLES OF PRESERVATIVE TREATED WOOD SHALL BE TREATED IN FIELD IN ACCORDANCE WITH AWPA M4 PER CRC R3|7-|.|
- 5. PROVIDE DRAFT STOPS AT THE FOLLOWING LOCATIONS:
 - a. IN ANY CONCEALED SPACE WHERE THERE IS USABLE SPACE BOTH ABOVE AND BELOW THE CONCEALED SPACE. THE CONCEALED SPACE SHALL NOT EXCEED 1000 SQ. FT. PER CRC R302.12
- 6. FOR EACH ENCLOSED ATTIC SPACE WITH A MAXIMUM VERTICAL HEIGHT GREATER THAN 30 INCHES, PROVIDE A MINIMUM OF 22x30 INCHES ATTIC ACCESS. (CRC R807.1)

- 7. ROOF: "DURO LAST" SINGLE PLY ROOF MEMBRANE
 OR EQUIVALENT FOR LOW SLOPE ROOFING MATERIAL
 (CERTIFIED ENERGY EFFICIENT REFER TO
 MANUFACTURER'S SPECIFICATIONS & TECHNICAL INFO.)
- 8. ROOF / CEILING JOIST PER STRUCTURAL
- 9. R-30 INSULATION @ ALL CEILINGS, TYP.
- 10. R-19 INSULATION @ ALL 2×8 JOIST RAFTER CONDITIONS
- ||. R-|3 INSULATION IN 2×4 EXTERIOR WALLS & R-|9 INSULATION IN 2×6 EXTERIOR WALLS
- |2. R-|3 INSULATION @ ALL INTERIOR WALLS, TYP.
- 13. R-19 INSULATION @ ALL FLOOR JOIST BAYS, TYP.
- 14. R-19 INSULATION IN ALL JOIST BAYS OVER OR UNDER UNCONDITIONED SPACES, TYP.
- 15. FLOOR SHT'G. PER STRUCTURAL PLANS
- 16. ROOF SHT'G. PER STRUCTURAL PLAN
- 17. FLOOR FRAMING PER STRUCTURAL PLAN.
- 18. STAIRCASE FRAMING PER STRUCTURAL PLAN
- 19. GUARD RAILS AND CABLE RAILING SYSTEM REFER TO MANUFACTURERS SPECIFICATION & TECHNICAL INFO.





WRITING OF ANY OR ENGINEER'S O MENTS ARE NOT : EQUAL TO THE O

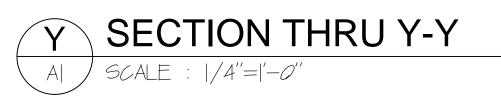

CONSULTANT



EAL

PROJECT TITLE

NEW 3 STOREY RESIDENTIAL BUILDING

18 SHOTWELL STREET SAN FRANCISCO, CA. 94103

OWNE

MUNAWAR HUSSEIN

-				
INFO REVISIONS				
#	DATE	DESCRIPTION		
DRAWN BY :		NM		
CHECKED BY:		AP		
DATE:		10 OCT 15		
	# DRAV	# DATE # DATE DRAWN BY: CHECKED BY:		

SHEET#
SECTIONS

A5

JOB NUMBER: 000



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(E) FRONT BLDG. WEST ELEVATION

A6 SCALE:1/4":1'-0"



(N) FRONT BLDG. WEST ELEVATION


SCALE:1/4":1'-0"

CONSULTANT



PRADO ENGINEERING
2785 WHITNEY DR.
FAIRFIELD CA 94533
TEL. (415) 889-0878

SEAL

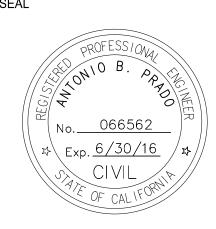

PROJECT TITLE

NEW 3-STORY 3-UNIT APARTMENT

ADDRESS

18 SHOTWELL ST. SAN FRANCISCO CA 94103

OWNER

MUNAWAR HUSSEIN

	INFO	REVISIONS				
	#	DATE	DESCRIPTION			
DA F						
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	DRAWN BY :		ABP			
CHECK		KED BY :	ABP			
	DATE	:	1.06.2016			

SHEET#

A6

JOB NUMBER: 130