## MEMO

# **Disclaimer for Review of Plans**

The San Francisco Planning Code requires that the plans of certain proposed projects be provided to members of the public prior to the City's approval action on the project. Accordingly, any images of plans featured on this website are provided for the primary purpose of facilitating public input prior to the City's action. The City and County of San Francisco does not own the copyright to these images. Please be aware that the unauthorized reproduction, distribution, or alteration of these images may result in a violation of Federal Copyright Law (17 U.S.C.A. Sections 101 et seq.) and that any party who seeks to reproduce or alter these images does so at his or her own risk.

Additionally, plans provided on this website are limited to site plans, elevations and/or section details (floor plans and structural details may not be included). These are DRAFT PLANS being provided for public review PRIOR to the City's approval action on the project. Final plans may differ from those that are currently available for review.

1650 Mission St. Suite 400 San Francisco, CA 94103-2479

Reception: 415.558.6378

Fax: 415.558.6409

Planning Information: 415.558.6377 NOTICE OF PUBLIC HEARING

Hearing Date: Wednesday, May 25, 2016

Time: **9:30 AM** 

Location: City Hall, 1 Dr. Carlton B. Goodlett Place, Room 408

Case Type: Variance(Rear Yard)
Hearing Body: Zoning Administrator

PORPERTY INFORMATION		APPLICATION INFORMATION	
Project Address:	4229 20th St	Case No.:	2015-016017VAR
Cross Street(s):	Collingwood/Castro	Building Permit:	2015.12.01.3895
Block / Lot No.:	2752/031	Applicant/Agent:	George Schevon
Zoning District(s):	RH-3	Telephone:	510-644-3407
Area Plan:	N/A	E-Mail:	george@studio4architecture.com

# PROJECT DESCRIPTION

The proposal is to construct a side addition (east elevation), increase the roof height on the building's rear portion, install new windows/doors and expand the rear deck.

**SECTION 134 OF THE PLANNING CODE** requires a rear yard of 34 feet 2 inches. The project proposes to expand a portion of the existing building which encroaches into the required rear yard and legalize and expand the existing rear deck/stairs which are located within the required rear yard; therefore, a variance is required.

### ADDITIONAL INFORMATION

FOR MORE INFORMATION, PLEASE CONTACT PLANNING DEPARTMENT STAFF:

Planner: Nancy Tran Telephone: 415-575-9174 Mail: Nancy.H.Tran@sfgov.org

**ARCHITECTURAL PLANS:** The site plan and elevations of the proposed project are available on the Planning Department's website at: <a href="http://sf-planning.org/ftp/files/notice/2015-016017VAR.pdf">http://sf-planning.org/ftp/files/notice/2015-016017VAR.pdf</a>

中文詢問請電:558.6378

Para información en Español llamar al: 558.6378

# GENERAL INFORMATION ABOUT PROCEDURES

#### VARIANCE HEARING INFORMATION

Under Planning Code Section 306.3, you, as a property owner or resident within 300 feet of this proposed project or interested party on record with the Planning Department, are being notified of this Variance Hearing. You are not obligated to take any action. For more information regarding the proposed work, or to express concerns about the project, please contact the Applicant/Agent or Planner listed on this notice as soon as possible. Additionally, you may wish to discuss the project with your neighbors and neighborhood association or improvement club, as they may already be aware of the project.

Persons who are unable to attend the public hearing may submit written comments regarding this application to the Zoning Administrator, Planning Department, 1650 Mission Street, Suite 400, San Francisco, CA 94103, by 5:00pm the day prior to the hearing. These comments will be made a part of the official public record, and will be brought to the attention of the person or persons conducting the public meeting or hearing

### **BUILDING PERMIT APPLICATION INFORMATION**

Under Planning Code Section 311, the Building Permit Application for this proposal is also subject to a 30-day notification to occupants and owners within 150-feet of the subject property. On May 4, 2016, the Department issued the required Section 311 notification for this project (expires June 3, 2016).

#### **BOARD OF APPEALS**

An appeal of the approval (or denial) of a **variance application** by the Zoning Administrator may be made to the **Board of Appeals within 10 days** after the **Variance Decision Letter** is issued by the Zoning Administrator.

An appeal of the approval (or denial) of a **building permit application** by the Planning Department may be made to the **Board of Appeals within 15 days** after the **building permit** is issued (or denied) by the Director of the Department of Building Inspection.

Appeals must be submitted in person at the **Board's office at 1650 Mission Street, 3rd Floor, Room 304**. For further information about appeals to the Board of Appeals, including current fees, **contact the Board of Appeals** at **(415) 575-6880**.

#### **ABOUT THIS NOTICE**

The Planning Department is currently reviewing its processes and procedures for public notification as part of the Universal Planning Notification (UPN) Project. The format of this Public Hearing notice was developed through the UPN Project and is currently being utilized in a limited trial-run for notification of Variance Hearings.

If you have any comments or questions related to the UPN Project or the format of this notice, please visit our website at <a href="http://upn.sfplanning.org">http://upn.sfplanning.org</a> for more information.

中文詢問請電:558.6378

Para información en Español llamar al: 558.6378

ALL WORK SHALL COMPLY WITH THE 2013 CALIFORNIA BUILDING UNLESS NOTED OTHERWISE

ALL WORK SHALL BE COMPLETED SKILLFULLY AND IN ACCORDANCE 28 WITH ACCEPTED TRADE STANDARDS

EXCEPT WHERE CONTRACT DOCUMENTS INCLUDE MORE STRINGENT REQUIREMENTS, APPLICABLE INDUSTRY STANDARDS INCLUDING MANUFACTURER STANDARDS AND INSTALLATION INSTRUCTIONS HAVE THE SAME FORCE AND EFFECT AS IF BOUND OR COPIED INTO THE CONTRACT DOCUMENTS. SUCH STANDARDS ARE PART OF THE CONTRACT DOCUMENTS BY REFERENCE. WHERE COMPLIANCE WITH A STANDARD IS REQUIRED, COMPLY WITH THE STANDARD IN EFFECT AS OF THE DATE OF THE CONTRACT

THE DRAWINGS SHOW ONLY REPRESENTATIVE TYPICAL DETAILS TO ASSIST THE CONTRACTOR AND DO NOT ILLUSTRATE EVERY

THE CONTRACT DOCUMENTS ARE COMPLEMENTARY AND WHAT IS REQUIRED BY ANY ONE SHALL BE AS BINDING AS IF REQUIRED BY ALL. THE INTENTION OF THE DOCUMENTS IS TO INCLUDE ALL LABOR, MATERIALS, EQUIPMENT, AND OTHER ITEMS AS NECESSARY FOR THE PROPER EXECUTION AND COMPLETION OF THE WORK.

THE CONTRACTOR SHALL COORDINATE THE VARIOUS CONSTRUCTION ACTIVITIES TO ASSURE EFFICIENT AND ORDERLY INSTALLATION OF EACH PART OF THE WORK. COORDINATE CONSTRUCTION OPERATIONS THAT ARE DEPENDENT UPON EACH

OTHER FOR PROPER INSTALLATION, CONNECTION AND OPERATION OWNER PROVIDED MATERIALS. THE OWNER SHALL DETERMINE LEAD TIME FOR ALL PRODUCTS AND DELIVER PRODUCTS WHEN NEEDED BY THE CONTRACTOR. THE CONTRACTOR SHALL PROVIDE A SCHEDULE OF THESE ITEMS TO THE OWNER WITHIN TWO WEEKS AFTER THE START OF CONSTRUCTION

THE CONTRACTOR IS SOLELY RESPONSIBLE FOR CONSTRUCTION MEANS AND METHODS. 10 THE CONTRACTOR SHALL INFORM THE ARCHITECT OF SCHEDULE

11 THE CONTRACTOR SHALL INFORM THE ARCHITECT ON THE PROGRESS OF THE WORK ON A WEEKLY BASIS OR MORE

FREQUENTLY AS CONDITIONS WARRANT 12 THE CONTRACTOR SHALL SCHEDULE MEETINGS WITH THE OWNER ON A TIMELY BASIS AND TO ALLOW FOR TIME REQUIRED TO PROVIDE APPROPRIATE RESPONSE TO ANY QUESTIONS OR SITE

13 THE CONTRACTOR SHALL ARRANGE FOR A PRECONSTRUCTION MEETING AND FOR ANOTHER MEETING, AFTER DETERMINING THE PROJECT DIMENSIONAL LAYOUT, FOR THE REVIEW BY THE

ARCHITECT AND OWNER. 14 THE CONTRACTOR SHALL ALLOW TWO WEEKS FOR REVIEW OF SUBMITTALS, SHOP DRAWINGS, SUBSTITUTIONS, AND RFI'S BY THE ARCHITECT. CONTRACTOR SHALL REVIEW ALL SUBMITTALS BEFORE ISSUING THEM TO THE ARCHITECT FOR REVIEW.

15 SUBMIT SHOP DRAWINGS OF ELEVATIONS OF WINDOW WALLS AND FULL-SIZE DETAILS SHOWING THICKNESS, PROFILES, JOINTING, CONNECTIONS, AND ASSEMBLY OF VARIOUS MEMBERS, REINFORCEMENT, ANCHORAGE, AND SUPPORTS, FLASHING AND

THE CONTRACTOR SHALL IMMEDIATELY NOTIFY THE ARCHITECT OF ANY DISCREPANCIES WITHIN THE CONTRACT DOCUMENTS

 THE CONTRACT DOCUMENTS AND EXISTING FIELD CONDITIONS. 2. MANUFACTURER'S INSTRUCTIONS, REGULATIONS, CODES AND THE CONTRACT DOCUMENTS.

ALL CHANGE ORDERS SHALL BE IN WRITING AND SHALL BE SIGNED BY THE OWNER AND CONTRACTOR. CHANGE ORDERS SHALL BE SIGNED PRIOR TO BEGINNING THE WORK OR ORDERING THE MATERIALS ADDRESSED IN THE CHANGE ORDER THE CONTRACTOR SHALL SUBMIT ALL DESIGN CHANGES OR SUBSTITUTIONS TO THE ARCHITECT FOR APPROVAL. THE

ARCHITECT SHALL NOT BE RESPONSIBLE FOR ANY CHANGES IN THE CONTRACT DOCUMENTS, CONSTRUCTION COST OR TIME, UNLESS APPROVED IN WRITING AND IN ADVANCE BY THE ARCHITECT. THE CONTRACTOR SHALL NOTIFY THE ARCHITECT OF ALL

MODIFICATIONS REQUESTED BY THE BUILDING DEPARTMENT. OR OFFICIAL HAVING JURISDICTION, AND OF ALL CHANGES REQUESTED BY THE INSPECTOR, OWNER, OR OTHERS. SUBSTITUTIONS WILL BE CONSIDERED, BUT DO NOT SUBSTITUTE DETAILS, EQUIPMENT, OR METHODS WITHOUT SPECIFIC, WRITTEN APPROVAL BY THE

THE CONTRACTOR SHALL VERIFY WITH THE ARCHITECT CODE UPGRADE WORK NOT REQUIRED BY THE OFFICIAL HAVING JURISDICTION. IF THE CONTRACTOR BELIEVES CODE WORK IS NECESSARY, AND IT HAS NOT BEEN REQUIRED BY THE OFFICIAL HAVING JURISDICTION, THE ARCHITECT SHALL DETERMINE WHETHER WORK SHALL BE UNDERTAKEN.

REMODELING, REPAIR OR REHABILITATION OF AN EXISTING BUILDING REQUIRES THAT CERTAIN ASSUMPTIONS BE MADE REGARDING EXISTING CONDITIONS. BECAUSE SOME OF THE ASSUMPTIONS MAY NOT BE VERIFIABLE WITHOUT DESTROYING ADEQUATE OR SERVICEABLE PORTIONS OF THE BUILDING, THE CONTRACTOR SHALL VERIFY ALL QUESTIONS, CONDITIONS, AND PROCEDURES WITH THE ARCHITECT PRIOR TO COMMENCING EACH

THE CONTRACTOR SHALL CONFIRM ALL EXISTING DIMENSIONS AND CONDITIONS IN THE FIFLD PRIOR TO BEGINNING WORK. ANY DISCREPANCIES BETWEEN THE DRAWINGS AND FIELD CONDITIONS MUST BE BROUGHT TO THE IMMEDIATE ATTENTION OF THE ARCHITECT FOR CLARIFICATION PRIOR TO PROCEEDING WITH THE WORK. THE CONTRACTOR SHALL RESOLVE ANY DISCREPANCY PRIOR TO PROCEEDING WITH THE WORK.

WRITTEN DIMENSIONS SHALL TAKE PRECEDENCE OVER SCALED DIMENSIONS. DO NOT SCALE DRAWINGS. [DIMENSIONS ARE TO THE FACE OF FRAME, UNLESS OTHERWISE NOTED.]

THE REMOVAL OR ALTERING IN ANY WAY OF EXISTING WORK SHALL BE CARRIED ON IN SUCH A MANNER AS TO PREVENT INJURY OR DAMAGE TO ANY PORTION (S) OF THE EXISTING WORK TO REMAIN. WHERE CONSTRUCTION ABUTS ADJACENT PROPERTY OR AN EXISTING STRUCTURE, THE CONTRACTOR SHALL VERIFY, PRIOR TO THE START OF THE WORK, IF ANY CONDITIONS WILL AFFECT WORK

THE CONTRACTOR SHALL BE RESPONSIBLE FOR ANY DAMAGE INCURRED AS A RESULT OF THE WORK. ANY DAMAGE SHALL BE REPAIRED AT NO ADDITIONAL COST TO OWNER.

27 WHERE EXISTING CONSTRUCTION IS CUT. DAMAGED. OR REMODELED, PATCH OR REPLACE WITH MATERIALS TO MATCH IN KIND, QUALITY, AND PERFORMANCE WITH ADJACENT MATERIALS. DO NOT NOTCH, BORE, OR CUT STRUCTURAL MEMBERS FOR PIPES, DUCTS, OR OTHER REASONS WITHOUT THE SPECIFIC, ADVANCE

WRITTEN APPROVAL OF THE STRUCTURAL ENGINEER. THE CONTRACTOR IS RESPONSIBLE FOR CAPPING OFF ANY UTILITY LINES DISTURBED DURING THE DEMOLITION AND CONSTRUCTION PROCESS THAT COULD BE A SAFETY HAZARD OR CAUSE DAMAGE TO THE BUILDING.

THE CONTRACTOR IS RESPONSIBLE FOR PROVIDING ALL TEMPORARY SUPPORTS, BRACING, AND SHORING OF EXISTING STRUCTURAL MEMBERS AS REQUIRED DURING THE CONSTRUCTION PROCESS. CONTRACTOR IS RESPONSIBLE FOR ALL TEMPORARY

UNLESS OTHERWISE INDICATED, ALL NEW WORK SHALL MATCH EXISTING MATERIALS, DETAILS, TRIM, ETC. TO THE FULLEST EXTENT POSSIBLE. PROVIDE PRODUCTS OF THE SAME KIND AND FROM A

PRIOR TO ORDERING OR FABRICATING MATERIAL, EQUIPMENT, OR PRODUCTS, THE CONTRACTOR SHALL DETERMINE THAT THE SIZE AND PRODUCTS INDICATED WILL PROPERLY ACCOMPLISH THE INTENT OF THE CONTRACT DOCUMENTS. THE CONTRACTOR SHALL INSPECT MATERIALS AND EQUIPMENT

IMMEDIATELY UPON DELIVERY AND AGAIN PRIOR TO INSTALLATION. CONTRACTOR SHALL REJECT DAMAGED AND DEFECTIVE ITEMS. THE CONTRACTOR SHALL INSTALL ALL EQUIPMENT, FIXTURES, AND MATERIALS PER MANUFACTURER'S RECOMMENDATIONS.

FOLLOW THE MANUFACTURER'S INSTRUCTIONS CAREFULLY. THE MANUFACTURER'S INSTRUCTIONS AND GUARANTEES SHALL BE GIVEN TO THE OWNER AT THE END OF THE JOB.

THE CONTRACTOR SHALL FLASH AND COUNTERFLASH TO S.M.A.C.N.A. STANDARDS, INDUSTRY STANDARDS, AND MANUFACTURER'S SPECIFICATIONS WHEREVER NECESSARY TO PROVIDE A WATERPROOF AND WEATHERPROOF CONSTRUCTION

ALL MECHANICAL, PLUMBING, AND ELECTRICAL SYSTEMS SHALL BE DELIVERED BY THE CONTRACTOR AS A DESIGN/BUILD PACKAGE. THE CONTRACTOR SHALL COORDINATE THE DESIGN AND CONSTRUCTION OF THESE SYSTEMS. THE CONTRACTOR SHALL SUBMIT DESIGN-BUILD DRAWINGS AND PERFORMANCE SPECIFICATIONS TO THE ARCHITECT AS SHOP DRAWINGS FOR REVIEW AND APPROVAL PRIOR TO SUBMITTING THE DRAWINGS TO

PROVIDE AND INSTALL NEW FIBERGLASS BATT INSULATION (OR OTHER INSULATION AS REQUIRED) AT NEW CONSTRUCTION AND AT EXISTING CONSTRUCTION WHERE OPENED UP DURING THE COURSE OF CONSTRUCTION AS FOLLOWS:

R-13: AT EXTERIOR WALLS OR WALLS ADJACENT TO UNCONDITIONED SPACES.

R-19 AT FLOOR ASSEMBLIES ABOVE CRAWL SPACES

R-30 AT ROOFS AND ROOF DECKS.

WHERE EXISTING CONSTRUCTION DOES NOT PROVIDE SUFFICIENT DEPTH, INSTALL THE THICKEST STANDARD BATT INSULATION THAT WILL FIT WITHIN THE AVAILABLE SPACE, UNLESS OTHERWISE NOTED IN THE DRAWINGS.

PROVIDE AND INSTALL TEMPERED GLAZING WHERE REQUIRED BY CODE. INSTALL TEMPERED GLAZING IN THE FOLLOWING HAZARDOUS LOCATIONS:

1. GLAZING IN SWINGING DOORS (EXCEPT JALOUSIES). 3. GLAZING IN STORM DOORS.

4. EXPOSED AREA OF AN INDIVIDUAL PANE GREATER THAN 9 SF. 5. GLAZING PANELS LESS THAN 18" ABOVE THE FLOOR. 6. GLAZING IN SHOWER DOORS

7. GLAZING IN AN INDIVIDUAL FIXED OR OPERABLE PANEL ADJACENT TO A DOOR WHERE THE NEAREST EXPOSED EDGE OF THE GLAZING IS WITHIN A 24 INCH ARC OF EITHER VERTICAL EDGE OF THE DOOR IN A CLOSED POSITION AND WHERE THE BOTTOM EXPOSED EDGE OF THE GLAZING IS LESS THAN 60 INCHES ABOVE THE WALKING

THE CONTRACTOR SHALL BE SOLELY AND COMPLETELY REPONSIBLE FOR CONDITIONS AT THE JOB SITE AT ALL TIMES, INCLUDING SAFETY OF PERSONS AND PROPERTY. THE CONTRACTOR SHALL BE SOLELY RESPONSIBLE FOR COORDINATION

THE CONTRACTOR SHALL KEEP THE JOB SITE CLEAN AND SAFE AT ALL TIMES. CLEAN MATERIALS, PROTECT CONSTRUCTION IN PROGRESS AND ADJOINING MATERIALS IN PLACE. PROVIDE TEMPORARY, PROTECTIVE COVERINGS WHERE NECESSARY TO ENSURE PROTECTION FROM DAMAGE OR DETERIORATION.

42 THE CONTRACTOR SHALL PERIODICALLY CLEAN AND MAINTAIN COMPLETED CONSTRUCTION ON A REGULAR BASIS. AT THE COMPLETION OF THE PROJECT, PROVIDE A FINAL CLEANING OF ALL SURFACES: POLISH ALL GLASS, BROOM SWEEP EXTERIOR SURFACES, AND VACUUM ALL INTERIOR FLOORS. CONTRACTOR SHALL LEAVE THE PREMISES CLEAN, ORDERLY, AND READY FOR

THE CONTRACTOR SHALL DISPOSE OF ALL DEBRIS AND WASTE OFF SITE IN A LEGAL MANNER AND ON A REGULAR BASIS TO PREVENT EXCESS ACCUMULATION ON SITE.

STUDIO 4 ARCHITECTURE (S4A) AND S4A'S CONSULTANTS SHALL HAVE NO RESPONSIBILITY FOR THE DISCOVERY, PRESENCE HANDLING, REMOVAL OR DISPOSAL OF, OR EXPOSURE OF PERSONS TO HAZARDOUS MATERIALS IN ANY FORM AT THE PROJECT SITE, INCLUDING BUT NOT LIMITED TO MOLD, ASBESTOS PRODUCTS, POLYCHLORINATED BIPHENYL (PCB), LEAD OR OTHER TOXIC

THE CONTRACTOR SHALL INSTALL ALL ELECTRICAL OUTLETS SWITCHES AND LIGHTING FIXTURES AS REQUESTED BY OWNER AND REQUIRED BY CODE.

STUDIO 4 ARCHITECTURE (S4A) AND S4A'S CONSULTANTS SHALL HAVE NO RESPONSIBILITY FOR THE DISCOVERY, PRESENCE, HANDLING, REMOVAL OR DISPOSAL OF, OR EXPOSURE OF PERSONS TO HAZARDOUS MATERIALS IN ANY FORM AT THE PROJECT SITE INCLUDING BUT NOT LIMITED TO MOLD, ASBESTOS PRODUCTS, POLYCHLORINATED BIPHENYL (PCB) OR OTHER TOXIC

# APPLICABLE CODES

ALL WORK SHALL COMPLY WITH THE FOLLOWING BUILDING CODES AND

2013 CALIFORNIA BUILDING CODE (CBC) 2013 CALIFORNIA ELECTRICAL CODE (CEC) 2013 CALIFORNIA MECHANICAL CODE (CMC)

2013 CALIFORNIA PLUMBING CODE (CPC) 2013 CALIFORNIA ENERGY CODE (CEC) 2013 CALIFORNIA FIRE CODE (CFC)

2013 CALIFORNIA GREEN BUILDING STANDARDS (CGBSC)

CITY OF SAN FRANCISCO MUNICIPAL CODE

**ABBREVIATIONS** 

# **NOTES**

ABBREVIATION TERM:

A.C.

A.C.T.

ADJ.

A.P.

APPL.

ARCH.

BLDG.

B.N.

C.G.

CLG.

CLO.

CLR.

C.M.U.

COL.

CONC.

CONT.

CTR.

CTSK.

DBL.

DIA.

DIST.

D.F.

DTL.

DWG.

ELEC.

**EMRGY** 

ENG.

E.P.

EXC.

F.B.O.

F.D.

FDN.

F.F.

CONST.

ACOUS.

ANGLE

ABOVE

TILE

ACOUSTIC

**ADJACENT** 

ALUMINUM

**ALTERNATE** 

APPLIANCE

**ARCHITECT** 

BOARD

BUILDING

BLOCKING

BOTTOM

BEAM

ACCESS PANEL

APPROXIMATELY

**BOUNDARY NAILING** 

CONCRETE MASONRY

**CORNER GUARD** 

CONTROL JOINT

**CENTER LINE** 

CEILING

CLOSET

CLEAR

COUNTER

COLUMN

CARPET

CENTER

DOUBLE

DIAMETER

DIMENSION

DISPENSER

DOUGLAS FIR

DOWNSPOUT

DISTANCE

DOWN

DETAIL

DRAWING

**EXISTING** 

ELECTRICAL

**ELEVATION** 

**EMERGENCY** 

**ENGINEERED** 

FI FCTRICAL

PANELBOAR

**EQUIPMENT** 

**EXTERIOR** 

FLOOR DRAIN

FOUNDATION

FINISH FLOOR

**FURNISHED BYOTHERS** 

FXCFPT

CONCRETE

CONSTRUCTION

CONTINUOUS

COUNTERSINK

DRINKING FOUNTAIN

**ANCHOR BOLTS** 

AIR CONDITIONING

ADJUSTABLE OR

ABOVE FINISHED

**ACOUSTICAL CEILING** 

ΑT

CONTRACTOR TO SUBMIT SIZING CALCULATION TO THE CITY INSPECTOR FOR WATER LINE TO VERIFY THAT EXISTING WATER LINE IS ADEQUATE

CONTRACTOR TO SUBMIT SIZING CALCULATION TO THE CITY INSPECTOR FOR SEWER LINE TO VERIFY THAT THE EXISTING SANITARY

FLR.

F.O.

F.O.F.

F.O.S.

F.R.P.

FT.

G.F.R.C

H.B.

HDWD.

HORIZ.

INSUL

MECH

NOM.

O.S.C.I.

F.S.E.C.

**FLOUR** 

**FINISH** 

FLOOR

FACE OF

**FLUORESCENT** 

**FACE OF FINISH** 

FACE OF STUD

FOOD SERVICE

CONTRACTOR

FOOT OR FEET

GALVANIZED

**GLASS FIBER** 

CONTRACTOR

GALVANIZED

SHEET METAL

HOSE BIBB

HARDWOOD

**HARDWARE** 

HORIZONTAL

INSULATION

INTERIOR

**JANITOR** 

KITCHEN

**LAVATORY** 

MAXIMUM

MINIMUM

MOUNTED

**MATERIAL** 

NUMBER

NOMINAL

MECHANICAL

MANUFACTURER

**MISCELLANEOUS** 

NOT IN CONTRACT

OVERFLOW DRAIN

OWNER SUPPLIED,

PERIMETER EDGE

PERPENDICULAR

PROPERTY LINE

PLASTIC LAMINATE

POUNDS PER SQUARE

POUNDS PER SQUARE

PROVIDED BY OWNER

CONTRACTOR

NOT TO SCALE

ON CENTER

OVERHEAD

INSTALLED

PLATE

PLYWD. PLYWOOD

PLASTER

HOUR, HOURS

KITCHEN EQUIPMENT

CONTRACTOR

HEIGHT

**GRAB BAR** 

GLASS

GROUND

REINFORCED CONCRETE

GYPSUM WALL BOARD

EQUIPMENT

FOOTING

GAUGE

REINFORCED PANEL

# 4229 20TH ST.

# REMODEL AND ALTERATION

# 4229 20TH ST. SAN FRANCISCO, CA 94114

RH-3

40-X

15'-0"

5'-0"

49'-6"

PRIVATE GARAGE

3 STORIES AT STREET

1.5 STORIES AT REAR YARD

40'-0" +/- (TO TOP OF PARAPET

2,760 SQ. FT. (.063 ACRE)

STUDIO 4 ARCHITECTURE 1840 B ALCATRAZ AVENUE BERKELEY, CA 94703

TEL: (510) 644-3407 FAX: (510) 405-2006 CONTACT: GEORGE SCHEVON, AIA EMAIL: george@studio4architecture.com

OSCAR ROJAS 445 FRANCISCO STREET #401 SAN FRANCISCO, CA 94133

TEL: (650) 544 - 5495 EMAIL: ogrojas@gmail.com **STRUCTURAL ENGINEER:** MOSSWOOD ENGINEERING

PROJECT DESCRIPTION:

3360 ADELINE STREET BERKELEY, CA 94703 TEL: (415) 839-1022 CONTACT: NATE WILLIAMS EMAIL: jobs@energycalcco.com

**ENERGY CONSULTANT:** ENERGY CALC, CO.

45 MITCHELL BLVD. STE. 16 SAN RAFAEL, CA 94903 TEL: (415) 457-0990

EMAIL: info@mosswoodengineering.com

# PROJECT DATA

TYPICAL BUILDING ANALYSIS:

GARAGE LEVEL: LOWER LEVEL: MAIN LEVEL: **UPPER LEVEL** 

TOTAL:

PRESSURE TREATED

PAINTED

R.D.

RM.

R.O.

R.S.

RWD.

R.W.L.

SH.

SHT.

STD.

STL.

S.S.

S.S.D.

SUSP.

T.B.D.

TEMP.

T.O.C.

T.O.W.

U.N.O.

WT.

W.H.

W.R.

T&G

S.W.

PARTITION

**ROOF DRAIN** 

REGISTER

REQUIRED

REDWOOD

SECTION

SHELF

SHOWER

SQUARE

STEEL

STANDARD

DRAWINGS

STORAGE

STRUCTURE

SUSPENDED

SHEAR WALL

TOWEL BAR

TEMPERED

TOP OF CURB

TO BE DETERMINED

TONGUE AND GROOVE

TREAD

THICK

T.O.B. TOP OF BEAM

T.O.P. TOP OF PLATE

TOE NAIL

T.O.CONC. TOP OF CONCRETE

T.O.PV. TOP OF PAVEMENT

TYPICAL

TOP OF WALL

OTHERWISE

VERTICAL

WEIGHT

WOOD

WINDOW

WITHOUT

WAINSCOT

WITH

VERIFY IN FIELD

WATER CLOSET

WATER HEATER

WATER PROOF

WATER RESISTANT

SHEATHING

**SPECIFICATION** 

STAINLESS STEEL

SEE STRUCTURAL

SQUARE FEET

REFRIGERATOR

ROUGH OPENING

RAIN WATER LEADER

ROUGH SAWN

285 SF (UNCONDITIONED) 733 SF (483 SF CONDITIONED SPACE) 1,115 SF (CONDITIONED) 1,115 SF (CONDITIONED) 3,248 SF

LOWER LEVEL: MAIN LEVEL: **UPPER LEVEL:** 

285 SF (UNCONDITIONED) 733 SF (483 SF CONDITIONED SPACE) 1,115 SF (CONDITIONED) 1,115 SF (CONDITIONED) 3,248 SF (NO CHANGE)

**EXISTING UNIT ANALYSIS:** 

4225 20TH STREET: 4227A 20TH STREET: 4227B 20TH STREET: 428 SF 4229 20TH STREET: 1,115 SF

PROPOSED UNIT ANALYSIS

483 SF (NO CHANGE) 4225 20TH STREET: 508 SF (NO CHANGE) **4227B 20TH STREET:** 428 SF (NO CHANGE) 4229 20TH STREET: 1,115 SF (NO CHANGE)

**DISABLED ACCESS REQUIREMENTS:** PER CBC 1102A.2, DISABLED ACCESS REQUIREMENTS

DO NOT APPLY TO THE ALTERATION, REPAIR. REHABILITATION OR MAINTENANCE OF MULTIFAMILY DWELLINGS CONSTRUCTED FOR FIRST OCCUPANCY PRIOR TO MARCH 13, 1991.

PROPERTY ADDRESS:

4225-4229 20TH STREET SAN FRANCISCO, CA 94114 PARCEL INFORMATION: APN PARCEL NO:

OCCUPANCY TYPE: R2 - COVERED MULTI-FAMILY TYPE VB NON-RATED TYPE OF CONSTRUCTION:

SPRINKLERED?: NO. OF UNITS: NO. OF STORIES:

ZONING:

BUILDING HEIGHT: HEIGHT DISTRICT:

**EXISTING LOT SIZE** YEAR BUILT:

SETBACKS:

FRONT: SIDF: REAR:

EXISTING 3 STORY, 4-UNIT MULTIFAMILY RESIDENTIAL STRUCTURE TO INCLUDE THE FOLLOWING SCOPE OF WORK:

1. THE REMOVAL OF EXISTING SHED ROOF IN LIEU OF NEW GABLE ROOF STRUCTURE AS EXTENSION OF EXISTING GABLE ROOF.

RETROFIT WINDOWS. 3. REMOVAL OF EXISTING WINDOWS AT SELECTED LOCATIONS.

# THIS PROJECT INVOLVES THE RENOVATION TO ONE UNIT IN AN

4229 20TH STREET (TOP FLOOR UNIT): EXISTING 3 BEDROOM, 1 BATHROOM UNIT

2. REPLACEMENT OF EXISTING SINGLE PANE WINDOWS WITH NEW

4. NEW EXTERIOR WINDOWS AT SELECTED LOCATIONS.

ARCHITECTURE

GEORGE M.

SCHEVON

Lic.# C-28400

Berkeley, CA 94703

tel....5 | 0.644.3407

fax....510.405.2006

STAMP

STATUS

**COVER** 

2016-03-10 GS15139 Project Number TMW Drawn By

Checked By REVISION DATE

A4.1 PROPOSED SECTIONS

1/4" = 1'-0"

**SYMBOLS** 

(E) CONSTRUCTION \_ \_ \_ \_ \_ \_ ---- TO BE REMOVED

(N) CONSTRUCTION

(N) 1-HR FIRE RATED CONSTRUCTION

(E) CONSTRUCTION TO REMAIN

LINE ABOVE

LINE BELOW -----

CENTERLINE

DETAIL NUMBER DIRECTION OF

**ELEVATION/SECTION** SHEET NUMBER

DETAIL NUMBER SHEET NUMBER

DETAIL NUMBER SHEET NUMBER **DIRECTION OF** 

INTERIOR ELEVATION

REVISION

**BREAK LINE** 

H MARK

**KEYNOTE** 

**WINDOW** 

**DOOR** 

**INDICATOR** 

**INDICATOR** 

REVISION

**INDICATOR** 

**INDICATOR** 

**ROOM TAG** 001

**INDICATOR** 

**VICINITY MAP** 



**DRAWING INDEX** 

A1.0 SITE PLAN AND GREEN BUILDING REQUIREMENTS A1.1 EXISTING PLANS W/ SELECTIVE DEMOLITION A1.2 EXISTING PLANS W/ SELECTIVE DEMOLITION 100.0' ELEVATION TAG A1.3 EXISTING ROOF PLAN W/ SELECTIVE DEMOLITION EXISTING ELEVATIONS A1.5 EXISTING ELEVATIONS A1.6 EXISTING ELEVATIONS A1.7 EXISTING ELEVATIONS A2.1 UPPER LEVEL FLOOR PLAN AND ROOF

> A3.1 | PROPOSED ELEVATIONS A3.2 PROPOSED ELEVATIONS

A3.3 PROPOSED ELEVATIONS

A3.4 PROPOSED ELEVATIONS

A5.1 WINDOW AND DOOR SCHEDULE A8.1 CONTEXT IMAGES A8.2 SURROUNDING BUILDINGS

SHEET NUMBER

PROGRESS OR CONFORMANCE TO THESE DOCUMENTS.

ODE SECTION REQUIREMENT		CODE SECTION	REQUIREMENT			
SITE DEVELOPMENT		ENVIRONMENTAL QUALITY (CON'D)				
4.106.2	DEVELOP AND IMPLEMENT A PLAN TO MANAGE STORM WATER DRAINAGE DURING CONSTRUCTION TO PREVENT FLOODING OF ADJACENT PROPERTY, EROSION AND TO RETAIN SOIL RUNOFF ON THE SITE USING ONE OR MORE OF THE FOLLOWING MEASURES:	4505.2	BASE OF 1/2 INCH OR LARGER CLEAN IN DIRECT CONTACT WITH CONCRETE	G: ALLED CONSISTING OF A 4-INCH THICK I AGGREGATE WITH A VAPOR RETARDER E. A CONCRETE MIX DESIGN WHICH WILL		
	<ol> <li>RETENTION BASINS</li> <li>FILTERED BARRIER SYSTEM, WATTLE OR OTHER METHOD OF PROTECTING THE LOCAL RAIN SEWER SYSTEM.</li> <li>COMPLIANCE WITH LAWFULLY ENACTED STORM WATER MANAGEMENT ORDINANCE.</li> </ol>	4505.3	INSTALLED. WALL AND FLOOR FRAMII	SIGNS OF WATER DAMAGE SHALL NOT BE NG SHALL NOT BE ENCLOSED WHEN THE CENT MOISTURE CONTENT. INSULATION		
WATER EFFICIENCY AND CONSERVATION	ON		PRODUCTS WHICH ARE VISIBLY WET	OR HAVE A HIGH MOSTURE CONTENT O DRY PRIOR TO ENCLOSURE IN WALL OR		
4.303.1	PLUMBING FIXTURES (WATER CLOSETS AND URINALS) AND FITTINGS (FAUCETS AND SHOWERHEADS) SHALL COMPLY WITH THE FOLLOWING:  WATER CLOSETS 1.28 GAL. / FLUSH CERTIFIED TO PERFORMANCE CRITERIA OF	4506.1	EACH BATHROOM SHALL BE MECHAN WITH THE FOLLOWING:	NICALLY VENTILATED AND SHALL COMPLY COMPLIANT AND BE DUCTED TO TERMINATE		
	THE U.S. EPA WATERSENSE SPECIFICATION  URINALS: 0.5 GAL. / FLUSH  SHOWERHEADS: MAX. FLOW RATE OF 2.0 GAL. / MIN. AT 80 PSI		OUTSIDE THE BUILDING.  • UNLESS FUNCTIONING AS A COMVENTILATION SYSTEM, FANS MUSAUTOMATIC HUMIDITY CONTROL			
	FAUCETS: MAX. FLOW RATE OF 1.5 GAL. / MIN. AT 60 PSI (LAVATORY) (MIN. FLOW RATE OF 0.8 GAL. / MIN. AT 20 PSI)  FAUCETS: MAX. FLOW RATE OF 1.8 GAL. / MIN. AT 60 PSI	4507.2	PERCENT.  HEATING AND AIR-CONDITIONING SYSTEM OF THEIR EQUIPMENT SELECTED ITS AND THE PROPERTY OF THE PROPERTY	STEMS SHALL BE SIZED, DESIGNED AND USING THE FOLLOWING METHOD:		
	(KITCHEN) (MAY TEMPORARILY INCREASE THE FLOW TO 2.2 GAL./ MIN.)		EQUIPMENT SHALL BE ESTABLIS J - 2004 (RESIDENTIAL LOAD CAL DUCT SYSTEMS), MANUAL S-2004	, DUCT SYSTEMS, HEATING AND COOLING SHED ACCORDING TO ANSI/ACCA 2 MANUAL .CULATION), MANUAL D-2009 (RESIDENTIAL 4 (RESIDENTIAL EQUIPMENT SELECTION), R EQUIVALENT DESIGN SOFTWARE OR		
4.304.1  MATERIAL CONSERVATION AND RESOU	AUTOMATIC IRRIGATION SYSTEMS CONTROLLERS INSTALLED AT THE TIME OF FINAL INSPECTION SHALL BE WEATHER OR SOIL MOISTURE BASED.  JRCE EFFICIENCY		METHODS.  2. DUCT SYSTEMS ARE SIZED ACCO (RESIDENTIAL DUCT SYSTEMS), A EQUIVALENT DESIGN SOFTWARE	ORDING TO ANSI/ACCA 1 MANUAL D-2009 ASHRAE HANDBOOKS OR OTHER		
4.406.1	ANNULAR SPACES AROUND PIPES, ELECTRIC CABLES, CONDUITS OR OTHER OPENINGS IN SOLE/BOTTOM PLATES AT EXTERIOR WALLS SHALL BE PROTECTED AGAINST THE PASSAGE OF RODENTS BY CLOSING SUCH		MANUAL S-2004 (RESIDENTAIL EC EQUIVALENT DESIGN SOFTWARE EXCEPTION: USE OF ALTERNATE DES	QUIPMENT SELECTION) OR OTHER E OR METHODS. SIGN TEMEPERATURES NECESSARY TO		
4.408.1	OPENINGS WITH CEMENT MORTAR, CONCRETE MASONRY OR A SIMILAR METHOD.  RECYCLE AND/OR SALVAGE FOR RESUE A MINIMUM OF 50 PERCENT OF THE NONHAZARDOUS CONSTRUCTION AND DEMOLITION WASTE GENERATED AT	4.504.5	COMPOSITE WOOD PRODUCTS USED BUILDING SHALL MEET THE REQUIRE	DARD AND MEDIUM DENSITY FIBERBOARD O ON THE INTERIOR OR EXTERIOR OF THE		
	THE SITE.		(17 CCR 93120 ET. SEQ.), BY OR BEFO SECTIONS, AS SHOWN IN TABLE 4.504	ORE THE DATES SPECIFIED IN THOSE		
4.408.2	DEVELOP A CONSTRUCTION WASTE MANAGEMENT PLAN TO INCLUDE:  1. IDENTIFY THE CONSTRUCITON AND DEMOLITION WASTE MATERIALS TO BE DIVERTED FROM DISPOSAL BY RECYCLING, REUSE ON THE PROJECT OR SALVAGE FOR FUTURE USE OR SALE.  2. SPECIFY IF CONSTRUCTION AND DEMOLITION WASTE MATERIALS WILL BE SORTED ON-SITE OR BULK MIXED.  3. IDENTIFY DIVERSION FACILITES WHERE THE CONSTRUCTION AND DEMOLITION WASTE MATERIAL WILL BE TAKEN.	<u> </u>	ADJACENT PROPERTY 700 CASTRO ST. LOT 35 - 4-STORIES			
	<ol> <li>IDENTIFY CONSTRUCTION METHODS EMPLOYED TO REDUCE THE AMOUNT OF CONSTRUCTION AND DEMOLITION WASTE GENERATED.</li> <li>SPECIFY THAT THE AMOUNT OF CONSTRUCTION AND DEMOLITION WASTE MATERIALS DIVERTED SHALL BE CALCULATED BY WEIGHT OR VOLUME, BUT NOT BY BOTH.</li> </ol>			ADJACENT PROPERTY 704 CASTRO ST. LOT 2 - 3-STORIES	ADJACENT PROPERTY 706 CASTRO ST. LOT 3 - 3-STORIES	ADJACENT PROPERTY 708 CASTRO ST. LOT 4 - 3-STORIES
4.408.3	UTILIZE A WASTE MANAGEMENT COMPANY, APPROVED BY THE ENFORCING AGENCY, WHICH CAN PROVIDE VERIFIABLE DOCUMENTATION THAT THE PERCENTAGE OF CONSTRUCTION AND DEMOLITION WASTE MATERIAL DIVERTED FROM THE LANDFILL COMPLIES WITH REQUIREMENTS LISTED IN CBC SEC. 4.408.1. THE OWNER OR CONTRACTOR MAY MAKE THE DETERMINATION IF THE CONSTRUCTION AND DEMOLITION WASTE MATERIALS WILL BE DIVERTED BY A WASTE MANAGEMENT COMPANY.	.10 3/4"	ADJACENT P 4221 20T		13' - 8"	25' - 0"
ENVIRONMENTAL QUALITY		36' - 0' 36'	LOT : 3-STOF	34		3/4"
4.504.1	AT THE TIME OF ROUGH INSTALLATION, DURING STORAGE ON THE CONSTRUCTION SITE AND UNTIL FINAL STARTUP OF THE HEATING, COOLING AND VENTILATING EQUIPMENT, ALL DUCT AND OTHER RELATED AIR DISTRIBUTION COMPONENT OPENINGS SHALL BE COVERED WITH TAPE, PLASTIC, SHEETMETAL OR OTHER METHODS ACCEPTABLE TO THE ENFORCING AGENCY TO REDUCE THE AMOUNT OF WATER, DUST AND DEBRIS, WHICH MAY ENTER THE SYSTEM.		HT. 35'-	0" +/- (E) LIGHT WELL <sub>79' - 3"</sub>	SETBACKS	34' - 2" 27' - 6"
4.504.2.1	ADHESIVES, SEALANTS AND CAULKS USED ON THE PROJECT SHALL MEET THE REQUIREMENTS OF THE FOLLOWING STANDARDS UNLESS MORE STRINGENT LOCAL OR REGIONAL AIR POLLUTION OR AIR QUALITY MANAGEMENT DISTRICT RULES APPLY.  1. ADHESIVES, ADHESIVE BONDING PRIMERS, ADHESIVE PRIMERS, SEALANTS, SEALANT PRIMERS, AND CAULKS SHALL COMPLY SCAQMD RULE 1168 VOC LIMITS AS SHOWN IN TABLE 4504.1 OR 4504.2, AS APPLICABLE. SUCH PRODUCTS ALSO SHALL COMPLY WITH RULE 1168 PROHIBITION ON THE USE OF CERTAIN TOXIC COMPOUNDS (CHLOROFORM, ETHYLENE DICHLORIDE, METHYLENE CHLORIDE, PERCHLOROETHYLENE AND TRICHLOROETHYLENE), EXCEPT FOR AEROSOL PRODUCTS, AS	(E) SIDEWALK  PROPERTY LINE  PROPERTY LINE	MÙIMÙI	E) 4-UNIT LTI-FAMILY	PROPOSED AREA OF WORK	(E) PROPERTY LINE  5"  DN  (E) REAR  YARD  28' - 0"
	SPECIFIED BELOW.  2. AEROSOL ADHESIVES, AND SMALLER UNIT SIZES OF ADHESIVES, AND SEALANT OR CAULKING COMPOUNDS SHALL COMPLY WITH STATEWIDE VOC STANDARDS AND OTHER REQUIREMENTS, INCLUDING PROHIBITIONS ON USE OF CERTAIN TOXIC COMPOUNDS, OF CALIFORNIA CODE OF REGULATIONS, TITLE 17, COMMENCING WITH SECTION 94507.	(E) UTILITU (3)		RUCTURE -4229 20TH STREET LOT 31	DE	9' - 2" DN (E) WD. DECK
4.504.2.2	ARCHITECTURAL PAINTS AND COATINGS SHALL COMPLY WITH VOC LIMITS IN TABLE 1 OF THE ARB ARCHITECTURAL SUGGESTED CONTROL MEASURE, AS SHOWN IN TABLE 4.504.3, UNLESS MORE STRINGENT LOCAL LIMITS APPLY.	PÓLE		(E) PROF	PERTY LINE	(E) WD. STAIR TO REMA
4.504.2.3	AEROSOL PAINTS AND COATINGS SHALL MEET THE PRODUCT -WEIGHTED MIR LIMITS FOR ROC IN SECTION 94522(a) (3) AND OTHER REQUIREMENTS, INCLUDING PROHIBITIONS ON USE OF CERTAIN TOXIC COMPOUNDS AND OZONE DEPLETING SUBSTANCES, IN SECTIONS 94522 (c) (2) AND (d) (2) OF CALIFORNIA CODE OF REGULATIONS, TITLE 17, COMMENCING WITH SECTION 94520; AND IN AREAS UNDER THE JURISDICTION OF THE BAY AREA AIR QUALITY MANAGEMENT DISTRICT ADDITIONALLY COMPLY WITH THE PERCENT VOC BY WEIGHT OF PRODUCT LIMITS OF REGULATION 8, RULE 49.	12' - 9" 10 - 152		ACENT PROPERTY 4231 20TH ST. LOT 30 110' - 0" 3 STORIES HT. 40'-0" +/-		
4.504.3	ALL CARPET SYSTEMS INSTALLED IN THE BUILDING INTERIOR SHALL MEET THE TESTING AND PRODUCT REQUIREMENTS OF THE CARPET AND RUG INSTITUTE'S GREEN LABEL PLUS PROGRAM. CARPET ADHESIVE SHALL MEET THE REQUIREMENTS OF TABLE 4.504.1.					
4.504.4	WHERE RESILIENT FLOORING IS INSTALLED, AT LEAST 80 PERCENT OF FLOOR AREA RECEIVING RESILIENT FLOORING SHALL COMPLY WITH CERTIFICATION UNDER THE RESILIENT FLOOR COVERING INSTITUTE (RFCI) FLOORSCORE PROGRAM.	SITE PLAN		<u> </u>	<u>/////////////////////////////////////</u>	

# SHEET NOTES

1. REQUIRED REAR YARD SETBACK CALCULATION

REQUIRED REAR YARD SETBACK (RYS) PER RH-3 (SETBACK A)

45% OF LOT DEPTH 110'-0" x .45 = <u>49'-6"</u>

49'-6"

21'-10"

REQUIRED RYS:

AVERAGE RYS OF 2 ADJ. PERMITTED RYS PER SAN FRANCISCO RESIDENTIAL FACADES: LOT 30 & LOT 34 = <u>34'-2"</u> DESIGN GUIDLINES (SETBACK B):

PERMITTED RYS PER SFRDG:

MINIMUM REQUIRED RYS PER SAN FRANCISCO MUNICIPAL CODE (SFMC) FOR RESIDENTIAL LOTS (SETBACK C):

25% OF LOT DEPTH 110'-0" x .25 = <u>27'-6"</u> < 34'-2" < 49'-6"

MINIMUM REQUIRED RYS: 27'-6" EXISTING RYS: 28'-0"

PROPOSED RYS: 28'-0" (NO CHANGE)

1. REQUIRED FRONT YARD SETBACK CALCULATION

REQUIRED FRONT YARD SETBACK (RYS) PER RH-3

MAX. 15'-0" OR 15% OF AVERAGE LOT DEPTH 110'-0" x .15 = 16'-6"

STUDIO 4
ARCHITECTURE 1840 B Alcatraz Avenue Berkeley, CA 94703 tel.....510.644.3407 fax....510.405.2006

STAMP GEORGE M. SCHEVON Lic.# C-28400 Ren. 8/31/17

STATUS

4229 20 ST. I FRANCISCO, C

SITE PLAN AND GREEN BUILDING REQUIREMENTS

2016-03-10 GS15139 Project Number TMW Drawn By Checked By GMS DATE REVISION

SHEET NUMBER

A1.0

1/8" = 1'-0"

(E) NORTH (STREET) EXTERIOR ELEVATION

1/4" = 1'-0"



STUDIO 4
A R C H I T E C T U R E

1840 B Alcatraz Avenue
Berkeley, CA 94703

tel.....510.644.3407
fax....510.405.2006

STAMP

GEORGE M.
SCHEVON

Lic.# C-28400
Ren. 8/31/17

ROF CALIFO

STATUS

ESIDENCE

TOUCOCCA

EXISTING ELEVATIONS

Date		2016-03-10	
Project Num	ber	GS15139	
Drawn By		TMV	
Checked By		GMS	
REVISION	DATE	BY	

SHEET NUMBER

A1.4

1/4" = 1'-0"

(E) SOUTH EXTERIOR ELEVATION 1/4" = 1'-0"



ROJAS RESIDENCE

STUDIO 4
ARCHITECTURE

GEORGE M. SCHEVON

1840 B Alcatraz Avenue Berkeley, CA 94703

tel....510.644.3407 fax....510.405.2006

STAMP

STATUS

EXISTING ELEVATIONS


Date 2016-03-10
Project Number GS15139
Drawn By TMW
Checked By GMS
REVISION DATE BY

SHEET NUMBER

A1.5

1/4" = 1'-0"

ale

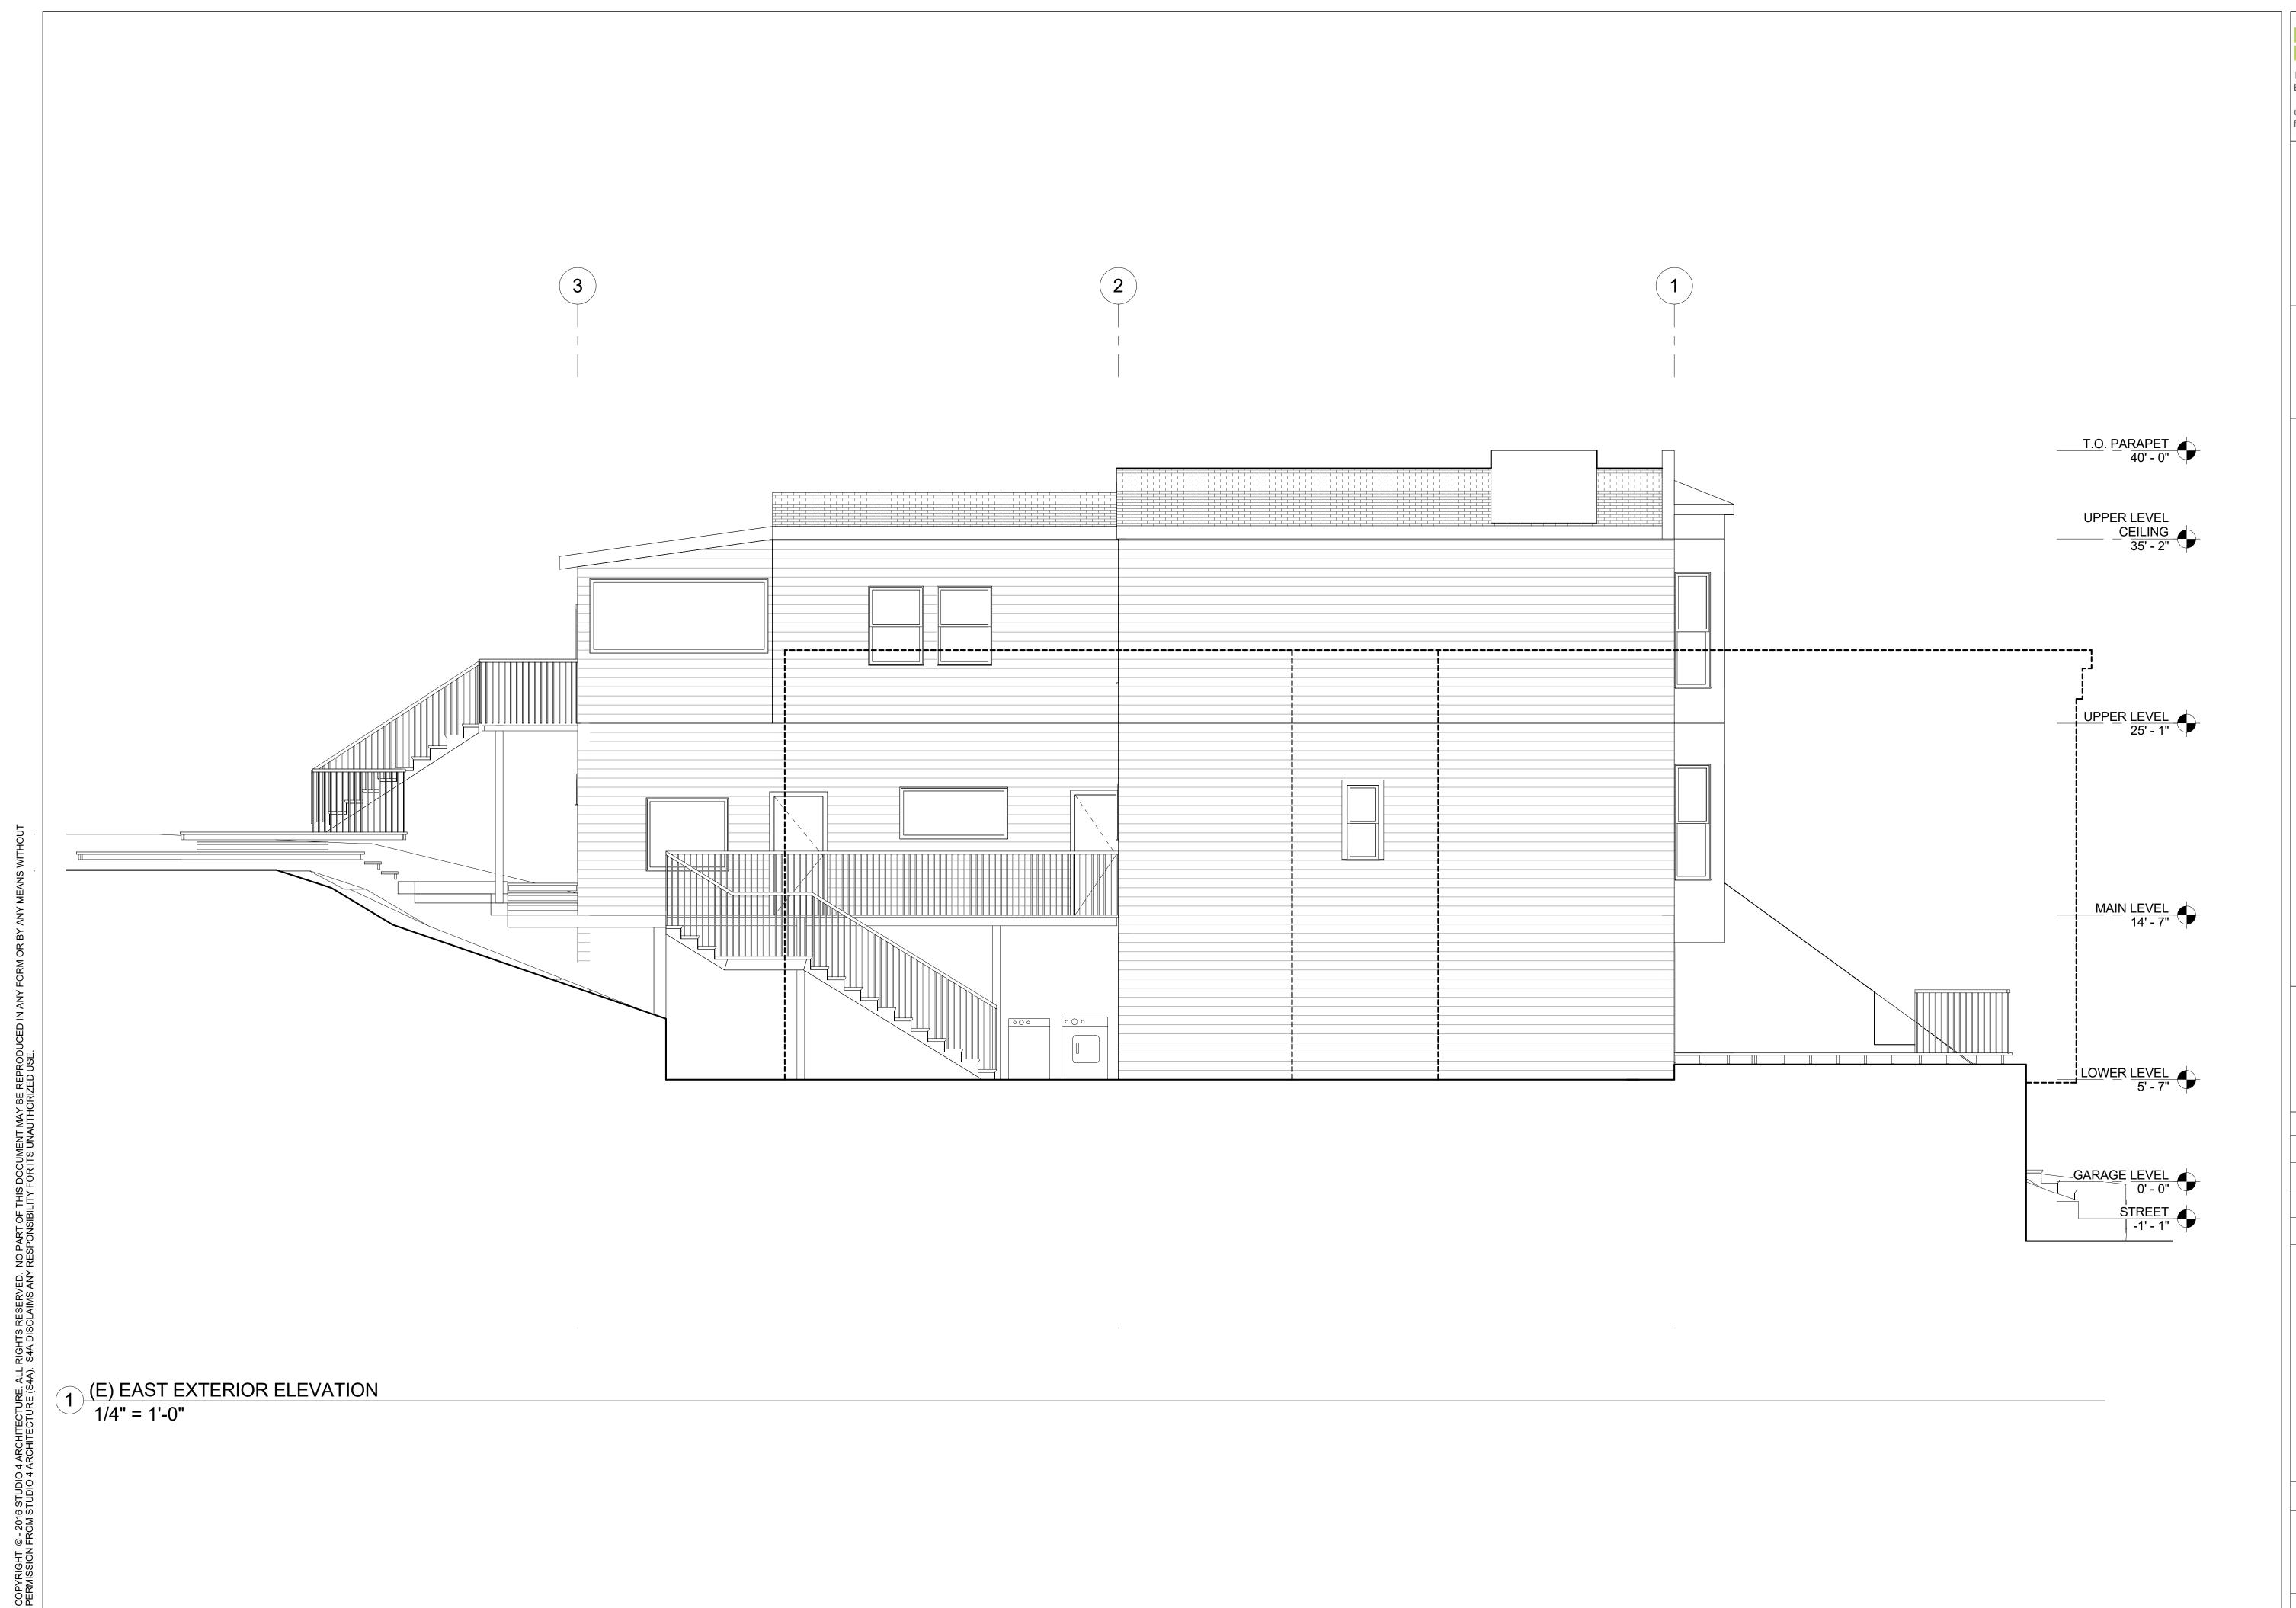

STATUS

STUDIO 4

A R C HITECTURE

1840 B Alcatraz Avenue
Berkeley, CA 94703

tel.....510.644.3407
fax....510.405.2006

STAMP

STATUS

STATUS

Type of California and Calif

EXISTING ELEVATIONS

Date 2016-03-10
Project Number GS15139
Drawn By TMW
Checked By GMS
REVISION DATE BY

SHEET NUMBER

A1.6

1/4" = 1'-0"

STUDIO 4
A R C H I T E C T U R E

1840 B Alcatraz Avenue
Berkeley, CA 94703

tel.....510.644.3407
fax....510.405.2006

STAMP

GEORGE M.
SCHEVON

Lic.# C-28400
Ren. 8/31/17

Ren. 8/31/17

STATUS

\_\_\_\_

EXISTING ELEVATIONS

Project Number GS151  Drawn By TM				
Drawn By TM Checked By GM	Date		2016-03-10	
Checked By GN	Project Num	nber	GS1513	
			TMV GM:	
REVISION DATE BY				
	REVISION	DATE	BY	

SHEET NUMBER

A1.7

1/4" = 1'-0"

COPYRIGHT © - 2016 STUDIO 4 ARCHITECTURE. ALL RIGHTS RESERVED. NO PART OF THIS DOCUMENT MAY BE REPRODUCED IN A PERMISSION FROM STUDIO 4 ARCHITECTURE (S4A). S4A DISCLAIMS ANY RESPONSIBILITY FOR ITS UNAUTHORIZED USE.

STUDIO 4
ARCHITECTURE 1840 B Alcatraz Avenue Berkeley, CA 94703 tel....510.644.3407 fax....510.405.2006

STAMP SCHEVON

STATUS

RESIDENCE

PROPOSED ELEVATIONS

2016-03-10 GS15139 Project Number TMW Drawn By Checked By GMS REVISION DATE


SHEET NUMBER


A3.1

1/4" = 1'-0"

1 NORTH (STREET) EXTERIOR ELEVATION 1/4" = 1'-0"

COPYRIGHT © - 2016 STUDIO 4 ARCHITECTURE. ALL RIGHTS RESERVED. NO PART OF THIS DOCUMENT MAY BE REPF PERMISSION FROM STUDIO 4 ARCHITECTURE (S4A). S4A DISCLAIMS ANY RESPONSIBILITY FOR ITS UNAUTHORIZED L

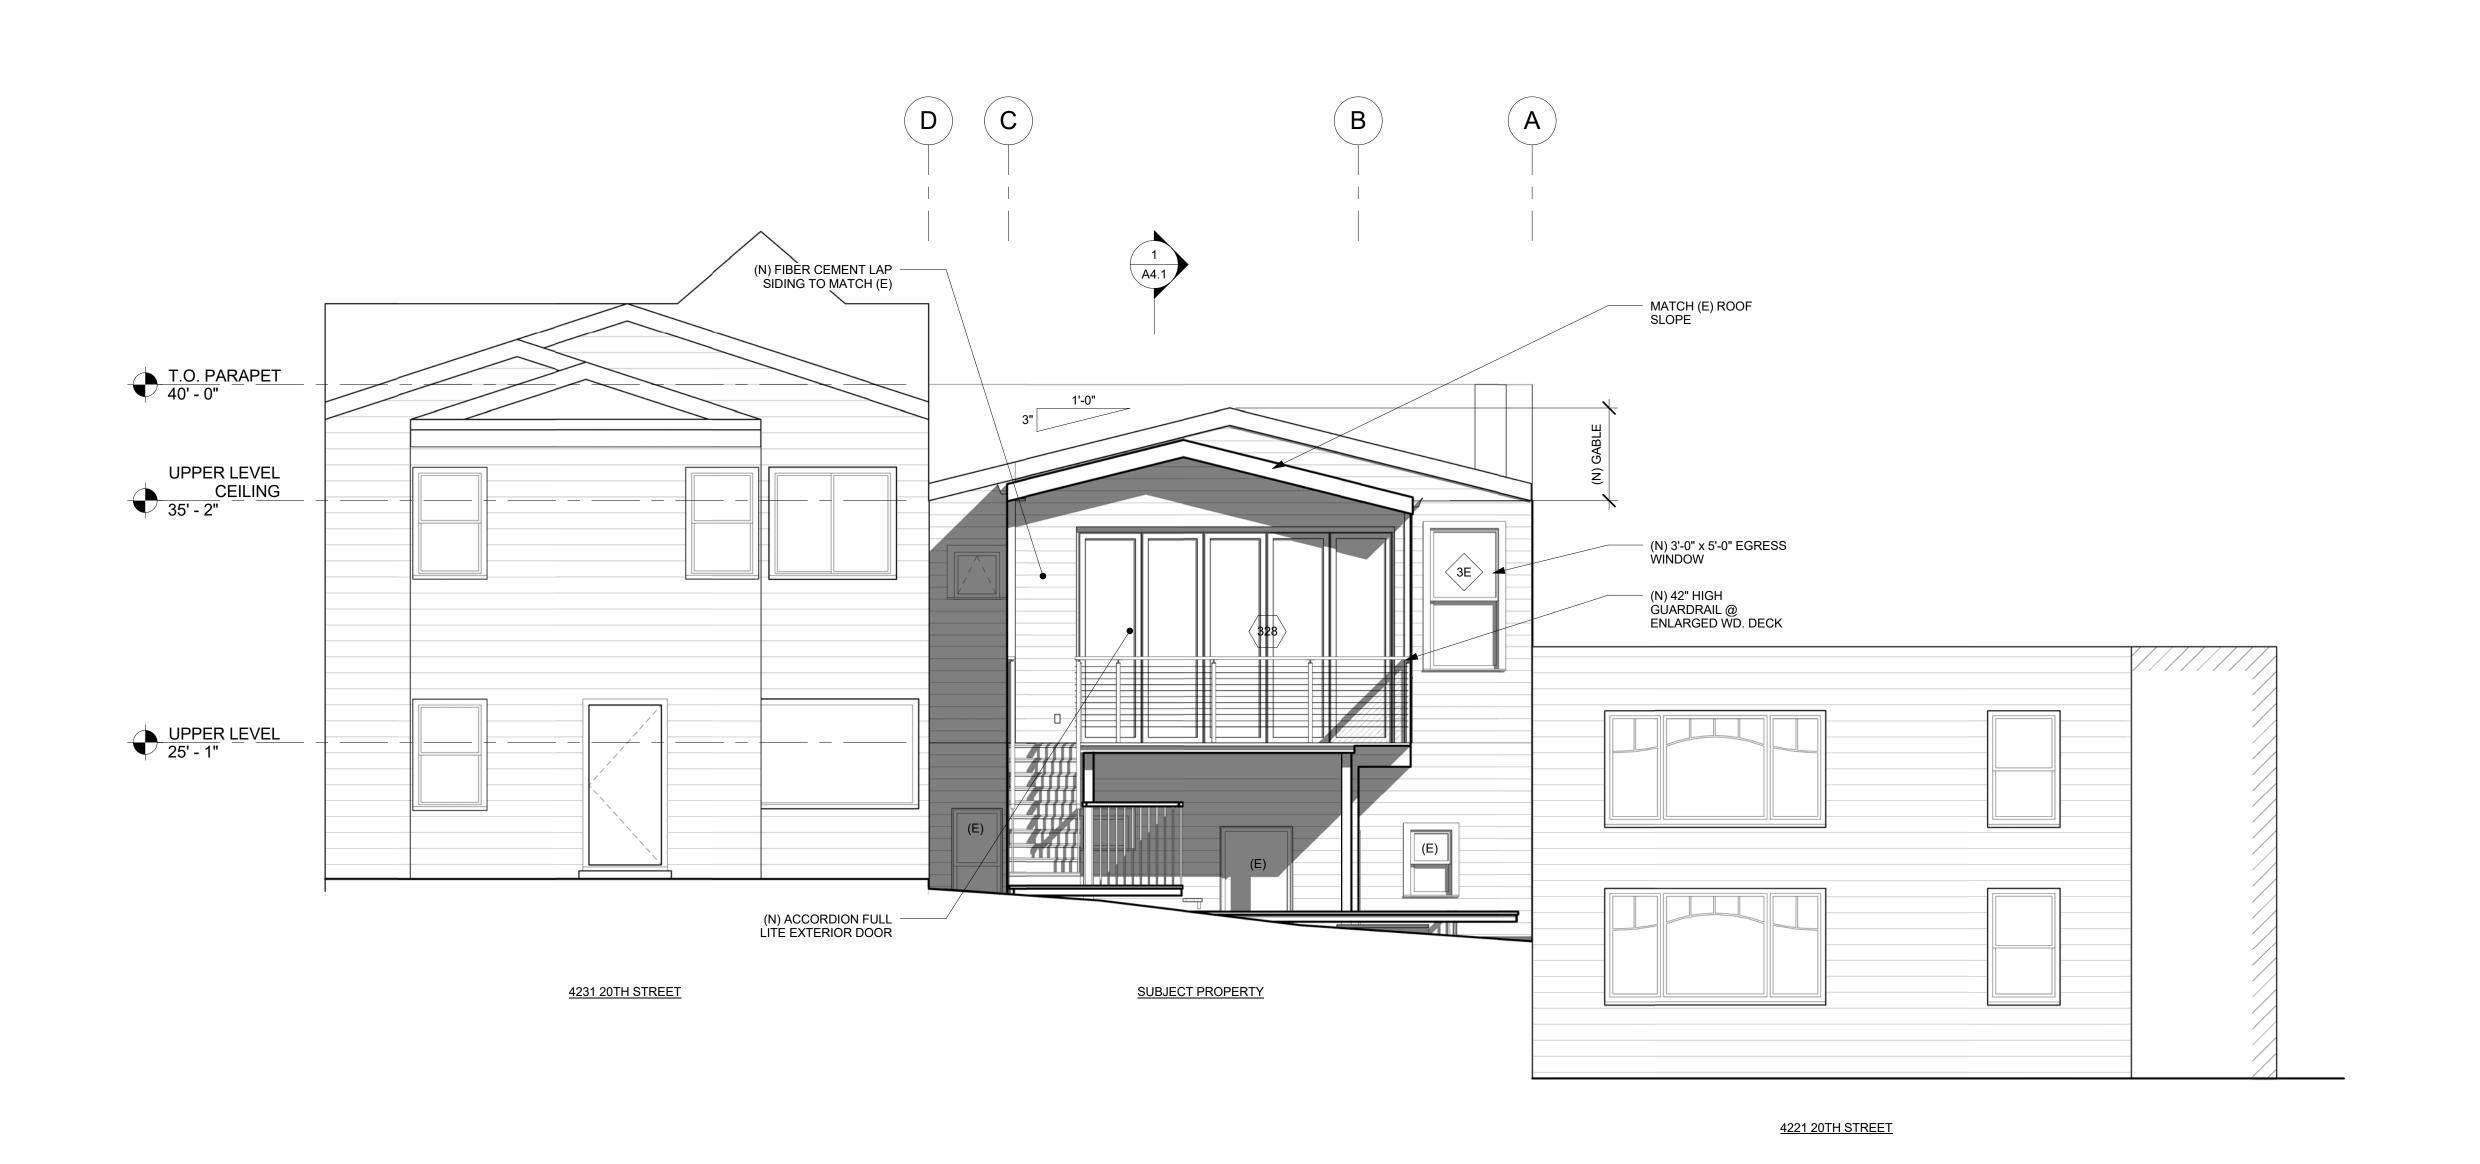

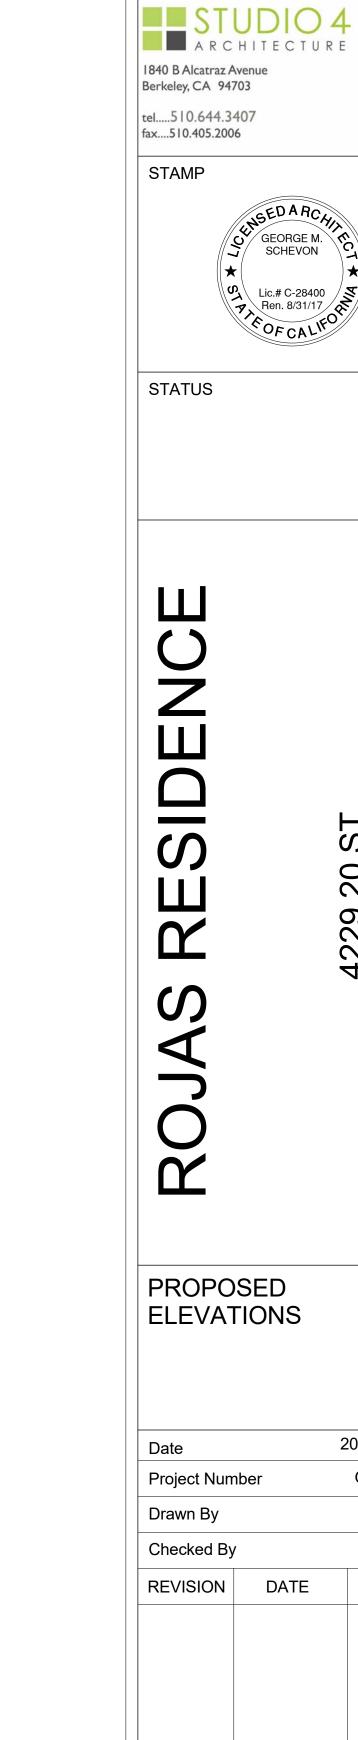

PROPOSED ELEVATIONS

GEORGE M. SCHEVON

2016-03-10 GS15139 Project Number TMW Drawn By Checked By DATE REVISION

SHEET NUMBER

A3.2

1/4" = 1'-0"

 $1 \frac{\text{SOUTH EXTERIOR ELEVATION}}{1/4" = 1'-0"}$ 

STUDIO 4
ARCHITECTURE 1840 B Alcatraz Avenue Berkeley, CA 94703 tel....510.644.3407 fax....510.405.2006 STAMP GEORGE M. SCHEVON STATUS PROPOSED ELEVATIONS 2016-03-10 GS15139 Project Number TMW Drawn By GMS Checked By REVISION DATE

SHEET NUMBER

A3.3

1/4" = 1'-0"

EAST EXTERIOR ELEVATION

1/4" = 1'-0"

COPYRIGHT © - 2016 STUDIO 4 ARCHITECTURE. ALL PERMISSION FROM STUDIO 4 ARCHITECTURE (S4A).

COPYRIGHT © - 2016 STUDIO 4 ARCHITECTURE. ALL RIGHTS RESERVED. NO PART OF THIS DOCUMENT MAY BE REPROD PERMISSION FROM STUDIO 4 ARCHITECTURE (S4A). S4A DISCLAIMS ANY RESPONSIBILITY FOR ITS UNAUTHORIZED USE.

1 WEST EXTERIOR ELEVATION
1/4" = 1'-0"

1840 B Alcatraz Avenue Berkeley, CA 94703 tel....510.644.3407 fax....510.405.2006 STAMP STATUS PROPOSED ELEVATIONS

Date	2016-03-1	1	
Project Num	Project Number Drawn By		3
Drawn By			I۷
Checked By		GM	1
REVISION	DATE	BY	_

SHEET NUMBER

1/4" = 1'-0"