MEMO

Disclaimer for Review of Plans

The San Francisco Planning Code requires that the plans of certain proposed projects be provided to members of the public prior to the City's approval action on the project. Accordingly, any images of plans featured on this website are provided for the primary purpose of facilitating public input prior to the City's action. The City and County of San Francisco does not own the copyright to these images. Please be aware that the unauthorized reproduction, distribution, or alteration of these images may result in a violation of Federal Copyright Law (17 U.S.C.A. Sections 101 et seq.) and that any party who seeks to reproduce or alter these images does so at his or her own risk.

Additionally, plans provided on this website are limited to site plans, elevations and/or section details (floor plans and structural details may not be included). These are DRAFT PLANS being provided for public review PRIOR to the City's approval action on the project. Final plans may differ from those that are currently available for review.

1650 Mission St. Suite 400 San Francisco, CA 94103-2479

Reception: 415.558.6378

Fax: 415.558.6409

Planning Information: 415.558.6377 NOTICE OF PUBLIC HEARING

Hearing Date: Wednesday, July 27, 2016

Time: **9:30 AM**

Location: City Hall, 1 Dr. Carlton B. Goodlett Place, Room 408

Case Type: Variance(Front Setback and Street Frontage)

Hearing Body: **Zoning Administrator**

PORPERTY INFORMATION		APPLICATION INFORMATION	
Project Address:	3649 21st Street	Case No.:	2015-015029VAR
Cross Street(s):	Sanchez and Church Streets	Building Permit:	2015.1015.9779
Block / Lot No.:	3620/058	Applicant/Agent:	Patrick Perez
Zoning District(s):	RH-1/40-X	Telephone:	415-370-7269
Area Plan:	N/A	E-Mail:	patrick@architectural- development.com

PROJECT DESCRIPTION

The Proposed Project is to add a new subterranean garage underneath an existing single-family dwelling, which currently encroaches into the required front setback. The garage door will be located below an existing staircase.

PER SECTION 132 OF THE PLANNING CODE the subject property requires a front setback of approximately 15 feet. The proposed garage addition would be located approximately 8 feet from the front property line; therefore, the project requires a variance.

PER SECTION 144 OF THE PLANNING CODE street facing garages structures and garage doors may not extend closer to the street than the primary building façade. The primary building façade has a setback of 12.5 feet from the front property line and the new garage door will be located approximately 8 feet from the front property line; therefore, the project requires a variance.

ADDITIONAL INFORMATION

FOR MORE INFORMATION, PLEASE CONTACT PLANNING DEPARTMENT STAFF:

Planner: Erika Jackson Telephone: 415-558-6363 Mail: erika.jackson@sfgov.org

ARCHITECTURAL PLANS: The site plan and elevations of the proposed project are available on the Planning Department's website at: http://notice.sfplanning.org/2015-015029VAR.pdf

GENERAL INFORMATION ABOUT PROCEDURES

VARIANCE HEARING INFORMATION

Under Planning Code Section 306.3, you, as a property owner or resident within 300 feet of this proposed project or interested party on record with the Planning Department, are being notified of this Variance Hearing. You are not obligated to take any action. For more information regarding the proposed work, or to express concerns about the project, please contact the Applicant/Agent or Planner listed on this notice as soon as possible. Additionally, you may wish to discuss the project with your neighbors and neighborhood association or improvement club, as they may already be aware of the project.

Persons who are unable to attend the public hearing may submit written comments regarding this application to the Zoning Administrator, Planning Department, 1650 Mission Street, Suite 400, San Francisco, CA 94103, by 5:00pm the day prior to the hearing. These comments will be made a part of the official public record, and will be brought to the attention of the person or persons conducting the public meeting or hearing

BUILDING PERMIT APPLICATION INFORMATION

Under Planning Code Section 311/312, the Building Permit Application for this proposal is also subject to a 30-day notification to occupants and owners within 150-feet of the subject property. **The mailing of such notification will be perfromed separately.**

BOARD OF APPEALS

An appeal of the approval (or denial) of a **variance application** by the Zoning Administrator may be made to the **Board of Appeals within 10 days** after the **Variance Decision Letter** is issued by the Zoning Administrator.

An appeal of the approval (or denial) of a **building permit application** by the Planning Department may be made to the **Board of Appeals within 15 days** after the **building permit** is issued (or denied) by the Director of the Department of Building Inspection.

Appeals must be submitted in person at the **Board's office at 1650 Mission Street, 3rd Floor, Room 304**. For further information about appeals to the Board of Appeals, including current fees, **contact the Board of Appeals** at **(415) 575-6880**.

ABOUT THIS NOTICE

The Planning Department is currently reviewing its processes and procedures for public notification as part of the Universal Planning Notification (UPN) Project. The format of this Public Hearing notice was developed through the UPN Project and is currently being utilized in a limited trial-run for notification of Variance Hearings.

If you have any comments or questions related to the UPN Project or the format of this notice, please visit our website at http://upn.sfplanning.org for more information.

中文詢問請電:558.6378

Para información en Español llamar al: 558.6378

PENNEBAKER/GONZALES RESIDENCE

3649 TWENTY FIRST ST. SAN FRANCISCO, CA

PROJECT NOTES 1. All construction, regardless of details on plans, shall comply with the 2013 California

- Building Code, 2013 California Residential Code, 2013 California Plumbing Code, 2013 California Mechanical Code, 2013 California Electrical Code, 2013 Green Building Standards, 2013 California Building Energy Standards and Mill Valley Municipal Code.
- 2. The documents describe intent. Contractor is responsible to provide complete, operational systems and installations. No claims for additional work will be awarded for work which is described in these documents or which is reasonably inferable from them.
- 3. All dimensions, notes and details shown on a portion of a drawing shall apply typically to all opposite hand and/or similar conditions, U.O.N.
- 4. Details shown are typical. Similar details apply to similar conditions.
- 5. Contractor is responsible for the thorough coordination of all trades. No claims for additional work will be awarded for work related to such coordination.
- 6. The Contractor shall examine the contract documents and shall inform himself as to the entire contents thereof before submitting his proposal. Any errors or ambiguities noted by him during said examination should immediately be called to the attention of the Architect before submitting a bid thereto. The Architect will issue an addendum or interpretation of the cited error or ambiguity. No subsequent claim for extra work will be allowed on account of claimed misunderstanding of the meaning or intent of the contract documents or any portion thereof if the item occasioning the claim appeared in, or was inferable from, said documents as furnished for bidding purposes.
- 7. The Contractor should visit the work site to ascertain by inspection pertinent local conditions such as location, character and accessibility of the site, availability of the facilities, character of existing building, etc.
- 8. Where a structural element is removed as indicated on drawings, verify location and dimensions with structural and architectural documents. Shore and brace as required.
- 9. Electrical, mechanical design/build subcontractors will be responsible for obtaining permits for their scope of work from the agencies having jurisdiction.
- 10. One copy of all building permits shall be submitted to the Architect.
- 11. All dimensions are to finish face of masonry, face of concrete, centerline of steel, face of mill work, or fixtures U.O.N. Dimensions are not adjustable without Architect's approval unless noted as "±". Verify dimensions marked "V.I.F." prior to commencement of construction and notify architect in writing of any inconsistencies.
- 12. Contractor shall not scale drawings. Dimensions shall govern. Drawings at a large scale shall take precedence over drawings of a small scale. Details shall govern over plans, sections and elevations.
- 13. Contractor shall verify rough opening requirements with manufacturers unit dimensions and prevent provision of required rough opening, specifics of the situation shall be reported in writing to the Architect.
- 14. All mounting of equipment, fixtures or accessories including wall, floor and ceiling installation - shall be as required to meet provisions of the 2010 California Building Code. the Mill Valley Planning Code all other applicable codes, the requirements of all other agencies having jurisdiction, and manufacturers instructions. In cases of differences contractor shall notify architect in writing. All casework shall be secured to support blocking at walls.
- 15. Contractor shall notify Architect immediately of all utilities determined in the course of construction as being necessary to be removed which have not otherwise been noted for removal. Contractor shall remove such utilities only after the consultation with the Architect and Owner. All utilities removed shall be disconnected, cut back to source, and capped. All penetrations created by the removal of utilities shall be sealed to match adjacent construction and finishes.
- 16. Delays resulting from failure to supply submittals and information shall be the responsibility of the General Contractor. Appropriate steps shall be taken to make up for
- 17. Contractor shall protect area and new or existing materials and finishes from damage which may occur from construction, demolition, dust, water, etc. and shall provide and maintain temporary barricades, closure walls, etc., as required to protect the public during the period of construction. Damage to new and existing materials, finishes, structures, and the equipment shall be repaired or replaced to the satisfaction of the Owner at the expense of the General Contractor.
- 18. Work areas to remain secure and lockable during construction.
- 19. Contractor shall remove all rubbish and waste materials of all subcontractors and trades on a daily basis and shall exercise strict control over job cleaning to prevent any dirt, debris or dust from affecting any finished areas in or outside the job site. Burning of debris on the site shall not be permitted.
- 20. Upon completion, the Contractor shall leave the premises and all affected areas clean to a broom clean condition and in an orderly manner ready for move-in.
- 21. Security provisions are part of this contract. Contractor shall review work and coordination requirements prior to start of construction.
- 22. Contractor shall not proceed with any work requiring additional compensation beyond the contract amount without written authorization from the architect or owners representative. Failure to obtain written authorization shall invalidate any claim for additional compensation.
- 23. Place and secure all ancor bolts and other items to be cast in concrete for foundation inspection. Wet setting anchor bolts or reinforcing after placement of concrete is not allowed.

ABBREVIATIONS

Air Conditioning Acoustical Above Finish Floor Nom. Aggregate # Alternate NIC Approximate N.T.S. Architectural Average

Perp.

Pl.

Rad.

R.D.

R.V.

Ref.

Resil.

R.O.

Bitum. **Bituminous** Building Cabinet Cem. Cement Ceramic Center Line Ceiling Clear Column

Board, Bead

Acous.

A.F.F.

Approx.

Avg.

Constr

Cont.

Dept.

P.L. Plas. Concrete Plywd. Construction Continuous Prop. Ptn. Double P.T. Department Diameter Qty. Dimension

Down Dwg. Drawing Existing East Ea. Each EI. Elevation Elect. Electrical Elev. Elevator Emer. Emergency Encl. Enclosure Egual Equipment Ext. Exterior

Fire Alarm Floor Drain F.F. Finish Floor Fdn. Foundation Finish Floor Fluor. Fluorescent Fireproof Foot / Feet Footing Furr. Furring

Gauge Galvanized Glass Grid Line Gyp. Bd. Gypsum Board Hose Bibb

> Hardware Horizontal Height Inside Diameter Insulation Interior Janitor Joint Laboratory

Hardwood

Hdwd.

Hdwe.

Horiz.

Insul.

Lab.

Min.

Misc.

Mtd.

Lt.

Light Mach. Machine Material Maximum Mech. Mechanical Memb. Membrane Manuf. Manufacturer Minimum Miscellaneous Mounted

North Nominal Number Number Not in Contract Not To Scale

O.C. On Center O.D. Outside Diameter Opg. Opening Opp. Opposite Perf. Perforated

> Perpendicular Property Line Plastic Laminate Plaster Plywood Property Partition Pressure Treated

Quantity Riser Radius Room Roof Drain Roof Vent

Refrigerator Reinforced Reg'd. Required Resilient Rough Opening R.W.L. Rain Water Leader

See Architectural Drawings S.A.D Sched. Schedule Sect. Section S.E.D. See Electrical Drawings S.L.D. See Landscape Drawings S.M.D. See Mechanical Drawings S.P.D. See Plumbing Drawings Spec. Specification Square See Structural Drawings

S.S.D. S.S. Stainless Steel Std. Standard Stl. Steel Stor. Storage Struct. Structural Susp. Suspended Sym. Symmetrical

Tread Tel. Telephone Temp. Tempered Terrazzo Tongue and Groove T.O. Top of T.O.P. Top of Parapet TV Television Тур. Typical Unfin. Unfinished

U.O.N. Unless Otherwise Noted Util. Utility Vert. Vertical Vest. Vestibule V.I.F. Verify in Field West

W

W/ With W.C. Water Closet W/D Washer/Dryer W.H. Water Heater WL Water Line W/O Without

PROJECT DIRECTORY

Property Owners / David Pennebaker **Daniel Gonzales**

DESIGNER Gary Jerabeck

Architectural Development, INC. #2 Third Street San Francisco, CA

PROJECT INFORMATION

3649 Twenty First St. Address: San Francisco, CA

3620/058 **BLOCK/LOT** RH-1 Zoning: **Construction Type:**

EXISTING USE: Residential **PROPOSED USE:** Residential

EXISTING Occupancy: Single Family-Residential **PROPOSED Occupancy:** Single Family-Residential

AREAS (gross):

EXISTING CONDITION NET SQFT

TOTAL: 2228 SF

PROPOSED CONDITION NET SQFT **GARAGE** 788 SF TOTAL: 3016 SF

SETBACKS REQUIRED:

FRONT SETBACK:

Average of Adjacent Building SIDE SETBACK:

SPC SECTION 132 LANDSCAPE SET BACK CALCULATIONS (E) FRONT SET BACK LANDSCAPE = 59 SQFT (N) FRONT SET BACK LANDSCAPE = 31 SQFT 31 / 59 = 53% 53% > 20 % O.K. GREEN ORDINANCE PERMEABLE SURFACE CALCULATIONS TOTAL FRONT SET BACK DRIVEWAY AREA = 270 SQFT

TOTAL PERMEABLE SURFACE = 270 SQFT 270/270 = 100% 100%>50% O.K.

PARKING

(E) PROVIDED/REQUIRED: 0 TOTAL (N) PROVIDED/REQUIRED: 2 TOTAL: 1 full size, 1 compact

DRAWING INDEX

NO.	SHEET NAME	
A0.0	COVER SHEET	
A0.1	PICTURES	
A0.2	SITE PLAN	
A1.00	NEW GARAGE LEVEL FLOOR PLAN	
A1.1	LEVEL 1 FLOOR PLAN	
A1.2	LEVEL 2 FLOOR PLAN	
A2.0	FRONT ELEVATIONS	
A2.1	SIDE ELEVATIONS	
A3.0	SECTIONS	
A3.1	SECTIONS	
A4.0	ELECTRICAL	


SCOPE OF WORK

New garage below first level

Replace or repair in kind existing front stairway

Partial Interior renovation

VICINITY MAP

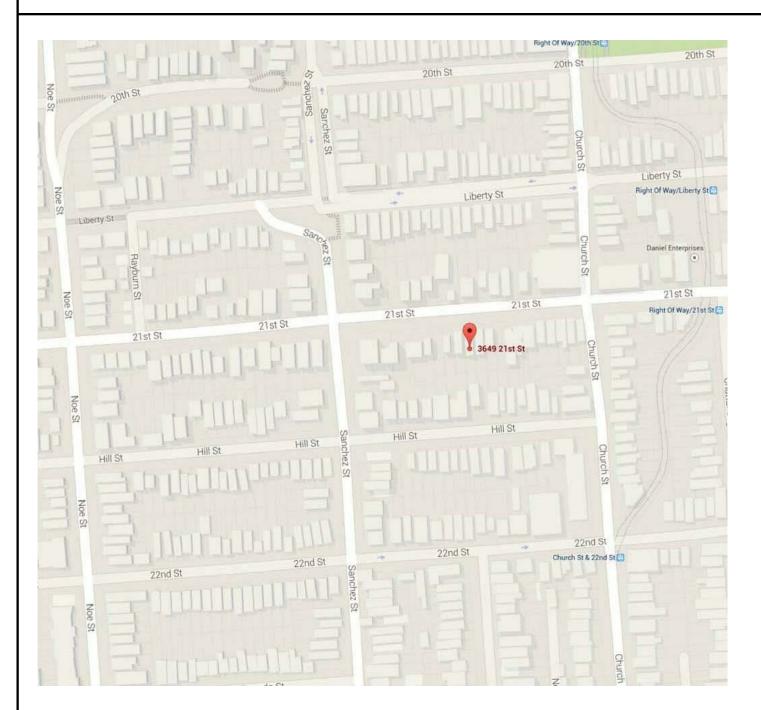

PENNEBAKER/GONZALES 3649 TWENTYFIRST ST SAN FRANCISCO, CA

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chitect

BLOCK/LOT 3620/058

COVER SHEET

Drawn by Checked by

A0.0

12/21/15

Scale









局 PENNEBAKER/GONZALES 3649 TWENTYFIRST ST SAN FRANCISCO, CA

BLOCK/LOT 3620/058


PICTURES


Drawn by

Scale

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No. Description

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BLOCK/LOT 3620/058

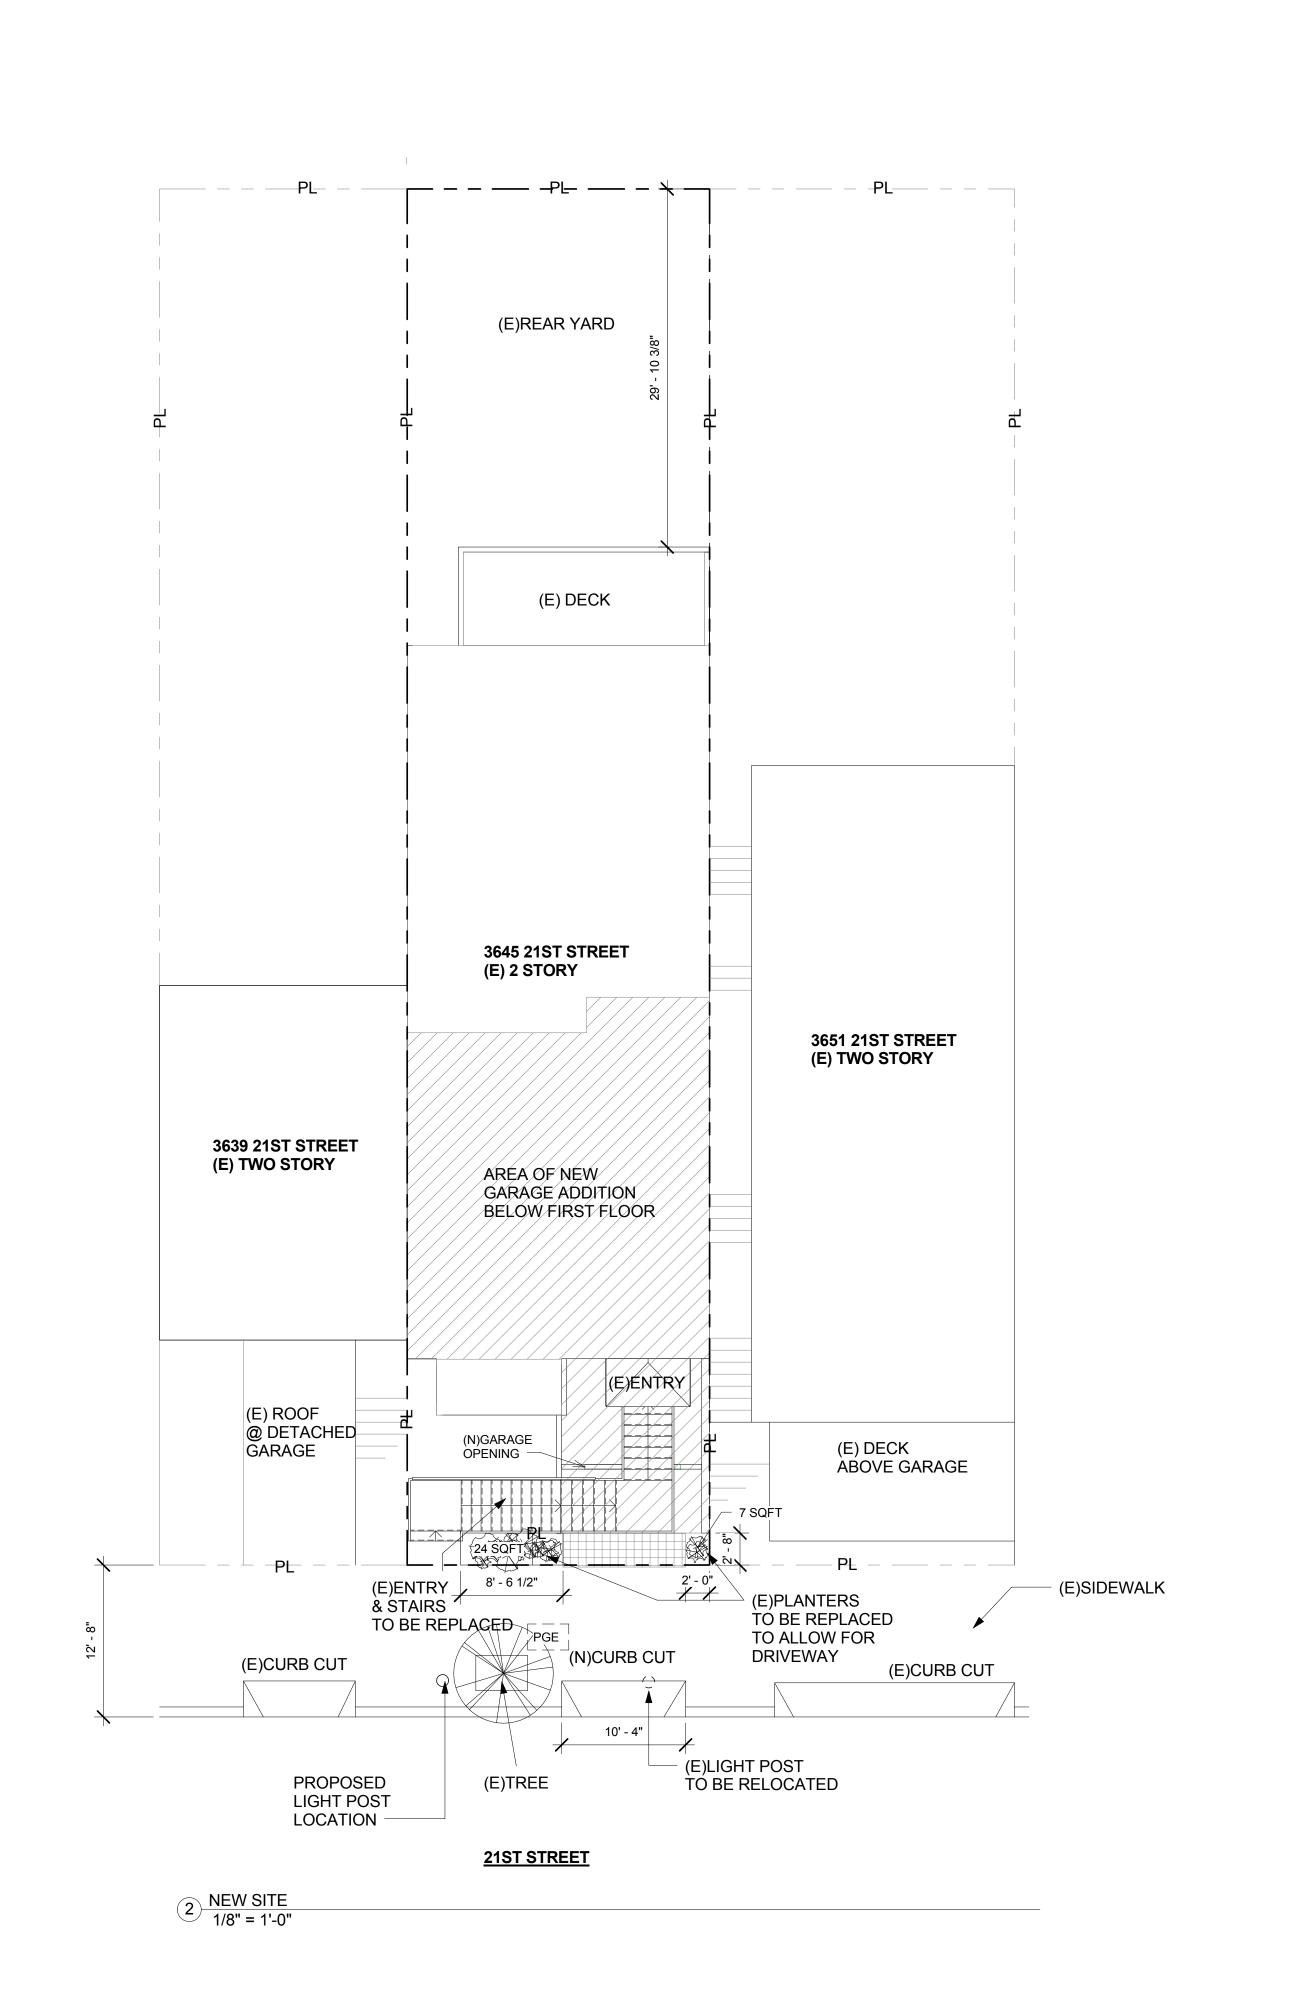SITE PLAN

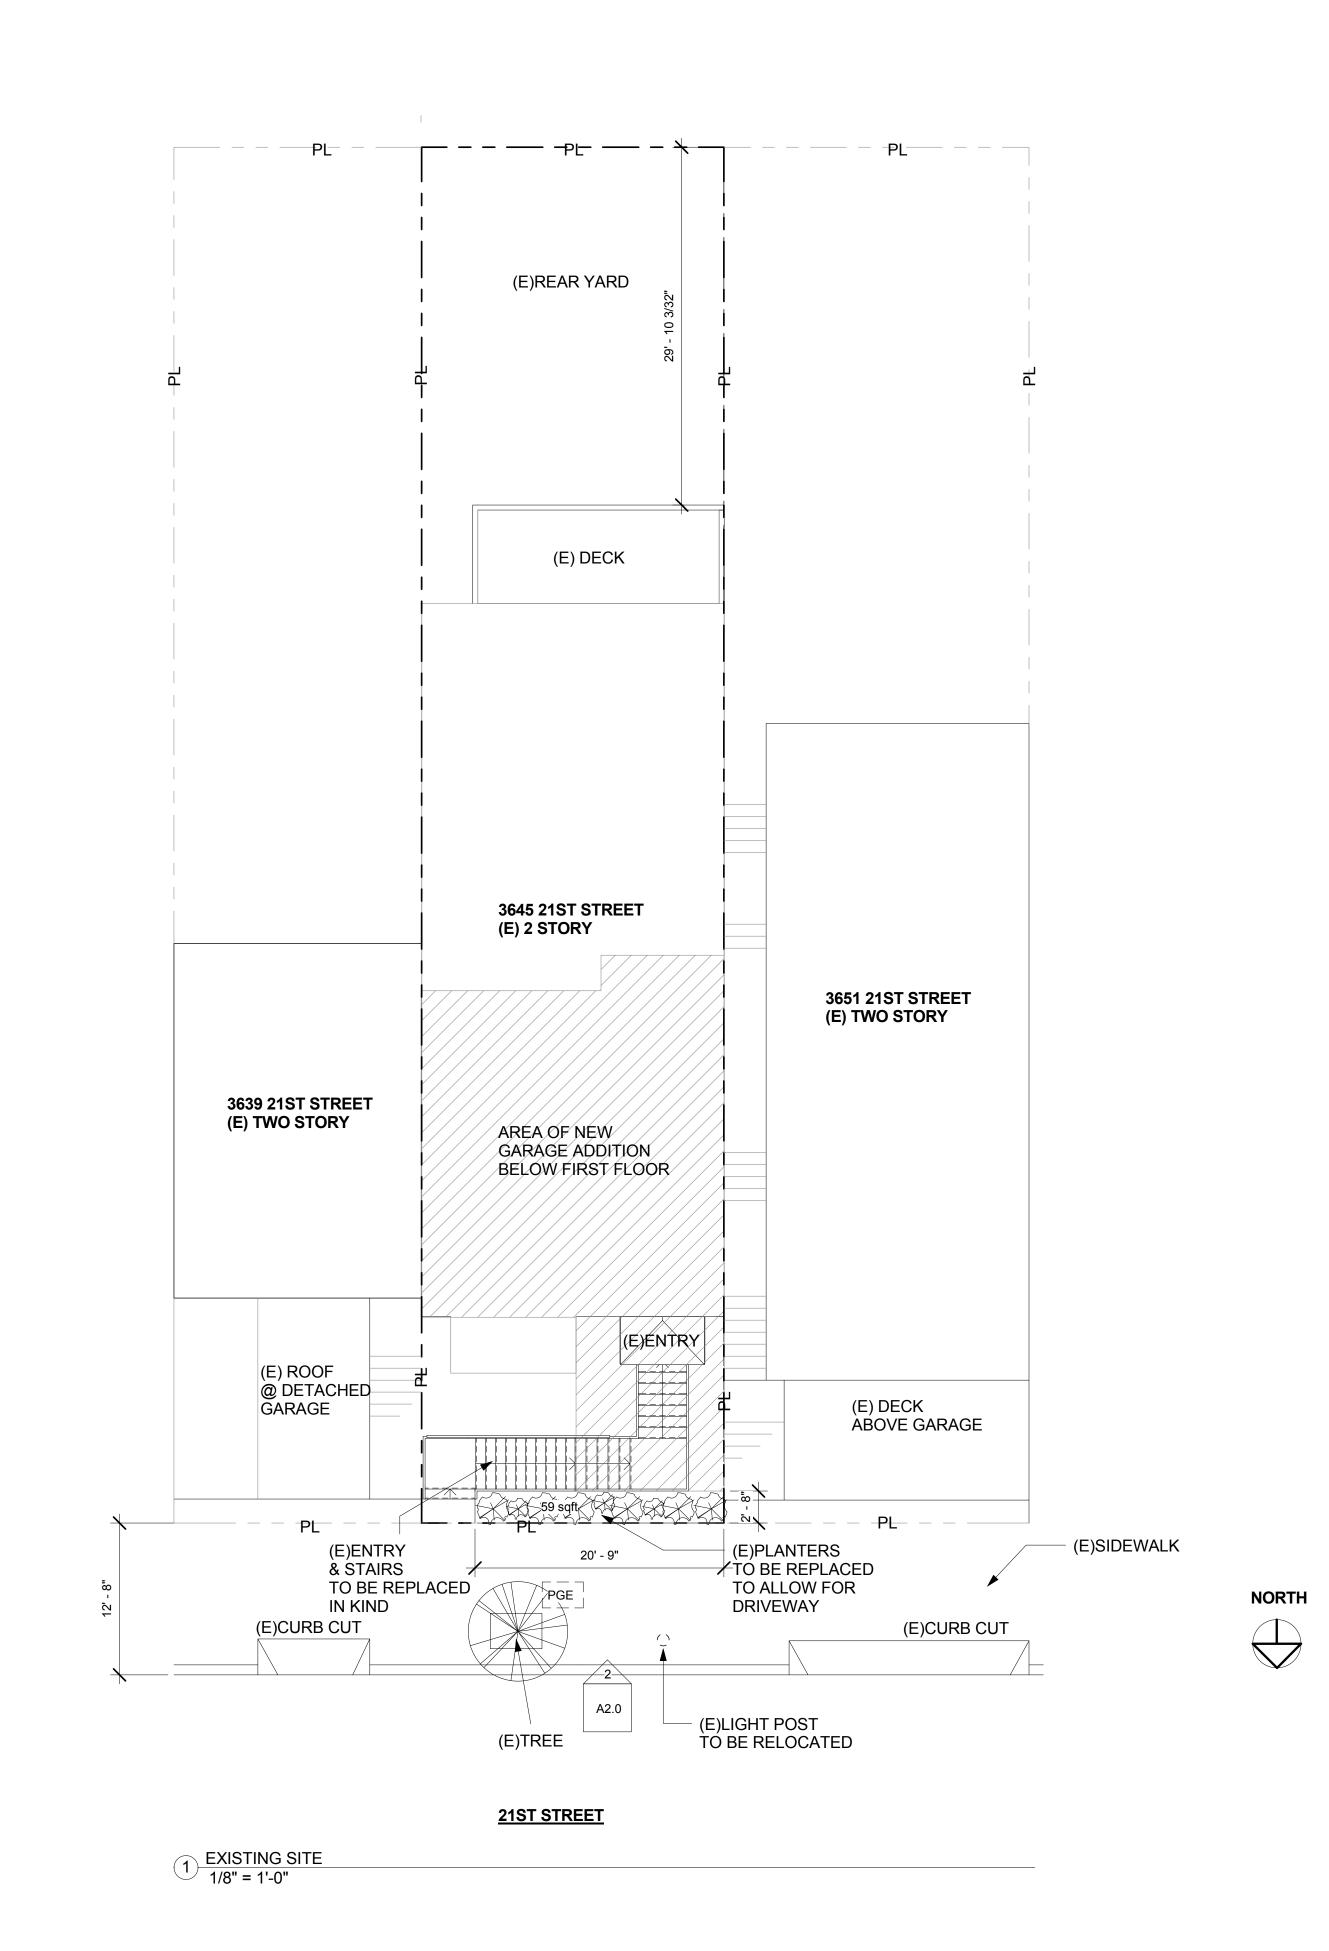Drawn by Checked by

12/21/15

1/8" = 1'-0" Scale

40' - 4 3/16" TRENCH DRAIN (N)STAIRS 7"MAX RISER 11" RUN (N) SOLID CONCRETE WALL (N)DRIVEWAY SLOPE MAX 25% SLOPE 1/8"/FT 5/8" TYPE X GYP. BOARD @ CEILING UP 3' - 0" VENT GARAGE DOOR 200 SQ IN VENT (N) SOLID CONCRETE WALL

Architectural DevelopinGARY JERABECK PA B PENNEBAKER/GONZALES 3649 TWENTYFIRST ST SAN FRANCISCO, CA

BLOCK/LOT 3620/058

NEW GARAGE LEVEL FLOOR PLAN 12/21/15

Drawn by Checked by

Author Checker

A1.00 1/4" = 1'-0"


Scale

NORTH

DEMO === WALL LEGEND
1/4" = 1'-0"

EXISTING _____

1 GARAGE LEVEL 1/4" = 1'-0"

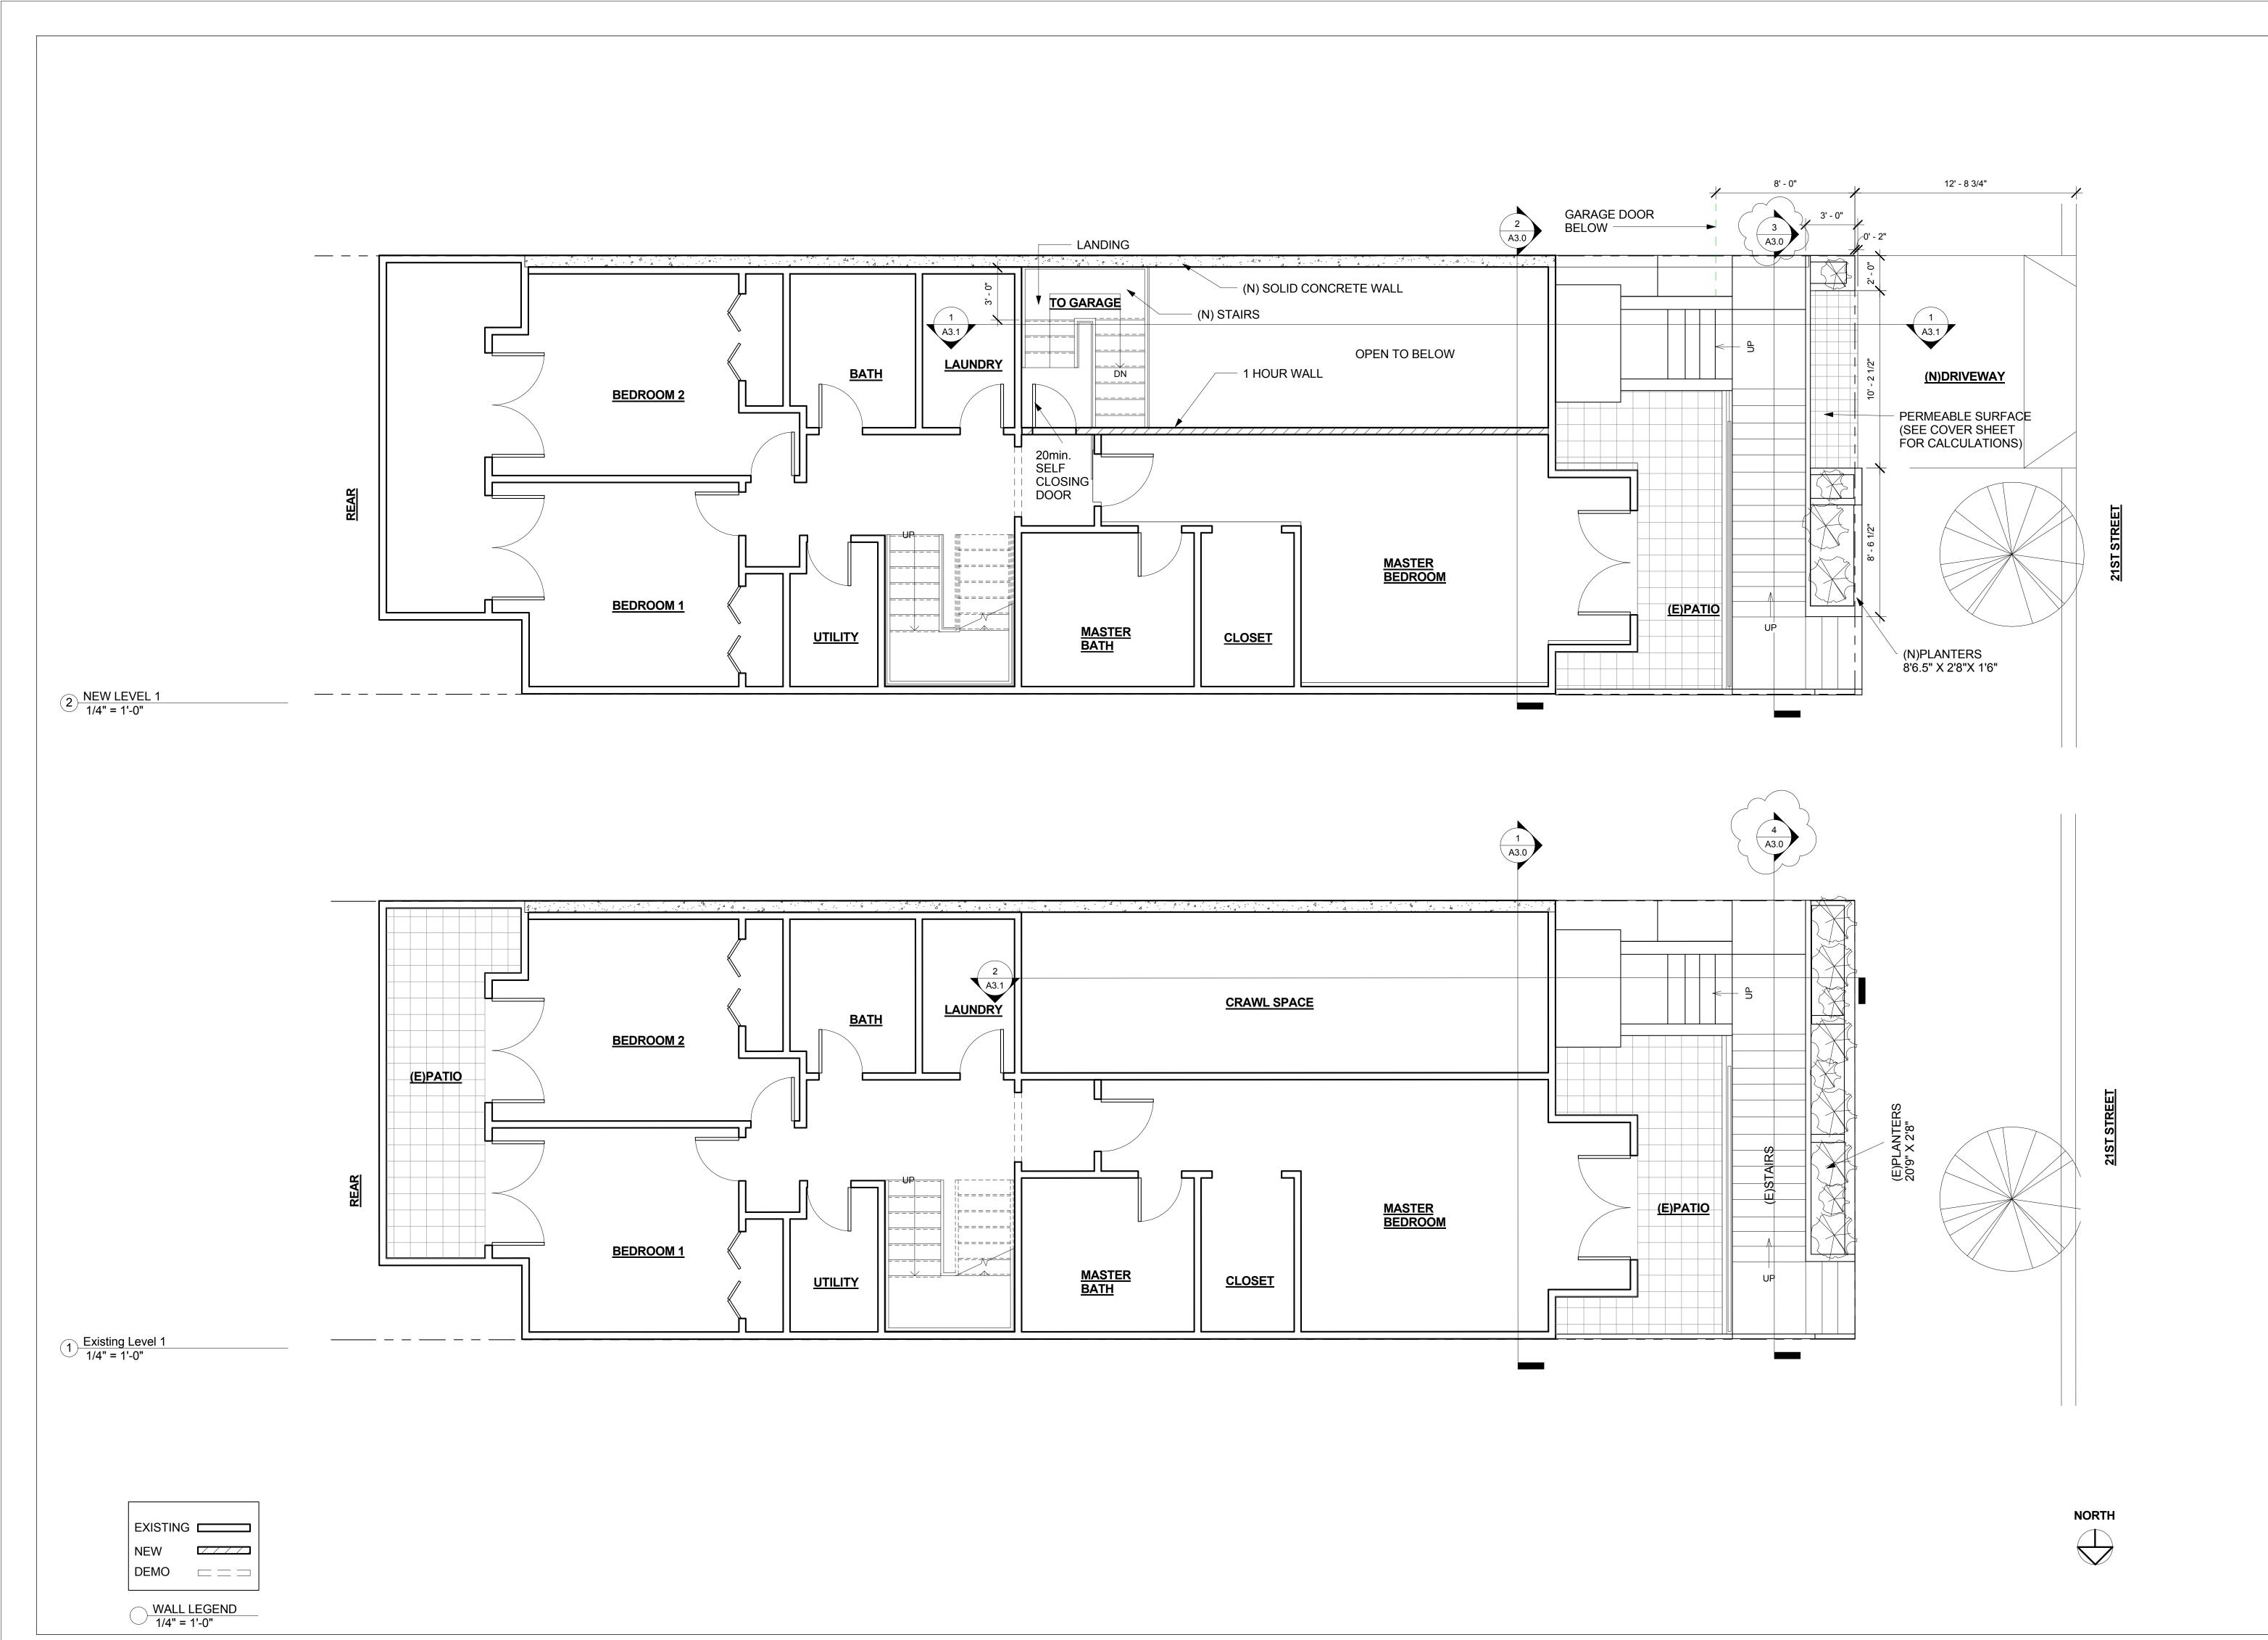

B


No.DescriptionDate1Section Revision5-13-16

PENNEBAKER/GONZALES 3649 TWENTYFIRST ST SAN FRANCISCO, CA

BLOCK/LOT 3620/058

LEVEL 1 FLOOR PLAN 12/21/15 Drawn by

Checked by A1.1 1/4" = 1'-0"

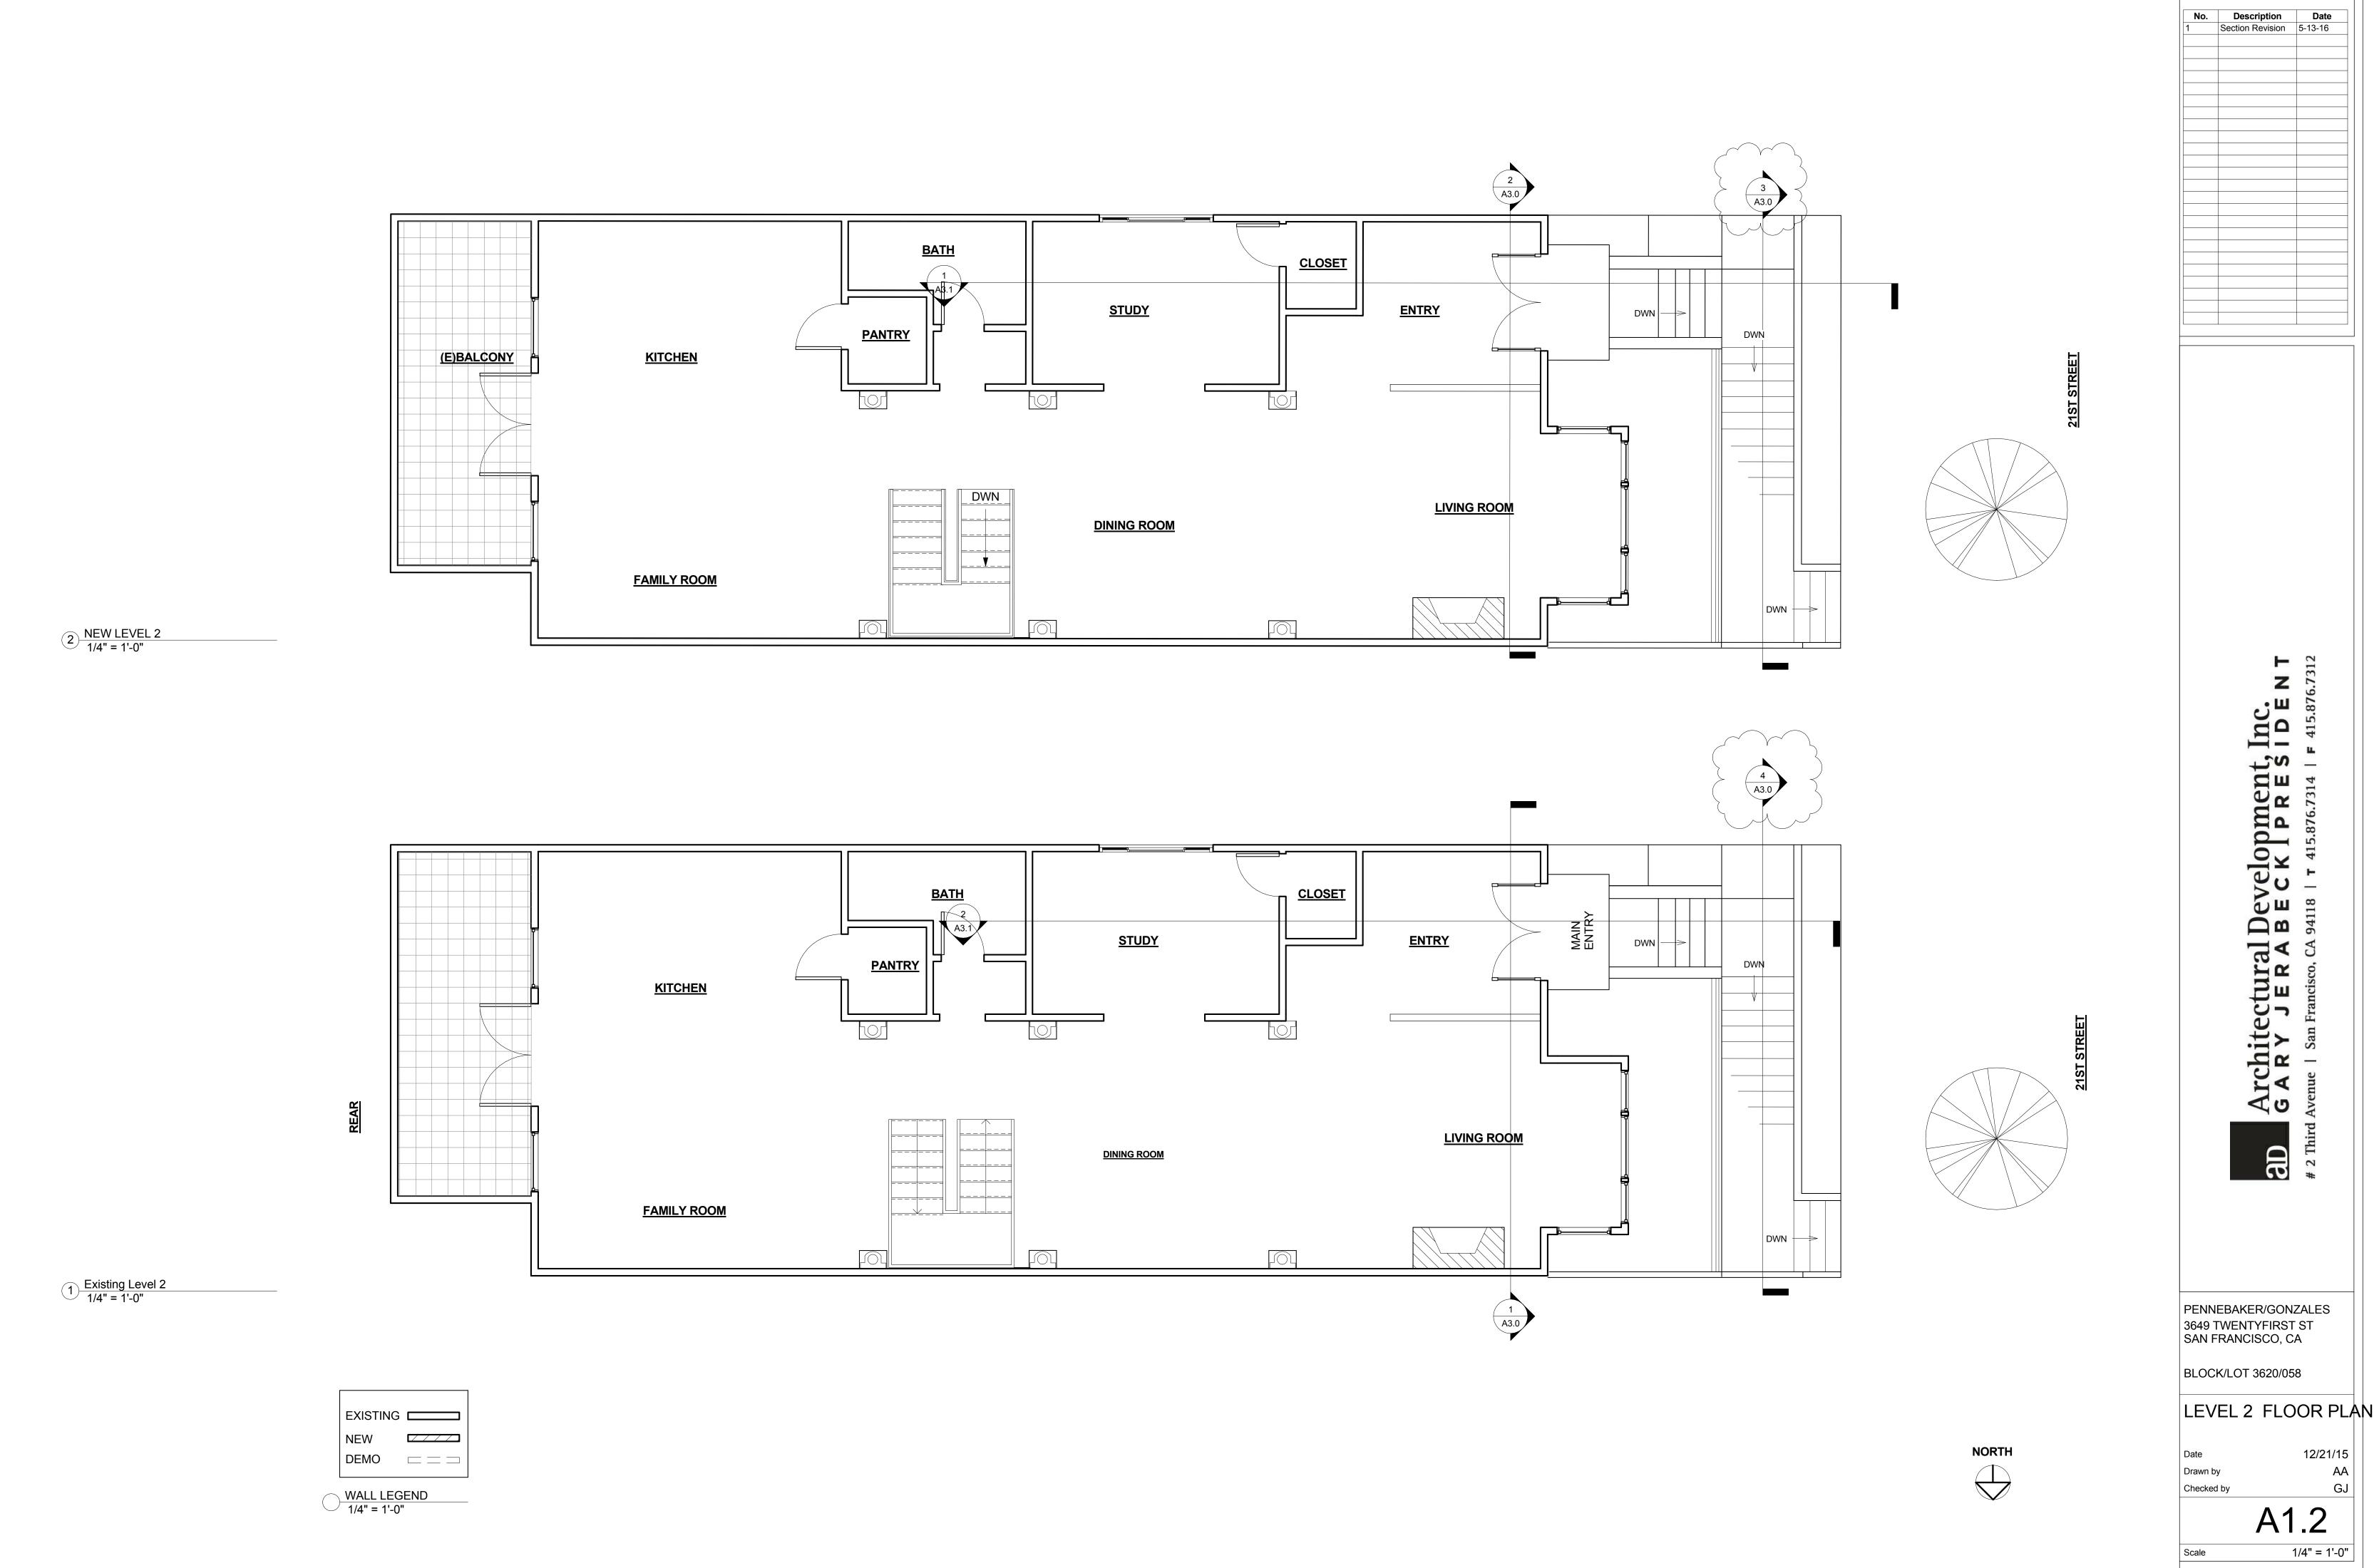

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12/21/15

1/4" = 1'-0"

A1.2



PENNEBAKER/GONZALES 3649 TWENTYFIRST ST SAN FRANCISCO, CA


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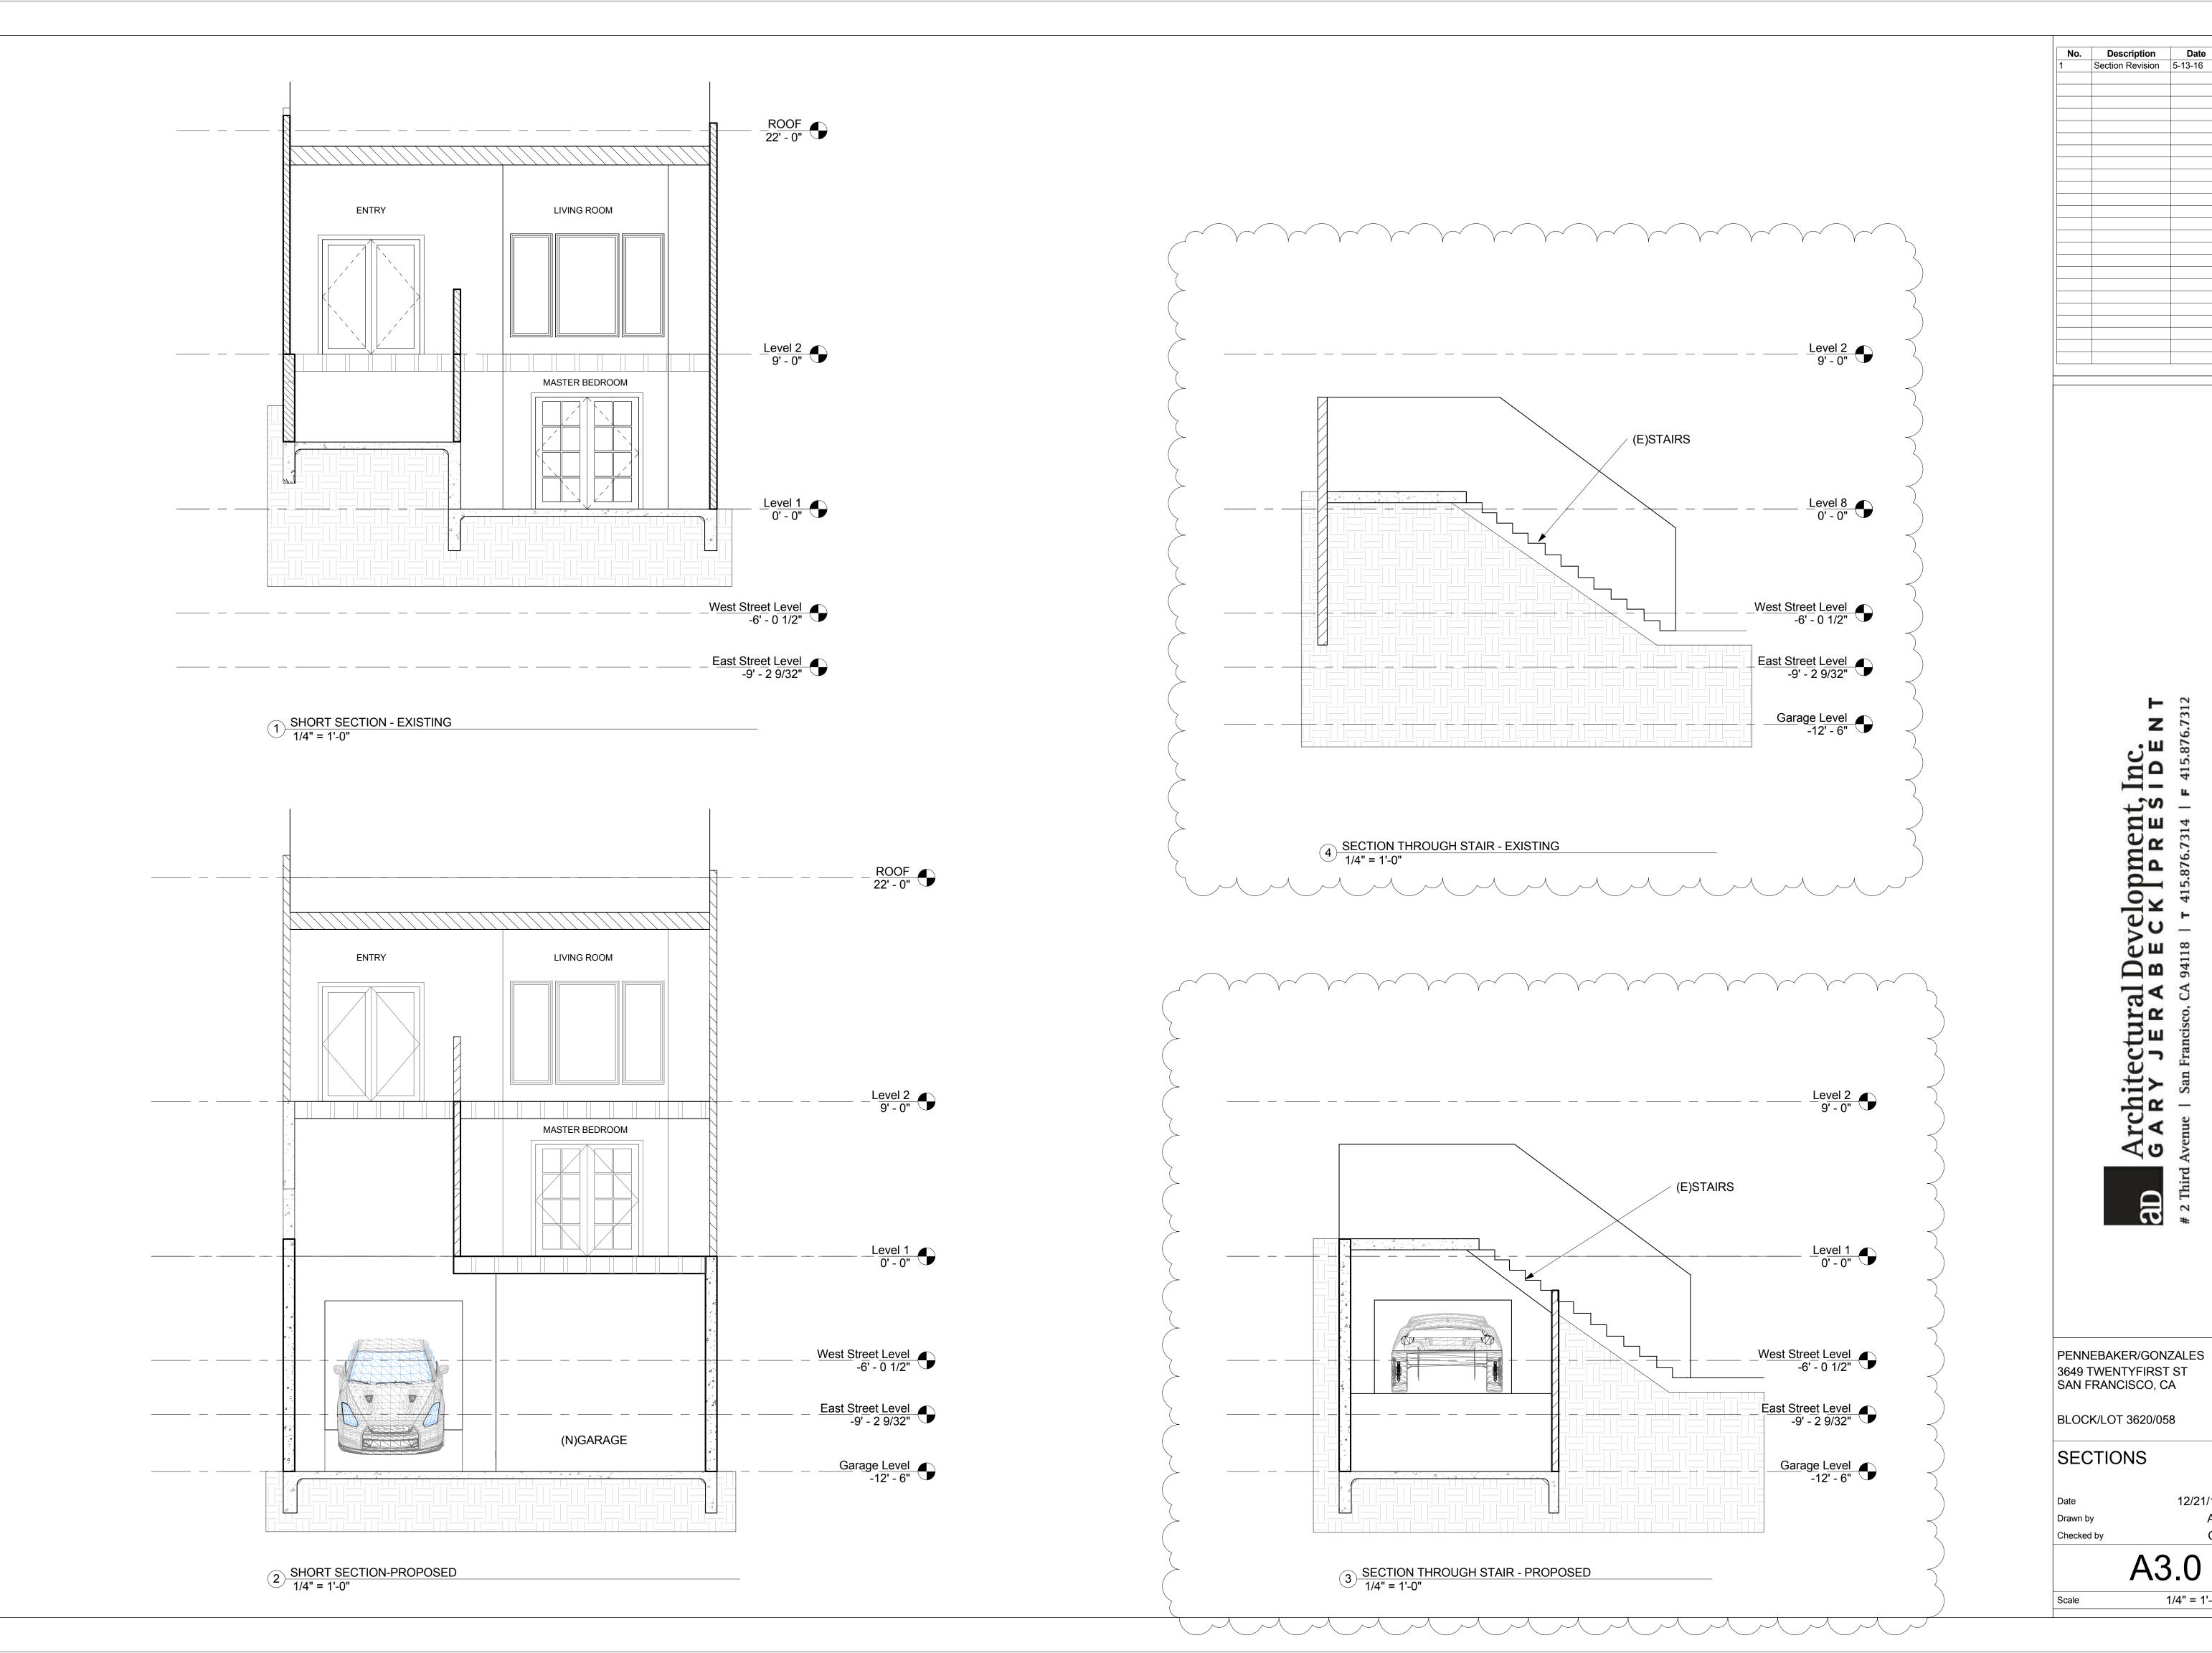
BLOCK/LOT 3620/058

FRONT ELEVATION\$

12/21/15 Drawn by Checked by

1/4" = 1'-0"



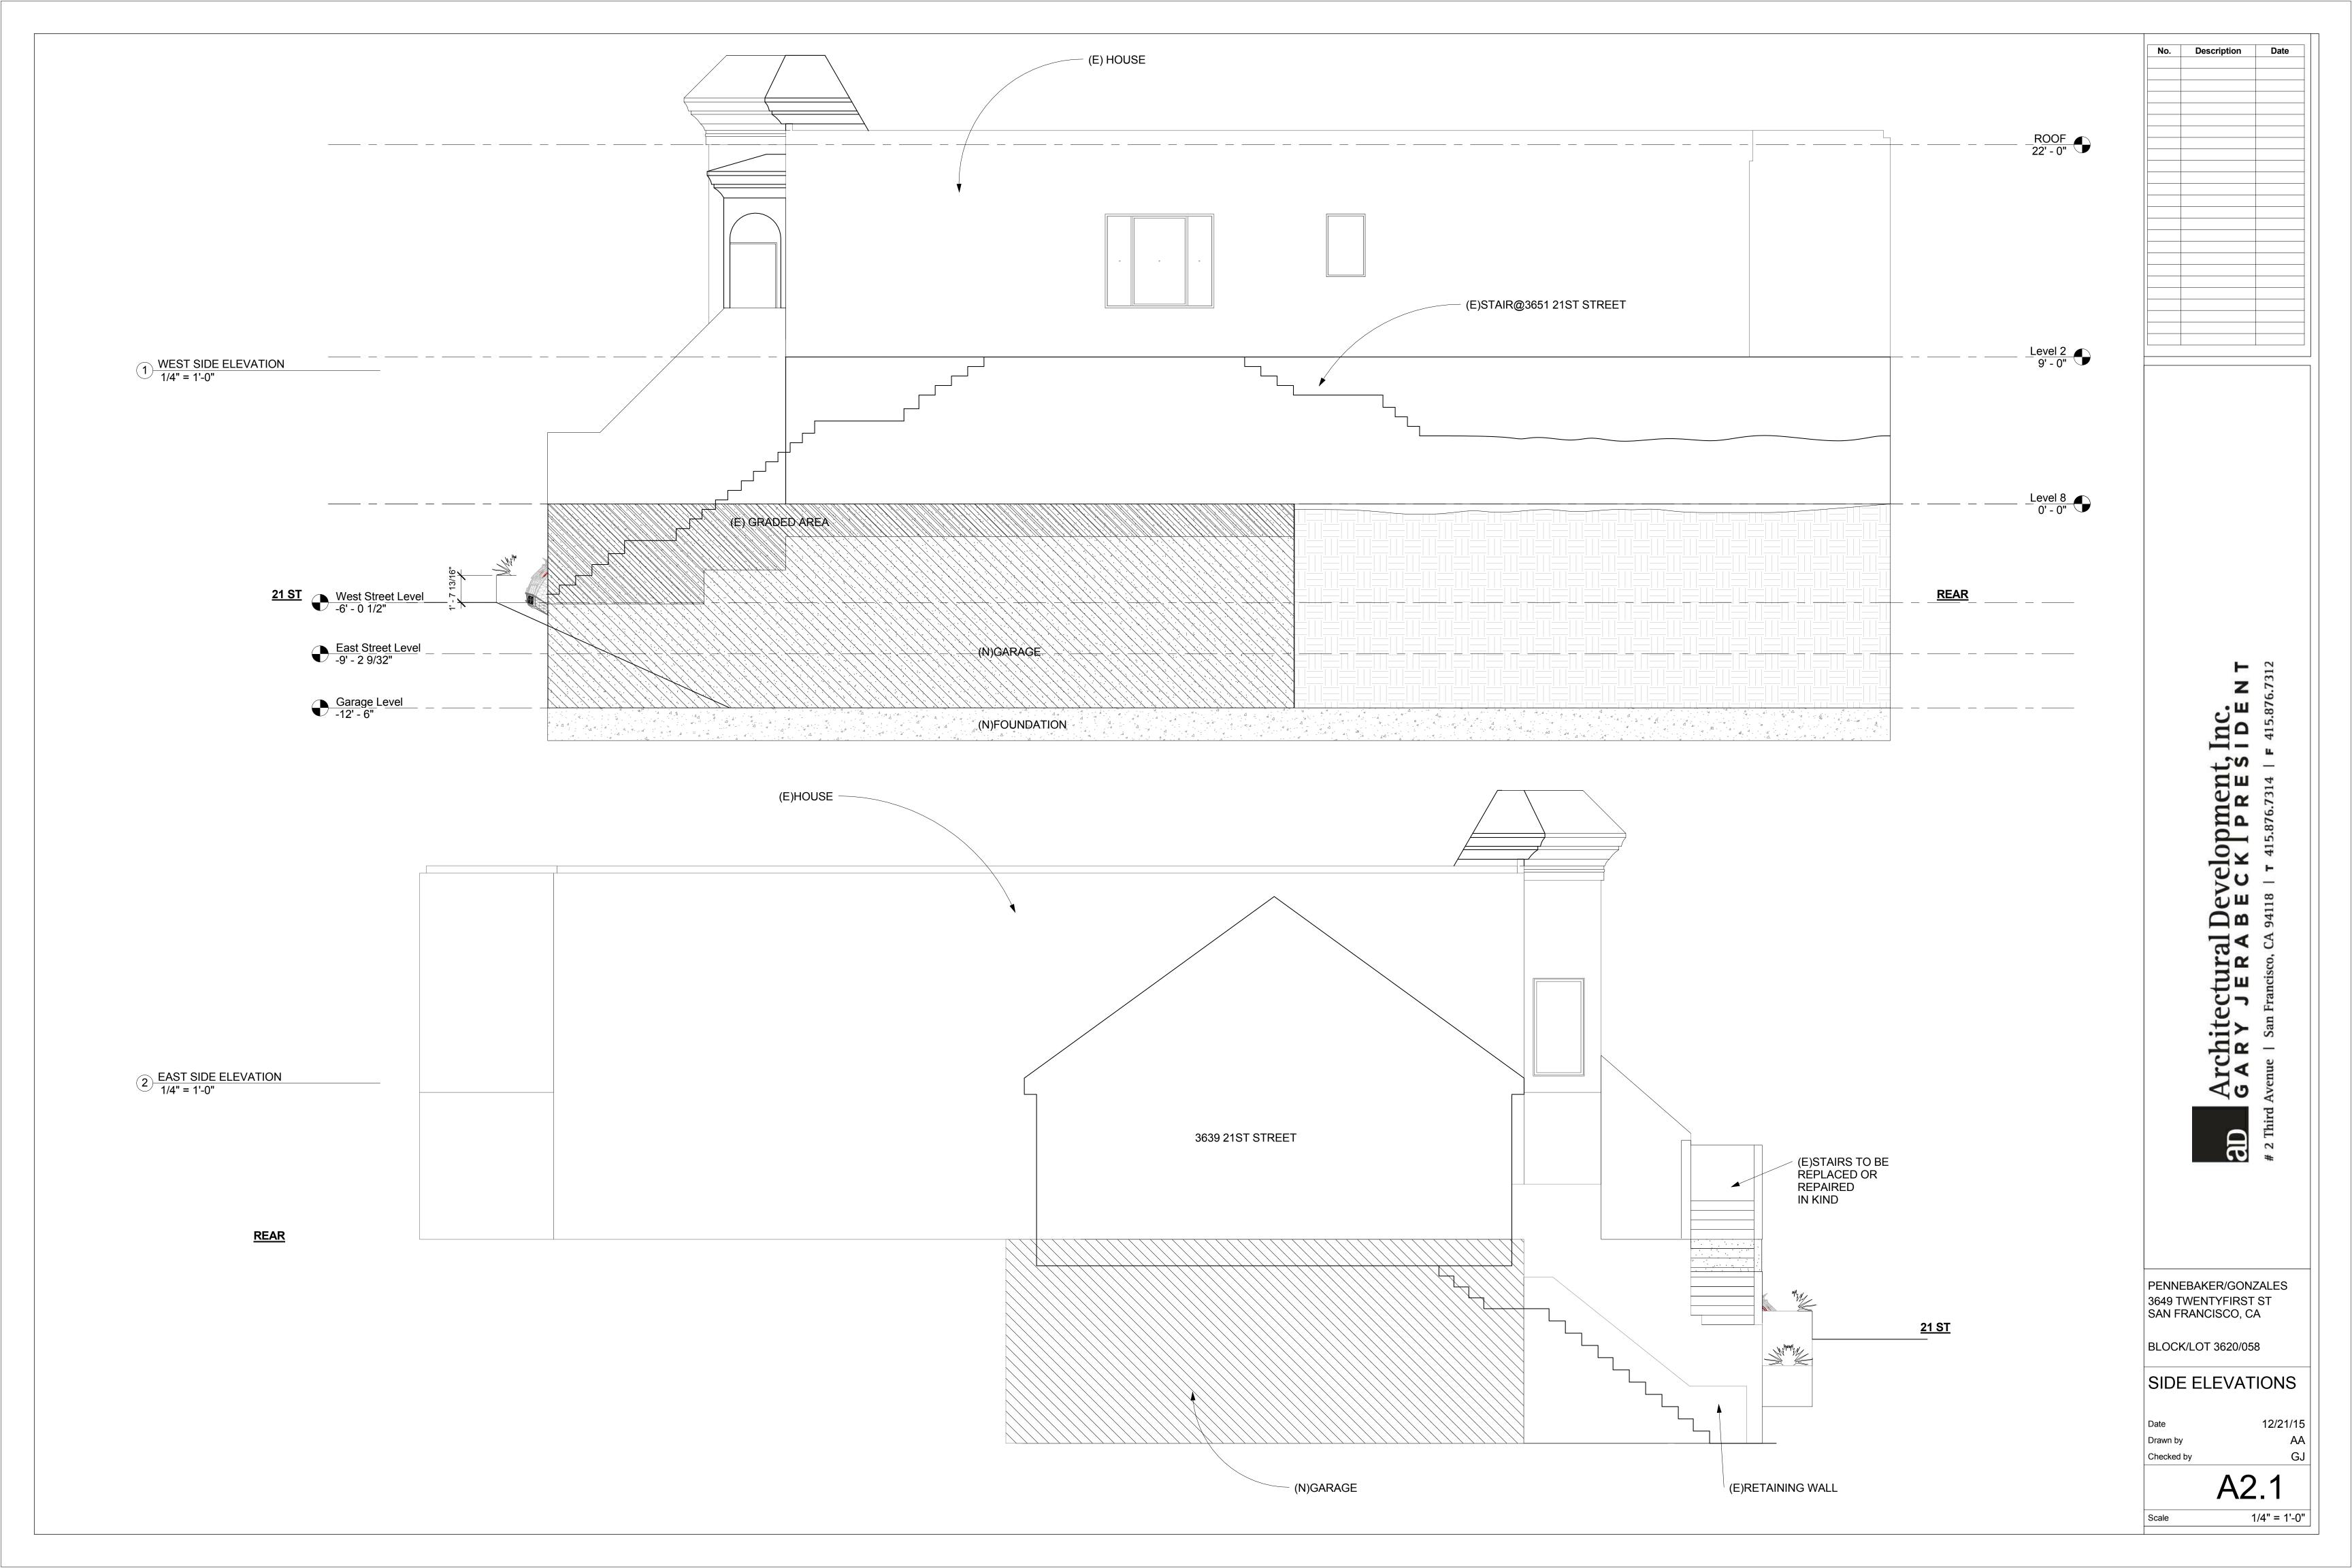


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12/21/15

1/4" = 1'-0"

A3.0



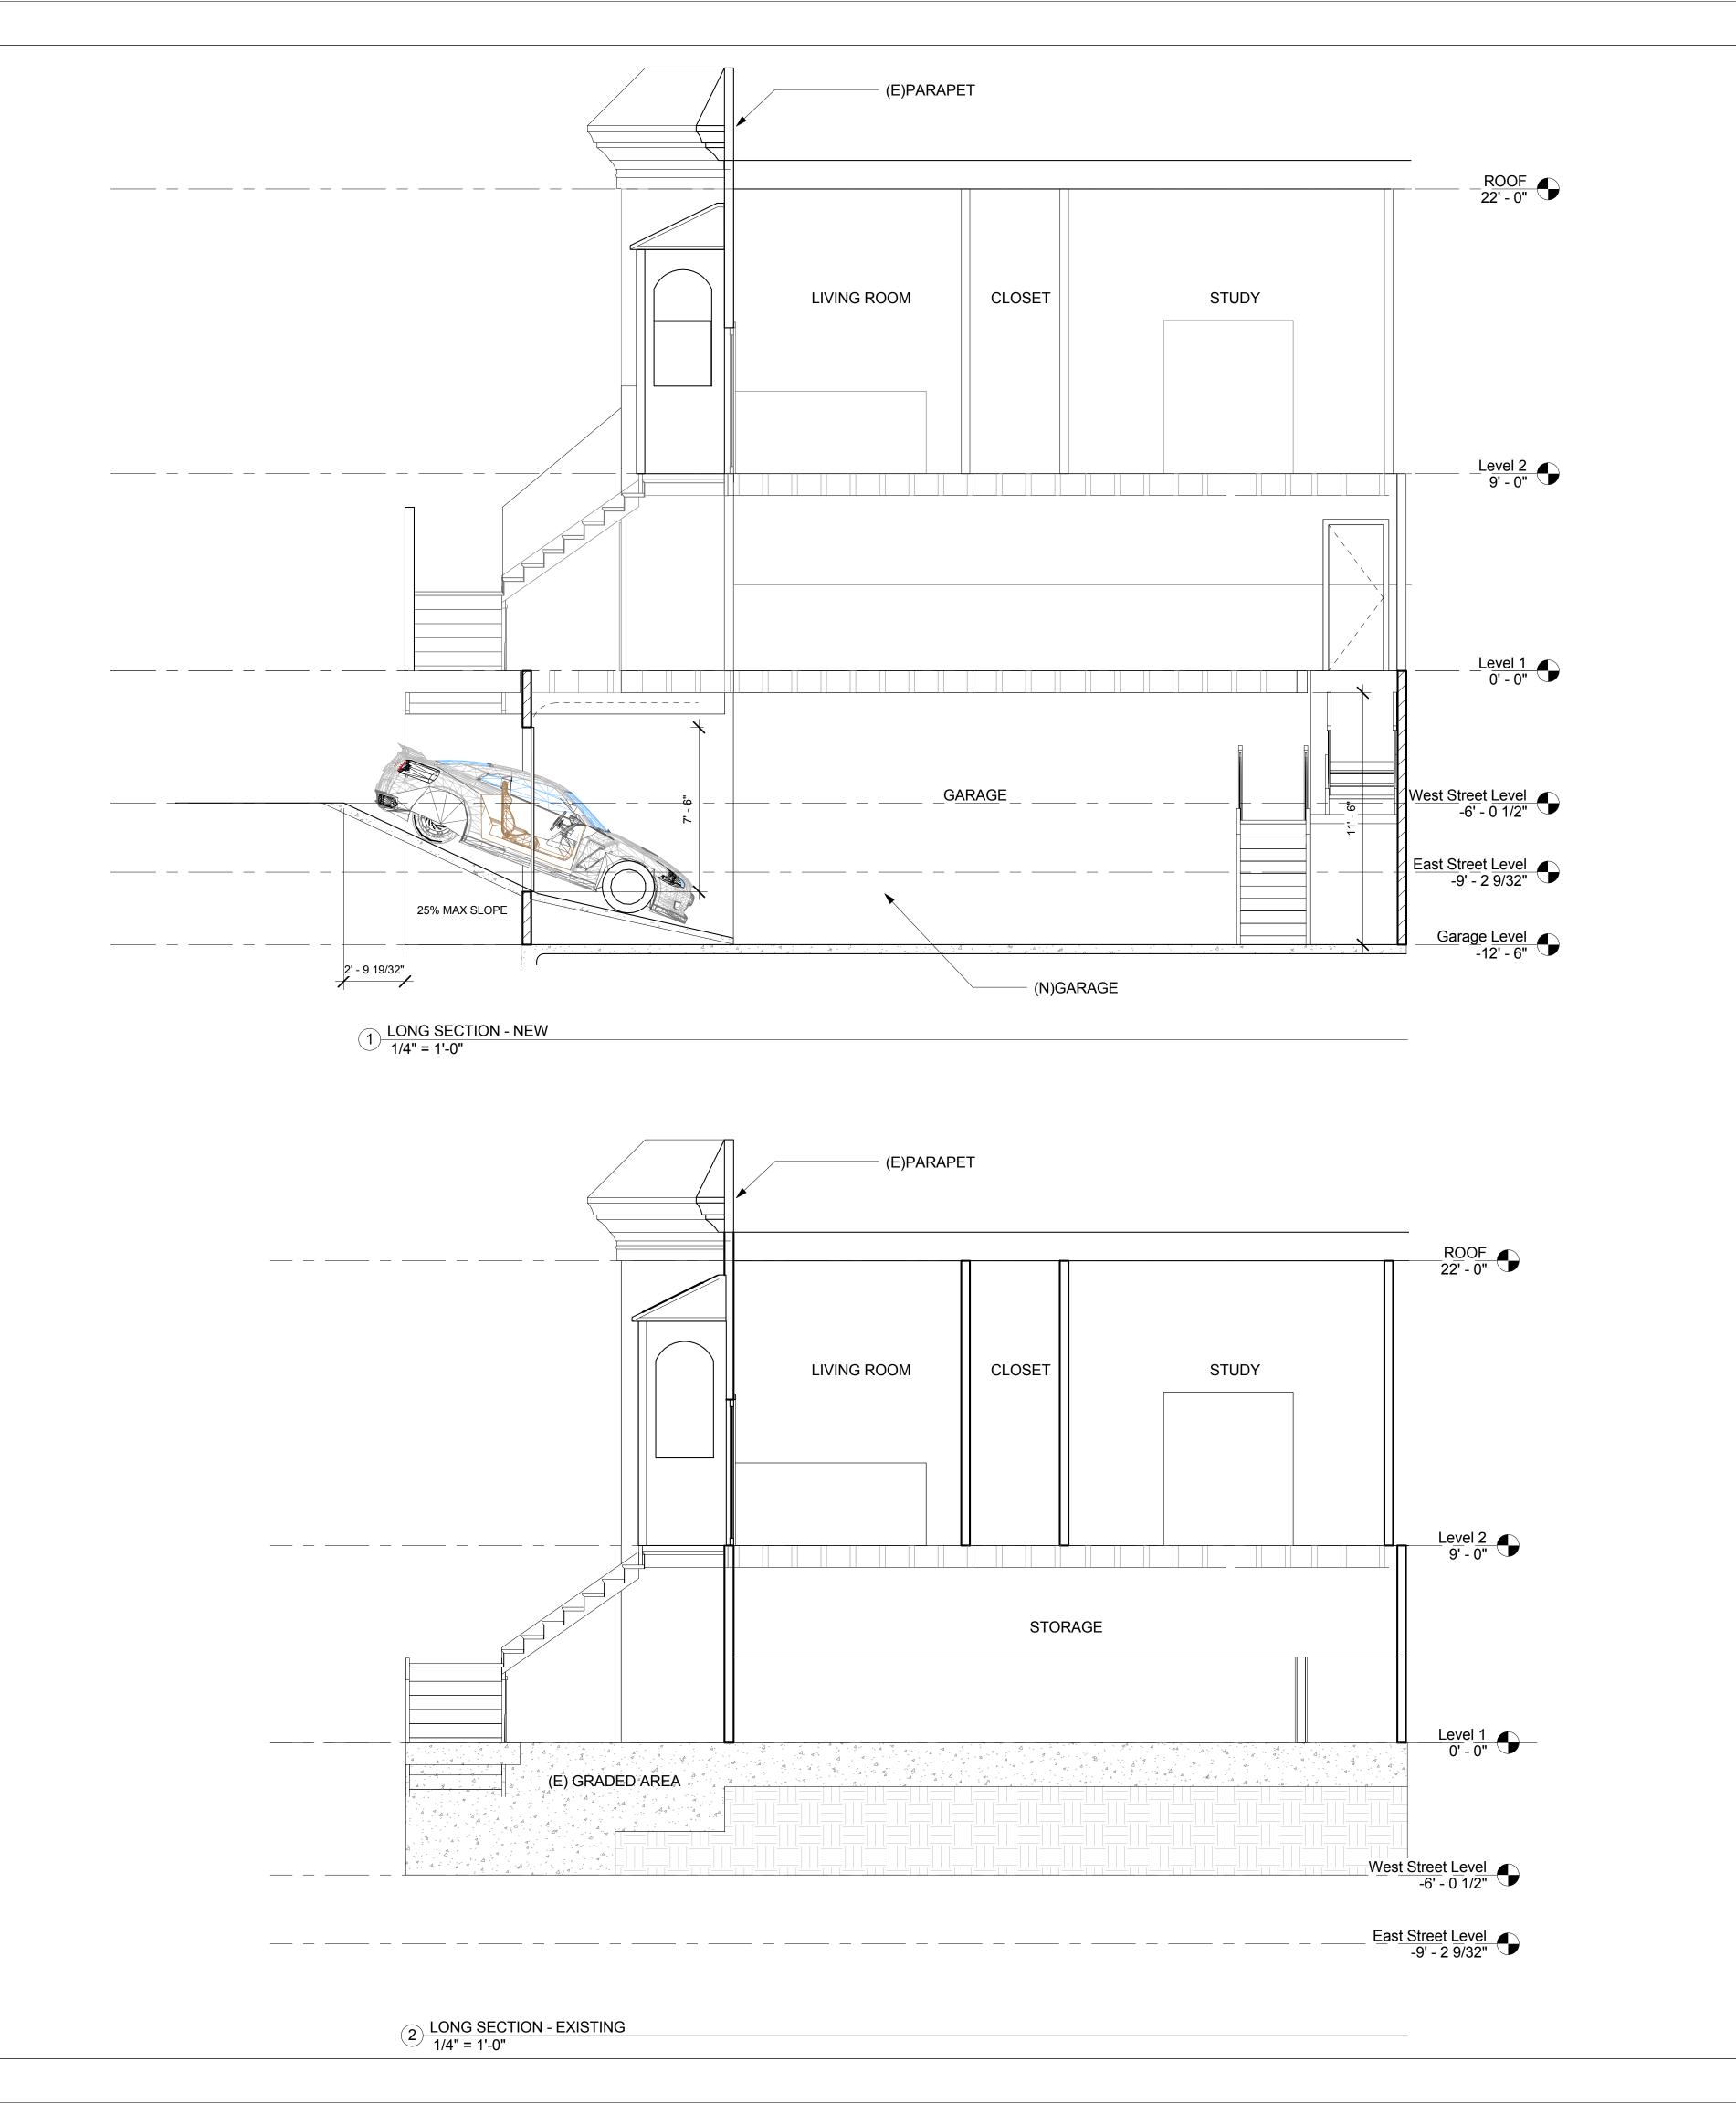

PENNEBAKER/GONZALES

12/21/15

1/4" = 1'-0"

3649 TWENTYFIRST ST SAN FRANCISCO, CA

BLOCK/LOT 3620/058

SECTIONS

Drawn by


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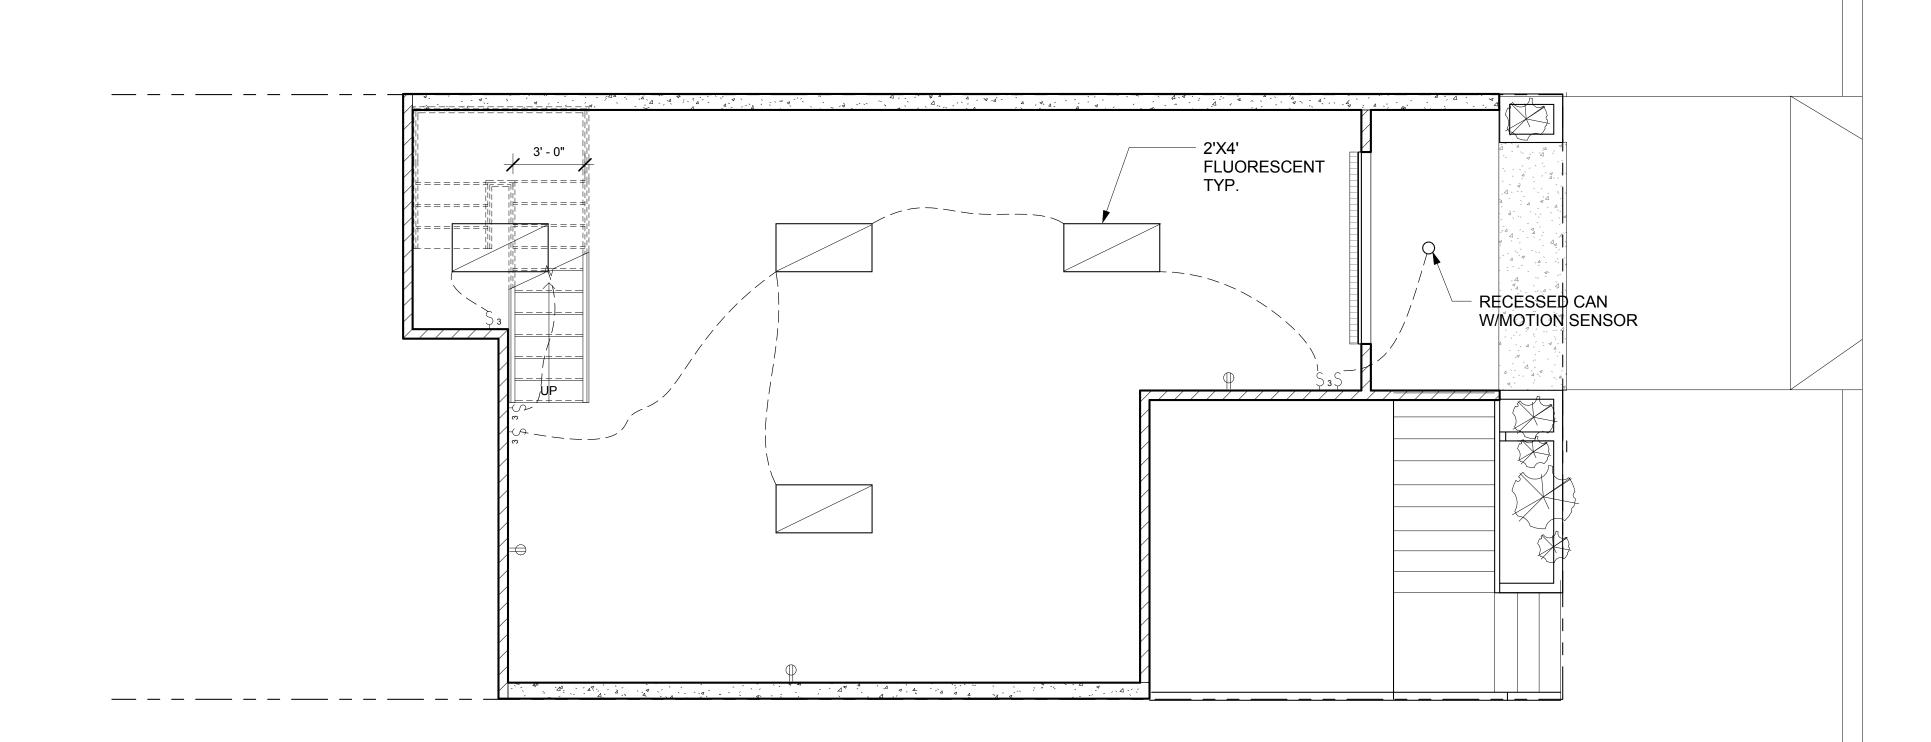
No. Description

ELECTRICAL NOTES

- 1. LIGHTING IN GARAGES SHALL EITHER BE HIGH EFFICACY OR SHALL BE CONTROLLED BY A OCCUPANT SENSOR.
- 2. OUTDOOR LIGHTS SHALL BE HIGH EFFICACY OR SHALL BE CONTROLLED BY A PHOTO CONTOL/MOTION SENSOR COMBINATION.
- 3. RECESSED LIGHTING INSTALLED IN INSULATED CEILINGS SHALL BE RATED FOR INSULATION CONTACT, ICAT-RATED AND LABELED AS AIRTIGHT TO THE STADARDS PRESCRIBED BY THE RESIDENTIAL ENERGY CODE.
- 4. PROVIDE AT LEAST ONE NON-DEDICATED GFCI OUTLET IN GARAGE





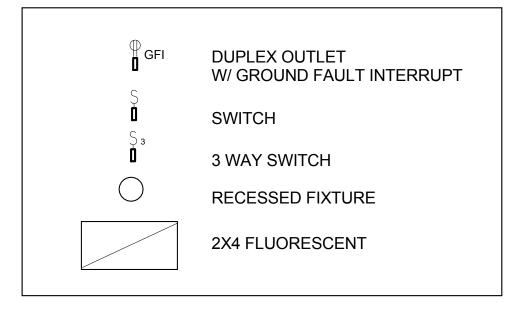

1 GARAGE LEVEL ELECTRICAL 1/4" = 1'-0"

PENNEBAKER/GONZALES 3649 TWENTYFIRST ST SAN FRANCISCO, CA

No. Description

BLOCK/LOT 3620/058

ELECTRICAL

Date
Drawn by
Checked by

A4.0

12/21/15

1/4" = 1'-0"

cale