MEMO

Disclaimer for Review of Plans

The San Francisco Planning Code requires that the plans of certain proposed projects be provided to members of the public prior to the City's approval action on the project. Accordingly, any images of plans featured on this website are provided for the primary purpose of facilitating public input prior to the City's action. The City and County of San Francisco does not own the copyright to these images. Please be aware that the unauthorized reproduction, distribution, or alteration of these images may result in a violation of Federal Copyright Law (17 U.S.C.A. Sections 101 et seq.) and that any party who seeks to reproduce or alter these images does so at his or her own risk.

Additionally, plans provided on this website are limited to site plans, elevations and/or section details (floor plans and structural details may not be included). These are DRAFT PLANS being provided for public review PRIOR to the City's approval action on the project. Final plans may differ from those that are currently available for review.

1650 Mission St. Suite 400 San Francisco, CA 94103-2479

Reception: 415.558.6378

Fax: 415.558.6409

Planning Information: 415.558.6377 NOTICE OF PUBLIC HEARING

Hearing Date: Wednesday, March 22, 2017

Time: **9:30 AM**

Location: City Hall, 1 Dr. Carlton B. Goodlett Place, Room 408

Case Type: Variance (Rear Yard)
Hearing Body: Zoning Administrator

PORPERT	TY INFORMATION	APPLICATION INFORMATION		
Project Address:	905 Geneva Avenue	Case No.:	2015-009578VAR	
Cross Street(s):	Mission Street	Building Permit:	2015.07.09.1102	
Block / Lot No.:	6410/010	Applicant/Agent:	Wilson Ng	
Zoning District(s):	NCD/65-A	Telephone:	415-684-0632	
Area Plan:	N/A	E-Mail:	Wilsonng2323@yahoo.com	

PROJECT DESCRIPTION

The proposal is to change the existing use on the second floor of a corner commercial building into four residential units.

Per Section 134 of the Planning Code, the subject property is required to maintain a rear yard of approximately 24 feet at the second story and above. The existing building is non-complying and extends into the required rear yard. The proposed conversion to residential use is an intensification of the non-complying structure; therefore, the project requires a rear yard variance.

ADDITIONAL INFORMATION

FOR MORE INFORMATION, PLEASE CONTACT PLANNING DEPARTMENT STAFF:

Planner: Todd Kennedy Telephone: 415-575-9125 Mail: Todd.Kennedy@sfgov.org

ARCHITECTURAL PLANS: The site plan and elevations of the proposed project are available on the Planning Department's website at: http://sf-planning.org/ftp/files/notice/2015-009578VAR.pdf

中文詢問請電:558.6378

Para información en Español llamar al: 558.6378

GENERAL INFORMATION ABOUT PROCEDURES

VARIANCE HEARING INFORMATION

Under Planning Code Section 306.3, you, as a property owner or resident within 300 feet of this proposed project or interested party on record with the Planning Department, are being notified of this Variance Hearing. You are not obligated to take any action. For more information regarding the proposed work, or to express concerns about the project, please contact the Applicant/Agent or Planner listed on this notice as soon as possible. Additionally, you may wish to discuss the project with your neighbors and neighborhood association or improvement club, as they may already be aware of the project.

Persons who are unable to attend the public hearing may submit written comments regarding this application to the Zoning Administrator, Planning Department, 1650 Mission Street, Suite 400, San Francisco, CA 94103, by 5:00pm the day prior to the hearing. These comments will be made a part of the official public record, and will be brought to the attention of the person or persons conducting the public meeting or hearing

BUILDING PERMIT APPLICATION INFORMATION

Under Planning Code Section 311/312, the Building Permit Application for this proposal is also subject to a 30-day notification to occupants and owners within 150-feet of the subject property. **The mailing of such notification will be perfromed separately.**

BOARD OF APPEALS

An appeal of the approval (or denial) of a **variance application** by the Zoning Administrator may be made to the **Board of Appeals within 10 days** after the **Variance Decision Letter** is issued by the Zoning Administrator.

An appeal of the approval (or denial) of a **building permit application** by the Planning Department may be made to the **Board of Appeals within 15 days** after the **building permit** is issued (or denied) by the Director of the Department of Building Inspection.

Appeals must be submitted in person at the **Board's office at 1650 Mission Street, 3rd Floor, Room 304**. For further information about appeals to the Board of Appeals, including current fees, **contact the Board of Appeals** at **(415) 575-6880**.


ABOUT THIS NOTICE

The Planning Department is currently reviewing its processes and procedures for public notification as part of the Universal Planning Notification (UPN) Project. The format of this Public Hearing notice was developed through the UPN Project and is currently being utilized in a limited trial-run for notification of Variance Hearings.

If you have any comments or questions related to the UPN Project or the format of this notice, please visit our website at http://upn.sfplanning.org for more information.

中文詢問請電:558.6378

Para información en Español llamar al: 558.6378

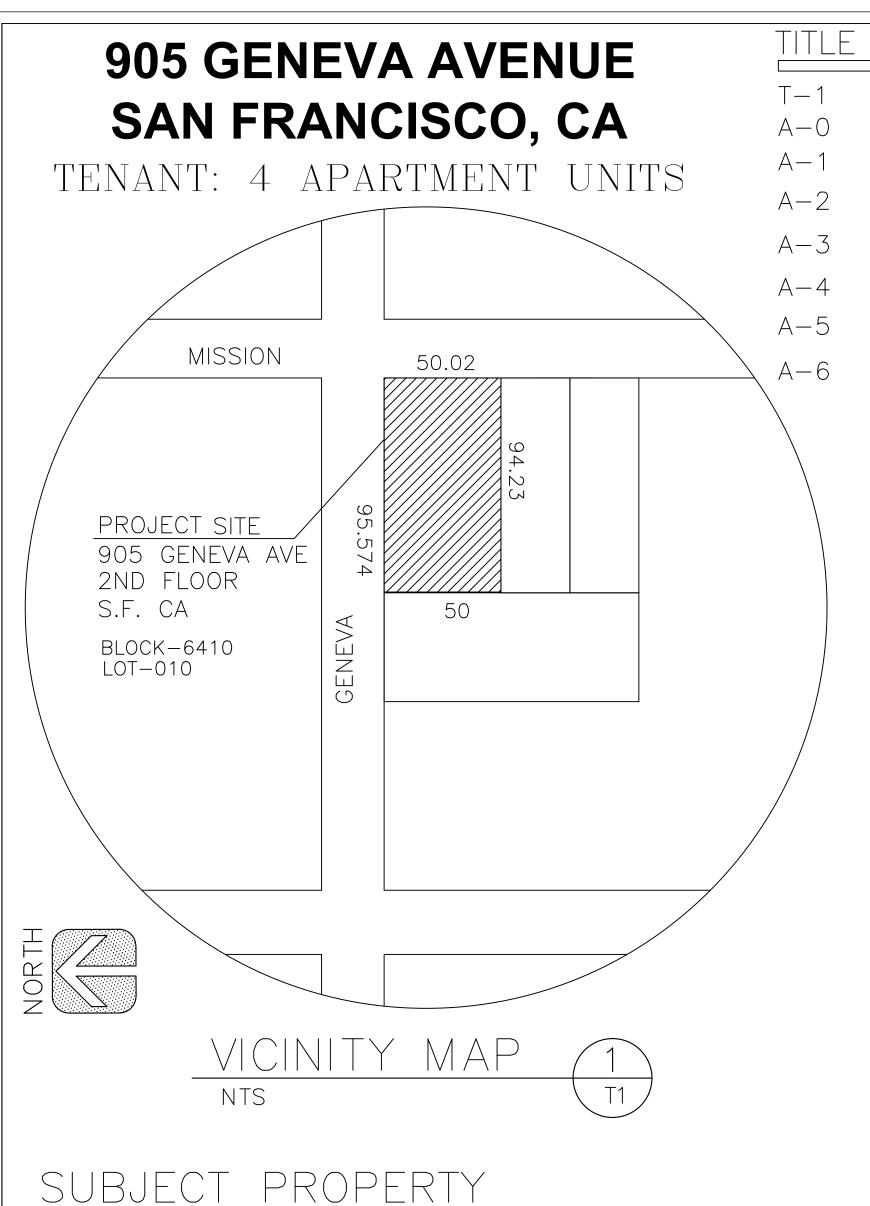

905 GENEVA AVE. SAN FRANCISCO, CA

BLOCK: 6410 LOT: 010

ZONE: NCD

HEIGHT LIMIT: (E) NO CHANGE

CONSTR. TYPE: VB OCCUPANCY: R-2OCCUP. LOAD: <49

BUILDING CODES: CBC 2013 EDITION

CPC 2013 EDITION

CMC 2013 EDITION

NEC 2013 EDITION

ALL APPLICABLE LOCAL AND STATE REGULATIONS

THIS PROJECT IS A DESIGN BUILT PROJECT. ALL WORK UNDER SEPARATE PERMITS: AS REQUIRED

*MECHANICAL/HVAC/VENTILATION

*PLUMBING *ELECTRICAL

*SPRINKLER SYSTEM/ALARM

TITLE SHEET

VICINITY MAP AND TITLE SHEET

ASSESSOR MAP

EXISTING ROOF/SITE PLAN

EXISTING GROUND FLOOR & SITE PLAN

EXISTING SECOND FLOOR PLAN

PHOTOS

PROPOSED SECOND FLOOR PLAN

EXISTING AND PROPOSED ROOF PLAN

SCOPE OF WORK

THE TENANT IMPROVEMENTS FOR CHANGE OF USE:

* FRAME FOR NEW PARTITION WALLS AND INSTALL NEW DOORS, BATHROOMS, KITCHENS, CLOSETS FOR 4 APARTMENT UNITS, BICYCLE/STORAGE ROOM & **COMMUNITY ROOM**

* FRAME FOR NEW ROOF STAIR WITH **ENCLOSED STAIRWELL TO ROOF.**

* CONSTRUCT NEW ROOF TOP DECK AND GARDEN AREA.

* BUILDING TO BE SPRINKLERED UNDER SEPARATE PERMITS.

EXISTING FRONT ELEVATIONS

BUILDING SECTIONS

INTERIOR WALL SECTION & DETAILS

A-10 WALL SECTIONS AND DETAILS

GENERAL AND ULTILITY NOTES

TOTAL 4 APT. UNITS: @ 2ND FLOOR

1 - ONE BEDROOM/BATH #3: 487 S/F

3 - TWO BEDROOM/BATH

#1: 645 S/F #4: 623 S/F

#2: 718 S/F

1 - COMMUNITY ROOM

140 S/F - BICYCLE PARKING & STORAGE RM

1 - TRASH ROOM

ABBRIVATIONS:

D = DIMMER SWITCH

T = TIMED LIGHT

(E) = EXISTING

(N) = NEW

3 = 3 WAY SWITCH

W/ BATTERY BACK UP

CARBON MONOXIDE = (c)

COMBINATION UNIT = (s)

F = FLUORESCENT LIGHT

M = MOTION SENSOR DETECTION

GFI = GFCI PROTECTED OUTLET

SMOKE DETECTOR (HARDWIRE)

GREEN BUILDING MEASURES NOTE:

THE GREEN BUILDING MEASURES TO BE TAKEN USING ENERGY EFFICIENT APPLIANCES (REFRIGERATOR, WASHER/DRYER) LOW WATTAGE LIGHT BULBS, TOILETS WITH SMALL AMOUNTS OF WATER PER FLUSH. NEWLY ENGINEERED INSULATION WILL BE USED TO MINIMIZE THE TREMBLING SOUND OF AIRPLANES. THIS INSULATION WILL ALSO KEEP THE HOME OF COMFORTABLE TEMPERATURES TO AVOID HAVING TO USE ELECTRICITY FOR HEATING/WARMING PURPOSES. THE WOOD BEING USED FOR THE ADDITION WILL COME FROM OLD PROJECTS PROVIDED BY MY CONTRACTOR TO DECREASE THE PURCHASE OF NEWLY CUT LUMBER.

LEGEND SYMBOL TYP.

EXISTING WALL

NEW WALL- ONE HR. RATED 2X4 STUD @ 16" O.C. WITH 5/8" SHEETROCK

WALL TO BE REMOVED

LIGHT FIXTURE

RECESSED CANISTER LIGHT (LOW VOLTAGE)

DUPLEX OUTLET

220-240V OUTLET

LIGHT SWITCH EXHAUST FAN

(LIGHT COMBINATION) SPRINKLER HEAD

EMERGENCY LIGHTS

ILLUMINATED EXIT SICN W/ EMERCENCY LICIITS

W/ BATTERY BACKUP

FIRE EXTINGUISHER- CLASS K

ULITILITY LEGEND



T1 ,

ARCHITECTURE

- 1. Contractor shall verify location of building on site. Notify Architect at time of staking of there are any discrepancy or inconsistencies found.
- 2. Subcontractors to submit delivery schedules as a part of their bid submittal.
- All warranties due to Owner shall be forwarded in triplicate form to General Contractor upon completion of the job with no exception. Failure to comply with will result in delay in payment to subcontractor.
- 4. Changes in design or materials will NOT be accepted without written authorization from Architect.
- 5. General Contractor shall (2) sets submit as—built drawings to Architect upon completion. (1 set of blue prints and 1 set of sepia)
- 6. All glazing shall conform to federal glazing regulations and chapter 24, 2010 California Building Code.

PLUMBING

Contractor's work shall include all pipe, valves, fittings, reducers, stops, saddles, etc. required for complete operable sanitary, water and storm drainage.

ELECTRICAL

- Electrical conduits and transformer pad shall be per CITY standards.
- Electrical contractor shall install "UNDER GROUND" at electrical service entrance to building per City details.
- Site fixture shall be wired in approved conduit to electrical house panel.
- City shall supply and install gas meters & gas lines. All fees shall be paid by Owner.

GENERAL NOTE

1. ALL WORK SHALL COMPLY WITH LASTEST APPLICABLE CODES AND TRADE STANDARDS WHICH GOVERN EACH PHASE OF WORK, INCLUDING BUT NOT LIMITED TO:

> 2013 CALIFORNIA BUILDING CODE 2013 CALIFORNIA MECHANICAL CODE 2013 CALIFORNIA PLUMBING CODE 2013 CALIFORNIA ELECTRICAL CODE

- 2013 CALIFORNIA TITLE 24 ALL WORK SHALL COMPLY WITH LOCAL ORDINANCES AND STATE LAWS.
- 3. ALL CONSTRUCTION SHALL CONFORM TO CURRENT TITLE 24, CALIFORNIA ADMINISTRATIVE CODE ACCESSIBILITY REQUIREMENTS.
- 4. ALL PUBLIC IMPROVEMENTS SHALL BE MADE IN ACCORDANCE WITH THE LATEST ADOPTED CITY STANDARDS.
- 5. ALL MECHANICAL, PLUMBING, AND ELECTRICAL EQUIPMENT SHALL BE ANCHORED AND SEISMICALLY
- 6. DIMENSIONS ON WORKING DRAWINGS GOVERN. DO NO SCALE DRAWINGS.
- 7. ALL TYPICAL DETAILS SHALL APPLY UNLESS NOTED OTHERWISE. THE DETAILS REFLECT THE DESIGN INTENT FOR TYPICAL CONDITIONS. THE CONTRACTOR SHALL VERIFY ALL FIELD CONDITIONS AND SHALL INCLUDE, IN HIS SCOPE, THE COST FOR COMPLETE FINISHED INSTALLATION, INCLUDING ANOMOLIES, OF ALL
- 8. ALL CONTRACTORS SHALL THOROUGHLY REVIEW CONTRACT DOCUMENTS AND SITE CONDITIONS PRIOR TO PROCEEDING WITH WORK. PRIOR TO BIDDING, CONTRACTOR SHALL NOTIFY THE OWNER AND ARCHITECT OF ANY CONDITIONS WHICH ARE NOT COVERED IN THE CONTRACT DOCUMENTS. DURING CONSTRUCTION, CONTRACTORS SHALL NOTIFY THE OWNER AND SEEK CLARIFICATION IF ANY DISCREPANCIES ARE FOUND. CONTRACTORS SHALL BE RESPONSIBLE FOR REMEDIAL WORK IF RELATED WORK IS AFTER A DESCREPANCY IS INDENTIFIED.
- 9. CONTRACTOR SHALL BE RESPONSIBLE FOR VERIFYING THAT MATERIALS, LABOR, INSTALLATION, ETC., CONFORMS TO THE CODES AND REQUIREMENTS OF LOCAL GOVERNING AGENCIES.
- 10. NO WORK SHALL COMMENCE WITH UNAPPROVED MATERIALS. ANY WORK DONE WITH UNAPPROVED MATERIALS AND EQUIPMENT IS AT THE CONTRACTOR'S RISK.
- 11. CONSTRUCTION MATERIALS STORED ON THE SITE SHALL BE PROPERLY STACKED AND PROTECTED SO AS TO PREVENT DAMAGE OR DETERIATION UNTIL USED. FAILURE IN THIS REGARD MAY BE CAUSE FOR REJECTION OF MATERIAL AND/OR WORK.
- 12. FINISHED AND CONSTRUCTION SHALL BE PROTECTED BY THE CONTRACTOR FROM POTENTIAL DAMAGE CAUSED BY CONSTRUCTION ACTIVITY. DAMAGE TO FINISHES OR CONSTRUCTION CAUSED IN THIS MANNER SHALL BE REPAIRED OR REPLACED (OWNER'S & ARCHITECT'S DECISION) BY CONTRACTOR WITH IDENTICAL MATERIAL AND/OR FINISHES.
- 13. ALL CONTRACTORS SHALL REMOVE TRASH AND DEBRIS RESULTING FROM THEIR WORK ON A DAILY BASIS. PROJECT SITE SHALL BE MAINTAINED IN A CLEAN AND ORDERLY CONDITION.
- 14. IN ADDITION TO THOSE SHOWN ON DRAWINGS, PROVIDE AND LOCATE ACCESS DOORS OR PANELS IN CEILING AND WALL CONSTRUCTION AS REQUIRED FOR MECHANICAL, PLUMBING, AND ELECTRICAL WORK.
- 15. PROIVDE BACKING FOR ALL EQUIPMENT AND ACCESSORIES.
- 16. CONTRACTOR TO FIELD VERIFY "AS-BUILT" CONDITIONS AND NOTIFY THE ARCHITECT IF THEY VARY SUBSTANTIALLY FROM THOSE SHOWN.

FIRE PROTECTION NOTES:

- 1. ALL PORTION OF THE BUILDING SHALL BE WITHIN 75 FEET OF A FIRE EXTINGUISER. THE MIN. SIZE OF THE EXTINGUISER SHALL BE 2-A: 10-BC
- PROVIDE A CLASS K FIRE EXTINGUISER IN THE KITCHEN AREA IF OPEN FLAME EQUIPMENT PRESENT.
- 3. FIRE SUPPRESSION SYSTEM UNDER KITCHEN HOOD SHALL BE UNDER SEPERATE PERMIT SUBMITTAL

OPMENT VEL DE

REVISIONS:

RE


WALL SECTIONS & DETAILS

DATE: 7/6/15 scale: AS SHOWN DRAWN BY: W.J.N

SHEET NO.

SHEETS

T-1

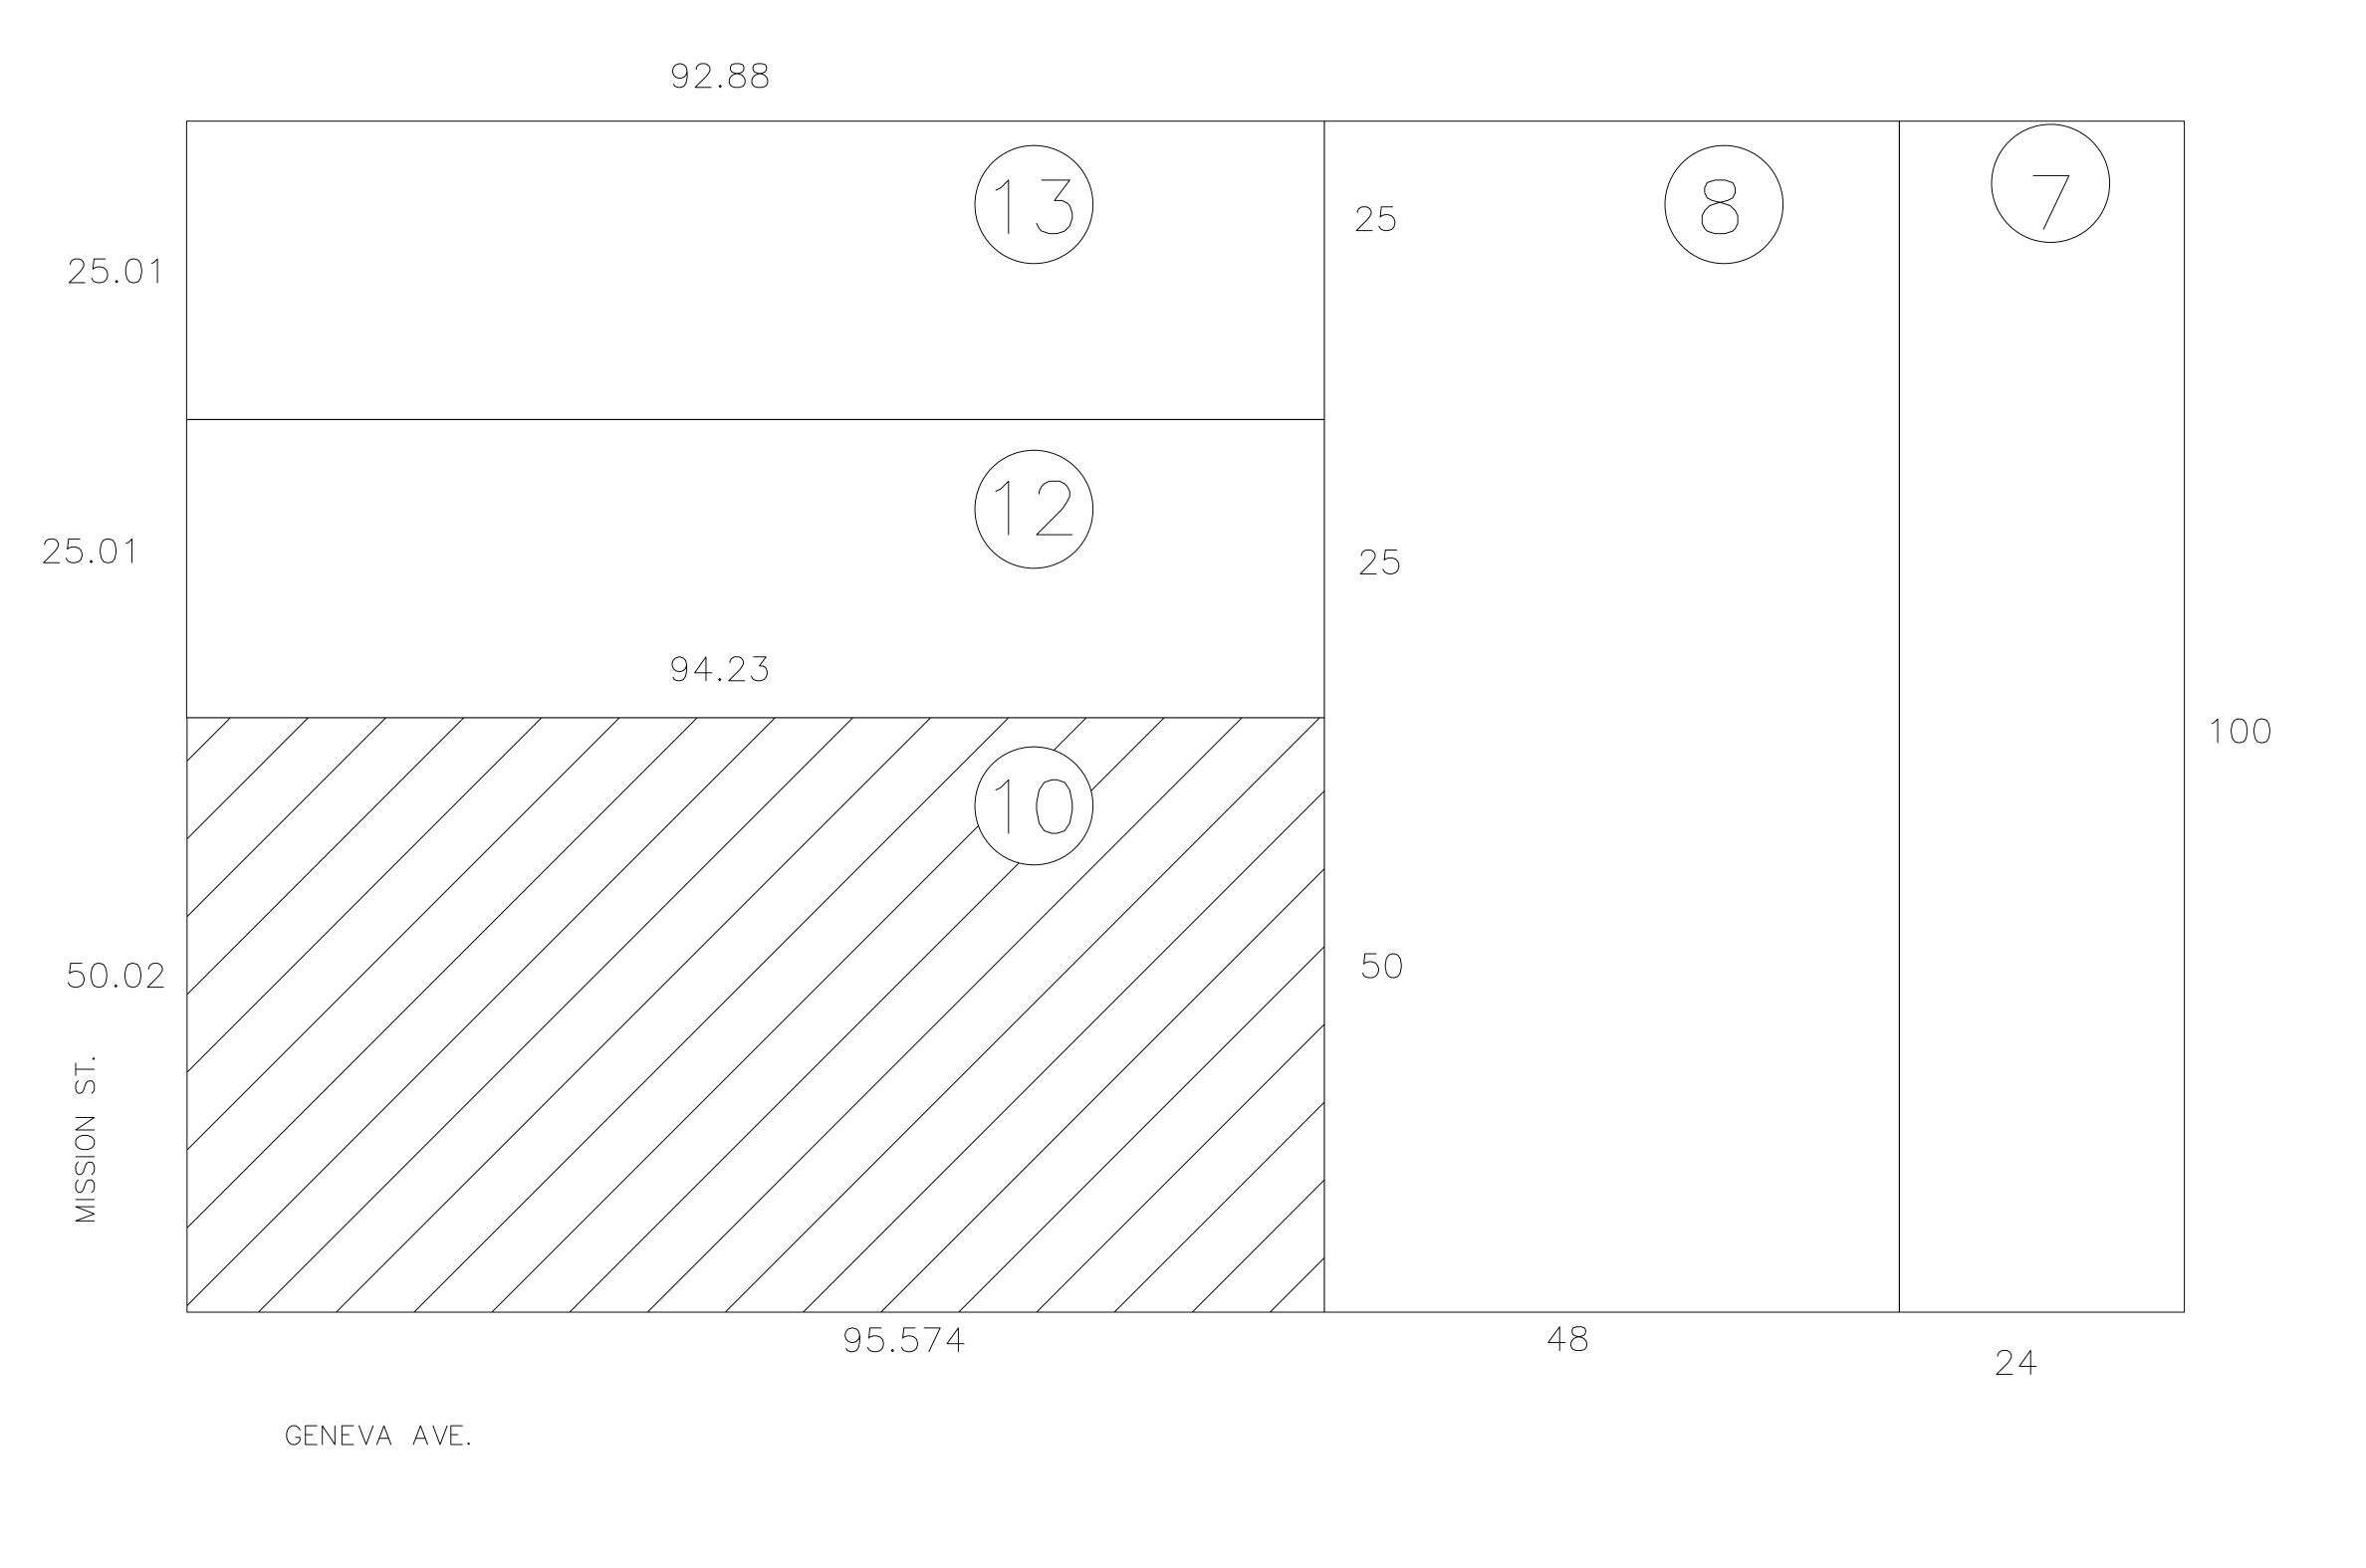


SUBJECT PROPERTY
905 GENEVA AVE.
SAN FRANCISCO, CA
BLOCK: 6410 LOT: 010


ZONE: NCD

HEIGHT LIMIT: EXIST. NO CHANGE


CONSTR. TYPE: VB OCCUPANCY: R-2




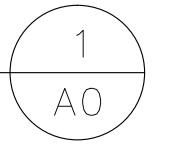

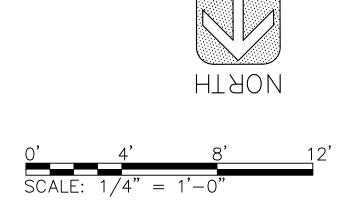

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		CHANGE OF USE	COMMEDCIAL TO PECIDENCE		905 GENEVA AVE.	SAN FRANCISCO, CA
	S	ITE	. PI	_A	1	
	SC	ALE:	6/3 A BY: W	S SI		/N
	SH	HEET	N□.			
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DEMOLITION NOTES:

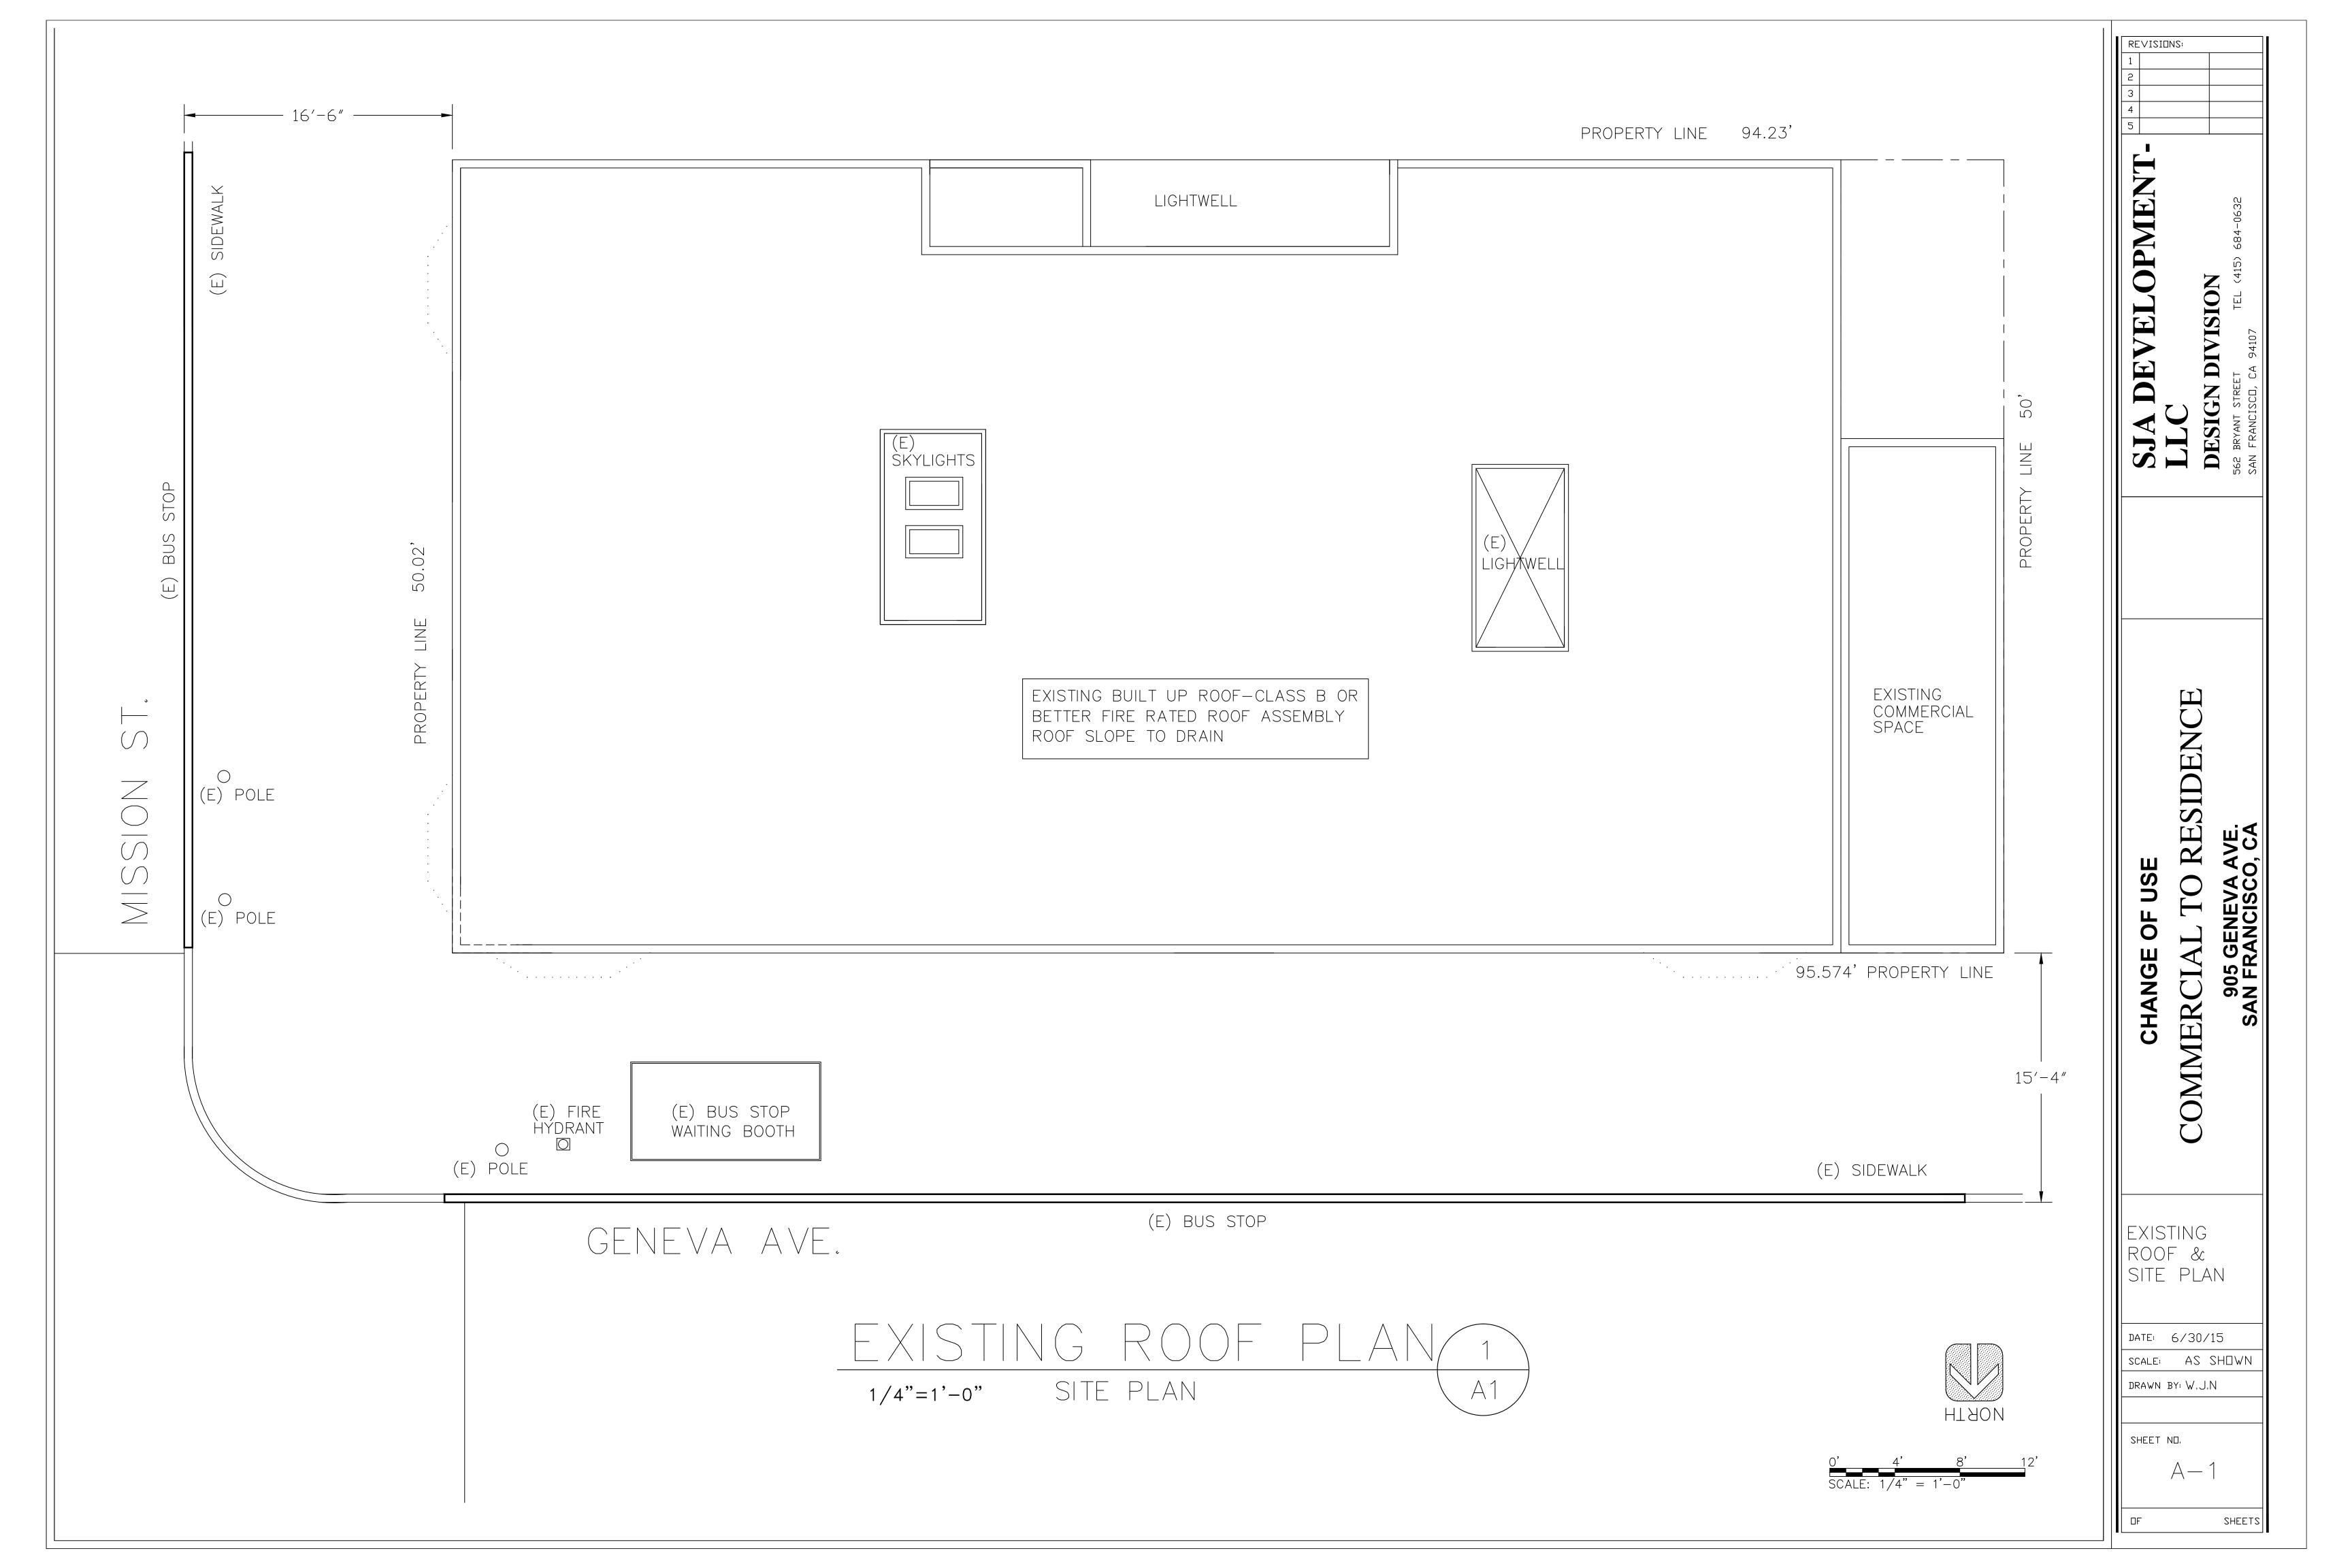- 1. COMPLETE ALL DEMOLITION WORK INDICATED OR NECESSARY FOR COMPLETION FO THE NEW WORK INCLUDING LABOR, SUPERVISION, TOOLS, MATERIALS, PERMITS, ETC. REQUIRED FOR REMOVAL OF FLOORS, WALLS CEILINGS, FIXTURES, DUCTWORK, , ETC.
- 2. PROVIDE PROTECTIVE DEVICES TO INSURE THE SAFE PASSAGE OF PERSONS AROUND THE DEMOLITION AREA. CONDUCT OPERATIONS TO PREVENT DAMAGE BY FALLING DEBRIS TO ADJACENT BUILDING, TREES, STRUCTURES, PERSONS, ETC. PROVIDE INTERIOR & EXTERIOR SHORING, BRACING, ETC. TO PREVENT MOVEMENT, SETTLEMENT OR COLLAPSE OF STRUCTURES TO BE DEMOLISHED AND FACILITIES TO REMAIN.
- 3. SHUT OFF AND/OR DISCONNECT UTILITIES SERVICING THE PROJECT AS AS REQUIRED BY WORK. IF POSSIBLE, REMOVE UTILITY LINES BACK TO MAIN SWITCHES, SHUT—OFF VALVES OR METERS. PROVIDE TEMPORARY POWER OUTLETS, LIGHTS (AS REQUIRED), HOSE BIBB WITH WATER TO ALLOW FOR DEMOLITION WORK.

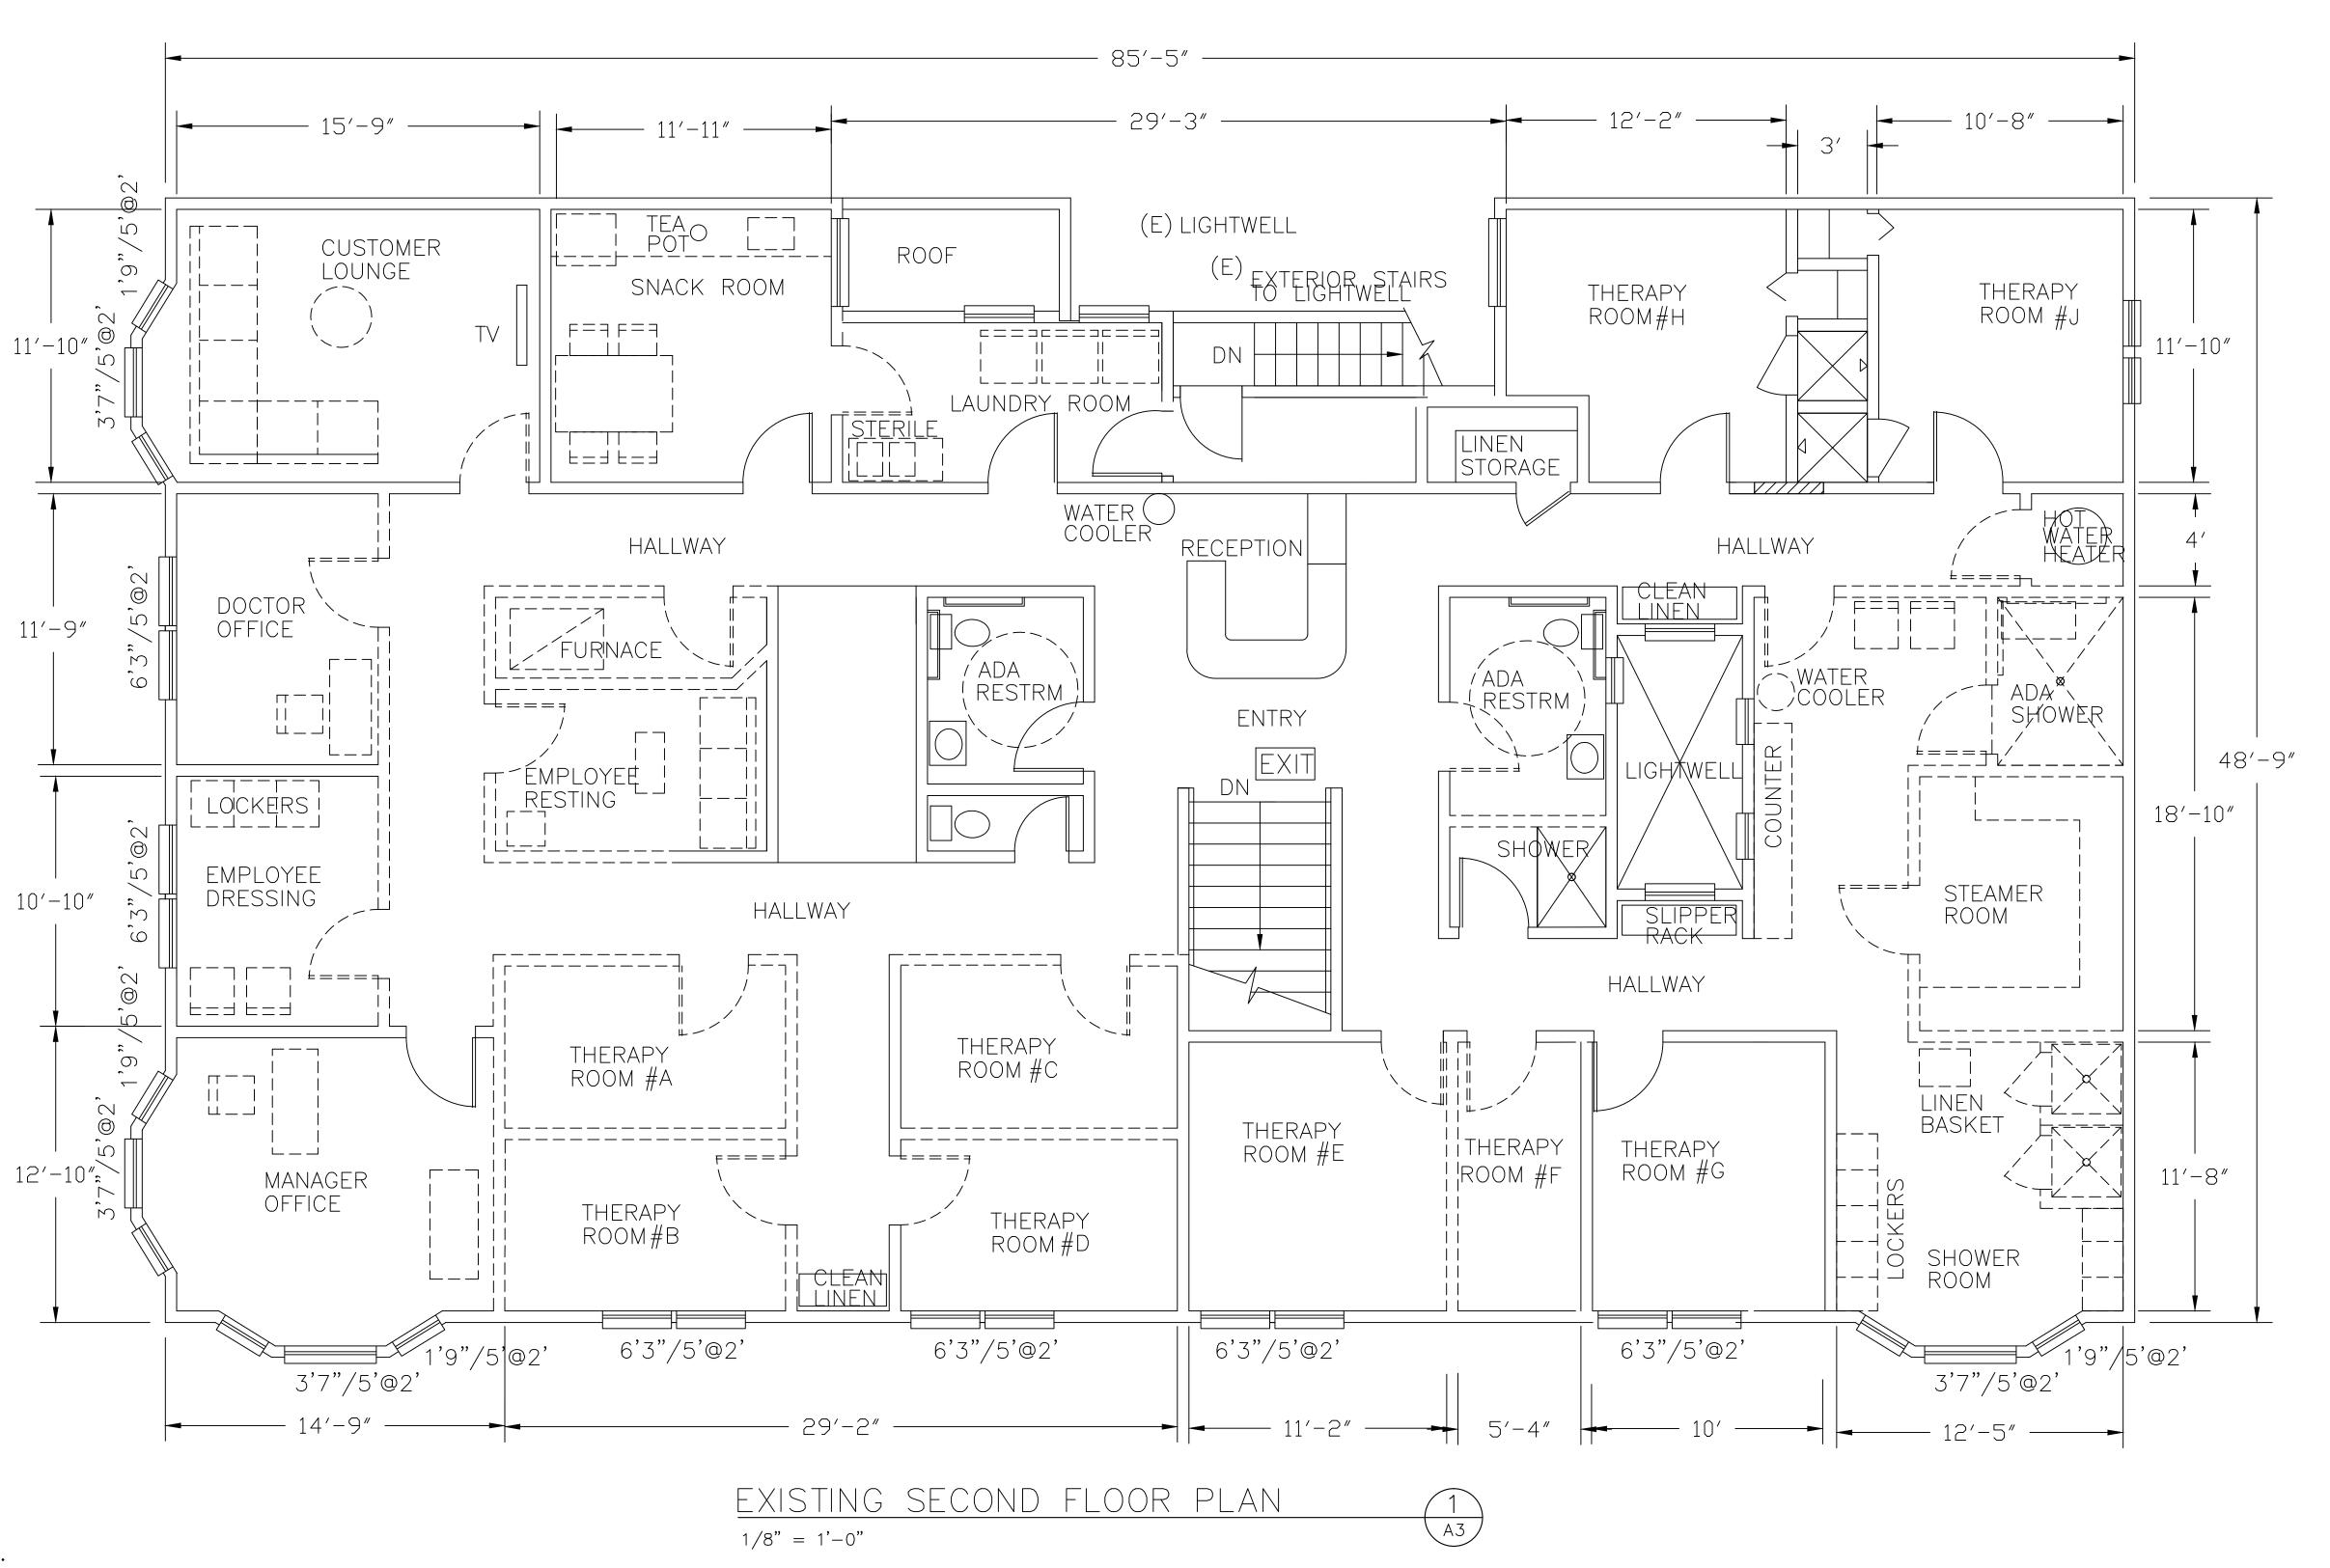
LEGEND SYMBOL TYP.

EXISTING WALL

NEW WALL- ONE HR. RATED 2X4 STUD @ 16" O.C. WITH 5/8" SHEETROCK

WALL TO BE REMOVED



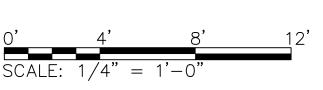

COMME

SIDENCE

REVISIONS:

VELOPMENT

EXISTING 2ND FLOOR PLAN

DATE: 6/30/15

SCALE: AS SHOWN

DRAWN BY: W.J.N

SHEET NO.

A-3




PROPERTY OPPOSITE CORNER




SUBJECT PROPERTY



SUBJECT PROPERTY

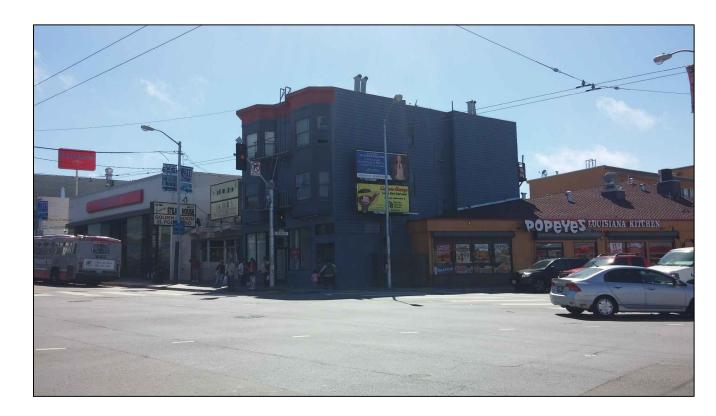

PROPERTY OPPOSITE CORNER

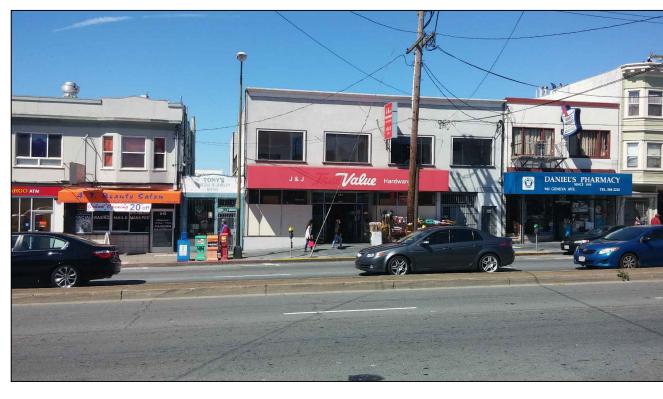

SUBJECT PROPERTY WITH ADJACENT BLDG.



SUBJECT PROPERTY WITH ADJACENT BLDG.




PROPERTY OPPOSITE SIDE



SUBJECT PROPERTY WITH ADJACENT BLDG.



SUBJECT PROPERTY

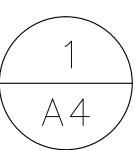

REVISIONS: 1 RES.5.14.9132 10/31/14 2 RES.5.14.9132 12/30/14


COMMERCIA


PHOTOS

DATE: 6/30/15 SCALE: AS SHOWN DRAWN BY: W.J.N

SHEET NO.

A-4

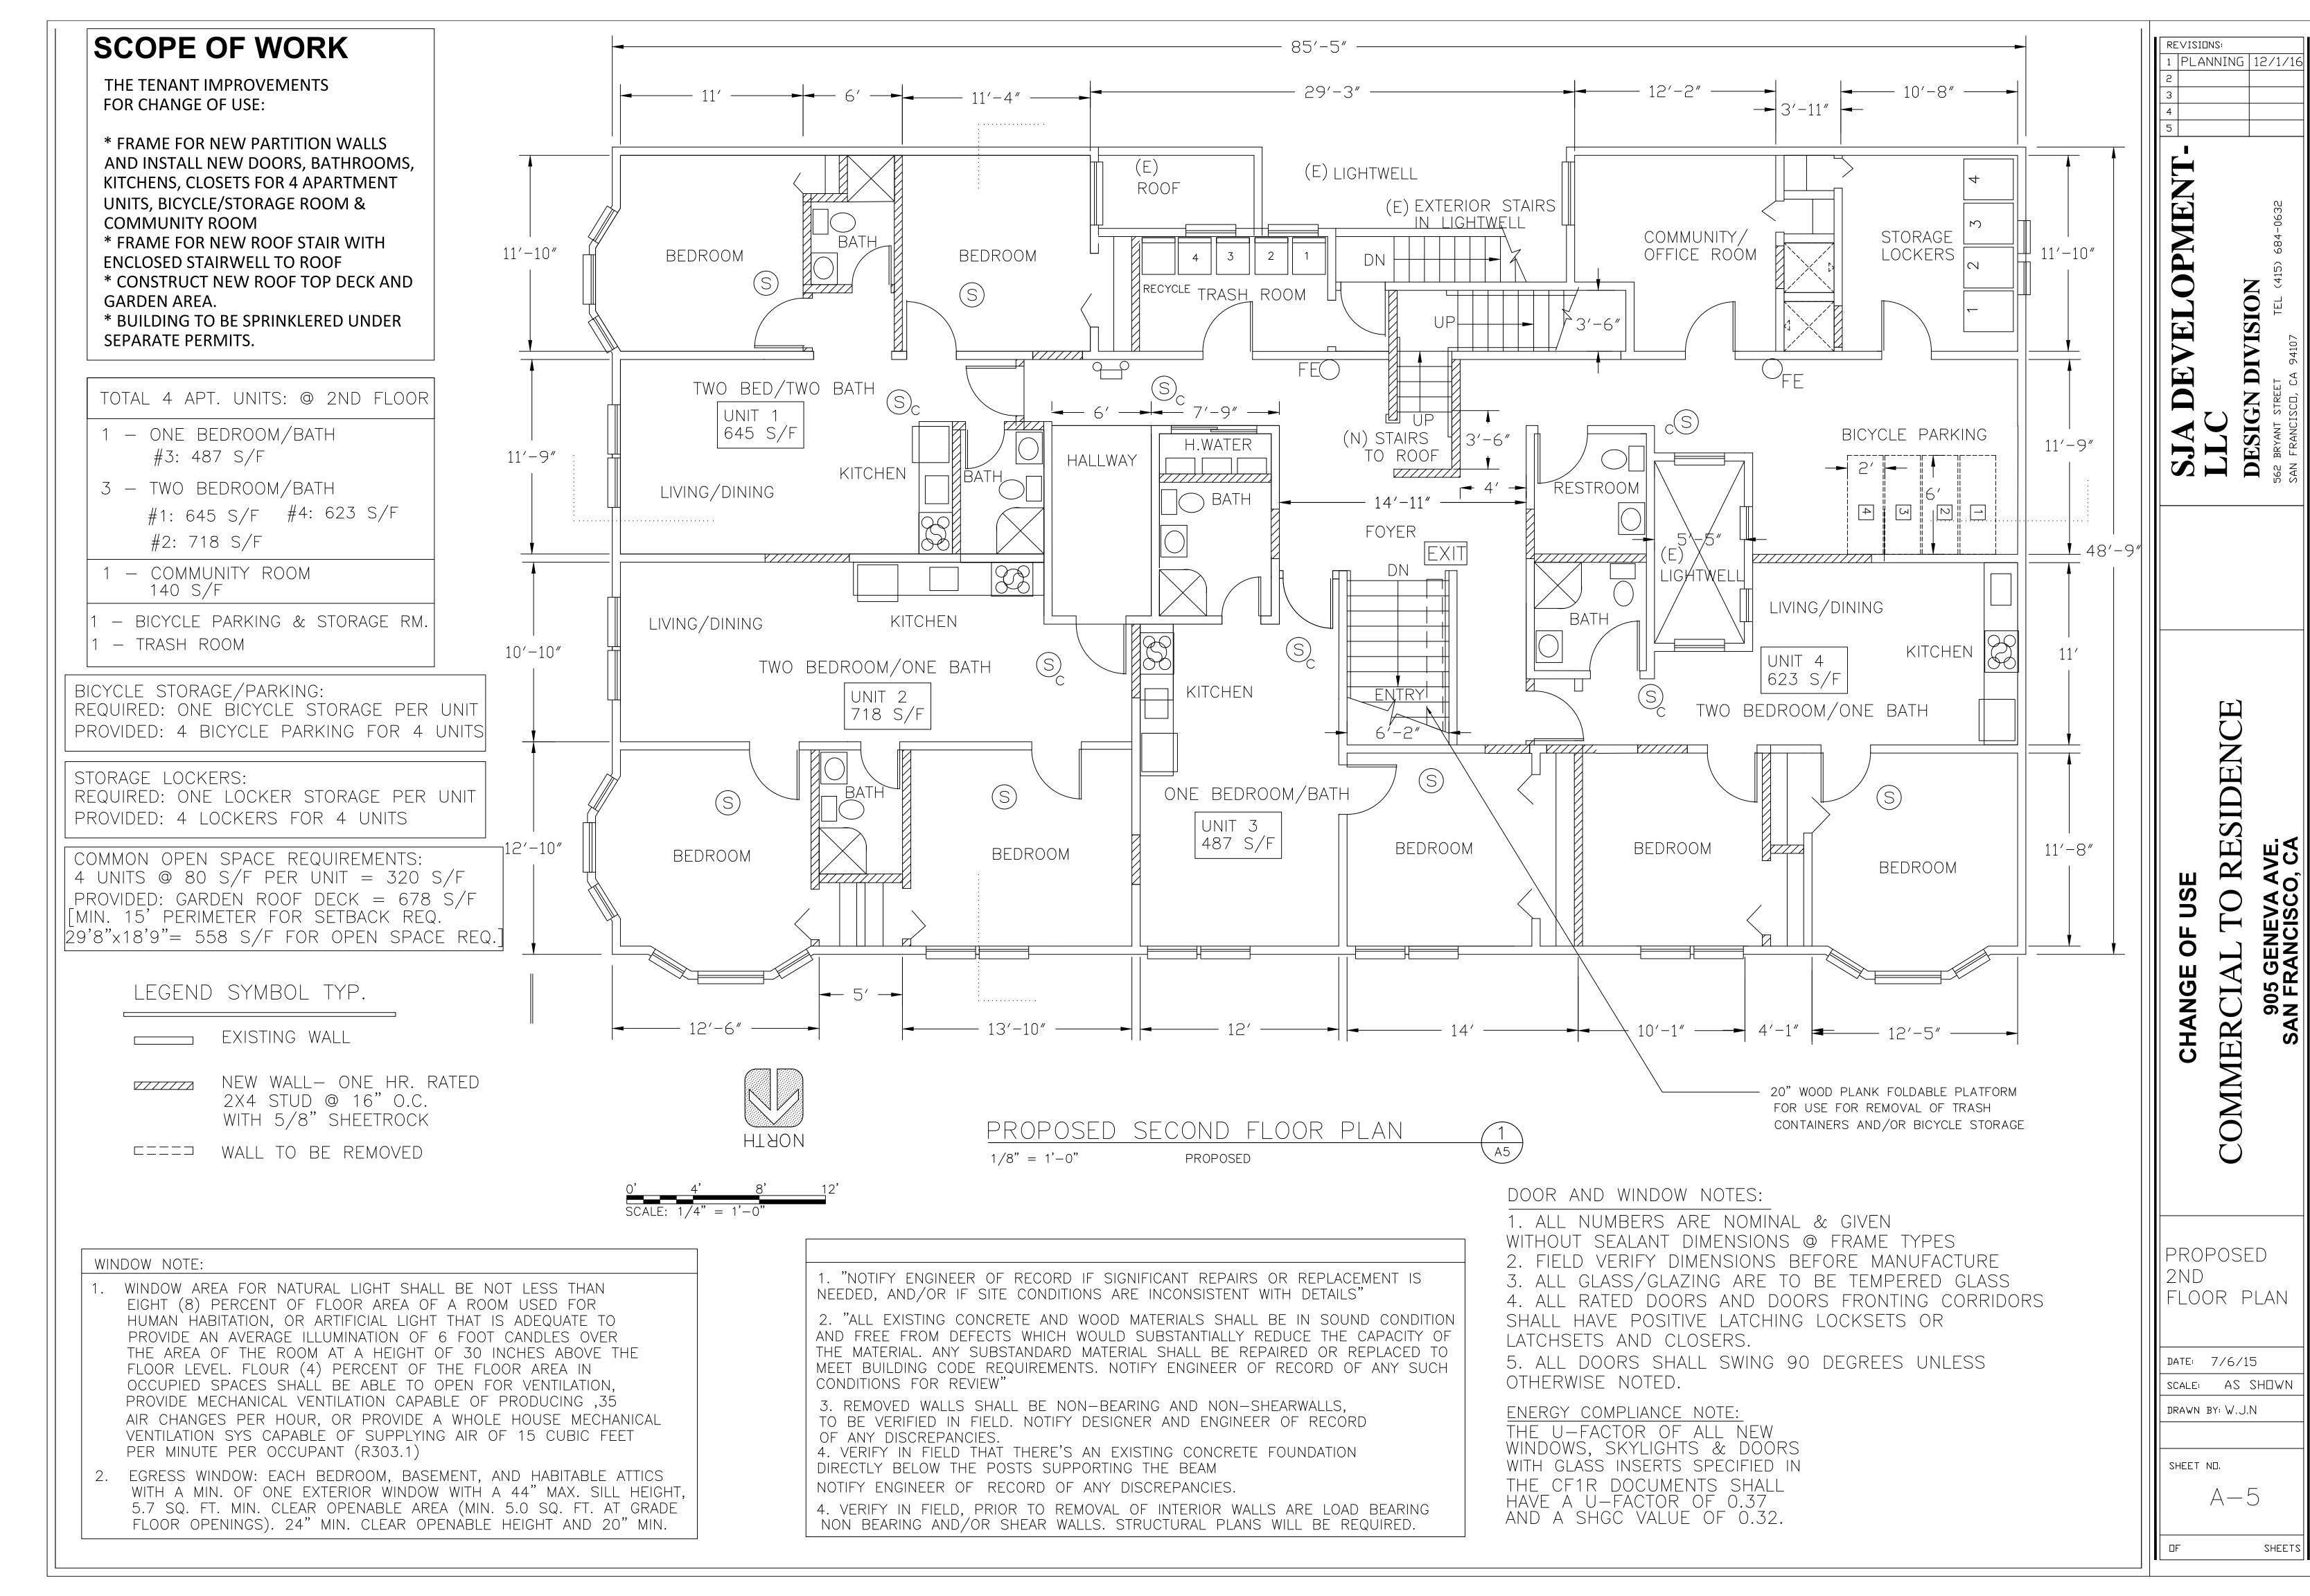

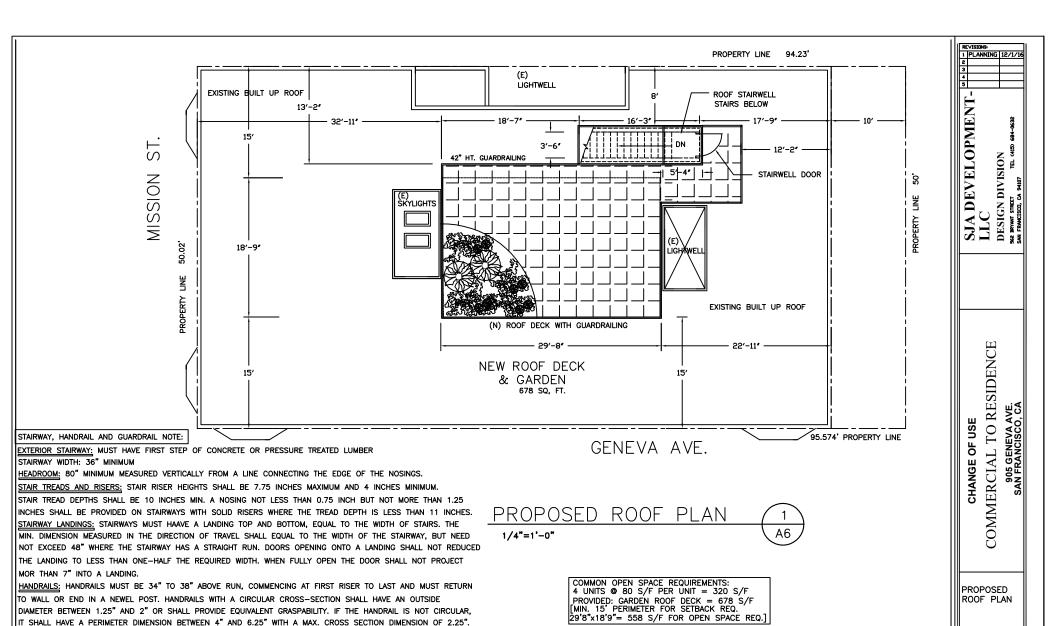

OCCUPANT LOAD: @ 15

678/15 = 45.2 OCCUPANTS

<49 ONE EXIT PROVIDED.

DATE: 7/6/15

DRAWN BY: W.J.N

SCALE: AS SHOWN

A-6

SHEETS

EDGES SHALL HAVE A MIN. RADIUS OF 0.01".


STAIRWAYS SHALL NOT BE USED FOR ANY PURPOSE


GUARDS: GUARDS SHALL BE LOCATED ALONG OPEN-SIDED WALKING SURFACES, STAIRWAYS, RAMPS AND LANDINGS THAT


ARE LOCATED MORE THAN 30" AABOVE THE FLOOR OR GRADE BELOW. GUARDS SHALL FORM A PROTECTIVE BARRIER NOT LESS THAN 42" HIGH EXCEPT WHEN TOP RAIL ALSO SEVES AS A HANDRAIL, GUARD HEIGHT SHALL NOT BE LESS THAN 34"


ENCLOSURES UNDER STAIRWAYS: THE WALLS AND SOFFITS UNDER ENCLOSED STAIRWAYS SHALL BE PROTECTED ON THE ENCLOSED SIDE WITH 0.5" GYPSUM BOARD. THERE SHALL BE NO ENCLOSED USABLE SPACE UNDER EXTERIOR EXIT STAIRWAYS


UNLESS THE SPACE IS COMPLETELY ENCLOSED IN ONE-HOUR FIRE-RESISTANCE CONSTRUCTION. THE SPACE UNDER EXTERIOR

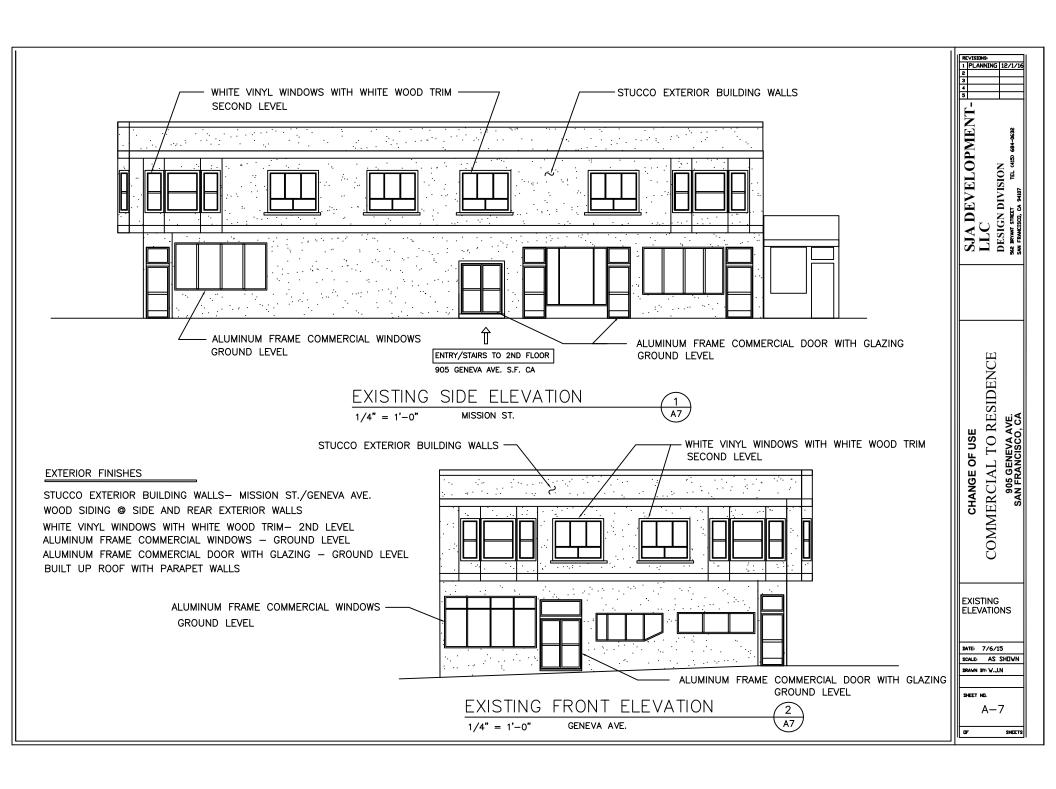

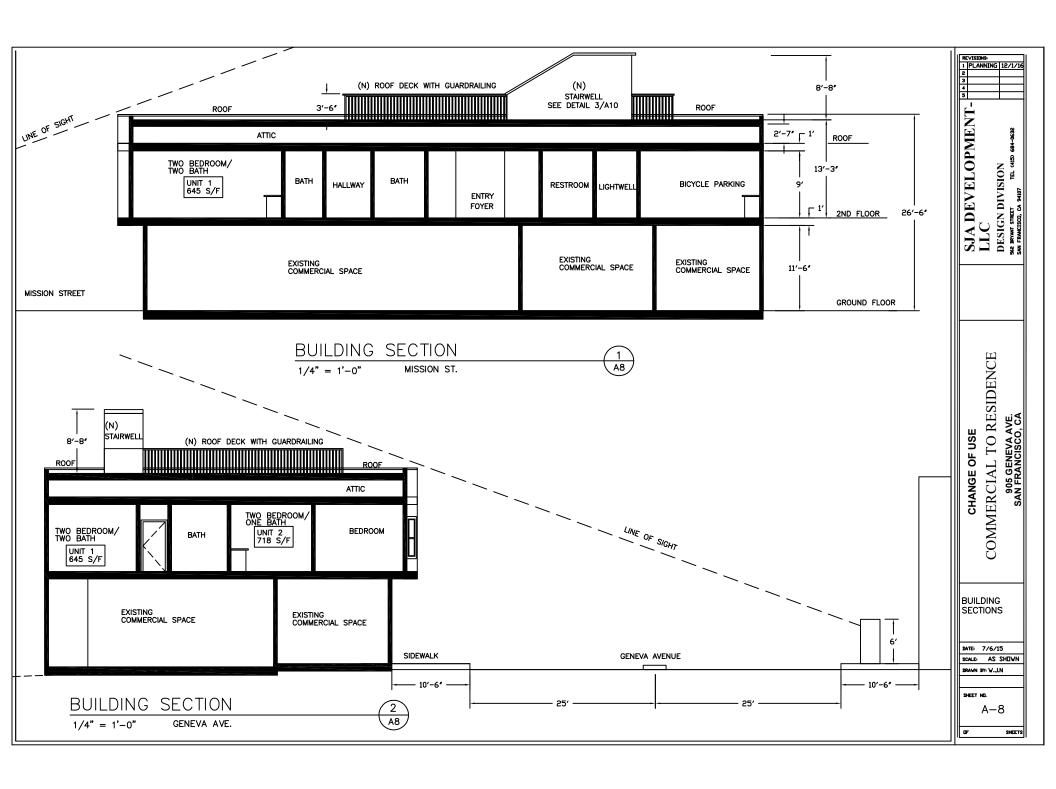

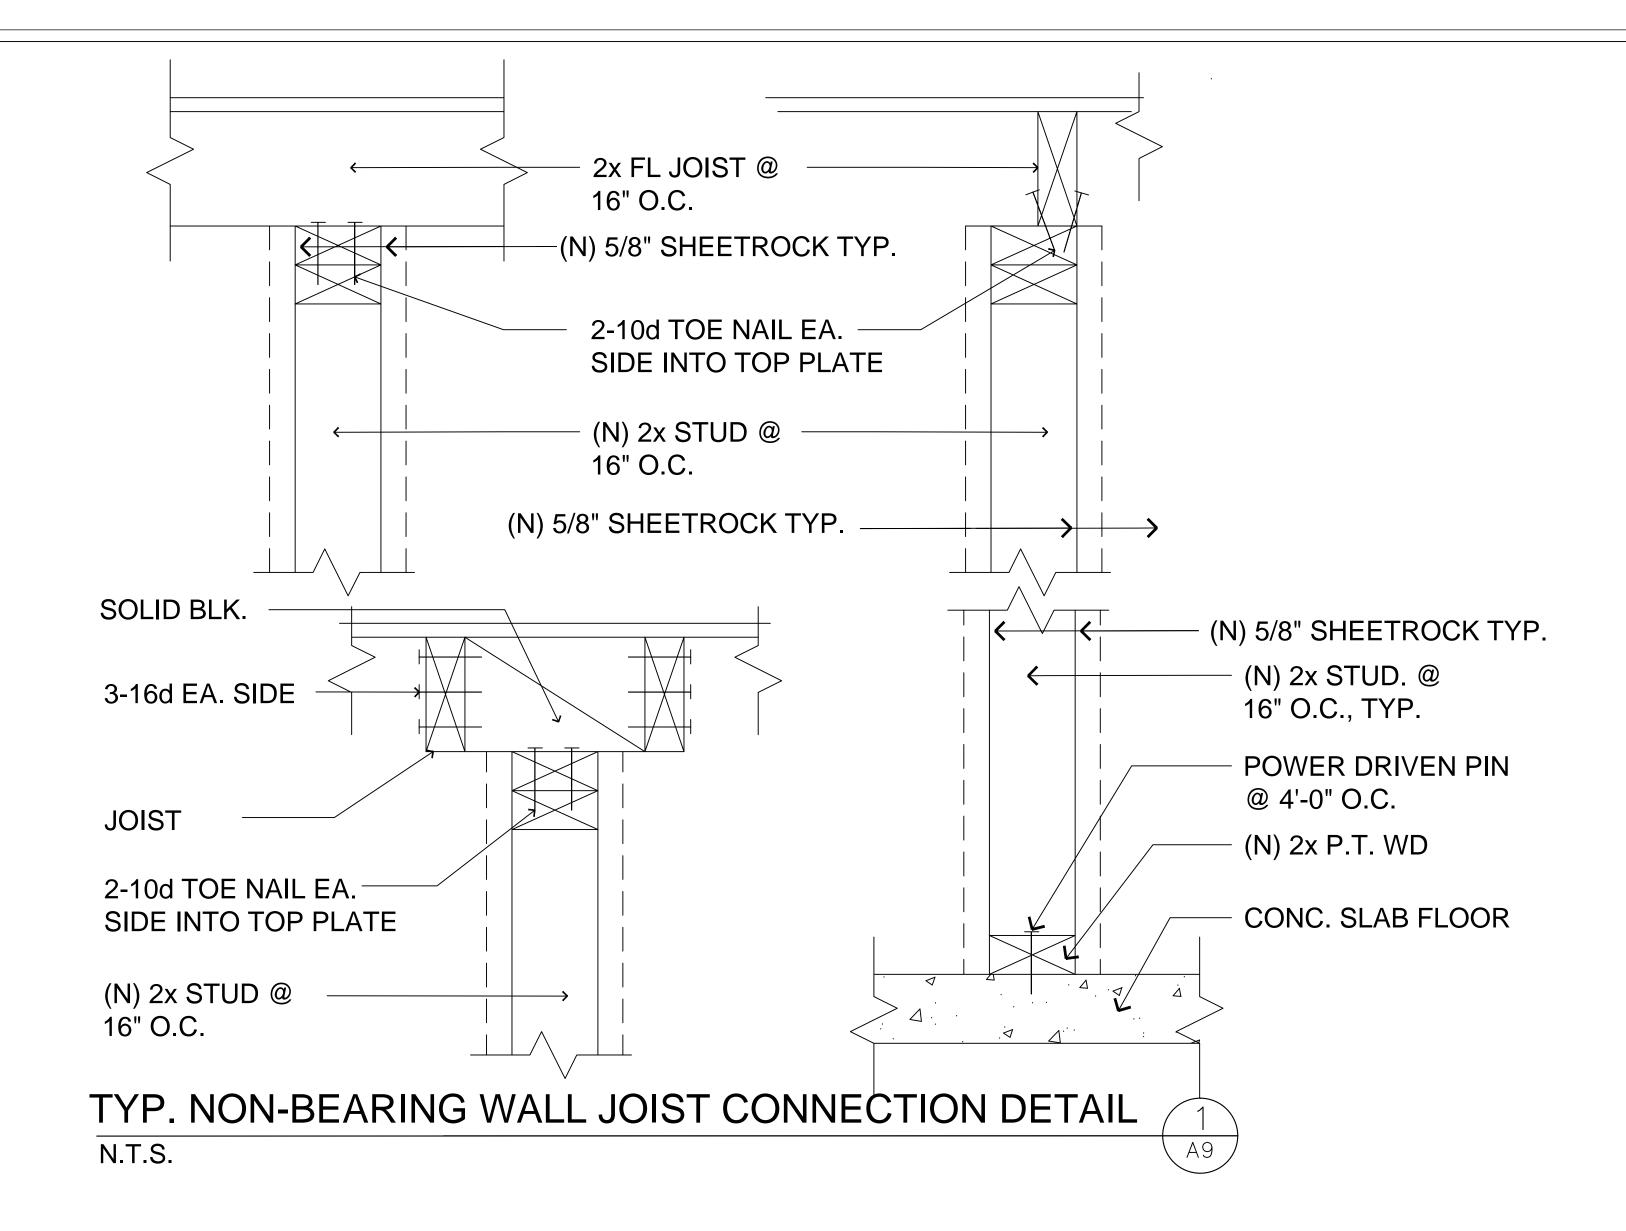

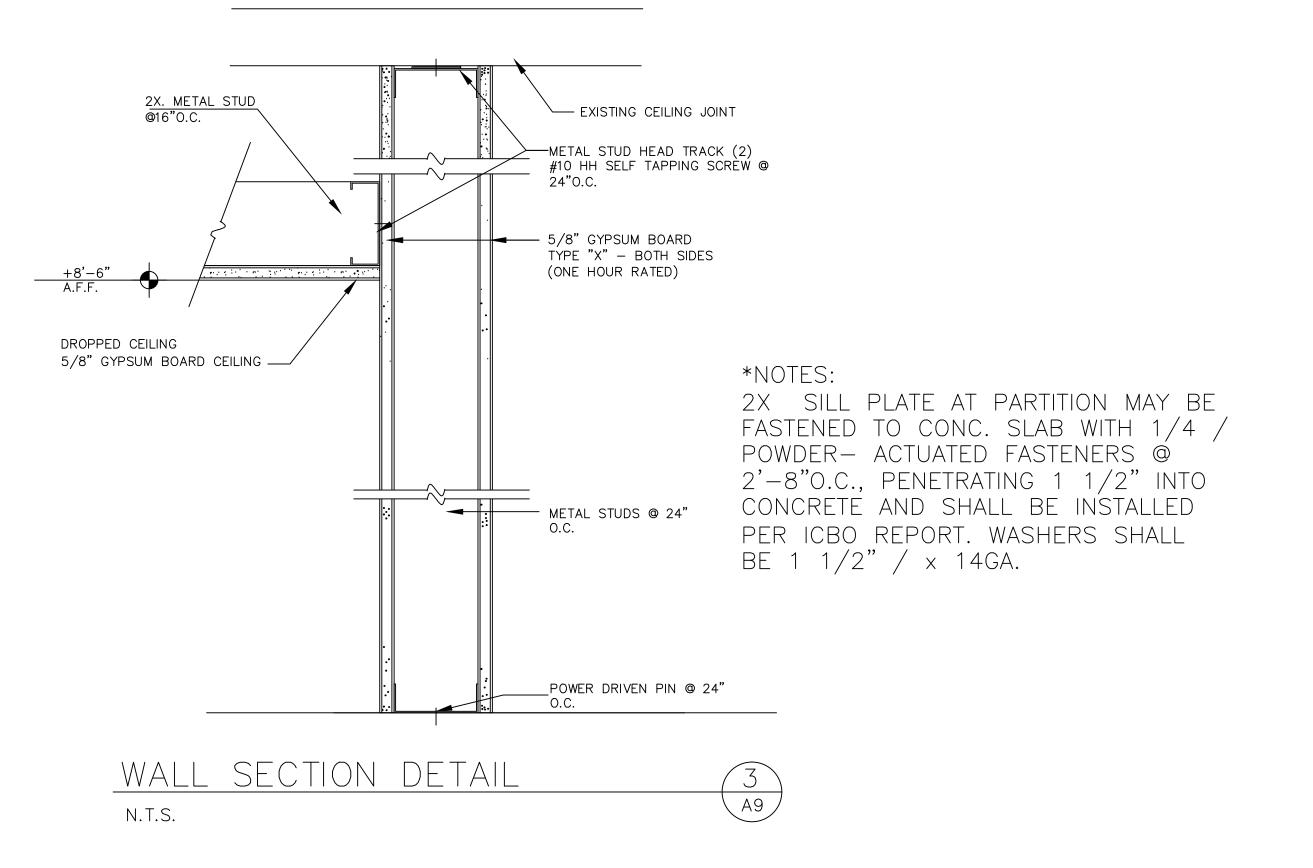

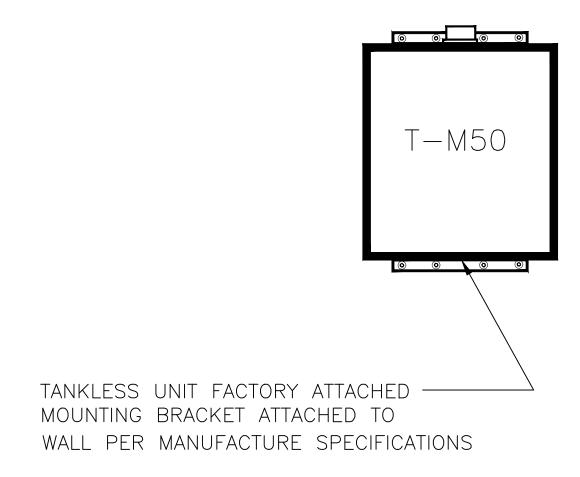


TANKLESS WATER HEATER

1" = 1'-0" MOUNTING DETAIL

A9

ELECTRIC TANKLESS WATER HEATER:

TAKAGI T-M50, ASME, 380,000 BTU
14.5 GPM, AC120V (60HZ) 1.48 AMPS
COMBUSTION AIR INTAKE KIT, 80.2% THERMAL EFF.
TANKLESS WATER HEATER WILL BE MOUNTED IN THE
WALL PER MANUFACTURER SPECIFICATIONS.
SEE MANUFACTURER SPECIFICATIONS ON SHEET M-1

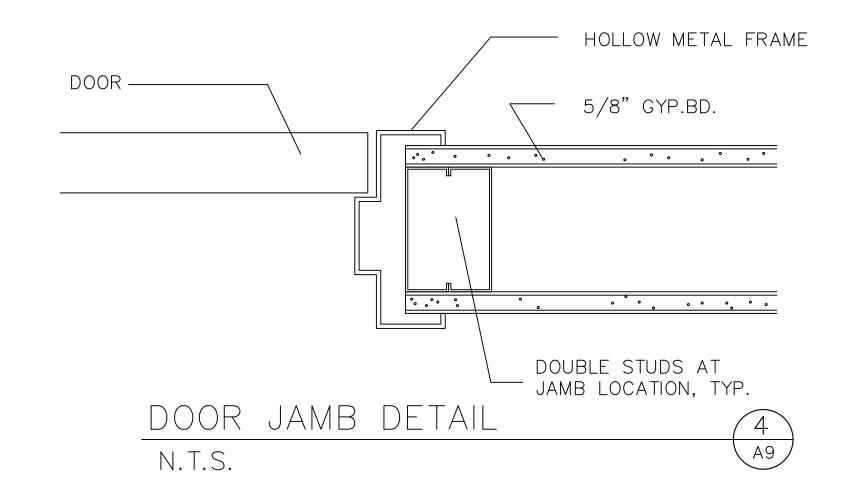

LOPMENT

GN DIVISION

DESIGN D

COMMERCIAL TO RESIDENCE 905 GENEVA AVE.

INTERIOR WALL SECTION & DETAILS


DATE: 6/30/15

SCALE: AS SHOWN

DRAWN BY: WJN

SHEET NO.

A-9

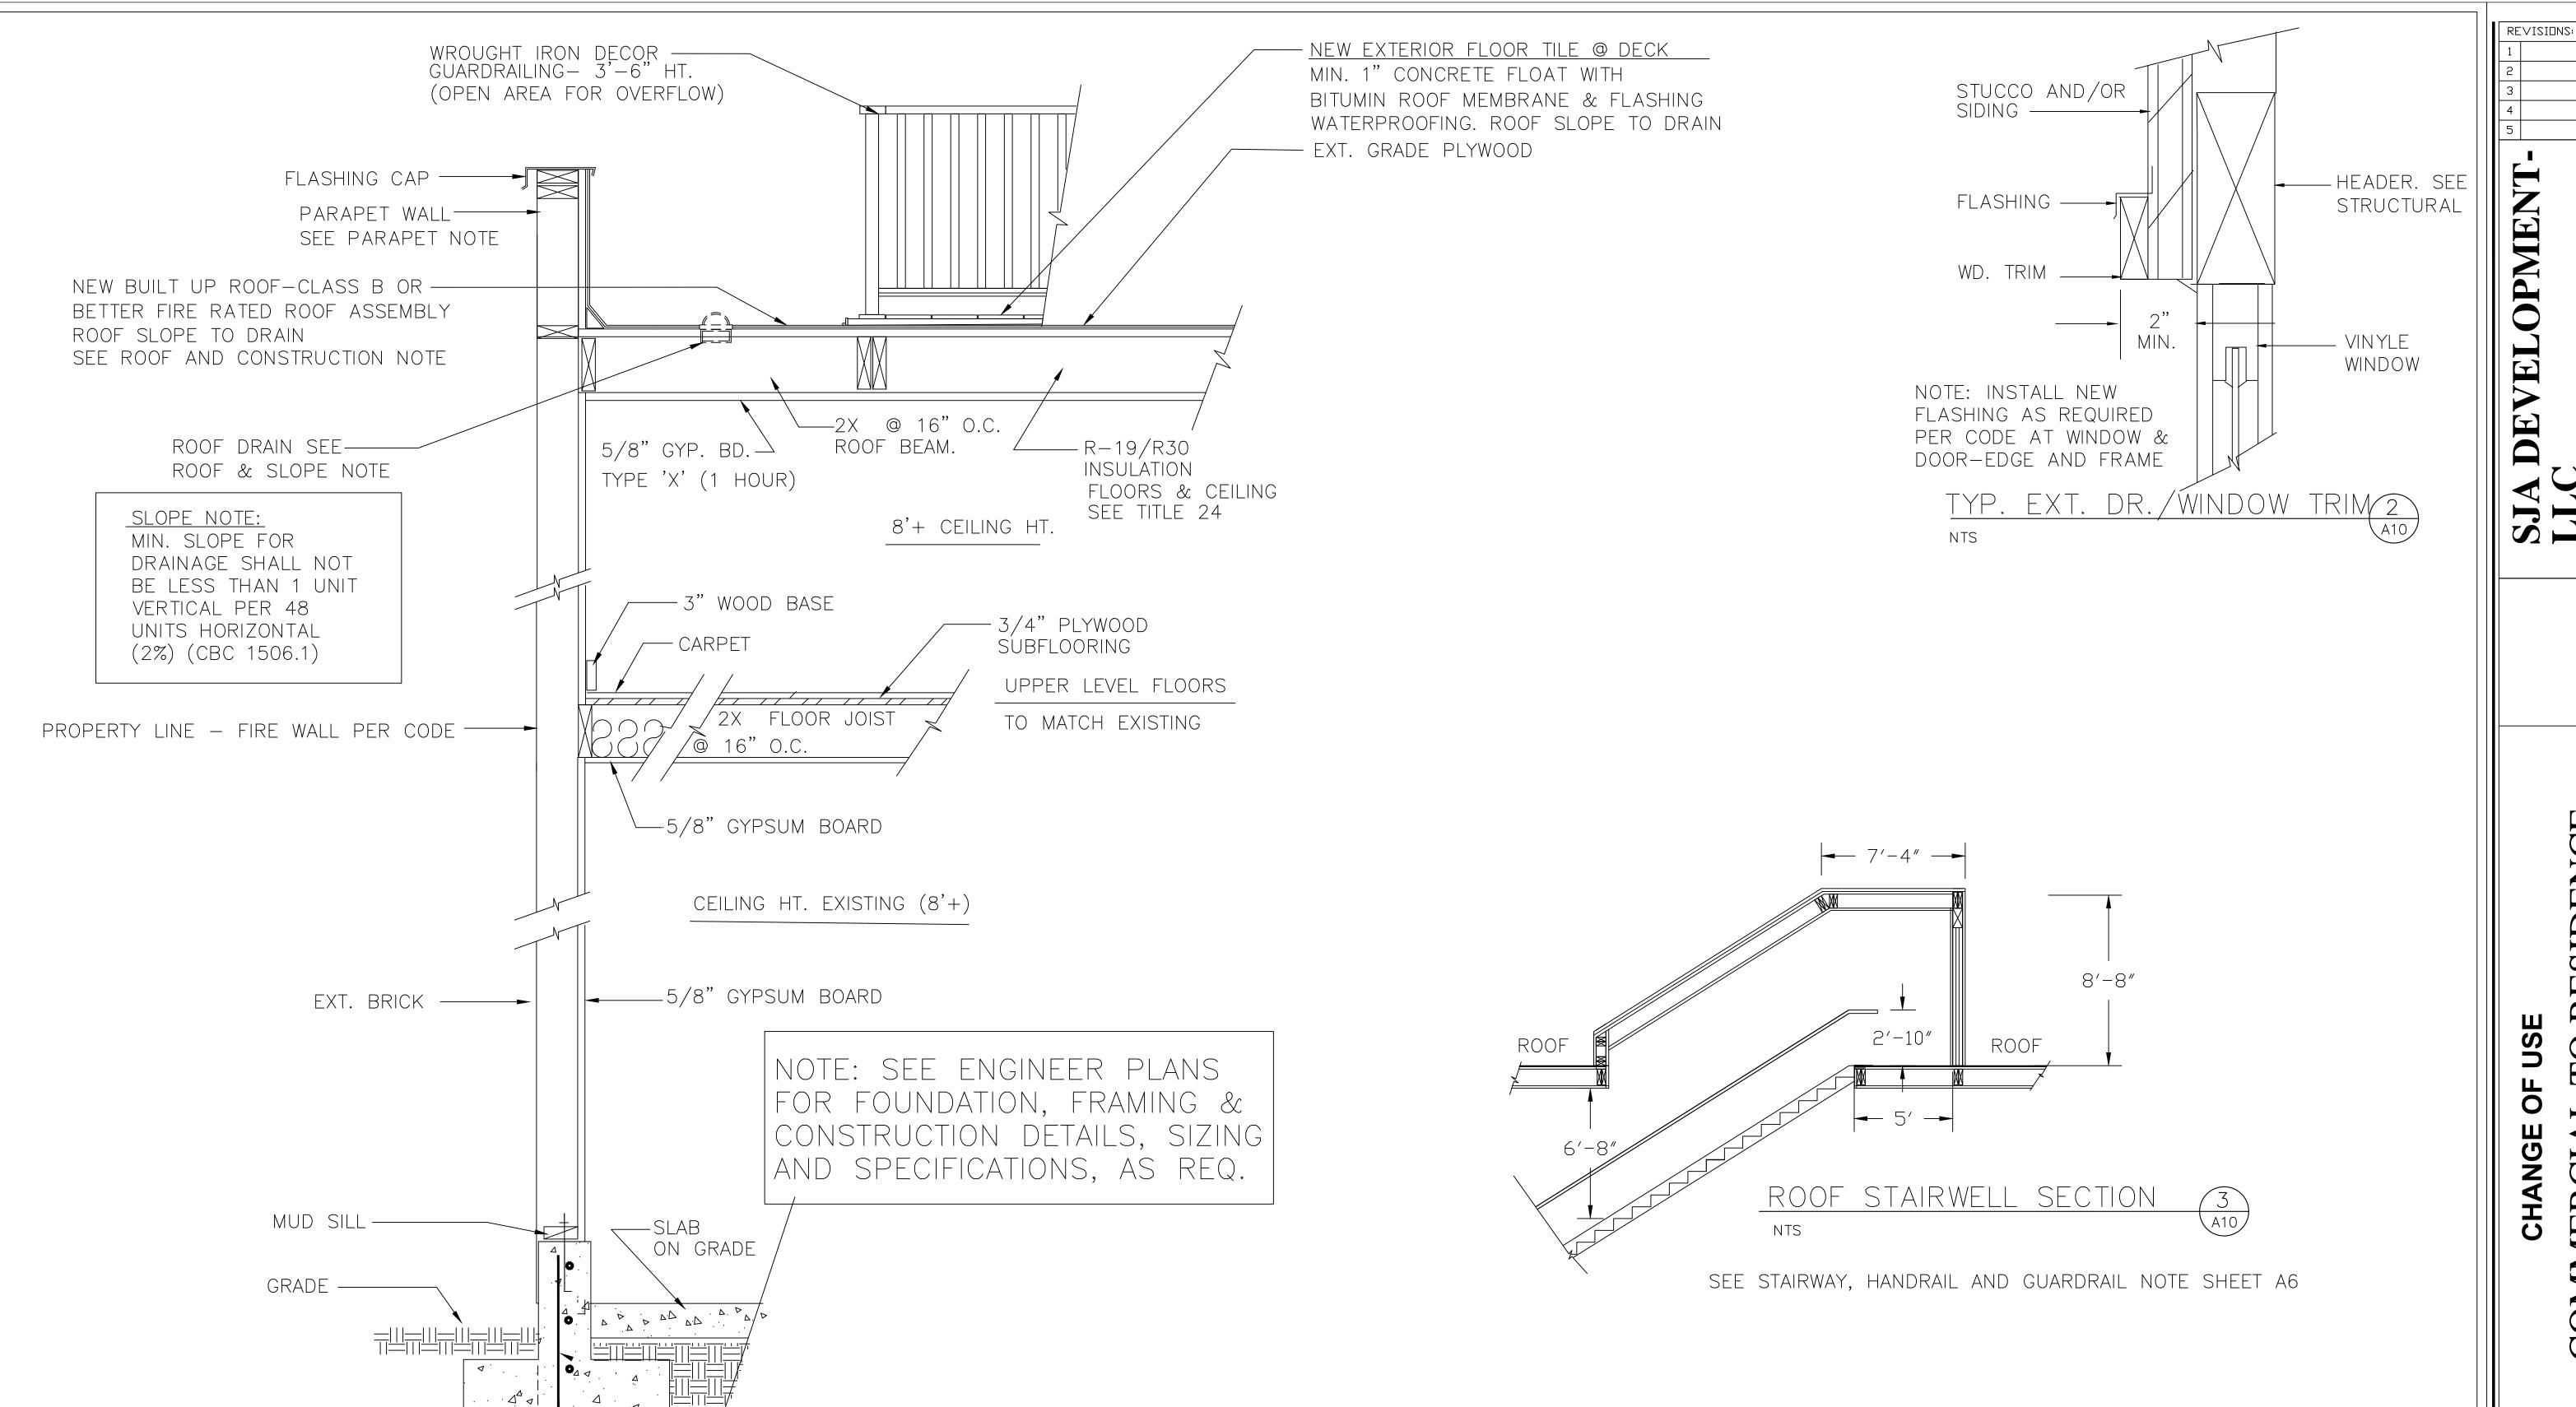

ROOF NOTES: (REPAIR AND/OR INSTALL NEW ROOF)

3/4" = 1'-0"

EXT. WALL SECTION

- 1. FLASHING AND PROTECTION FOR ALL PENETRATIONS AND OPENINGS AS REQUIRED PER CODE.
- 2. SUPPLY NEW DRAINAGE SYSTEM & PIPING @ 20' INTERVALS (MIN.) WITH 1/4' MESH SCREEN (CONTINUOUS)
- 3. SUPPLY MIN. 5 YEARS WARRANTY ON ALL ROOF WORK. ROOF TO BE BUILT UP— BITUMEN MOP DOWN W/ COATING ROOF PARAPET TO HAVE GALVANIZED FLASHING CAP ALL AROUND, PER CODE.
- 4. ALL NEW ROOF ASSEMBLIES FOR STRUCTURES FOR ALL OCCUPANCY CLASSIFICATIONS SHALL HAVE A FIRE RATING OF CLASS B OR BETTER WHEN TESTED UNDER CBC STANDARD 15-2

EADER. SEE RUCTURAL INYLE INDOW	SJA DEVELOPMENT- LLC DESIGN DIVISION 562 BRYANT STREET TEL (415) 684-0632 SAN FRANCISCE, CA 94107
	COMMERCIAL TO RESIDENCE 905 GENEVA AVE. SAN FRANCISCO, CA
	WALL SECTIONS AND DETAILS DATE: 7/6/15
	SCALE: AS SHOWN DRAWN BY: W.J.N SHEET NO. A — 1 O OF SHEETS

BATHROOM NOTES: SHOWER STALLS: SIZE: MIN. 1024 SQ. INCHES AND ABLE TO ENCOMPASS A 30" CIRCLE TO 70" HIGH CURB/DAM HEIGHT: 2" MIN., 9" MAX. DOOR: THRESHOLD SIZED TO ALLOW MIN. 22" DOOR, TEMPERED GLAZING, MUST OPEN OUTWARDS. VALVE: MUST BE LISTED ANTI-SCALD TEMPERATURE/PRESSURE BALANCED DEVICE SHOWERHEAD: MAY NOT DISCHARGE DIRECTLY AT ENTRANCE TO COMPARTMENT(PERSON/BATHER MUST BE ABLE TO ADJUST VALVE BEFORE STEPPING IN) WINDOWS: TEMPERED IF PART OF ENCLOSURE, LESS THAN 5' ABOVE TUB OR PAN. WATER CLOSETS: CLEARANCES: 15" FROM CENTER TO SIDEWALL OR OTHER OBSTRUCTION, 24" CLEAR IN FRONT **VENTILATION:** NATURAL: 1/20TH OF FLOOR AREA-1-1/2 SQ. FT. MIN. OR MECHANICAL: SYSTEM PROVIDING OUTSIDE AIR/5 AIR CHANGES PER HR., TERMINATE MIN. 3' FROM PROPERTY LINE OR OPENING INTO BUILDING, EQUIPPED WITH BACKDRAFT DAMPER. **ELECTRIC:** OUTLETS: GFCI PROTEDTED: 1 REQUIRED ADJACENT TO EACH BASIN; PROVIDE SEPARATE 20 AMP CIRCUIT FOR RECEPTACLES ONLY LIGHTING: MAIN LIGHTING MUST BE A FLOURESCENT FIXTURE. BATHTUB/SHOWER SPACE: NO RECEPTACLES OR SWITCHES ALLOWED (RECESSED LIGHTS OK IF DAMP RATED). CORD-CONNECTED, PENDANTS OR HANGING FIXTURES NOT ALLOWED WITHIN 3' HORIZONTALLY OR 8' VERTICALLY ABOVE TUB RIM. OVERHEAD LIGHTS LESS THAN 7'-6" ABOVE TOP OF RIM MUST BE GFCI PROTECTED CIRCUIT; LIGHT SWITCHES AND RECEPTACLES WITHIN 5' MUST BE

KITCHEN NOTES: COUNTERS: REQUIRE 2 OR MORE 20 AMP CIRCUITS (DIVIDED APPROX. EQUALLY), ALL COUNTERTOP RECEPTACLES MUST BE GFCI PROTECTED. INSTALL OUTLETS AT EACH COUNTERTOP WIDER THAN 12". NO POINT ALONG COUNTER TO BE MORE THAN 24" FROM AN OUTLET. OUTLETS MAY NOT BE MOUNTED MORE THAN 18" ABOVE COUNTER AND NEVER IN A FACE-UP POSITION ON COUNTER. ISLANDS AND PENINSULAS REQUIRE A MINIMUM OF 1 RECEPTACLE WHEN THE LONG DIMENSION IS 24" OR MORE AND THE SHORT DIMENSION IS 12" OR MORE. SEPARATE CIRCUITS SUITABLE FOR THE LOAD ARE REQUIRED FOR EACH APPLIANCE: DISHWASHER (20 AMP); GARBAGE DISPOSAL; TRASH COMPACTOR; RANGE (MIN. 40 AMP).

LIGHTING: MAIN AREA LIGHTING, CONTROLLED BY FIRST SWITCH, MUST BE A FLOURSCENT FIXTURE. PLUMBING:

DISHWASHER REQUIRES AN APPROVED, LISTED AIR GAP MOUNTED ABOVE THE FLOOD LEVEL OF THE SINK OR DRAINBOARD, WHICHEVER IS HIGHER. MECHANICAL:

COOKTOPS: VERTICAL CLEARANCE OF NOT LESS THAN 30" TO UNPROTECTED MATERIAL ABOVE, 24" TO METAL VENTILATING HOOD. OTHER:

DOORS: A SELF-CLOSING, TIGHT FITTING, SOLID-WOOD DOOR 1-3/8" THICH OR A 20 MINUTE FIRE RATED DOOR IS REQUIRED BETWEEN A KITCHEN AND THE GARAGE.

ANY DOOR BETWEEN A FOOD PREPARATION OR STORAGE ROOM AND A ROOM CONTAINING A WATER CLOSET MUST HAVE A TIGHT-FITTING DOOR.

PLUMBING NOTES:

GAS, VENTING PER CODE.

ELEVATED 18" ABOVE FLOOR.

20 AMPERE BRANCH CIRCUIT

FOR NEW BUILDINGS & SECONDARY UNITS, INSULATE ALL HOT WAT WATER IPES 3/4 INCH OR GREATER IN DIAMETER, 13. ELECTRICAL, UTILITY SERVICE LATERALS AND SEWERAGE SHALL BE UNDERGROUND. FROM THE WATER HEATÉR TO THE KITCHEN FIXTURES (BEES 150 (k) 6).

10. INSTALL NEW AUTOMATIC GARAGE DOOR

OPENER WITH SWITCH AND REMOTE CONTROL

11. INSTALL & PROVIDE HOT WATER HEATER,

WASHER & DRYER ROUGH IN. ELECTRICAL, OR

PROVIDE SEISMIC BRACE AND STRAPPING FOR

UTILITIES AS REQUIRED. HOT WATER TO BE

12. GFI AT BATHROOM TO BE DEDICATED

SHALL BE PROTECTED WITH ARC- FAULT

(BEES STD. 151 (f) 3 AND TABLE 151 C).

ENERGY CALCULATION PACKAGE

(BEES 150 (k) 4).

CIRCUIT INTERRUPTERS. (AFC) CEC 210-12 (B)

15. PROPOSED WINDOWS: U-FACTOR OF 0.42 PER

16. ALL RECESSED LIGHTING FIXTURES INSTALLED IN

17. FOR ALL OTHER ROOMS: PROVIDE FLUORESCENT

AND AT (AIR TIGHT) RATED (BEES `150 (k) 5).

INSULATED CEILINGS SHALL BE IC (INSULATION COVER)

FIXTURES, OR PROVIDE A MANUAL ON SENSOR CONTROL


GENERAL NOTES

- 1. ALL DESIGNS AND MATERIALS SHALL BE IN ACCORDANCE WITH 2007 CALIFORNIA BUILDING CODE, 2007 NATIONAL ELECTRICAL CODE, 2007 THE UNIFORM PLUMBING CODE, 2007 UNIFORM MECHANICAL CODE, 2007 UNIFORM FIRE CODE AND ALL OTHER CODES, CITY AND ORDINANCES WHICH APPLY.
- 2. PORTLAND CEMENT PLASTER-EXTERIOR STUCCO SHALL CONFORM TO SECTION 4708 AND TABLE 47-F AND 47-I, UBC. THE MINIMUM NAIL SIZE FOR FASTEN WOVEN OR WELDED WIRE LATH TO WOODFRAME SHALL BE NO. 11 GAUGE, 1-1/2" LONG WITH 7/16" DIAMETER HEAD NAIL OR NO. 16 GAUGE STAPLES HAVING 7/8" LONG LEGS AND MAXIMUM NAIL SPACING 6 INCHES AT STUDS AND TOP AND BOTTOM PLATES.
- 3. GYPSUM WALLBOARD SHALL CONFORM TO SECTION 4711 AND TABLES 47.G AND 47-1. UBC. THE MINIMUM NAIL SIZE SHALL BE 5d COOLER NAIL (OR WALLBOARD NAIL) AND MAXIMUM NAIL SPACING 7 INCHES AT PANEL EDGES AND INTERMEDIATE SUPPORTS (UNBLOCKED), UNLESS OTHERWISE NOTED.
- 4. ALL WORK SHALL BE PERFORMED IN ACCORDANCE WITH STRUCTURAL CALCULATIONS, INCLUDING ANY AND ALL ADDENDA PREPARED BY ENGINEER AND APPROVED BY SAN FRANCISCO BUILDING DEPARTMENT.
- 5. ALL EXCAVATIONS SHALL BE NEAT, CLEAN AND TRUE AND SHALL BE FREE OF ALL LOOSE MATERIAL PRIOR TO PLACING CONCRETE.
- 6. CONTRACTOR OR SUB-CONTRACTORS SHALL BE RESPONIBLE FOR PROVING ALL TEMPORARY BRACING, SHORING, RAILING, ETC., NECESSARY TO ENSURE SAFETY OF PERSONS AND PROPERTY.
- 7. CONTRACTOR AND SUB-CONTRACTORS SHALL CLEAN UP DEBRIS AS THE WORK PROGRESSED. CONTRACTOR AND SUB-CONTRACTORS SHALL PROVIDE FOR TRASH REMOVAL FROM SITE. FINAL CLEANING, AFTER SUBSTANIAL COMPLETION, BUT PRIOR TO FINAL INSPECTION, SHALL INCLUDE A THOROUGH CLEANING OF ALL SURFACES INSTALLED, INCLUDING COUNTERTOPS, GLASS, LIGHT FIXTURES, FLOOR COVERING, ETC. ALL TEMPORARY FACILITIES, EXCESS MATERIALS, DEBRIS, TRASH, EQUIPMENT, ETC., SHALL BE REMOVED FROM THE SITE.
- 8. PRIOR TO COMMERCING CONSTRUCTION, CONTRACTOR AND SUB-CONTRACTORS SHALL REVIEW ALL DRAWINGS SUPPLIED BY ARCHITECT OR DESIGNER AND ENGINEER. VERIFY ALL SITE AND EXISTING JOB CONDITIONS AND DIMENSIONS AND NOTIFY ARCHITECT OR DESIGN AND ENGINEER OF ANY ERRORS IN DIMENSIONS, DETAILS OR CODE COMPLIANCE. SUCH ERRORS SHALL BE RESOLVED BY DESIGNER, ENGINEER AND CONTRACTOR BEFORE CONTINUING WITH ANY WORK.
 - ALL WORK SHOULD BE PLUMB, LEVEL AND SQUARE. ALL MATERIALS, APPLIANCES, FIXTURES, EQUIPMENTS, ETC., SHALL BE NEW AND CONFORM WITH ALL APPLICABLE CODES, WORKMANSHIP SHALL MEET THE BEST PROFESSIONAL STANDARDS OF THE TRADE.
- 10. FLASHING AND PROTECTION FOR ALL PENETRATIONS AND OPENINGS AS REQUIRED PER CODE.
- 11. SUPPLY NEW DRAINAGE SYSTEM & PIPING @ 20' INTERVALS (MIN.) WITH 1/4' MESH SCREEN (CONTINUOUS) 12. SUPPLY MIN. 5 YEARS WARRANTY ON ALL ROOF WORK. ROOF TO BE BUILT UP- BITUMEN TORCH DOWN W/ COATING
 - ROOF PARAPET TO HAVE GALVANIZED FLASHING CAP ALL AROUND, PER CODE.
- SEWERAGE TO BE HOOKED UP WITH EXISTING MAIN INFORM LOCAL UTILITY DEPT. 14. COLORS OF INTERIOR AND EXTERIOR FINISHES AND PAINTS ARE TO BE CHOSEN BY OWNER.
- 15. INSULATION SCHEDULE AS FOLLOW: WALL -R-13; ROOF -R-30; FLOOR/CEILING -R-19 PER TITLE 24
- 16. PROVIDE FIRE EXTINGUISHER SYSTEM AND TYPE PER S.F. FIRE DEPARTMENT REQUIREMENTS AND LOCATION PER CODE.

WINDOW REQUIREMENTS-

- 1. TEMPORARY NFRC LABELS ON NEW WINDOWS AND EXTERIOR DOORS SHALL NOT BE REMOVED UNTIL AFTER FINAL INSPECTION (CNC STD 10.111(a) & 116 (a)4) HVAC REQUIREMENTS-
- 2. R-4.2 DUCT INSULATION SHALL BE INSTALLED IF 40 FEET OR LESS OF NEW DUCTS ARE INSTALLED IN UNCONDITIONED SPACE (CNC 152(b)D)
- 3. VENTILATION FANS FOR NEW OR REMODELED BATHROOMS SHALL BE MINIMUM 50 CFM WITH MAXIMUM 1 SONE SOUND RATING (ASHRAE 62.2)
- 4. 1 INCH INSULATION SHALL BE INSTALLED ON FIRST 5 FEET OF HOT AND COLD WATER PIPES AT THE WATER HEATER (CNC 150(j)2)
- 5. 50% OF KITCHEN LIGHTING WATTAGE SHALL BE HIGH EFFICACY. INCANDESCENT LIGHTING SHALL BE CONTROLLED BY A SEPARATE SWITCH. NOTE: BLANK ELECTRICAL BOXES SHALL BE COUNTED AS 180 WATTS (CNC 150 (k) 8-9 & (k) 3)
- EFFICACY UNTIL THE TOTAL WATTAGE OF ALL KITCHEN LIGHTS IS 50% EXISTING LIGHTING FIXTURES ARE INCLUDED IN THE CALCULATION. NOTE: LIGHTING INSTALLED ADJACENT TO THE KITCHEN, SUCH AS DINING ROOMS AND NOOK AREAS, IS CONSIDERED AS KITCHEN LIGHTING, UNLESS SWITCHED SEPARATELY.
- 7. KITCHEN FANS SHALL BE SWITCHED SEPARATELY FROM ANY LIGHTING SYSTEM. BATHROOMS, GARAGES, LAUNDRY ROOMS, CLOSETS AND UTILITY ROOMS-
- ON/OFF MOTION SENSOR AND ONE OF THE FOLLOWING CONTROLS (CNC 150 (k) 13) * A PHOTO-CONTROL, * AN ASTRONOMICAL CLOCK, * AN ENERGY MANAGEMENT CONTROL SYSTEM

GENERAL NOTES

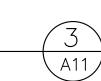

ENERGY CODE:

- WATER HEATING REQUIREMENTS-
- KITCHENS-
- 6. ALL NEW OR REPLACEMENT LIGHTING FIXTURES INSTALLED IN THE KITCHEN SHALL BE HIGH
- 8. ALL NEW LIGHTING INSTALLED IN BATHROOMS, GARAGES, LAUNDRY ROOMS, CLOSETS GREATER THAN 70 SF. AND ULITILY ROOMS SHALL BE HGIH EFFICACY OR SPECIFY A MANUAL ON/OCCUPANCY SENSOR CONTROL FOR ALL INCANDESCENT FIXTURES (DIMMERS DO NOT QUALIFY) (CNC 150 (k) 10)
- 9. BATH FANS SHALL BE SWITCHED SEPARATELY FROM ANY LIGHTING SYSTEM. OUTDOOR LIGHTING REQUIREMENTS-
- 10. ALL EXTERIOR LIGHTING FIXTURES SHALL BE HIGH EFFICACY, OR CONTROLLED BY AN AUTO

UTILITY NOTES:

1. SHOWER AND TUB-SHOWER COMBINATION SHALL BE PROVIDED WITH INDIVIDUAL CONTROL VALVES OF THE PRESSURE BALANCE OR THERMOSTATIC MIXING TYPE VALVE.

2. SHOWER HEADS SHALL NOT EXCEED A WATER SUPPLY FLOW RATE OF 2.5 GAL. PER MINUTE. 3 MIN. 34"X34" SHOWER STALLS WITH

1024 SQ. IN. AND 30" DIA. CIRCLE TO BE PROVIDED AT BATHROOMS. 4. BATHROOM AND LAUNDRY ROOM OUTLETS SHALL BE ON A DEDICATED

20 AMPERE BRANCH CIRCUIT


13. SUPPLY & INSTALL NEW TILE ENCLOSURE 5. PROVIDE FLUORESCENT LIGHT AT SHOWER STALL-70 IN. ABOVE DRAIN INLET FIXTURE OF 40 LUMENS PER WATT OR AND NEW TEMPERED GLASS SHOWER DOOR PER GREATER FOR BATHROOMS. SWITCH TO BE CODE, TYP. @ SHOWERS AT THE ENTRANCE TO THE BATHROOM. FLUORESCENT LIGHT AT KITCHEN. 14. ALL RECEPTACLES, LIGHTING CIRCUITS, SWITCHES, & 50% OR MORE OF THE KITCHEN LIGHTING HARDWIRED SMOKE DETECTORS INSTALLED IN BEDROOMS WATTAGE MUST BE FLUORESCENT. INCANDESCENT

LIGHTING MUST BE SWITCHED SEPARATELY (BEES 150 (k) 2). 6. ALL NEW INSTALLED WINDOWS: TO BE DOUBLE PANE, VINYLE INSULATED WITH MIN. U-VALUE OF R-0.427. EXTERIOR LIGHTS AND HOUSE LIGHTS TO BE ON SEPARATE PANEL OR TIMED SWITCH OR MOTION DETECTED LIGHTS AND WEATHERPROOF

8. ALL EXHAUST FAN AND DUCTWORK VENT PER CODE.

9. PROVIDE 1.6 GAL. PER TANK PER WATER FLUSH TOILET

UTILITY NOTES

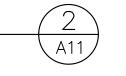

18. ALL EXT. LIGHTING FIXTURES SHALL BE HIGH EFFICACY FLUORESCENT OR CONTROLLED BY AN AUTO ON/OFF MOTION SENSOR COMBINED WITH PHOTO SENSOR TO PREVENT DAYLIGHT USE (BEES 150 (k) 4).

ENERGY NOTES



VELOPMENT-

REVISIONS:

905 GENEVA AVE. N FRANCISCO, CA RE

GENERAL AND ULTILITY NOTES

DATE: 6/30/15 SCALE: AS SHOWN DRAWN BY: WILSON NG

SHEET NO.

A-1