MEMO

Disclaimer for Review of Plans

The San Francisco Planning Code requires that the plans of certain proposed projects be provided to members of the public prior to the City's approval action on the project. Accordingly, any images of plans featured on this website are provided for the primary purpose of facilitating public input prior to the City's action. The City and County of San Francisco does not own the copyright to these images. Please be aware that the unauthorized reproduction, distribution, or alteration of these images may result in a violation of Federal Copyright Law (17 U.S.C.A. Sections 101 et seq.) and that any party who seeks to reproduce or alter these images does so at his or her own risk.

Additionally, plans provided on this website are limited to site plans, elevations and/or section details (floor plans and structural details may not be included). These are DRAFT PLANS being provided for public review PRIOR to the City's approval action on the project. Final plans may differ from those that are currently available for review.

1650 Mission St. Suite 400 San Francisco, CA 94103-2479

Reception: 415.558.6378

Fax: 415.558.6409

Planning Information: 415.558.6377 1650 Mission Street, Suite 400 • San Francisco, CA 94103 • Fax (415) 558-6409

NOTICE OF PUBLIC HEARING

Hearing Date: Wednesday, July 27, 2016

Not before 9:30 AM Time:

Location: City Hall, 1 Dr. Carlton B. Goodlett Place, Room 408

Case Type: Variance

Hearing Body: Zoning Administrator

PROPERTY INFORMATION		APPLICATION INFORMATION	
Project Address:	870 Union Street	Case No.: Building Permit: Applicant: Telephone: E-Mail: br	2015-007313VAR
Cross Street(s):	Taylor/Mason Streets		2015.11.13.2622 & 2623
Block /Lot No.:	0100/085-087		Brian Milford
Zoning District(s):	RM-1 / 40-X		(415) 346-9990
Area Plan:	N/A		ian@martinkovicmilford.com

PROJECT DESCRIPTION

The subject lot is a through lot with one existing residential structure at the front (fronting Union Street), containing 3 dwelling units. The project proposes a vertical and horizontal addition to said front structure (adding a fourth floor), and construction a new, 4-story residential structure in the rear of the lot (fronting Aladdin Terrace), containing 1 dwelling unit.

SECTION 134 OF THE PLANNING CODE requires a minimum rear yard of approximately 32'-3/16" for the subject property. Because the subject lot is a through lot, the required rear vard shall be located in the central portion of the lot, between the two structures on such lot. The project proposes a new structure in the rear of the lot (fronting Aladdin Terrace) that would encroach into the required rear yard by approximately 12'-3/16"; therefore the project requires a variance.

SECTION 135 OF THE PLANNING CODE requires useable open space be provided for each dwelling unit according to standards set forth in the Code. Two of the four units (Units #1 and #2 in the front structure) do not provide useable open space meeting the requirements of the Code; therefore the project requires a variance.

SECTION 140 OF THE PLANNING CODE requires units to face directly on an open area as defined by Code. Two of the four units (Unit #1 in the front structure, and Unit #4 in the rear structure) do not face directly on an open area as defined by Code; therefore the project requires a variance.

ADDITIONAL INFORMATION

ARCHITECTURAL PLANS: The site plan and elevations of the proposed project are available on the Planning Department's website at: http://notice.sfplanning.org/2015-007313VAR.pdf

Members of the public are not required to provide personal identifying information when they communicate with the Commission or the Department. All written or oral communications, including submitted personal contact information, may be made available to the public for inspection and copying upon request and may appear on the Department's website or in other public documents.

FOR MORE INFORMATION, PLEASE CONTACT PLANNING DEPARTMENT STAFF:

Planner: Nicholas Foster Telephone: (415) 575-9167 E-Mail: nicholas.foster@sfgov.org

GENERAL INFORMATION ABOUT PROCEDURES

HEARING INFORMATION

You are receiving this notice because you are either a property owner or resident that is adjacent to the proposed project or are an interested party on record with the Planning Department. You are not required to take any action. For more information regarding the proposed work, or to express concerns about the project, please contact the Applicant or Planner listed on this notice as soon as possible. Additionally, you may wish to discuss the project with your neighbors and/or neighborhood association, as they may already be aware of the project.

Persons who are unable to attend the public hearing may submit written comments regarding this application to the Planner listed on the front of this notice, Planning Department, 1650 Mission Street, Suite 400, San Francisco, CA 94103, by 5:00 pm the day before the hearing. These comments will be made a part of the official public record and will be brought to the attention of the person or persons conducting the public hearing.

Comments that cannot be delivered by 5:00 pm the day before the hearing may be taken directly to the hearing at the location listed on the front of this notice. Comments received at 1650 Mission Street after the deadline will be placed in the project file, but may not be brought to the attention of the Zoning Administrator at the public hearing.

BUILDING PERMIT APPLICATION INFORMATION


Pursuant to Planning Code Section 311 or 312, the Building Permit Application for this proposal may also be subject to notification of property owners and residents within 150-feet of the subject property. On 6/20/16, the Department issued the required Section 311 notification for this project (expires 7/19/16).

APPEAL INFORMATION

An appeal of the approval (or denial) of a **Variance application** by the Zoning Administrator may be made to the **Board of Appeals within 10 calendar days** after the Variance Decision Letter is issued by the Zoning Administrator.

An appeal of the approval (or denial) of a **building permit application** by the Planning Commission may be made to the **Board of Appeals within 15 calendar days** after the building permit is issued (or denied) by the Director of the Department of Building Inspection.

Appeals must be submitted in person at the Board's office at 1650 Mission Street, 3rd Floor, Room 304. For further information about appeals to the Board of Appeals, including current fees, contact the Board of Appeals at (415) 575-6880.

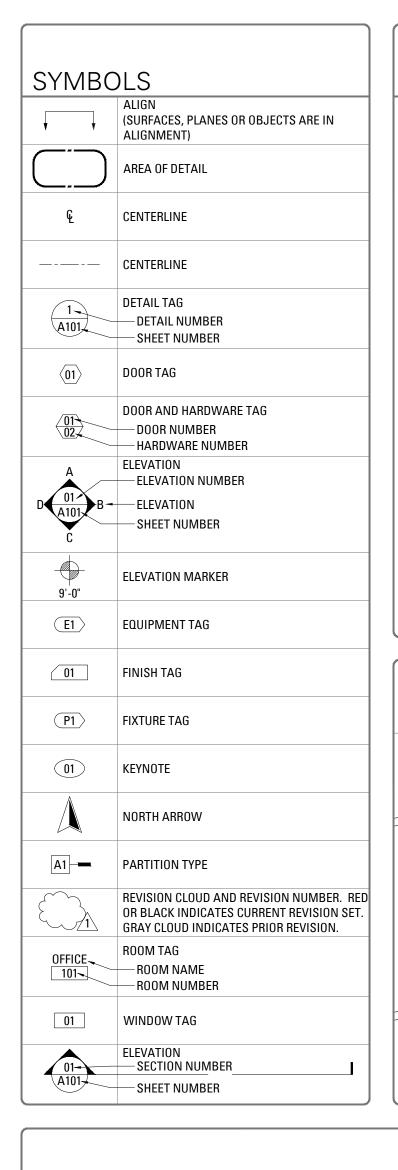

ABBREVIATIONS

CENTERLINE

ALUMINUM

ALUMINUM

ANODIZED

APPROXIMATE

AS REQUIRED

BUILDING

BLOCKING

BOTTOM OF

BETWEEN

CAULKING

CLEANOUT

COLUMN

CONCRETE

CONNECTION

CONTINUOUS

COUNTERSUNK

DEPARTMENT

DIMENSION

DISPENSER

DOOR

EAST

EACH

EMER.

ENGR.

DOOR OPENING

DOWNSPOUT

EXPANSION JOINT

ELECTRICAL PANEL BOARD

DRAWING

DRAWER

ELECTRICAL

EMERGENCY

ENGINEER

DRINKING FOUNTAIN

DOUBLE

DIA. OR Ø DIAMETER

CONSTRUCTION

CLOSET

CLEAR

CALIFORNIA BUILDING CODE

CALIFORNIA FIRE CODE

CALIFORNIA ELECTRICAL CODE

CALIFORNIA MECHANICAL CODE

CONCRETE MASONRY UNIT

CALIFORNIA PLUMBING CODE

CALIFORNIA RESIDENTIAL CODE

CALIFORNIA GREEN BUILDING CODE G.C.

BLOCK

AT FINISHED ROOF

ARCHITECTURAL

ANOD.

BTWN.

CFC CGC CLG. CLKG.

CLOS.

CONN.

CONSTR.

APPROX.

PLUS OR MINUS

PROPERTY LINE

POUND OR NUMBER

ABOVE FINISHED FLOOR

EQUIPMENT

EXISTING

EXTERIOR

EXTRUSION

FIRE ALARM

FINISH

FL00R

FLUORESCENT

FACE OF FINISH

FACE OF STUD

FOOT OR FEET

FIELD VERIFY

GALVANIZED

GENERAL

GYPSUM

HOSEBIB

HOUR

JANITOR

JOINT

KITCHEN

LAMINATE

LAVATORY 1

MAXIMUM

MECHANICAL

MEMBRANE

MEZZANINE

MINIMUM

MOUNTED

MOUNTING

MULLION

NORTH

NUMBER

NOMINAL

OVER

NOT TO SCALE

MANUFACTURER

MISCELLANEOUS

NOT IN CONTRACT

MASONRY OPENING

METAL

JANITOR'S CLOSET

MEDIUM DENSITY FIBERBOARD

HANDICAPPED

HORIZONTAL

HOLLOW METAL

FURRING

FUTURE

FACE OF PLYWOOD

F.E.C.

FIN.

F.H.C.

FLUOR.

F.O.P.

F.O.S.

GALV.

GSM.

GEN.

GWB

HORIZ.

H.W.H.

INSUL.

JAN.

MECH.

MEMB.

MET.

MFR.

MIN

MTG.

MUL.

N.T.S.

GYP.

FORCED AIR UNIT

FIRE EXTINGUISHER

FIRE HOSE CABINET


FIRE EXTINGUISHER CABINET

FIRE RETARDANT OR FIRE RATED

GALVANIZED SHEET METAL

GENERAL CONTRACTOR

GYPSUM WALL BOARD

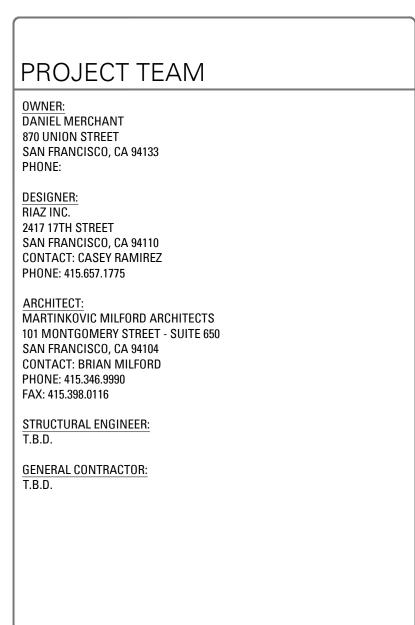

LOCATION MAP -ALADDIN TERRACE -KENT ST -- PROJECT LOCATION

0.A.

0.C.

P.LAM.

P.L.F.

P.S.F.

PT.

R.F.P.

RM.

PLYWD. PLYWOOD

OVERALL

POINT


ON CENTER

OUTSIDE FACE OF STUD


PLASTIC LAMINATE


870 UNION STREET RESIDENCE ADDITION AND REMODEL


870 UNION STREET SAN FRANCISCO, CALIFORNIA 94133

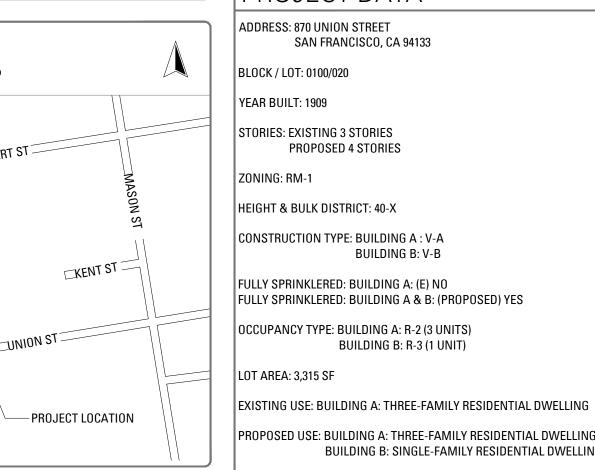

ECT DATA	SCOPE OF WORK
0 UNION STREET AN FRANCISCO, CA 94133	SCOPE OF WORK INCLUDES THE DEMOLITION OF EXISTING WALLS, WINDOWS, DOORS, FINISHES AND FIXTURES. SCOPE TO INCLUDE LOWERING TOP 2 FLOORS OF (E) STRUCTURE TO
0100/020	ACCOMODATE (N) WORK ON ROOF. CONSTRUCTION OF NEW
1909	WALLS, DOORS, FINISHES AND FIXTURES. CONSTRUCTION AT EXISTING BUILDING WITH AN ADDITIONAL 4TH FLOOR AND DECKS. CONSTRUCTION OF REAR ADDITION AT ALL THREE
STING 3 STORIES DPOSED 4 STORIES	FLOORS WITH COURTYARD ON GROUND FLOOR. EXTERIOR WORK INCLUDES NEW WINDOW, DOOR, AND FINISHES. CONSTRUCTION OF (N) REAR YARD STRUCTURE FACING
1	ALADDIN TERRACE.
LK DISTRICT: 40-X	SCOPE OF WORK TO INCLUDE A FULLY AUTOMATIC SPRINKLER SYSTEM. NFPA STANDARD SYSTEM TYPE TO BE
ON TYPE: BUILDING A : V-A BUILDING B: V-B	DETERMINED BY SFFD.

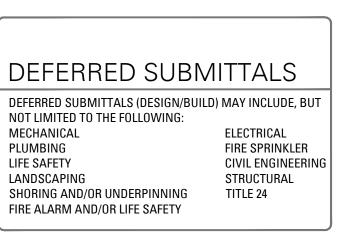

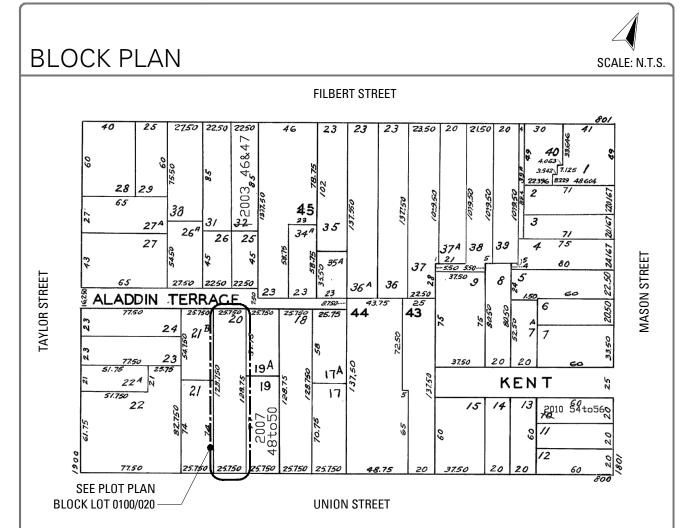

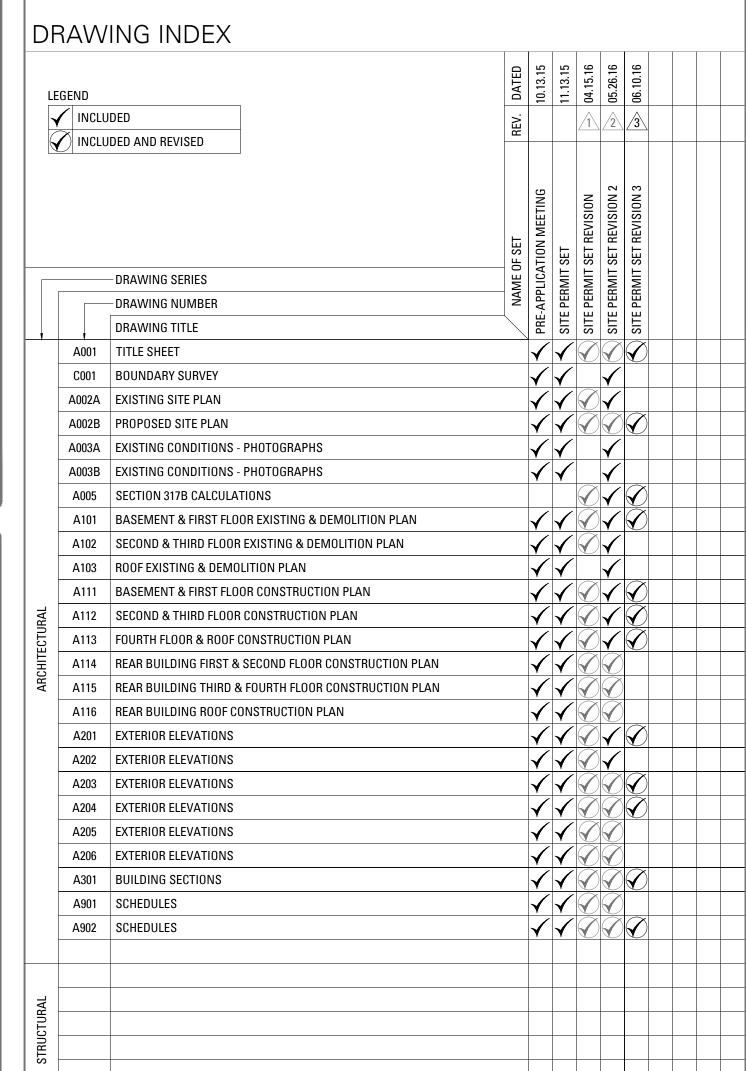


870 Union Street Residence Addition and Remodel

> 870 UNION STREET, SAN FRANCISCO, CA 94133

MARTINKOVIC MILFORD ARCHITED

101 Montgomery Street Suite 650 San Francisco, CA 94104 T 415 346 9990

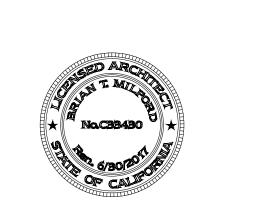

APPLICABLE CODES

BUILDING B: R-3 (1 UNIT)

BUILDING B: SINGLE-FAMILY RESIDENTIAL DWELLING

2013 CALIFORNIA BUILDING CODE 2013 CALIFORNIA ELECTRICAL CODE 2013 CALIFORNIA MECHANICAL CODE 2013 CALIFORNIA PLUMBING CODE

EXISTING BUILDING A:

UNIT 1 EXISTING: 345 SF

UNIT 1 PROPOSED: 350 SF

UNIT 2 EXISTING: 1,141 SF

UNIT 3 EXISTING: 1,259 SF

PROPOSED BUILDING B:

UNIT 4 PROPOSED: 2,877 SF

EXISTING GARAGE AND CORRIDORS: N/A

PROPOSED GARAGE AND CORRIDORS: 669 SF

UNIT 4 EXISTING: N/A

UNIT 3 PROPOSED: 2,761 SF

UNIT 2 PROPOSED: 1,316 SF

AREA OF WORK: ±8,229 S.F.

2013 CALIFORNIA FIRE CODE POUNDS PER LINEAR FOOT 2013 CALIFORNIA ENERGY CODE POUNDS PER SQUARE FEET 2013 CALIFORNIA GREEN BUILDING CODE

PARTITION RISER REFERENCE REFRIGERATOR

REQUIRED REINFORCED FIBERGLASS PANEL ROUGH OPENING SOUTH

S.C.D. SEE CIVIL DRAWINGS SCHED. SCHEDULE SECTION S.E.D. SEE ELECTRICAL DRAWINGS SF SQUARE FEET S.I.D. SEE INTERIOR DRAWINGS SIM SIMILAR

S.M.D. SEE MECHANICAL DRAWINGS SPEC. SPECIFICATION SQUARE SEE STRUCTURAL DRAWINGS STAINLESS STEEL STD. STANDARD

STL. STEEL HEIGHT STOR. STORAGE HOT WATER DISPENSER STRUCT. STRUCTURAL HOT WATER HEATER TREAD TILE COUNCIL OF AMERICA INSULATION INTERIOR TO BE DETERMINED

T&G

T.0.S.

TYP

U.O.N.

UTIL.

V.C.T.

VERT.

V.I.F.

X OR x

VERTICAL

VOLUME

WITH

WOOD

WITHOUT

WEIGHT

YARD

VERIFY IN FIELD

WEST OR WIDTH

WATER CLOSET

WHERE OCCURS

WATERPROOF

TONGUE AND GROOVE TELEPHONE **TEMPORARY** THICK TOP OF TOP OF SLAB T.0.W. TOP OF WALL

TYPICAL UNDERWRITERS LABORATORY UNLESS OTHERWISE NOTED UNIT 1 EXISTING BEDROOMS: UTILITY UNIT 1 PROPOSED BEDROOMS: 1 VARIES UNIT 2 EXISTING BEDROOMS: 2 VINYL COMPOSITION TILE


> UNIT 3 PROPOSED BEDROOMS: 2 PROPOSED BUILDING B: UNIT 4 EXISTING BEDROOMS: N/A UNIT 4 PROPOSED BEDROOMS: 3


> > TOTAL EXISTING BEDROOMS: 5 TOTAL PROPOSED BEDROOMS: 7

UNIT 2 PROPOSED BEDROOMS: 1

UNIT 3 EXISTING BEDROOMS: 2

2013 CALIFORNIA BUILDING ENERGY EFFICIENCY STANDARDS 2013 SAN FRANCISCO BUILDING CODE AMENDMENTS 2013 SAN FRANCISCO ELECTRICAL CODE AMENDMENTS 2013 SAN FRANCISCO MECHANICAL CODE AMENDMENTS 2013 SAN FRANCISCO PLUMBING CODE AMENDMENTS 2013 SAN FRANCISCO FIRE CODE AMENDMENTS 2013 SAN FRANCISCO GREEN BUILDING CODE AMENDMENTS 2013 SAN FRANCISCO HOUSING CODE AMENDMENTS AREA OF WORK. SEE SITE PLANS A002A & A002B -EXISTING & PROPOSED UNIT AREAS 25 0T EXISTING COMMON AREAS AND COMMON STAIRS: 926 SF PROPOSED COMMON AREAS AND COMMON STAIRS: 746 SF TOTAL EXISTING (FRONT STRUCTURE) BUILDING AREA: 3,671 S TOTAL PROPOSED (FRONT STRUCTURE) BUILDING AREA: 5,173 SF TOTAL EXISTING (REAR STRUCTURE) BUILDING AREA: 0 SF TOTAL PROPOSED (REAR STRUCTURE) BUILDING AREA: 3,546 SF

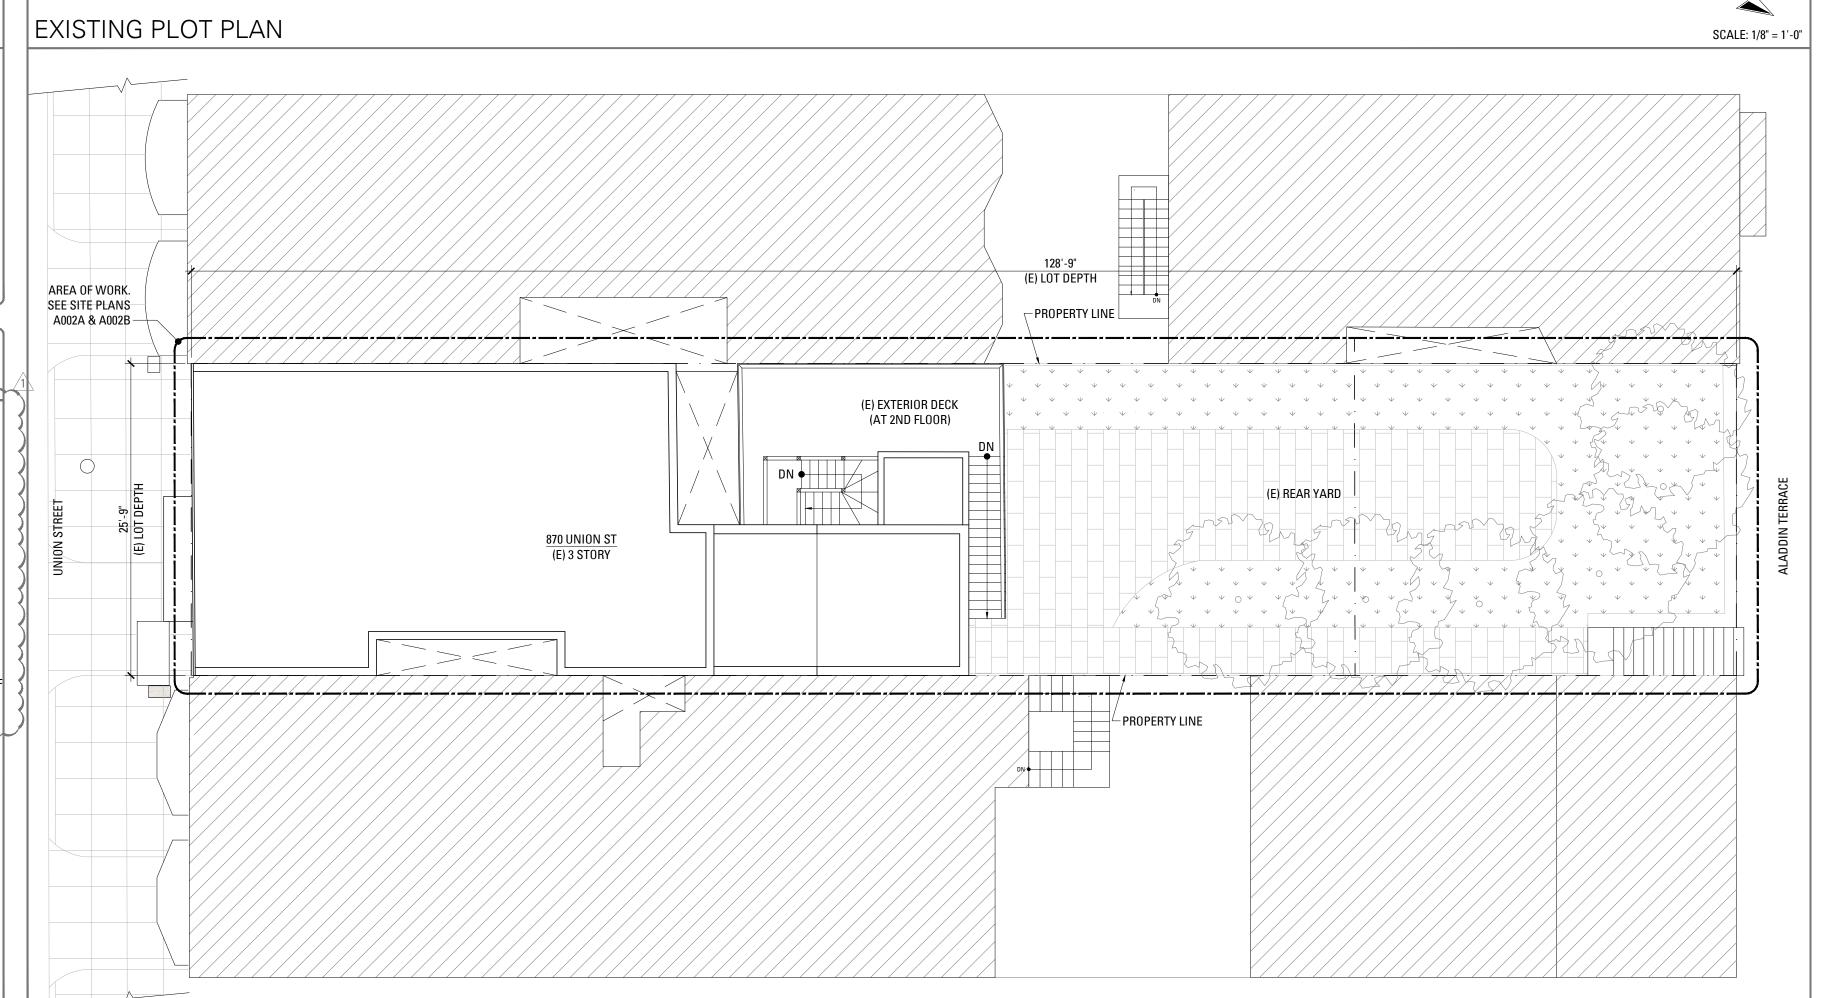


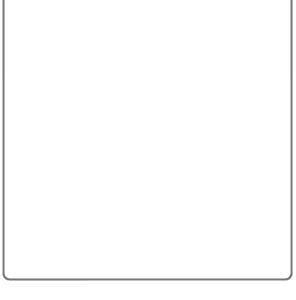

RECORD OF DRAWING ISSUANCE PRE-APP MEETING 10.13.2015 11.13.2015 SITE PERMIT SET SITE PERMIT SET REV. 04.27.2016 SITE PERMIT SET REV. 2 05.26.2016 SITE PERMIT SET REV. 3

SITE PERMIT SET REVISION 3		
Drawn By:	S.A.	
Checked By:	B.M.	
Project Number:	1554.1	

Title Sheet

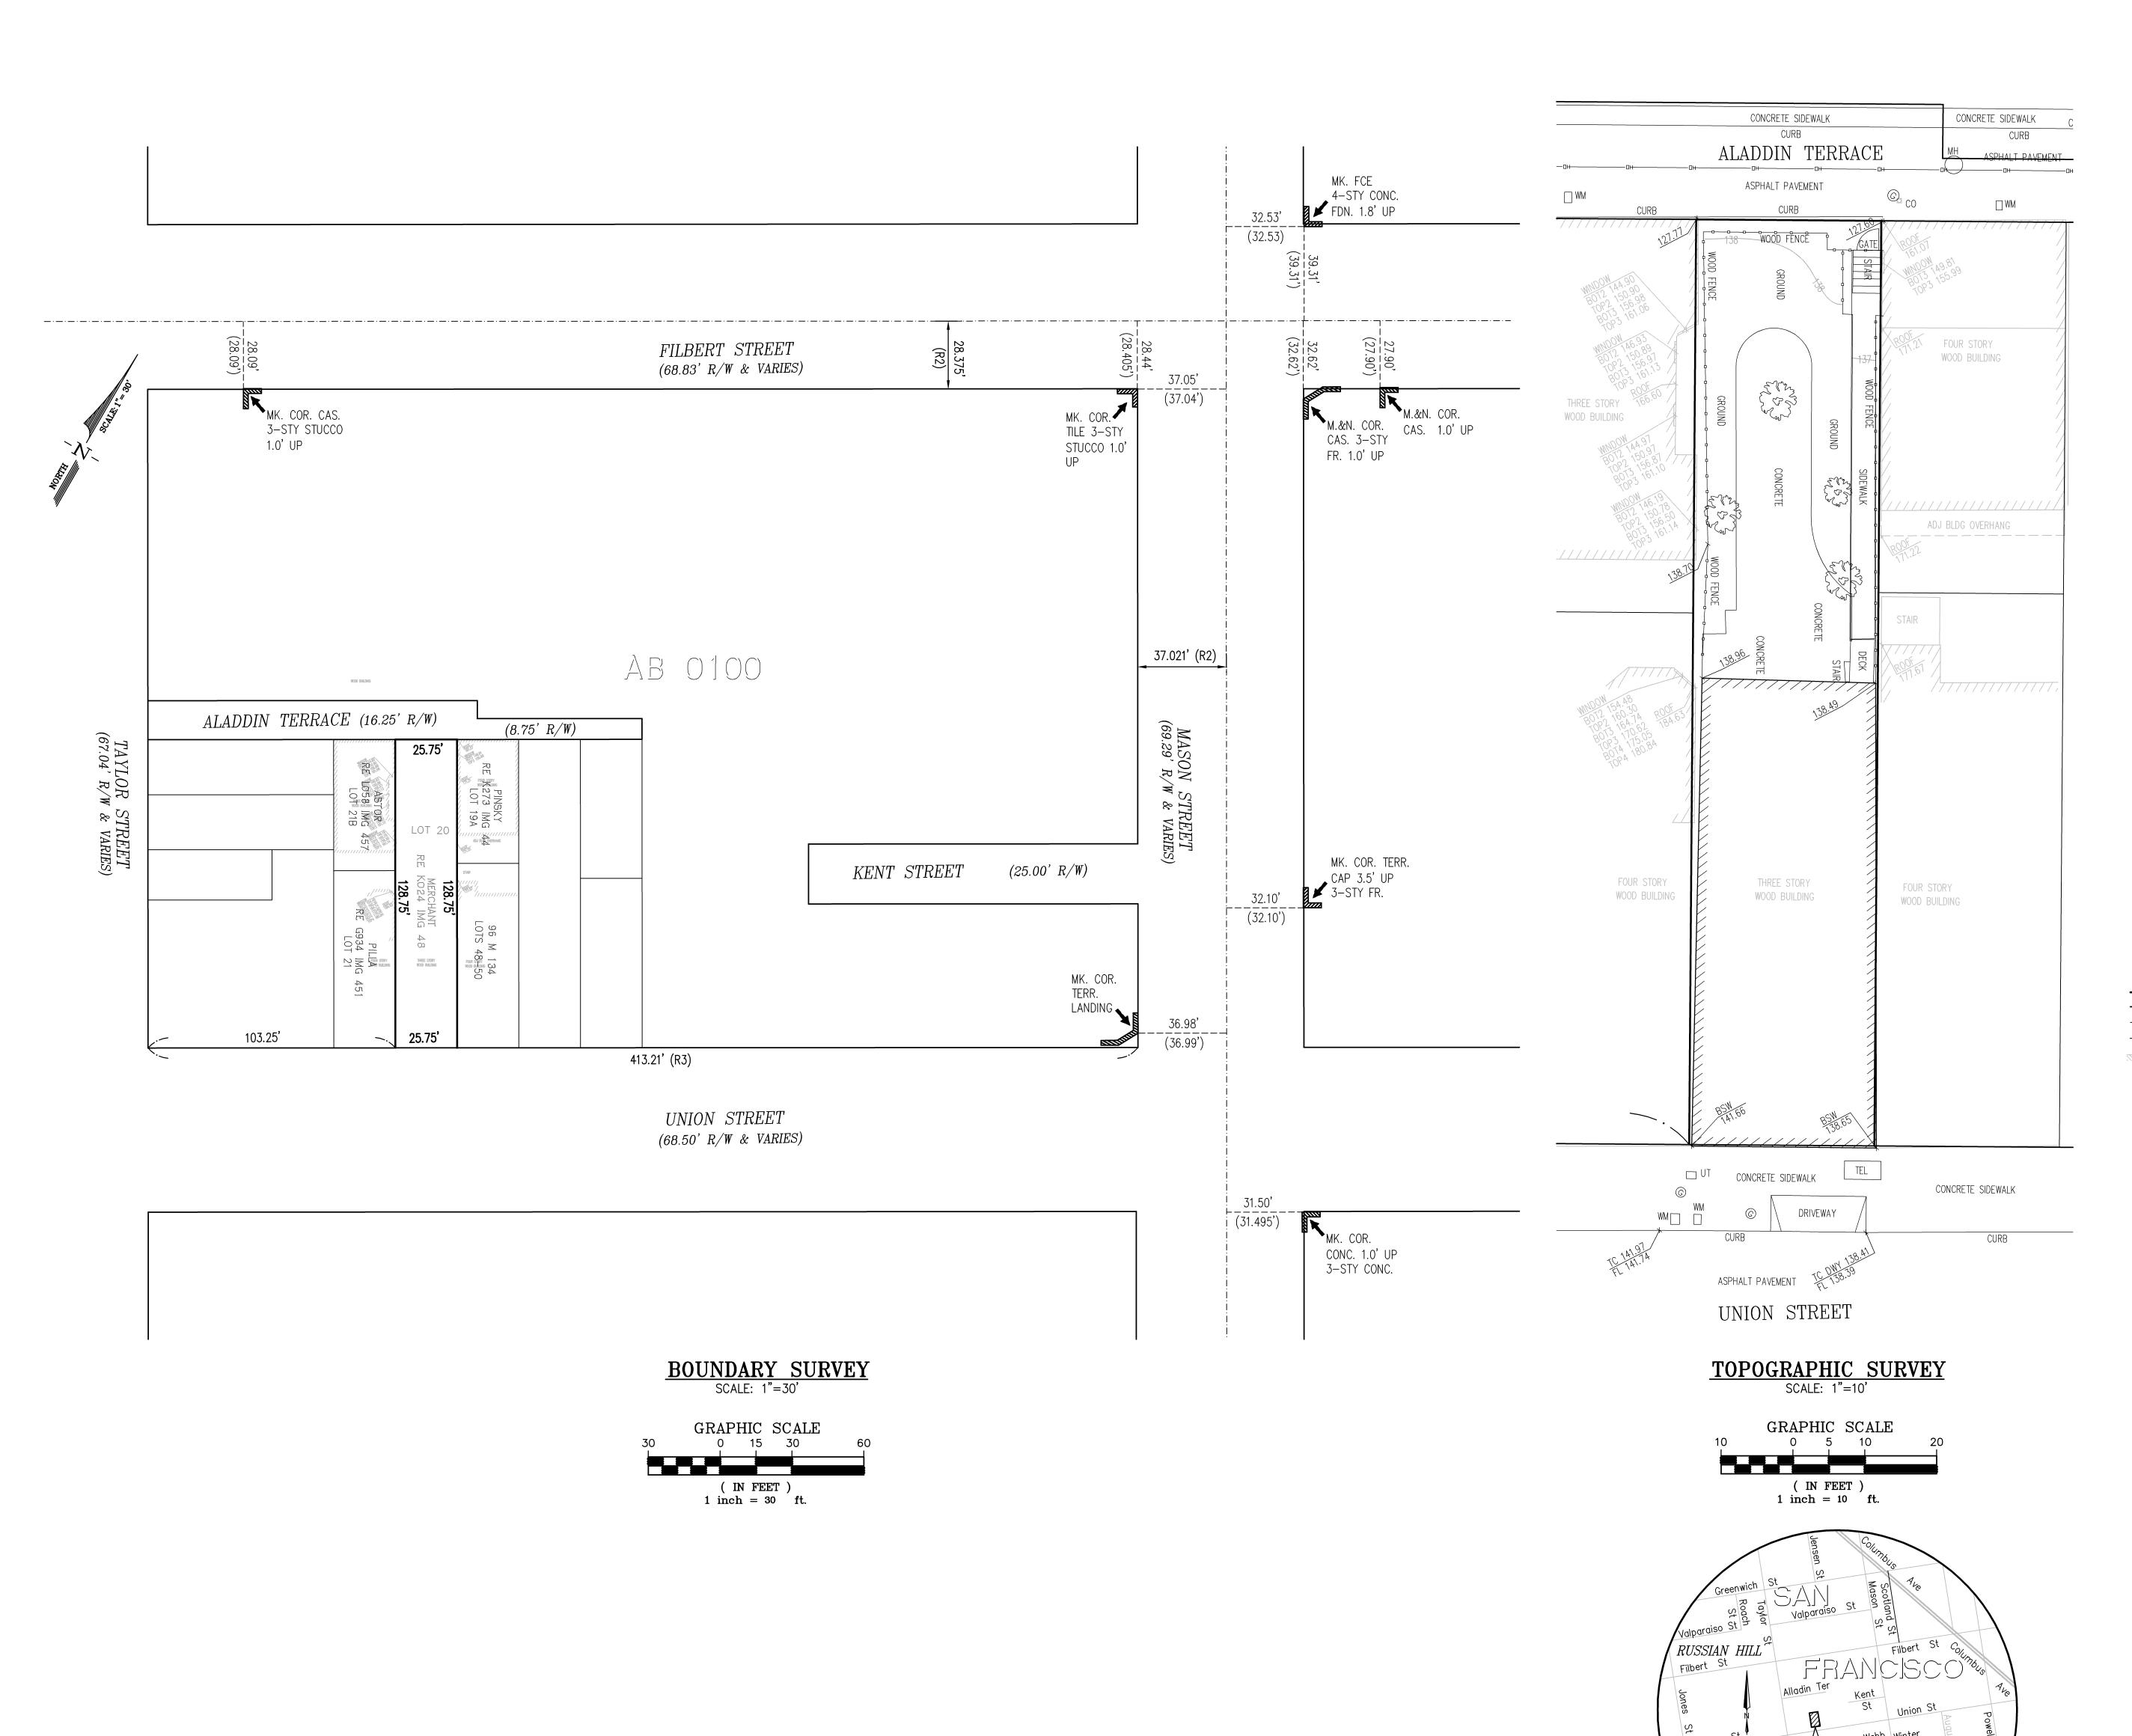

GENERAL NOTES:

2. ENGINEER/SURVEYOR:

DANIEL MERCHANT 1. OWNER/DEVELOPER:

872 UNION STREET SAN FRANCISCO, CA 94123 (310) 422-3931

LUK AND ASSOCIATES 738 ALFRED NOBEL DRIVE HERCULES, CA 94547 JACKIE LUK PLS 8934

(510) 724-3388

3. ASSESSOR'S PARCEL NO.: BLOCK 100 LOT 20

870, 872 & 872A UNION STREET, SAN FRANCISCO, CA 94123 4. PROPERTY ADDRESS:

5. LOT AREA: 3315 S.F.± (0.08 ACRE±)

6. EASEMENTS AND/OR RIGHTS OF WAY ARE SHOWN HEREON PER THE "PTR". OTHER EASEMENTS AND/OR RIGHTS OF WAY OF RECORD, IF ANY, ARE NOT SHOWN HEREON.

7. THE UTILITIES SHOWN HEREON ARE BY SURFACE OBSERVATION AND RECORD INFORMATION ONLY AND NO WARRANTY IS GIVEN HEREIN AS TO THEIR EXACT LOCATION. IT IS THE RESPONSIBILITY OF THE DEVELOPER AND/OR CONTRACTOR TO VERIFY THE EXACT LOCATION OF THE UTILITIES WITH THE APPROPRIATE UTILITY COMPANY OR AGENCY.

8. ALL ANGLES ARE 90°UNLESS OTHERWISE NOTED.

9. CONTOUR INTERVAL: 1 FOOT

10. NUMBER OF RESIDENTIAL UNITS: 3



RECORD REFERENCES

(R1) GRANT DEED RECORDED NOVEMBER 20, 2009 ON REEL K024 AT IMAGE 0048, DOCUMENT NUMBER 2009-1875013-00, ON FILE IN THE OFFICE OF THE RECORDER OF THE CITY AND COUNTY OF SAN FRANCISCO.

(R2) MONUMENT MAP NO. 8 ON FILE IN THE OFFICE OF THE CITY AND COUNTY

(R3) BLOCK DIAGRAM OF 50 VARA BLOCK 181 ON FILE IN THE OFFICE OF THE CITY AND COÚNTY SURVEYOR.

BENCHMARK

BENCHMARK AS SHOWN ON THE CITY OF SAN FRANCISCO BENCHMARK BOX 1, BOOK 421 AT PAGE 41, BEING A CUT CROSS ON THE WEST SIDE OF THE LOWER TERRAZZO STEP, 23 FEET WEST OF THE NORTHWEST CORNER AT THE INTERSECTION OF TAYLOR STREET AND UNION STREET, ELEVATION = 157.724 FEET, CITY AND COUNTY OF SAN FRANCISCO DATUM.

LEGEND

<u>SYMBOLS</u>	DESCRIPTION	<u>SYMBOLS</u>	<u>DESCRIPTION</u>
	BOUNDARY — SUBJECT PROPERTY RIGHT—OF—WAY LINE ADJOINERS PROPERTY LINE MONUMENT LINE BUILDING LINE	□ WM □ TEL □ UT ○ CO □ JP	WATER METER TELEPHONE BOX UTILITIES BOX CLEAN OUT JOINT POLE MANHOLE
\odot	FOUND MONUMENT AS NOTED	○ MH Ŵ WV	WATER VALVE
(T)	TOTAL	Ğ GV	GAS VALVE
DOC. NO.	DOCUMENT NUMBER		OVERHEAD POWER LINE
X 141.97	TOP FACE OF CURB ELEVATION	<u></u>	- WOOD FENCE - CONTOUR LINE
X 141.74	FLOW LINE ELEVATION		TREE
AC	ASPHALT CONCRETE	OR	OFFICIAL RECORD
BLDG	BUILDING	R1	RECORD REFERENCE
BSW	BACK OF SIDEWALK	(266.81')	RECORD DISTANCE
CONC	CONCRETE	3	LOT NUMBER
GB	GRADE BREAK	IMG	IMAGE
GRD	GROUND	R/W	RIGHT OF WAY
TRW	TREEWELL	APN	ASSESSOR'S PARCEL NUMBER
TFC TW	TOP FACE OF CURB TOP FACE OF WALL	PTR	PRELIMINARY TITLE REPORT
DWY	DRIVEWAY	RE. PGS	REEL PAGES

TENTATIVE PARCEL MAP

PROJECT

VICINITY MAP

NO SCALE


A RESIDENTIAL 3 UNIT CONDOMINIUM PROJECT 870, 872, AND 872A UNION STREET

BEING A SUBDIVISION OF THAT CERTAIN REAL PROPERTY AS DESCRIBED IN THAT CERTAIN GRANT DEED RECORDED NOVEMBER 20, 2009, AS REEL KO24, IMAGE 0048 OF OFFICIAL RECORDS OF THE CITY AND COUNTY OF SAN FRANCISCO. ALSO BEING A SUBDIVISION OF LOT 20, ASSESSOR'S BLOCK 0100. ALSO BEING A PART OF 50 VARA BLOCK NO. 181.

> CITY AND COUNTY OF SAN FRANCISCO, CALIFORNIA SCALE: AS SHOWN APRIL 2015

PREPARED BY LUK & ASSOCIATES CIVIL ENGINEERS — LAND PLANNERS — LAND SURVEYORS 738 ALFRED NOBEL DRIVE HERCULES, CALIFORNIA 94547 (510) 724-3388

SHEET 1 JOB NO: 13059A10

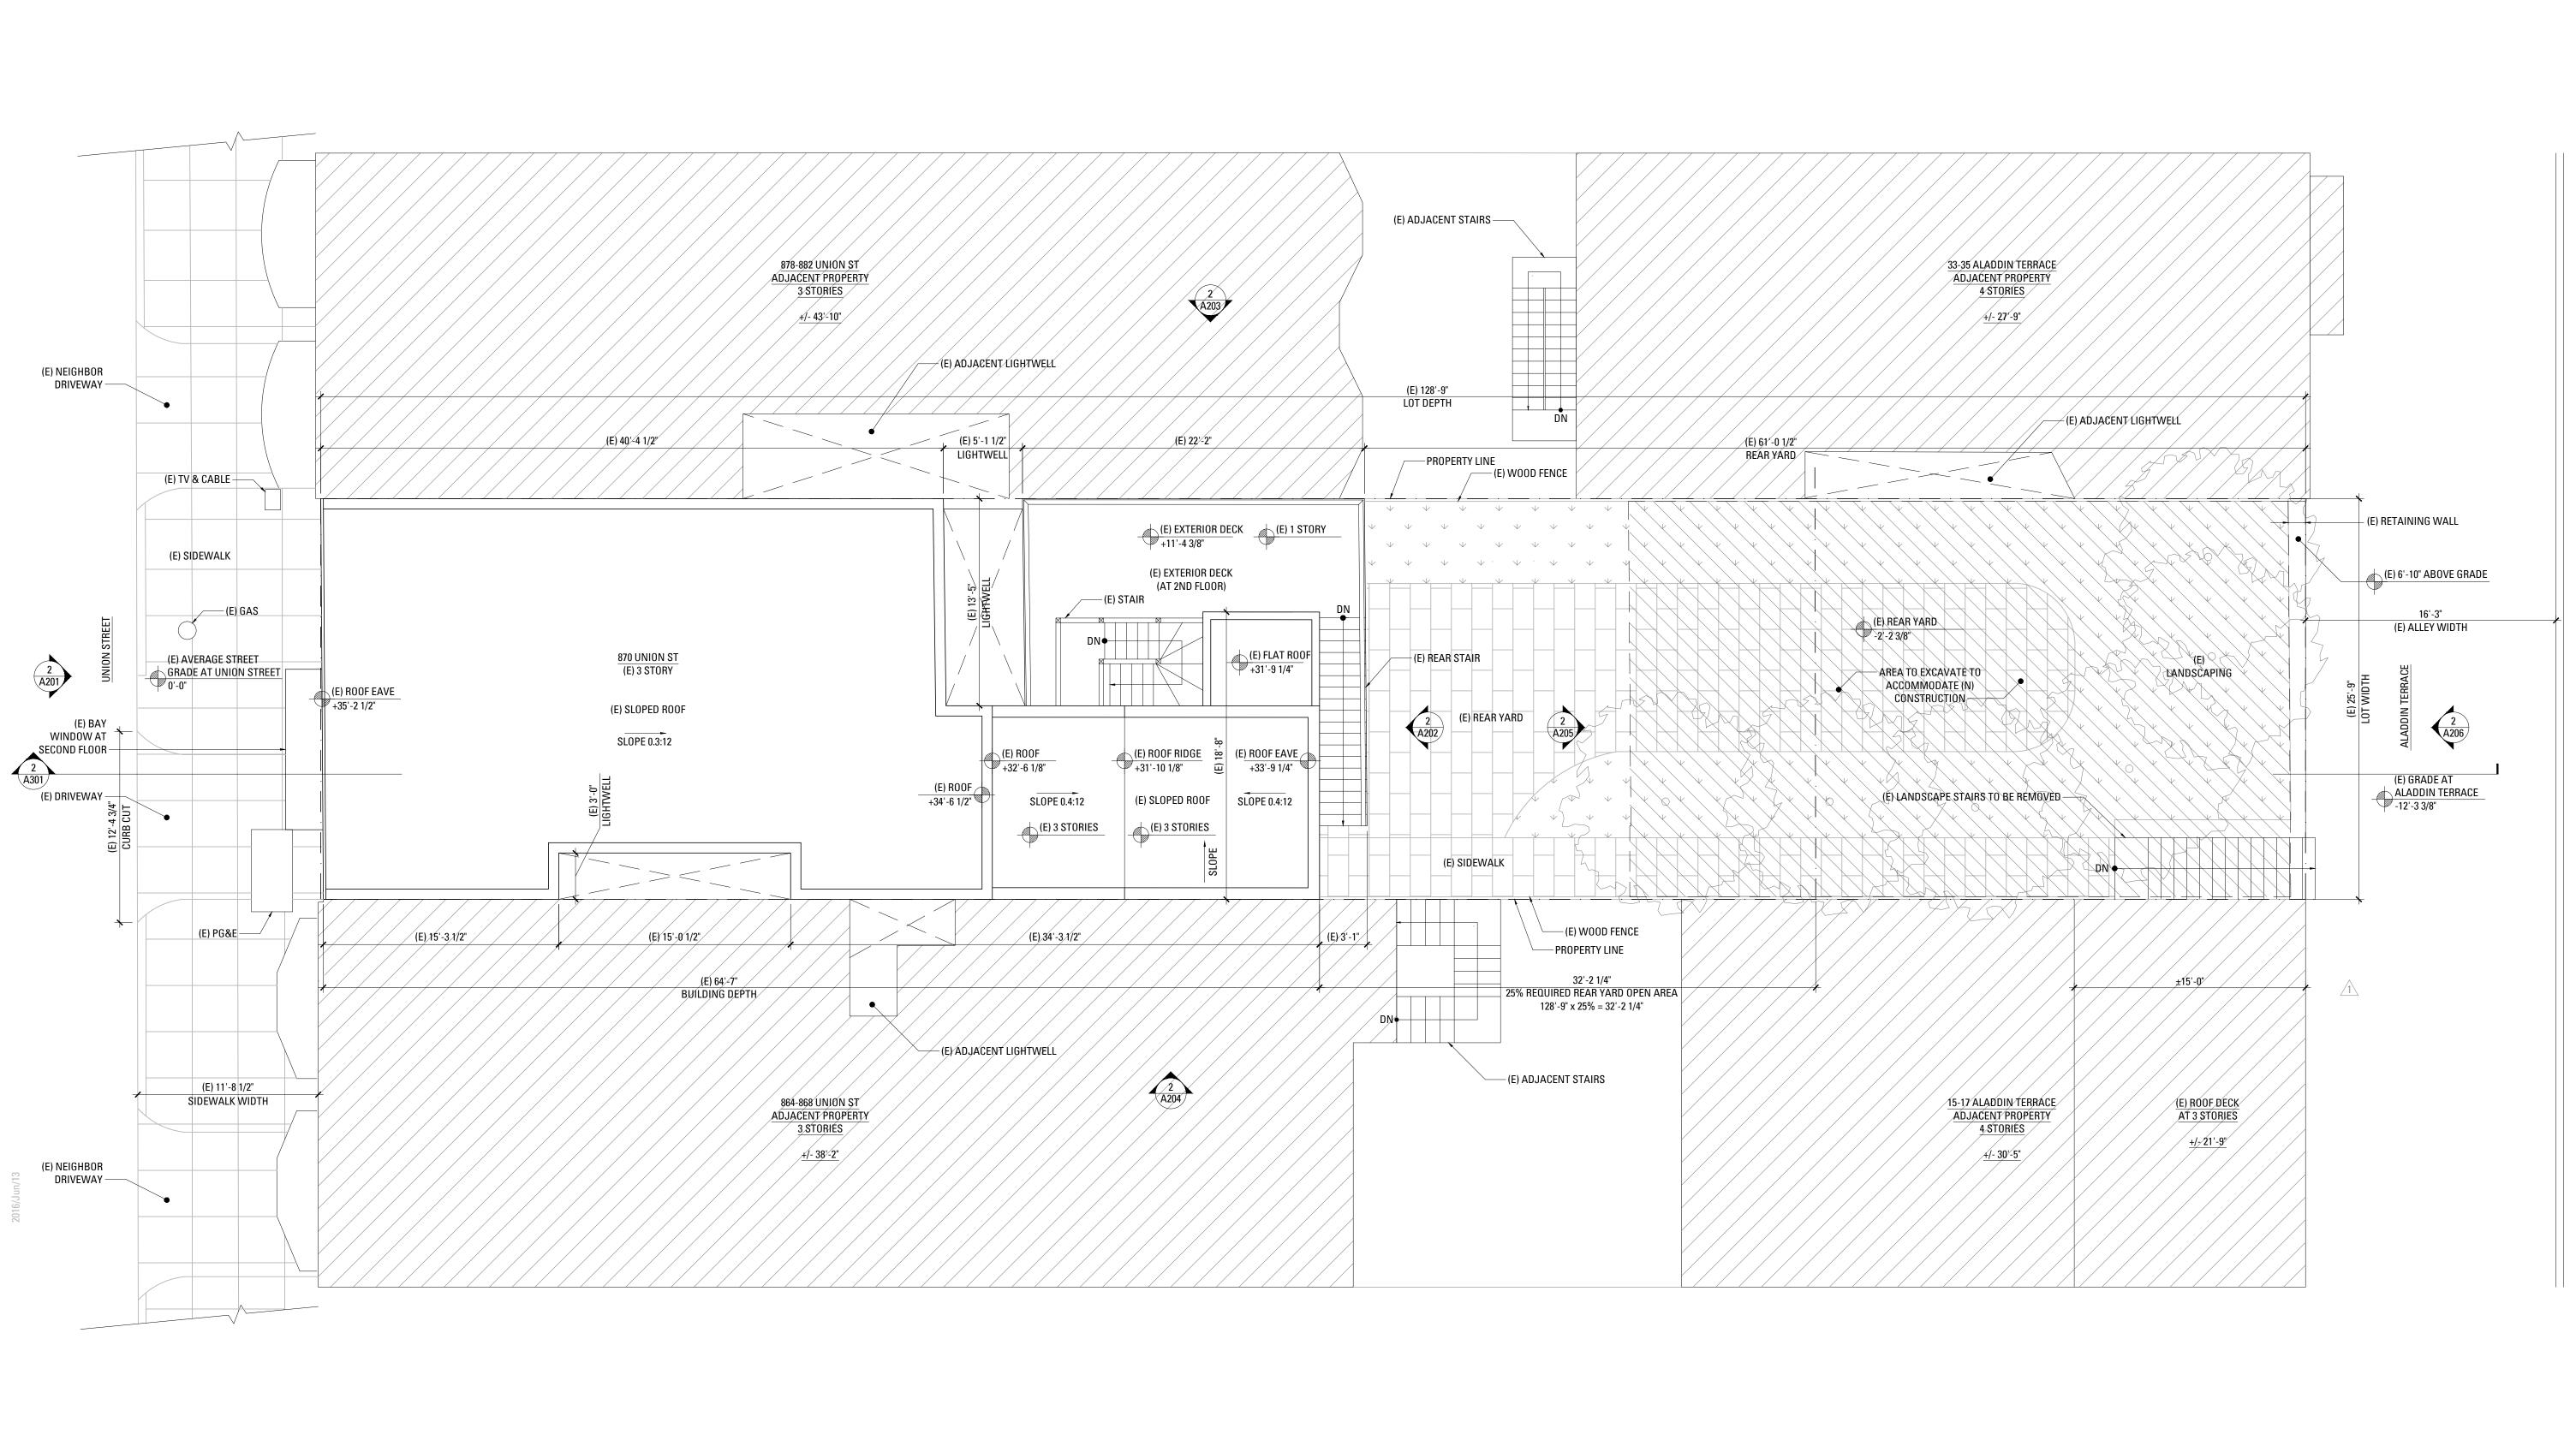


870 Union Street Residence Addition and Remodel


> 870 UNION STREET, SAN FRANCISCO, CA 94133

MARTINKOVIC MILFORD ARCHITECTS

101 Montgomery Street Suite 650 San Francisco, CA 94104 T 415 346 9990



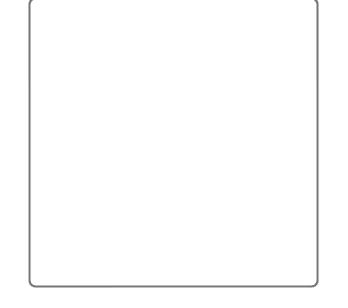

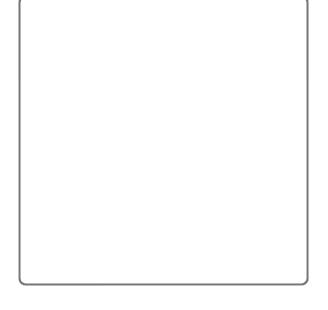

PRE-APP MEETING	10.13.2
SITE PERMIT SET	11.13.2
SITE PERMIT SET REV.	<u></u>
SITE PERMIT SET REV. 2	2 05.26.2
SITE PERMIT SET REV. 3	<u>3</u> 06.10.2

,	SITE PER REVIS	
	Drawn By:	S.A.
	Checked By :	B.M.
	Project Number:	1554.1


Existing Site Plan

870 UNION STREET, SAN FRANCISCO, CA 94133







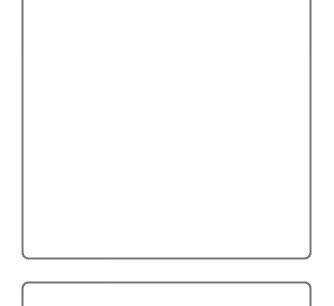




PRE-APP MEETING	 10.13.20
SITE PERMIT SET	11.13.20
SITE PERMIT SET REV.	04.27.20
SITE PERMIT SET REV. 2	05.26.20
SITE PERMIT SET REV. 3	06.10.20

SITE PER REVIS	
Drawn By:	S.A.
Checked By:	B.M.
Project Number:	1554.1


Proposed Site Plan

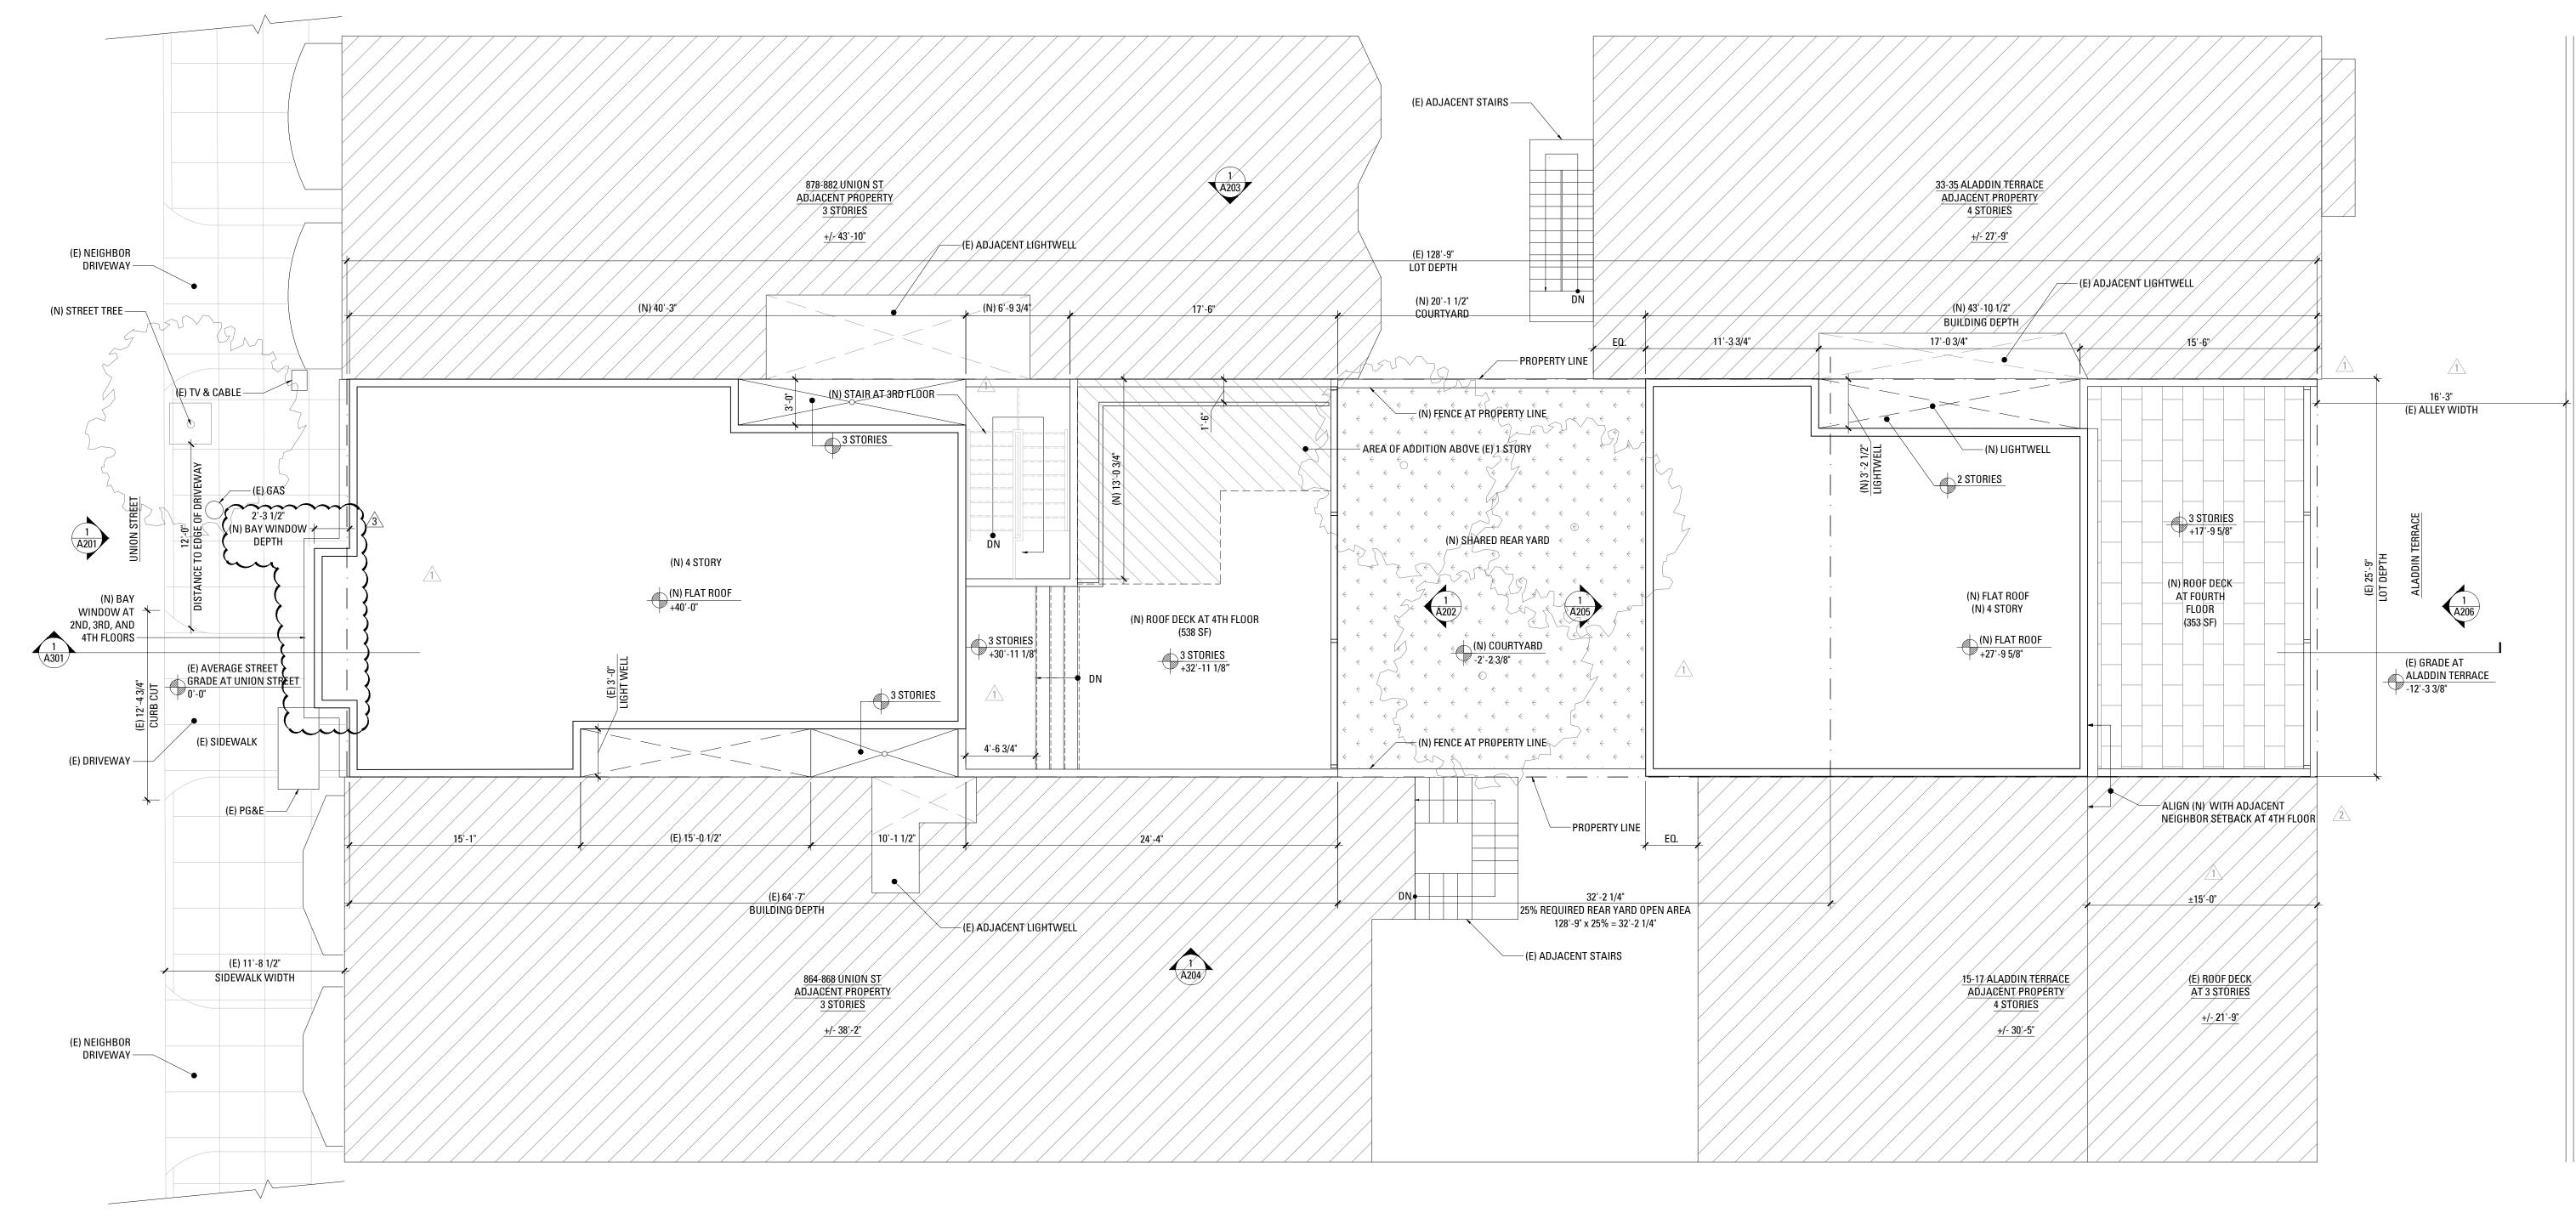

870 UNION STREET, SAN FRANCISCO, CA 94133

MARTINKOVIC MILFORD ARCHITECTS

101 Montgomery Street Suite 650 San Francisco, CA 94104 T 415 346 9990

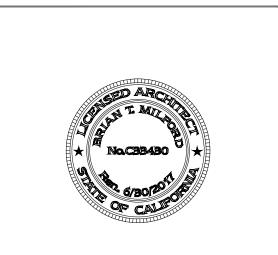





2 SOUTH SIDE OF UNION STREET (ACROSS THE STREET FROM SUBJECT PROPERTY) SCALE: NTS

— 857 UNION ST

— 847, 849 UNION ST



– 878, 880, 882 UNION ST





864, 866, 868 UNION ST ——

881, 883, 885 UNION ST ———

858, 860 862 UNION ST —

887, 889 UNION ST ——



852, 854, 856 UNION ST —

RECORD OF DRAWING ISSUANCE	CE
PRE-APP MEETING	10.13.201
SITE PERMIT SET	11.13.201
SITE PERMIT SET REV.	04.27.2010
SITE PERMIT SET REV. 2	2 05.26.2010
SITE PERMIT SET REV. 3	3 06.10.2010

SITE PERMIT SET REVISION 3		
Drawn By:	S.A.	
Checked By:	B.M.	
Project Number:	1554.1	

Existing Photographs

SHEET NUMBER

A003A

- X.8 4900 X - X.9 2000 X - X.9

870 Union Street Residence Addition and Remodel

> 870 UNION STREET, SAN FRANCISCO, CA 94133

MARTINKOVIC MILFORD ARCHITECTS

101 Montgomery Street Suite 650 San Francisco, CA 94104 T 415 346 9990



____ 33, 35 ALADDIN ST

NORTH SIDE OF ALADDIN STREET (ACROSS THE STREET FROM SUBJECT PROPERTY)

SCALE: NTS

____15 ALADDIN ST

PROJECT PROPERTY

PRE-APP MEETING

10.13.2015

SITE PERMIT SET

SITE PERMIT SET REV.

10.13.2015

11.13.2015

SITE PERMIT SET REV.

205.26.2016

SITE PERMIT SET REV. 3

306.10.2016


SITE PERMIT SET
REVISION 3

Drawn By: S.A.
Checked By: B.M.
Project Number: 1554.1

Existing Photographs

SHEET NUMBER

A003B

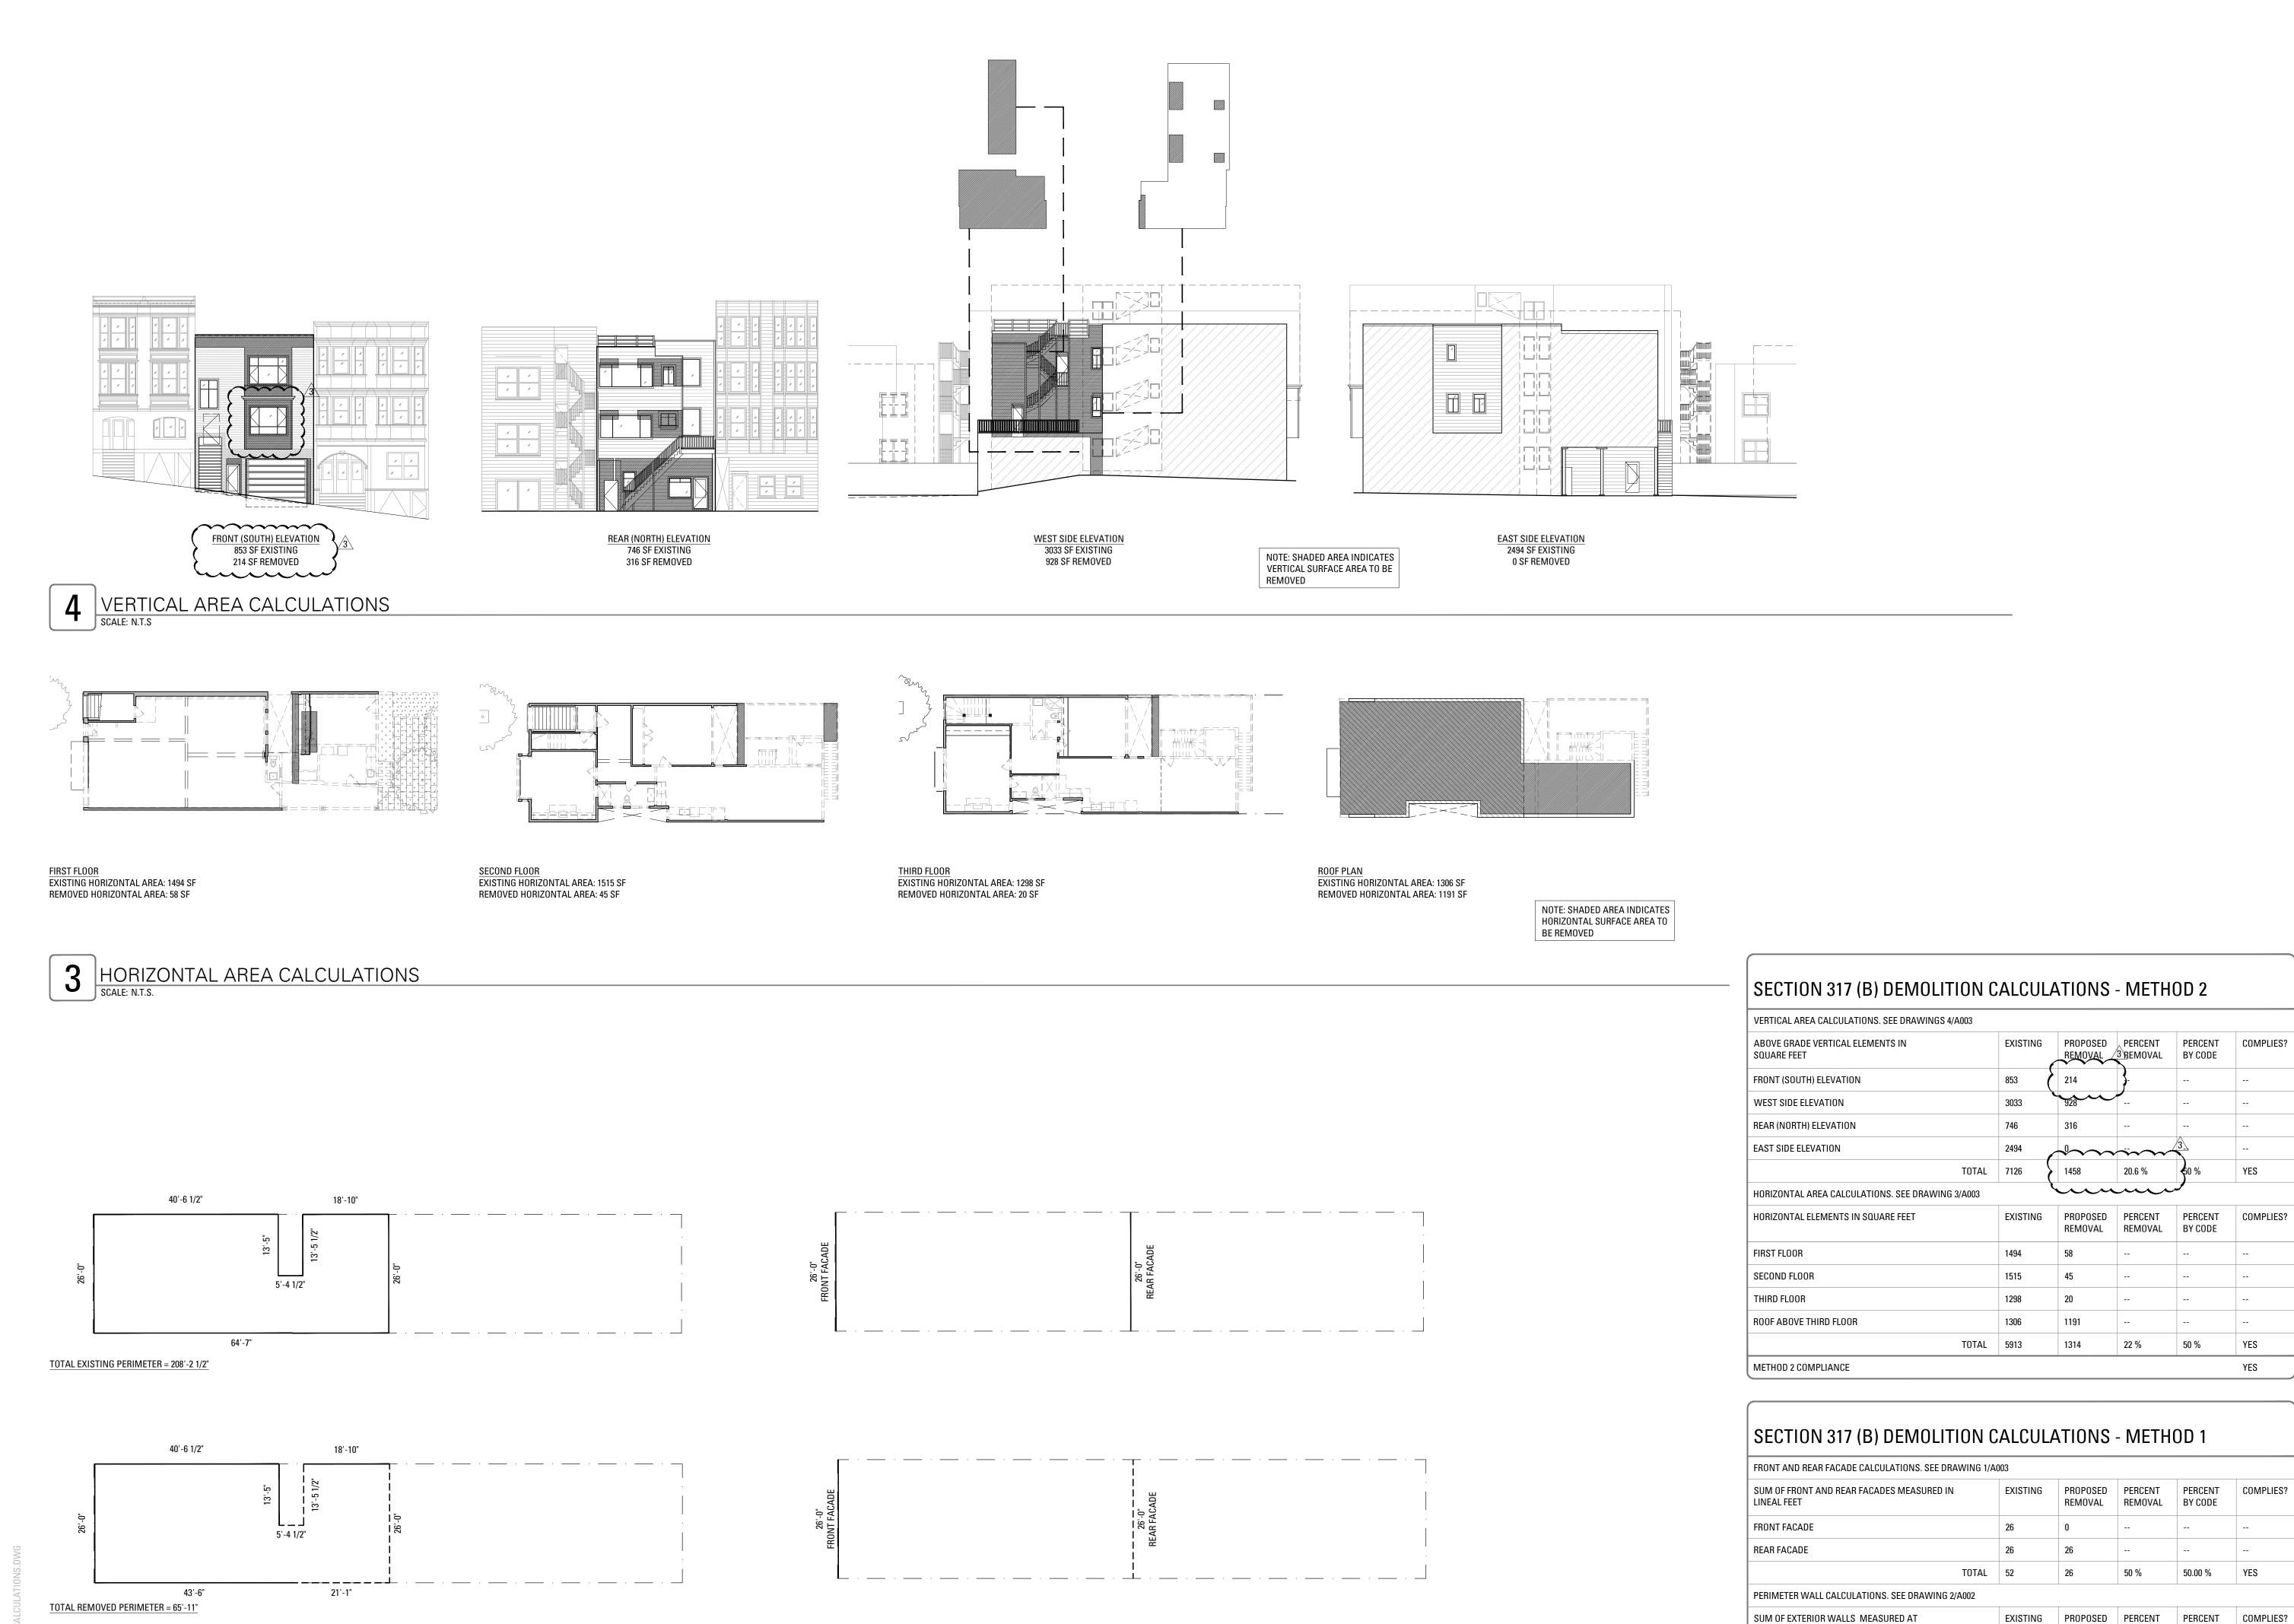

FRONT AND REAR - LINEAR FEET

PERIMETER WALLS - LINEAR FEET SCALE: N.T.S.

870 Union Street Residence Addition and Remodel

870 UNION STREET, SAN FRANCISCO, CA 94133

MARTINKOVIC MILFORD ARCHITECT

101 Montgomery Street Suite 650 San Francisco, CA 94104 T 415 346 9990



	_
RECORD OF DRAWING ISSUANO	CE
PRE-APP MEETING	10.13.2015
SITE PERMIT SET	11.13.2015
SITE PERMIT SET REV.	04.27.2016
SITE PERMIT SET REV. 2	2 05.26.2016
SITE PERMIT SET REV. 3	3 06.10.2016

SITE PERMIT SET REV.	J <u>/1</u> 04.27.201
SITE PERMIT SET REV. 2	2 05.26.201
SITE PERMIT SET REV. 3	<u>3</u> 06.10.201

YES

REMOVAL REMOVAL BY CODE

208'-2 1/2" 65'-11" 31.66 % 65.00 % YES

FOUNDATION LEVEL


METHOD 1 COMPLIANCE


PERIMETER


DASHED LINE INDICATES LINEAR DIMENSION OF WALL TO BE REMOVED

SITE PERMIT SET REVISION 3					
Drawn By:	S.A.				
Checked By:	B.M.				
Project Number:	1554.1				

Section 317B Calculations

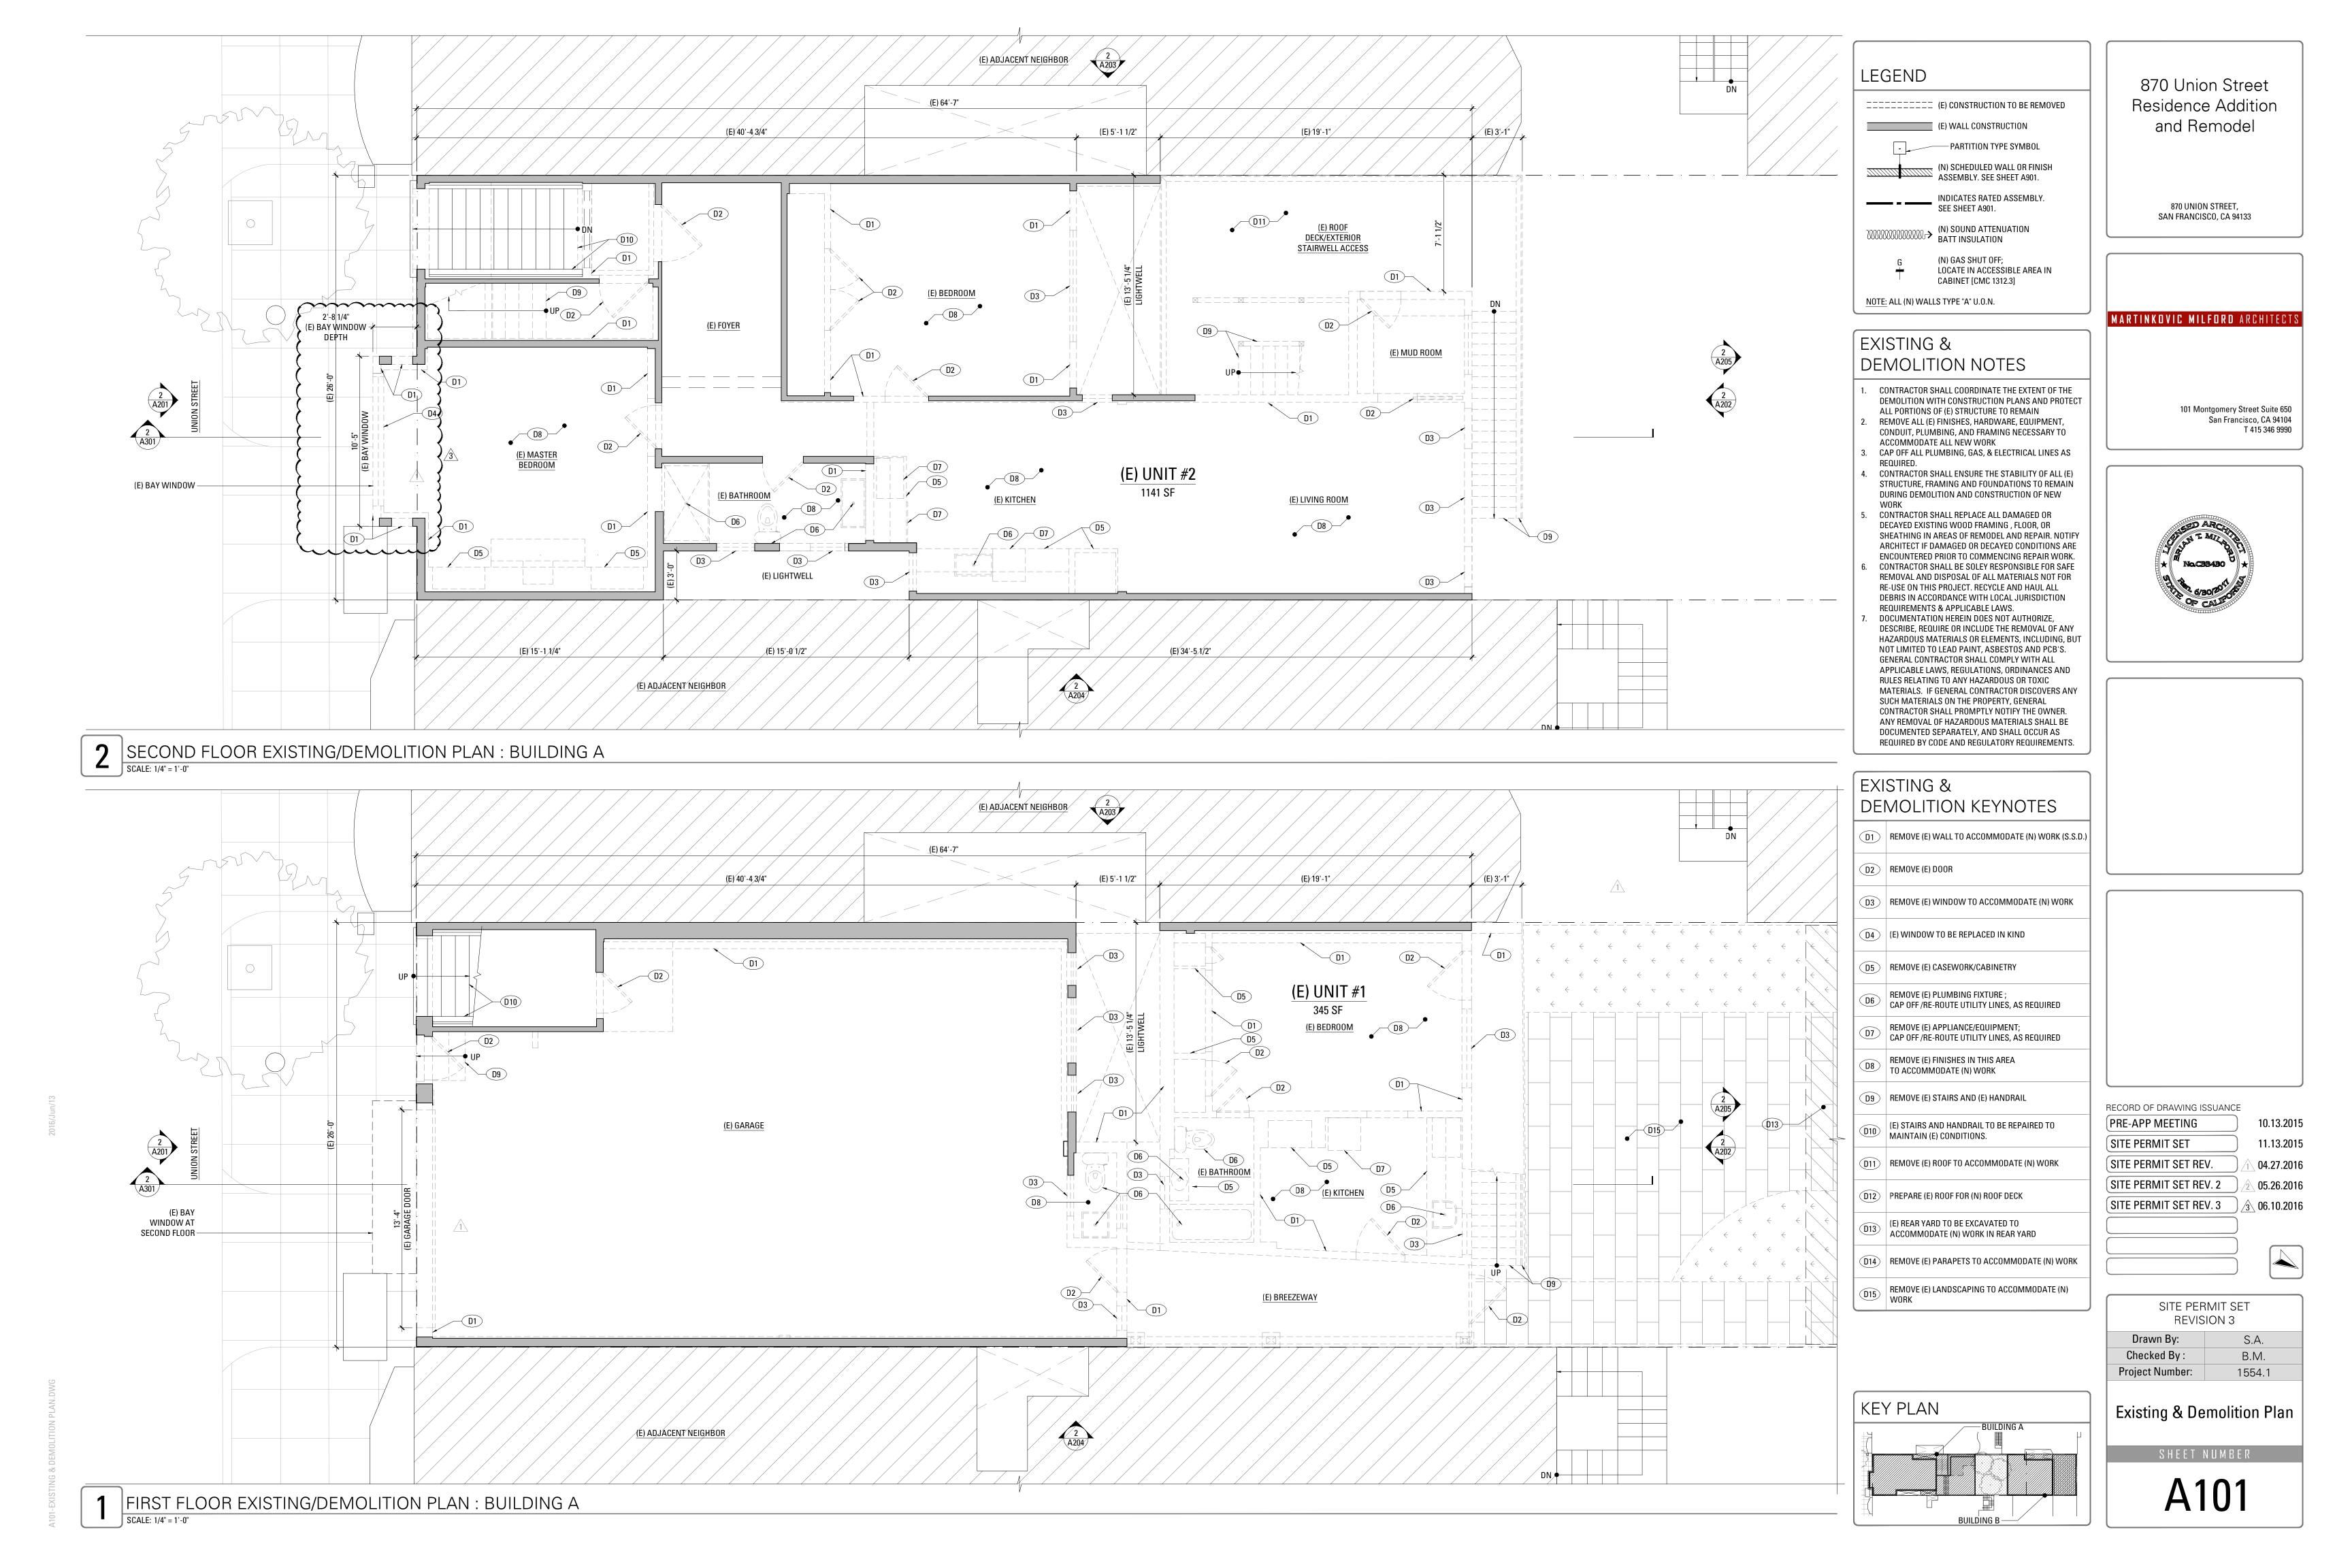

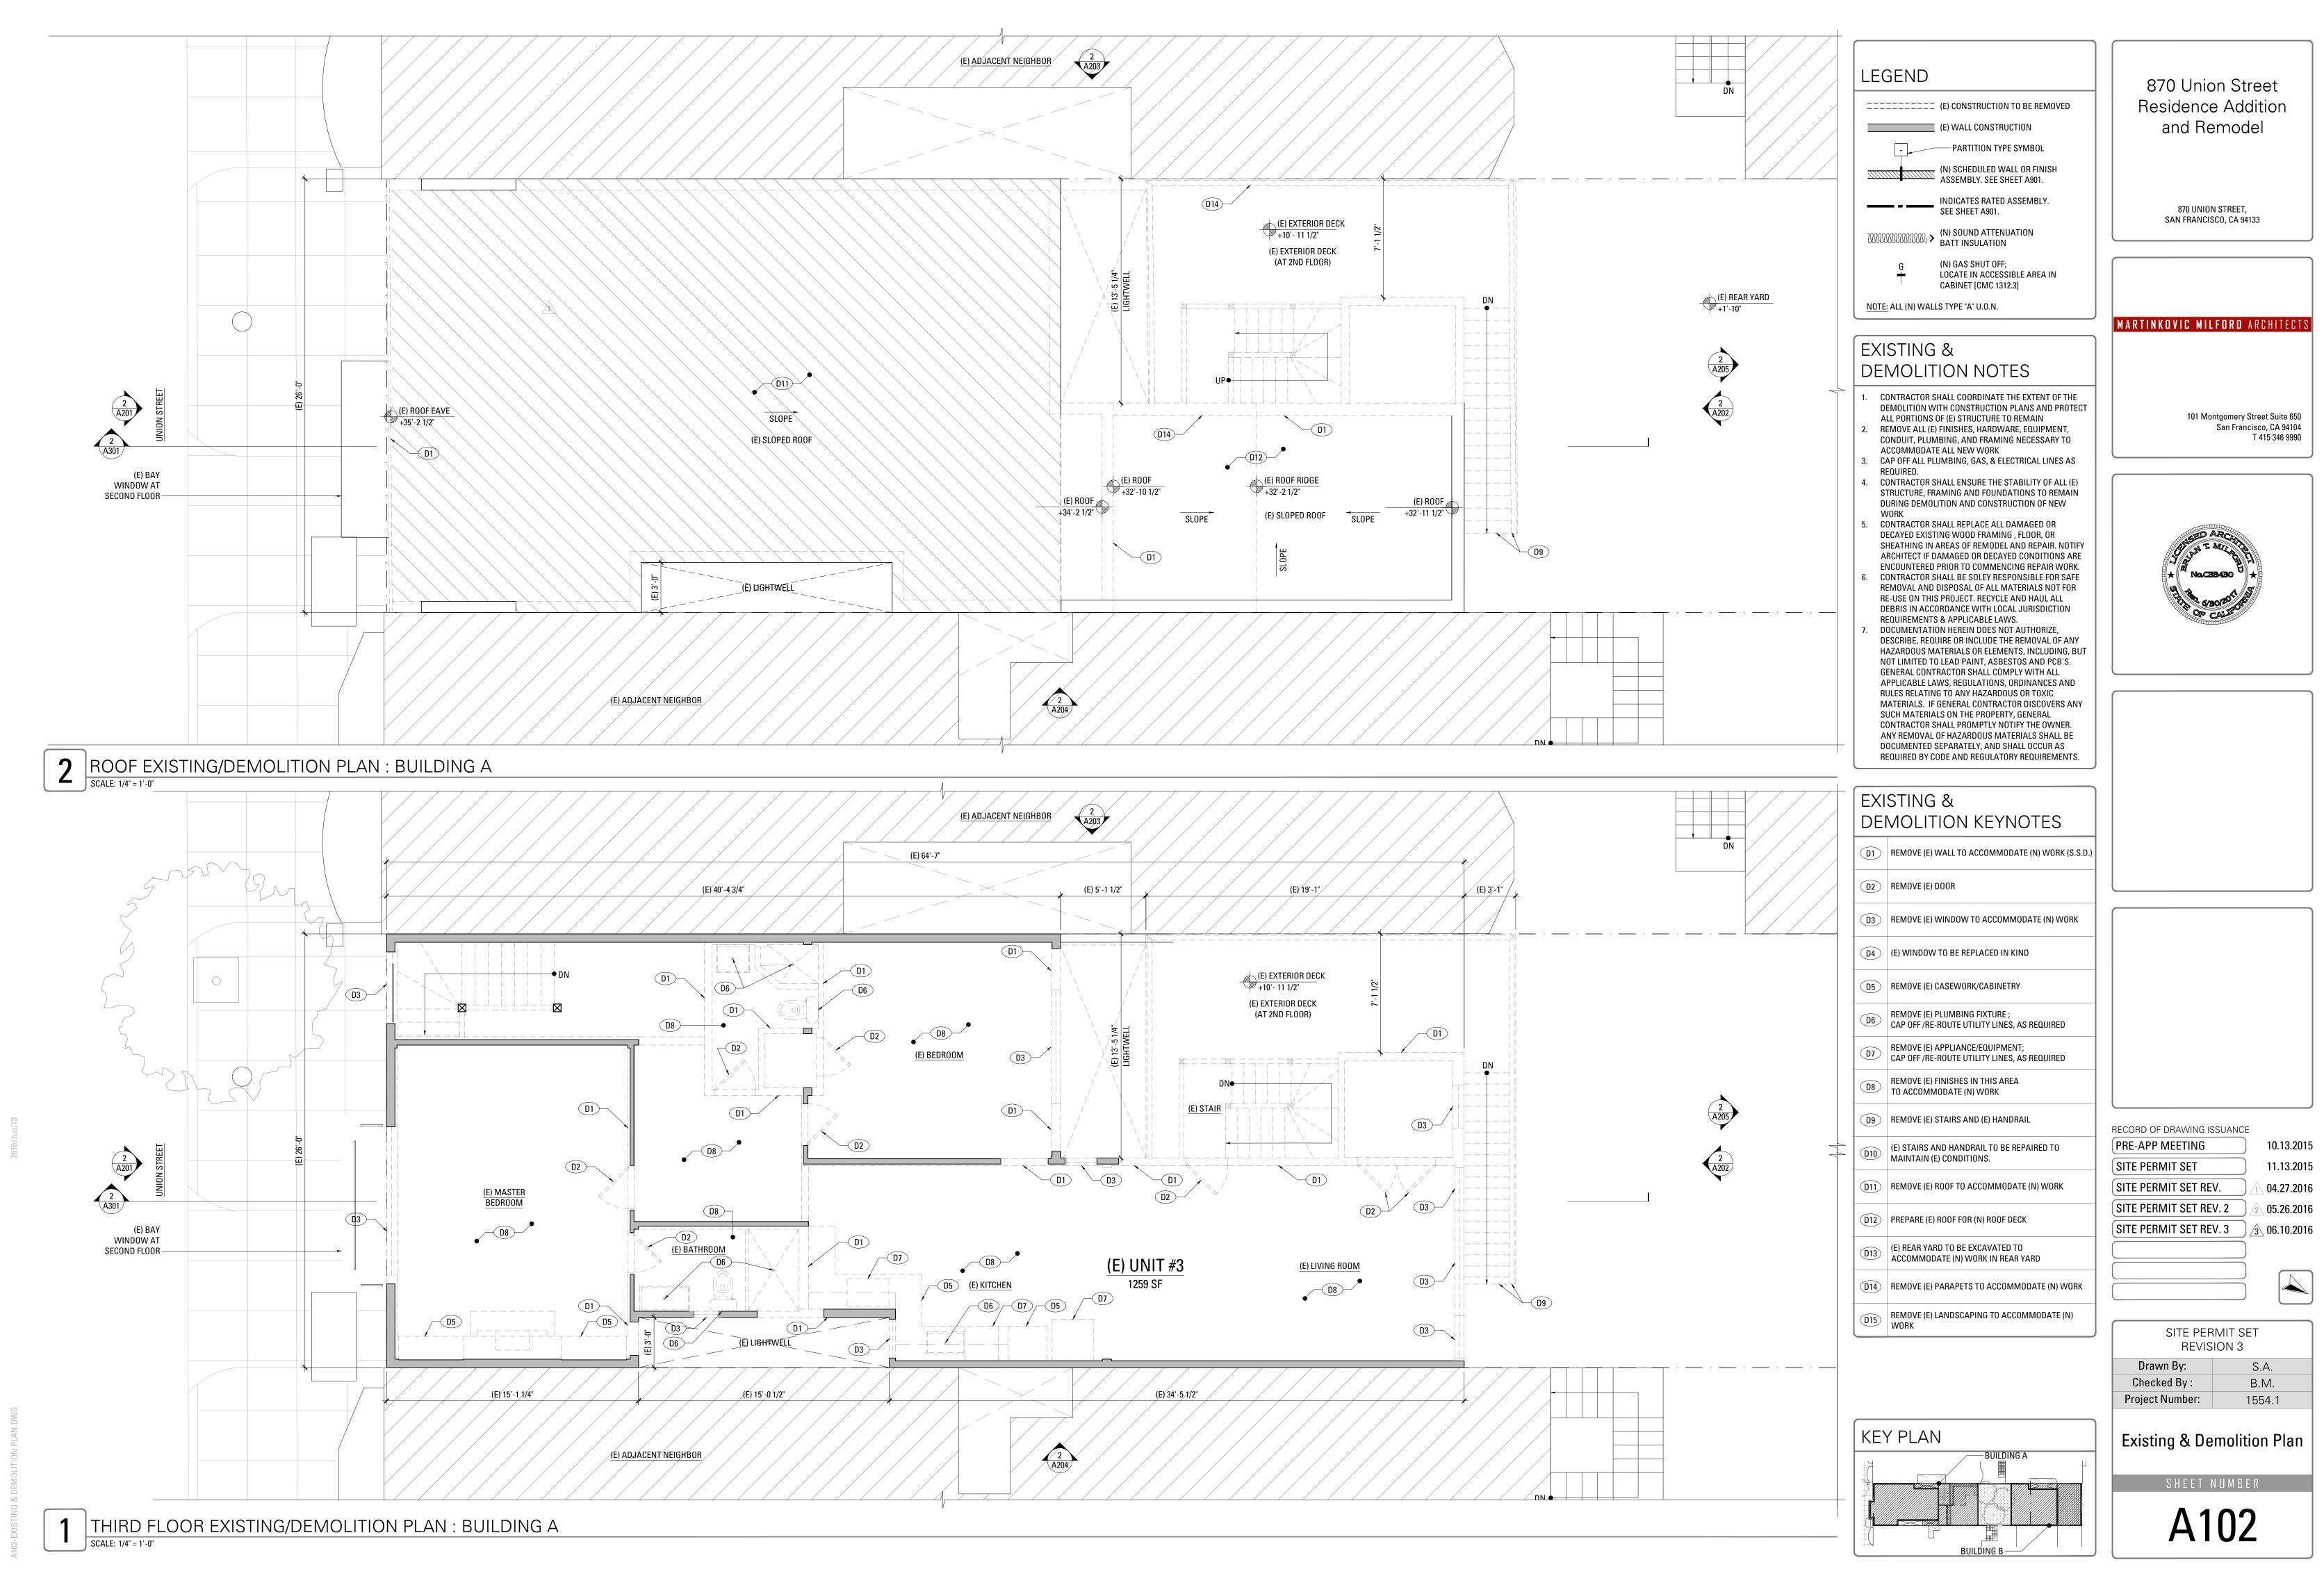

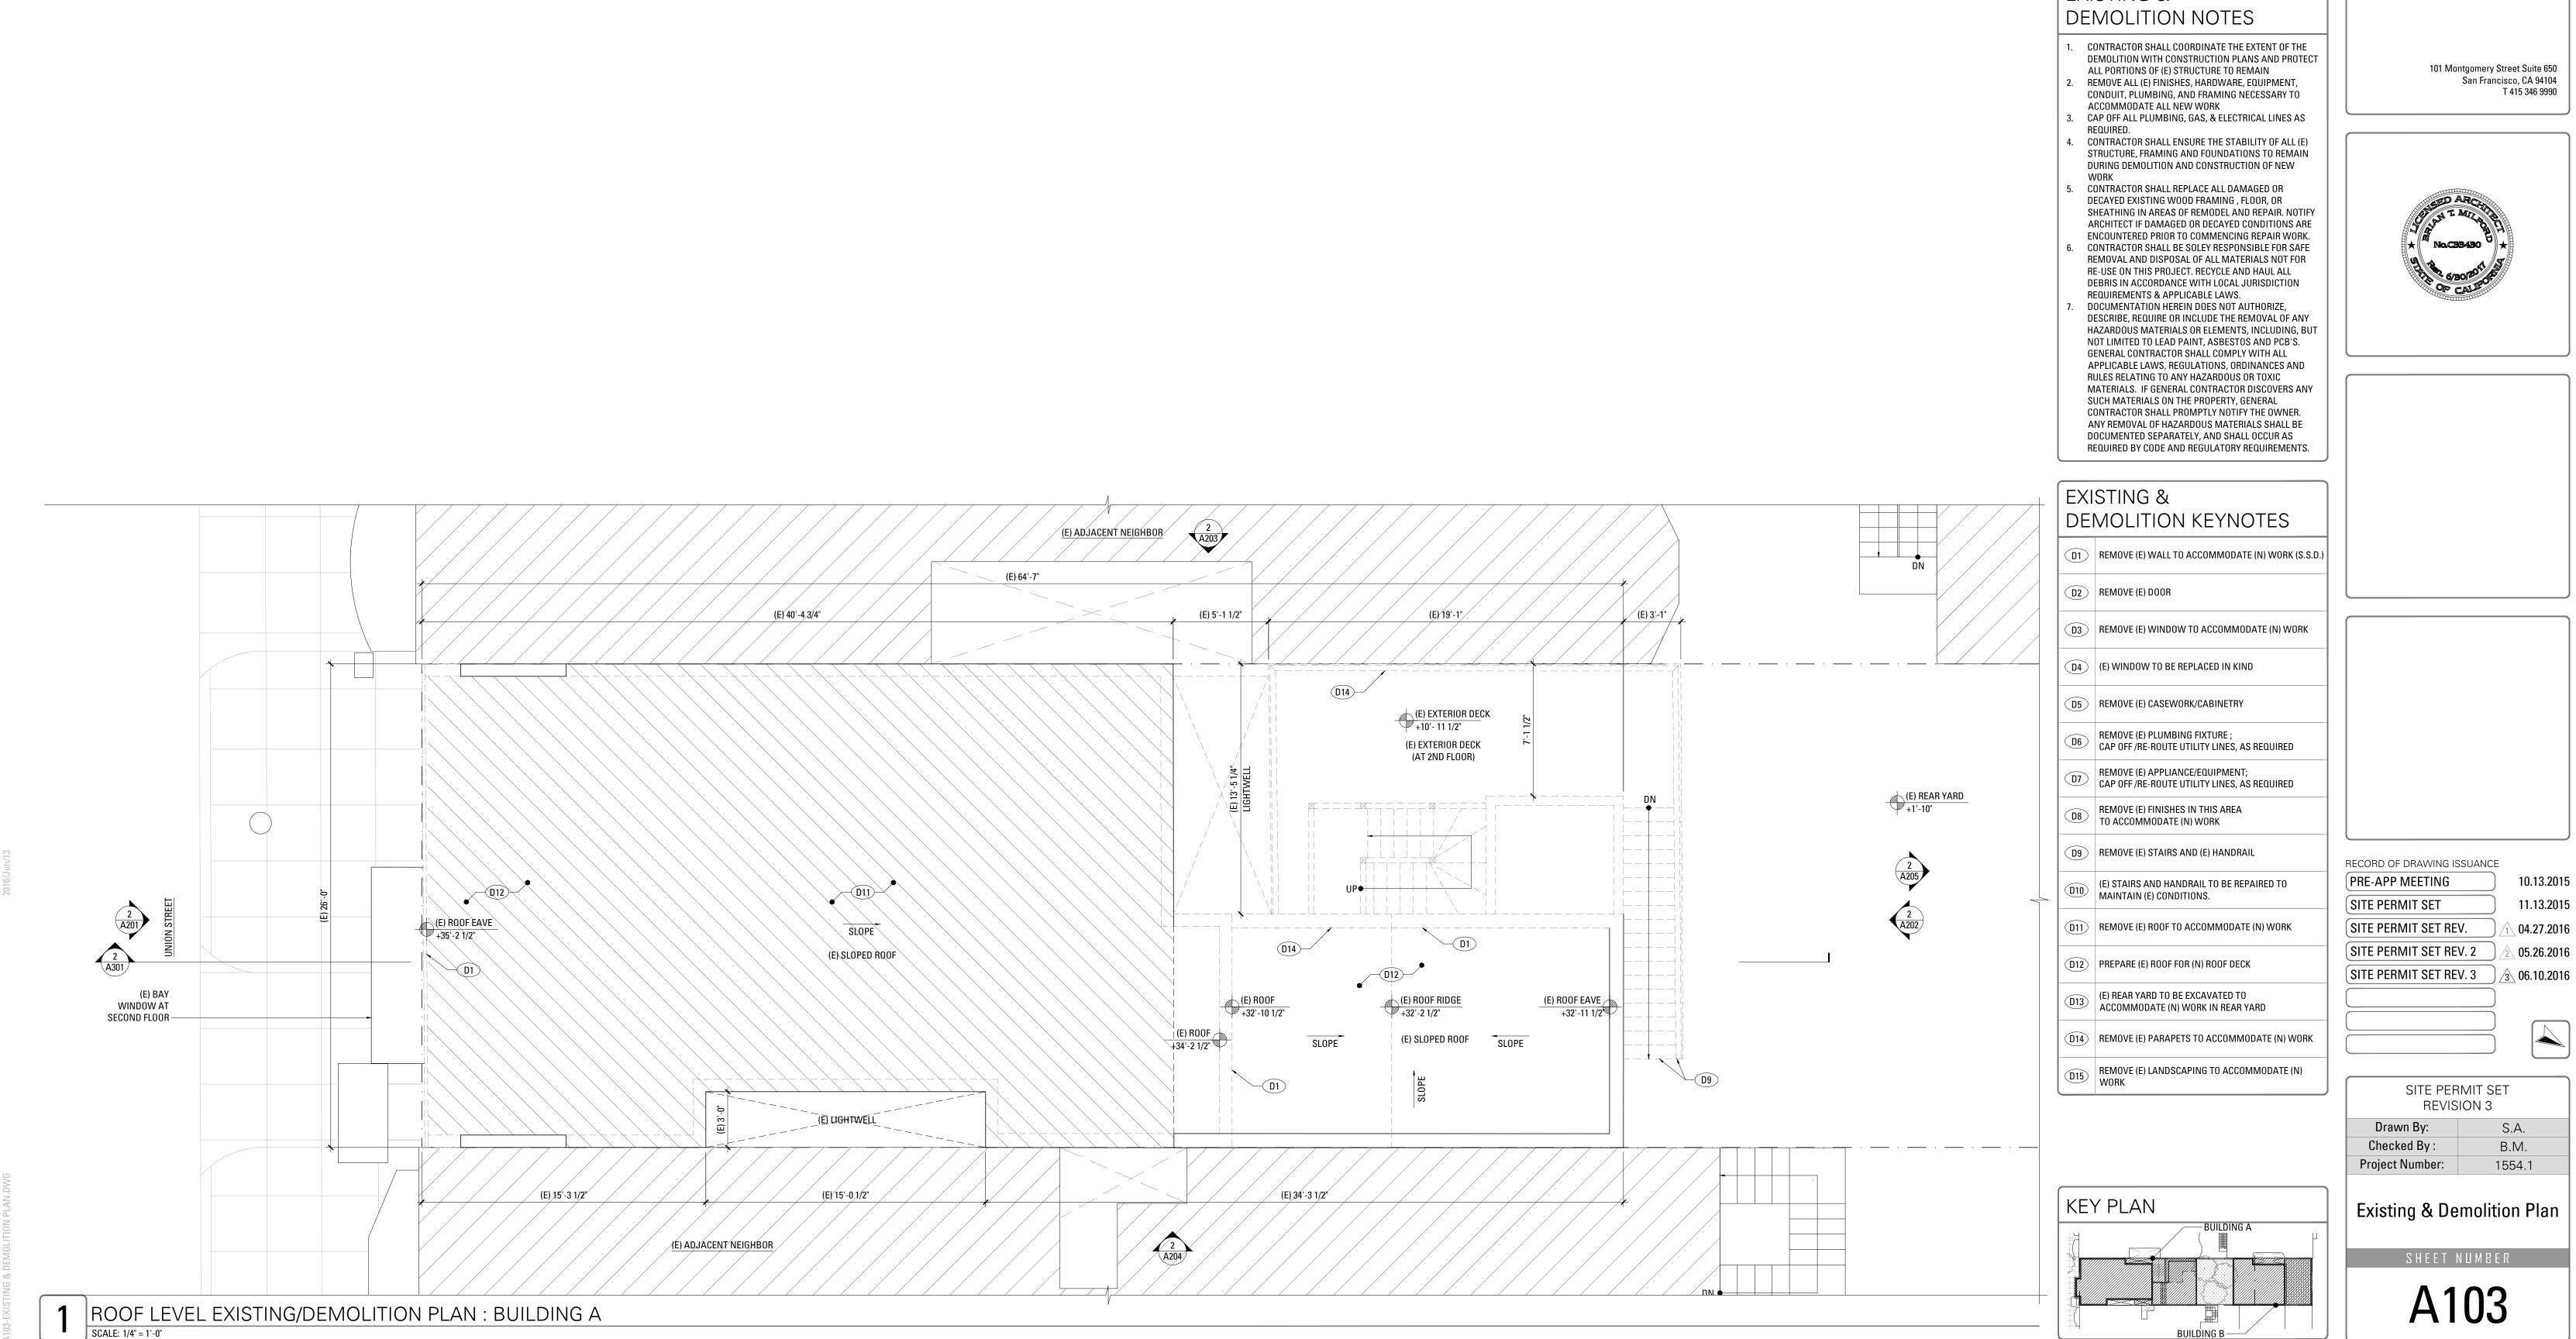

LEGEND

(E) WALL CONSTRUCTION

PARTITION TYPE SYMBOL (N) SCHEDULED WALL OR FINISH ASSEMBLY. SEE SHEET A901.

INDICATES RATED ASSEMBLY.
SEE SHEET A901.

(N) SOUND ATTENUATION BATT INSULATION

(N) GAS SHUT OFF; LOCATE IN ACCESSIBLE AREA IN CABINET [CMC 1312.3]


NOTE: ALL (N) WALLS TYPE "A" U.O.N.

EXISTING &

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MARTINKOVIC MILFORD ARCHITECTS




- (N) BUILT-IN CASEWORK. SEE INTERIOR ELEVATIONS.
- (N) FULL HEIGHT BUILT-IN CASEWORK.
- SEE INTERIOR ELEVATIONS. PROVIDE BACKING

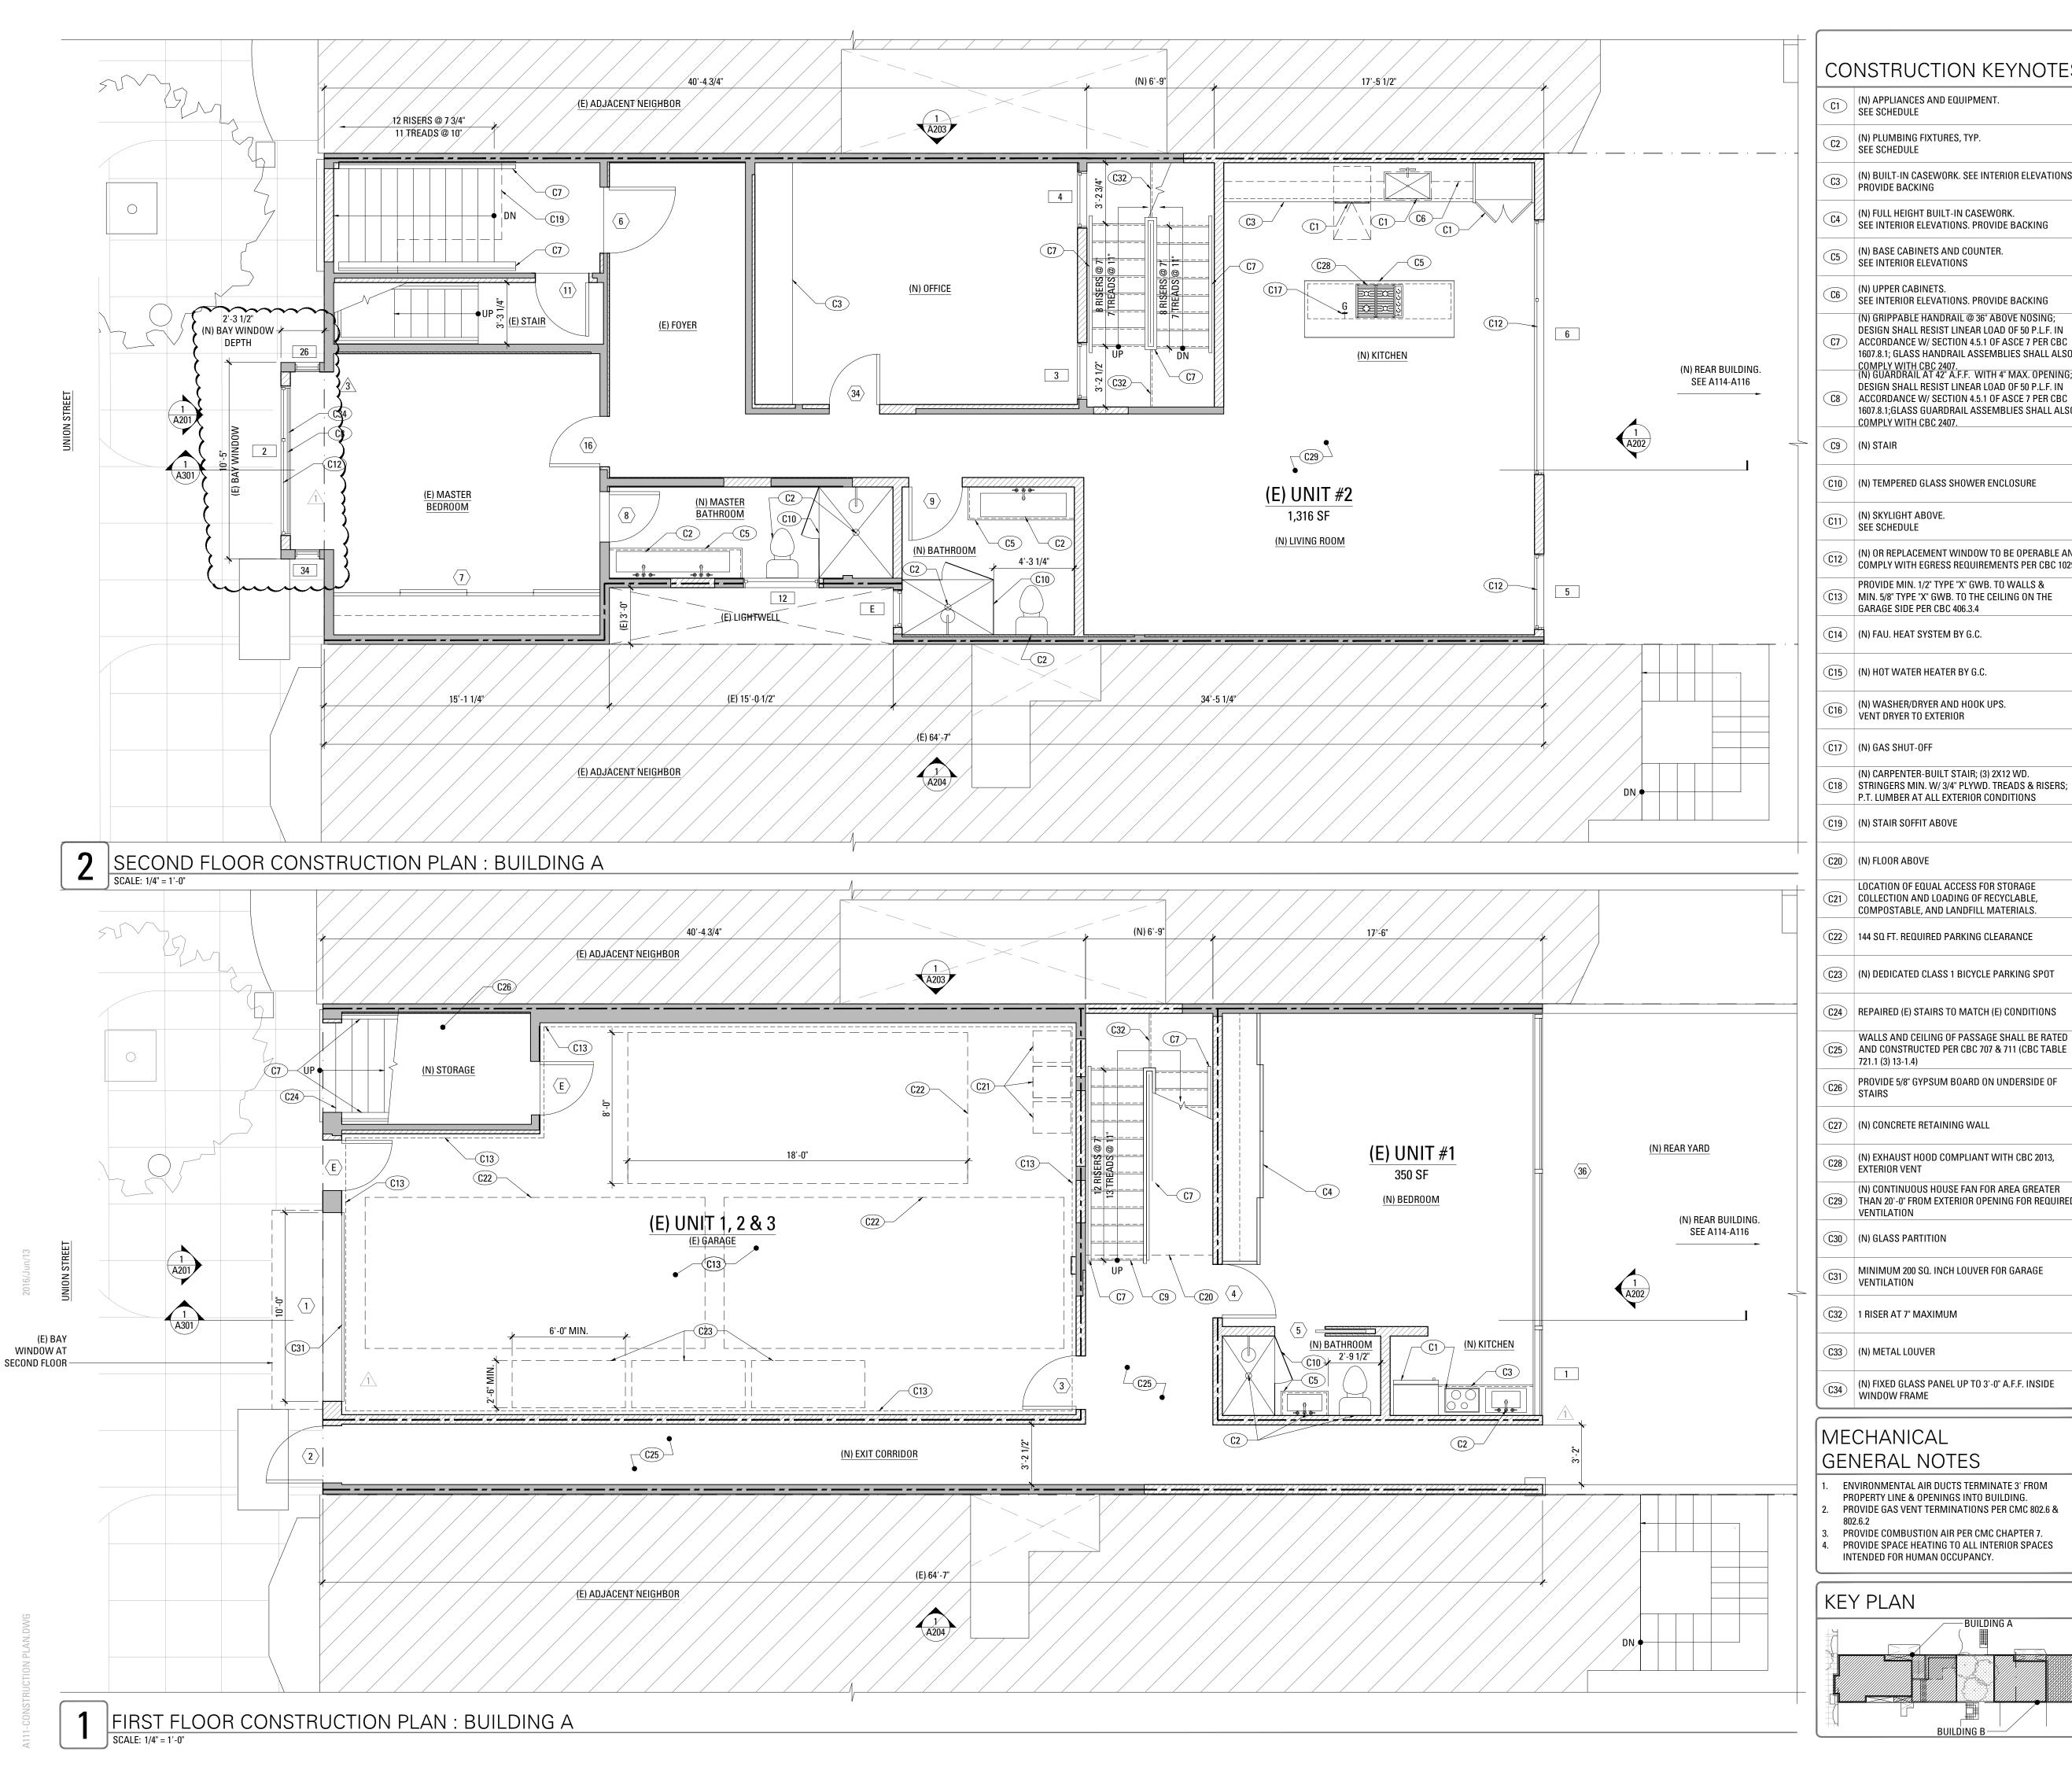- SEE INTERIOR ELEVATIONS. PROVIDE BACKING (N) GRIPPABLE HANDRAIL @ 36" ABOVE NOSING;
- DESIGN SHALL RESIST LINEAR LOAD OF 50 P.L.F. IN (C7) ACCORDANCE W/ SECTION 4.5.1 OF ASCE 7 PER CBC 1607.8.1; GLASS HANDRAIL ASSEMBLIES SHALL ALSO
- DESIGN SHALL RESIST LINEAR LOAD OF 50 P.L.F. IN (C8) ACCORDANCE W/ SECTION 4.5.1 OF ASCE 7 PER CBC 1607.8.1; GLASS GUARDRAIL ASSEMBLIES SHALL ALSO
- (C10) (N) TEMPERED GLASS SHOWER ENCLOSURE
- (N) OR REPLACEMENT WINDOW TO BE OPERABLE AND COMPLY WITH EGRESS REQUIREMENTS PER CBC 1029
- (C13) MIN. 5/8" TYPE "X" GWB. TO THE CEILING ON THE GARAGE SIDE PER CBC 406.3.4
- (C14) (N) FAU. HEAT SYSTEM BY G.C.
- (C15) (N) HOT WATER HEATER BY G.C.
- (N) WASHER/DRYER AND HOOK UPS. VENT DRYER TO EXTERIOR
- (N) CARPENTER-BUILT STAIR; (3) 2X12 WD. (C18) | STRINGERS MIN. W/ 3/4" PLYWD. TREADS & RISERS;
- (C19) (N) STAIR SOFFIT ABOVE
- LOCATION OF EQUAL ACCESS FOR STORAGE C21 COLLECTION AND LOADING OF RECYCLABLE,
- COMPOSTABLE, AND LANDFILL MATERIALS.
- (C23) (N) DEDICATED CLASS 1 BICYCLE PARKING SPOT
- (C24) REPAIRED (E) STAIRS TO MATCH (E) CONDITIONS
- WALLS AND CEILING OF PASSAGE SHALL BE RATED (C25) AND CONSTRUCTED PER CBC 707 & 711 (CBC TABLE
- PROVIDE 5/8" GYPSUM BOARD ON UNDERSIDE OF STAIRS
- (C27) (N) CONCRETE RETAINING WALL
- (N) EXHAUST HOOD COMPLIANT WITH CBC 2013,
- (C29) THAN 20'-0" FROM EXTERIOR OPENING FOR REQUIRED

- (N) FIXED GLASS PANEL UP TO 3'-0" A.F.F. INSIDE


GENERAL NOTES

- ENVIRONMENTAL AIR DUCTS TERMINATE 3' FROM PROPERTY LINE & OPENINGS INTO BUILDING. PROVIDE GAS VENT TERMINATIONS PER CMC 802.6 &
- PROVIDE COMBUSTION AIR PER CMC CHAPTER 7.
- PROVIDE SPACE HEATING TO ALL INTERIOR SPACES INTENDED FOR HUMAN OCCUPANCY.

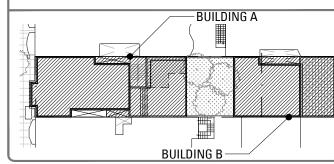

LEGEND

(E) WALL CONSTRUCTION

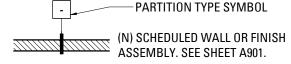

INDICATES RATED ASSEMBLY. SEE SHEET A901.

(N) SOUND ATTENUATION BATT INSULATION

(N) GAS SHUT OFF; LOCATE IN ACCESSIBLE AREA IN

CABINET [CMC 1312.3] NOTE: ALL (N) WALLS TYPE "A" U.O.N.

CONSTRUCTION GENERAL NOTES

- ALL (N) WALLS TYPE "A" U.O.N. SEE SCHEDULE, A901. ALL DIMENSIONS ARE TO FACE OF FINISH, CENTERLINE OF OPENING OR EDGE OF JAMB FRAME, U.O.N.
- DOORS NOT LOCATED BY DIMENSION SHALL BE PLACED 3" OFF JAMB, U.O.N. ALL REQUIRED HANDRAILS SHALL COMPLY WITH
- HANDRAIL GRASPABILITY PER CBC 1012.3. PROVIDE & INSTALL FLASHING, COUNTERFLASHING, CAP FLASHING, METAL TRIM, OTHER FABRICATED ITEMS AND MISCELLANEOUS SHEET METALWORK AT JUNCTIONS OF A ROOF AND WALL, AT CHIMNEYS, OVER EXPOSED DOORS AND WINDOWS, AT CHANGES OF SIDING MATERIAL IN ROOF VALLEYS OR WHERE REQUIRED TO PROVIDE COMPLETE WATERTIGHT AND WATERPROOF CONSTRUCTION.
- PROVIDE & INSTALL ONE PIECE GSM PAN FLASHING AT ALL NEW AND REPLACEMENT EXTERIOR DOORS. COMPLY WITH ASTM E2112-07, STANDARD PRACTICE FOR INSTALLATION OF EXTERIOR WINDOWS, DOORS, AND SKYLIGHTS.
- WATERPROOFING SHALL OVERLAP FLASHINGS FOR POSITIVE DRAINAGE AT ALL CONDITIONS.
- FLASHING & SHEET METALWORK SHALL BE FABRICATED AND INSTALLED IN ACCORDANCE WITH SHEET METAL & AIR CONDITIONING CONTRACTORS' NATIONAL ASSOCIATION (SMACNA) ARCHITECTURAL SHEET METAL MANUAL. COMPLY WITH MINIMUM THICKNESS OR GAGE REQUIREMENTS AS SPECIFIED IN SMACNA ARCHITECTURAL SHEET METAL MANUAL.
- ISOLATE AND PROTECT DISSIMILAR METALS FROM CONTACT WITH EACH OTHER BY APPLYING SPECIFIED ISOLATION MATERIAL TO CONTACT SURFACES. PROTECT SURFACES OF SHEET METAL IN CONTACT WITH CONCRETE, TREATED WOOD, OR ALUMINUM WITH A HEAVY COATING OF BITUMINOUS PAINT AS RECOMMENDED BY MANUFACTURER/FABRICATOR.
- FLASHING & SHEET METALWORK WILL NOT BE MEASURED SEPARATELY FOR PAYMENT BUT WILL BE PAID FOR AS PART OF THE CONTRACT LUMP SUM PRICE FOR ARCHITECTURAL WORK. PROVIDE MINIMUM OF R-13 BATT INSULATION IN
- SPACE, IN AREAS NOT ALREADY INSULATED PROVIDE CEMENT BOARD BACKING IN AREAS TO RECEIVE TILE FINISH

EXTERIOR WALLS ADJACENT TO (N) AND (E) LIVING

- 13. WOOD LOCATED NEARER THAN 6" TO EARTH SHALL BE TREATED WOOD
- 14. ALL DOORS AND WINDOWS NOT TAGGED ARE EXISTING TO REMAIN U.O.N.
- 15. ALL TOILETS TO HAVE A MINIMUM CLEARANCE OF 24" IN FRONT AND 15" FROM CENTERLINE OF THE TOILET TO
- S. STAIRWAYS SHALL HAVE A MINIMUM HEADROOM CLEARANCE OF 80 INCHES ABOVE THE FRONT EDGE OF THE NOSING.
- ALL APPLIANCES WITH QUICK-ACTING VALVES, INCLUDING BUT NOT LIMITED TO DISHWASHERS & CLOTHES WASHERS, SHALL HAVE WATER HAMMER
- ARRESTORS (CPC 609.10) 8. ALL EXISTING NON-COMPLIANT AND NEW PLUMBING FIXTURES SHALL COMPLY WITH CALIFORNIA SB-407
- WATER HEATERS SHALL HAVE SEISMIC STRAPPING AT A POINT WITHIN THE UPPER 1/3 AND THE LOWER 1/3 OF THE WATER HEATER'S VERTICAL DIMENSIONS. AT THE LOWER POINT, A MINIMUM DISTANCE OF FOUR (4) INCHES SHALL BE MAINTAINED ABOVE THE CONTROLS TO THE STRAP. (CPC 507.2)
-). KITCHEN RANGES SHALL BE PROVIDED WITH A METAL VENTILATING HOOD. A VERTICAL CLEARANCE OF 24" MINIMUM BETWEEN THE COOKTOP & METAL VENTILATING HOOD SHALL BE MAINTAINED. THE HOOD SHALL BE AS WIDE AS THE RANGE AND CENTERED OVER THE UNIT. THE METAL HOOD SHALL BE
- 0.0122" MINIMUM THICK (2013 CMC 920.3) EACH KITCHEN IS REQUIRED TO HAVE AN EXHAUST FAN DUCTED TO THE OUTSIDE WITH A MINIMUM VENTILATION RATE OF 100 CFM.
- 22. ALL EXHAUST FAN DUCTING, INCLUDING BUT NOT LIMITED TO TO KITCHEN AND BATHROOM EXHAUST FANS, SHALL BE SIZED ACCORDING TO ASHRAE STANDARD 62.2 TABLE 7.1.
- . APPLIANCES IN ATTIC AND UNDER-FLOOR SPACES SHALL BE ACCESSIBLE THROUGH AN OPENING AND PASSAGEWAY AT LEAST AS LARGE AS THE LARGEST COMPONENT OF THE APPLIANCE, AND NOT LESS THAN 22 INCHES BY 30 INCHES. (CPC 508.4) APPLIANCES IN ATTIC AND UNDER-FLOOR SPACES SHALL HAVE A SOLID FLOOR PASSAGEWAY OF NOT
- LESS THAN 24 INCHES AND A WORK PLATFORM OF NOT LESS THAN 30 INCHES BY 30 INCHES IN FRONT OF THE SERVICE SIDE OF THE APPLIANCE. (CPC 508.4.2 & . APPLIANCES IN ATTIC AND UNDER-FLOOR SPACES
- SHALL HAVE A PERMANENT 120-VOLT RECEPTACLE OUTLET AND A LIGHTING FIXTURE NEAR THE APPLIANCE. (CPC 508.4.4)

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MARTINKOVIC MILFORD ARCHITECT


101 Montgomery Street Suite 650 San Francisco, CA 94104 T 415 346 9990



RECORD OF DRAWING ISSUANCE PRE-APP MEETING 10.13.2015 11.13.2015 SITE PERMIT SET SITE PERMIT SET REV. 04.27.2016 SITE PERMIT SET REV. 2 2 05.26.2016 SITE PERMIT SET REV. 3 3 06.10.2016

SITE PERMIT SET **REVISION 3** Drawn By: S.A. Checked By: B.M. Project Number: 1554.1


Construction Plan

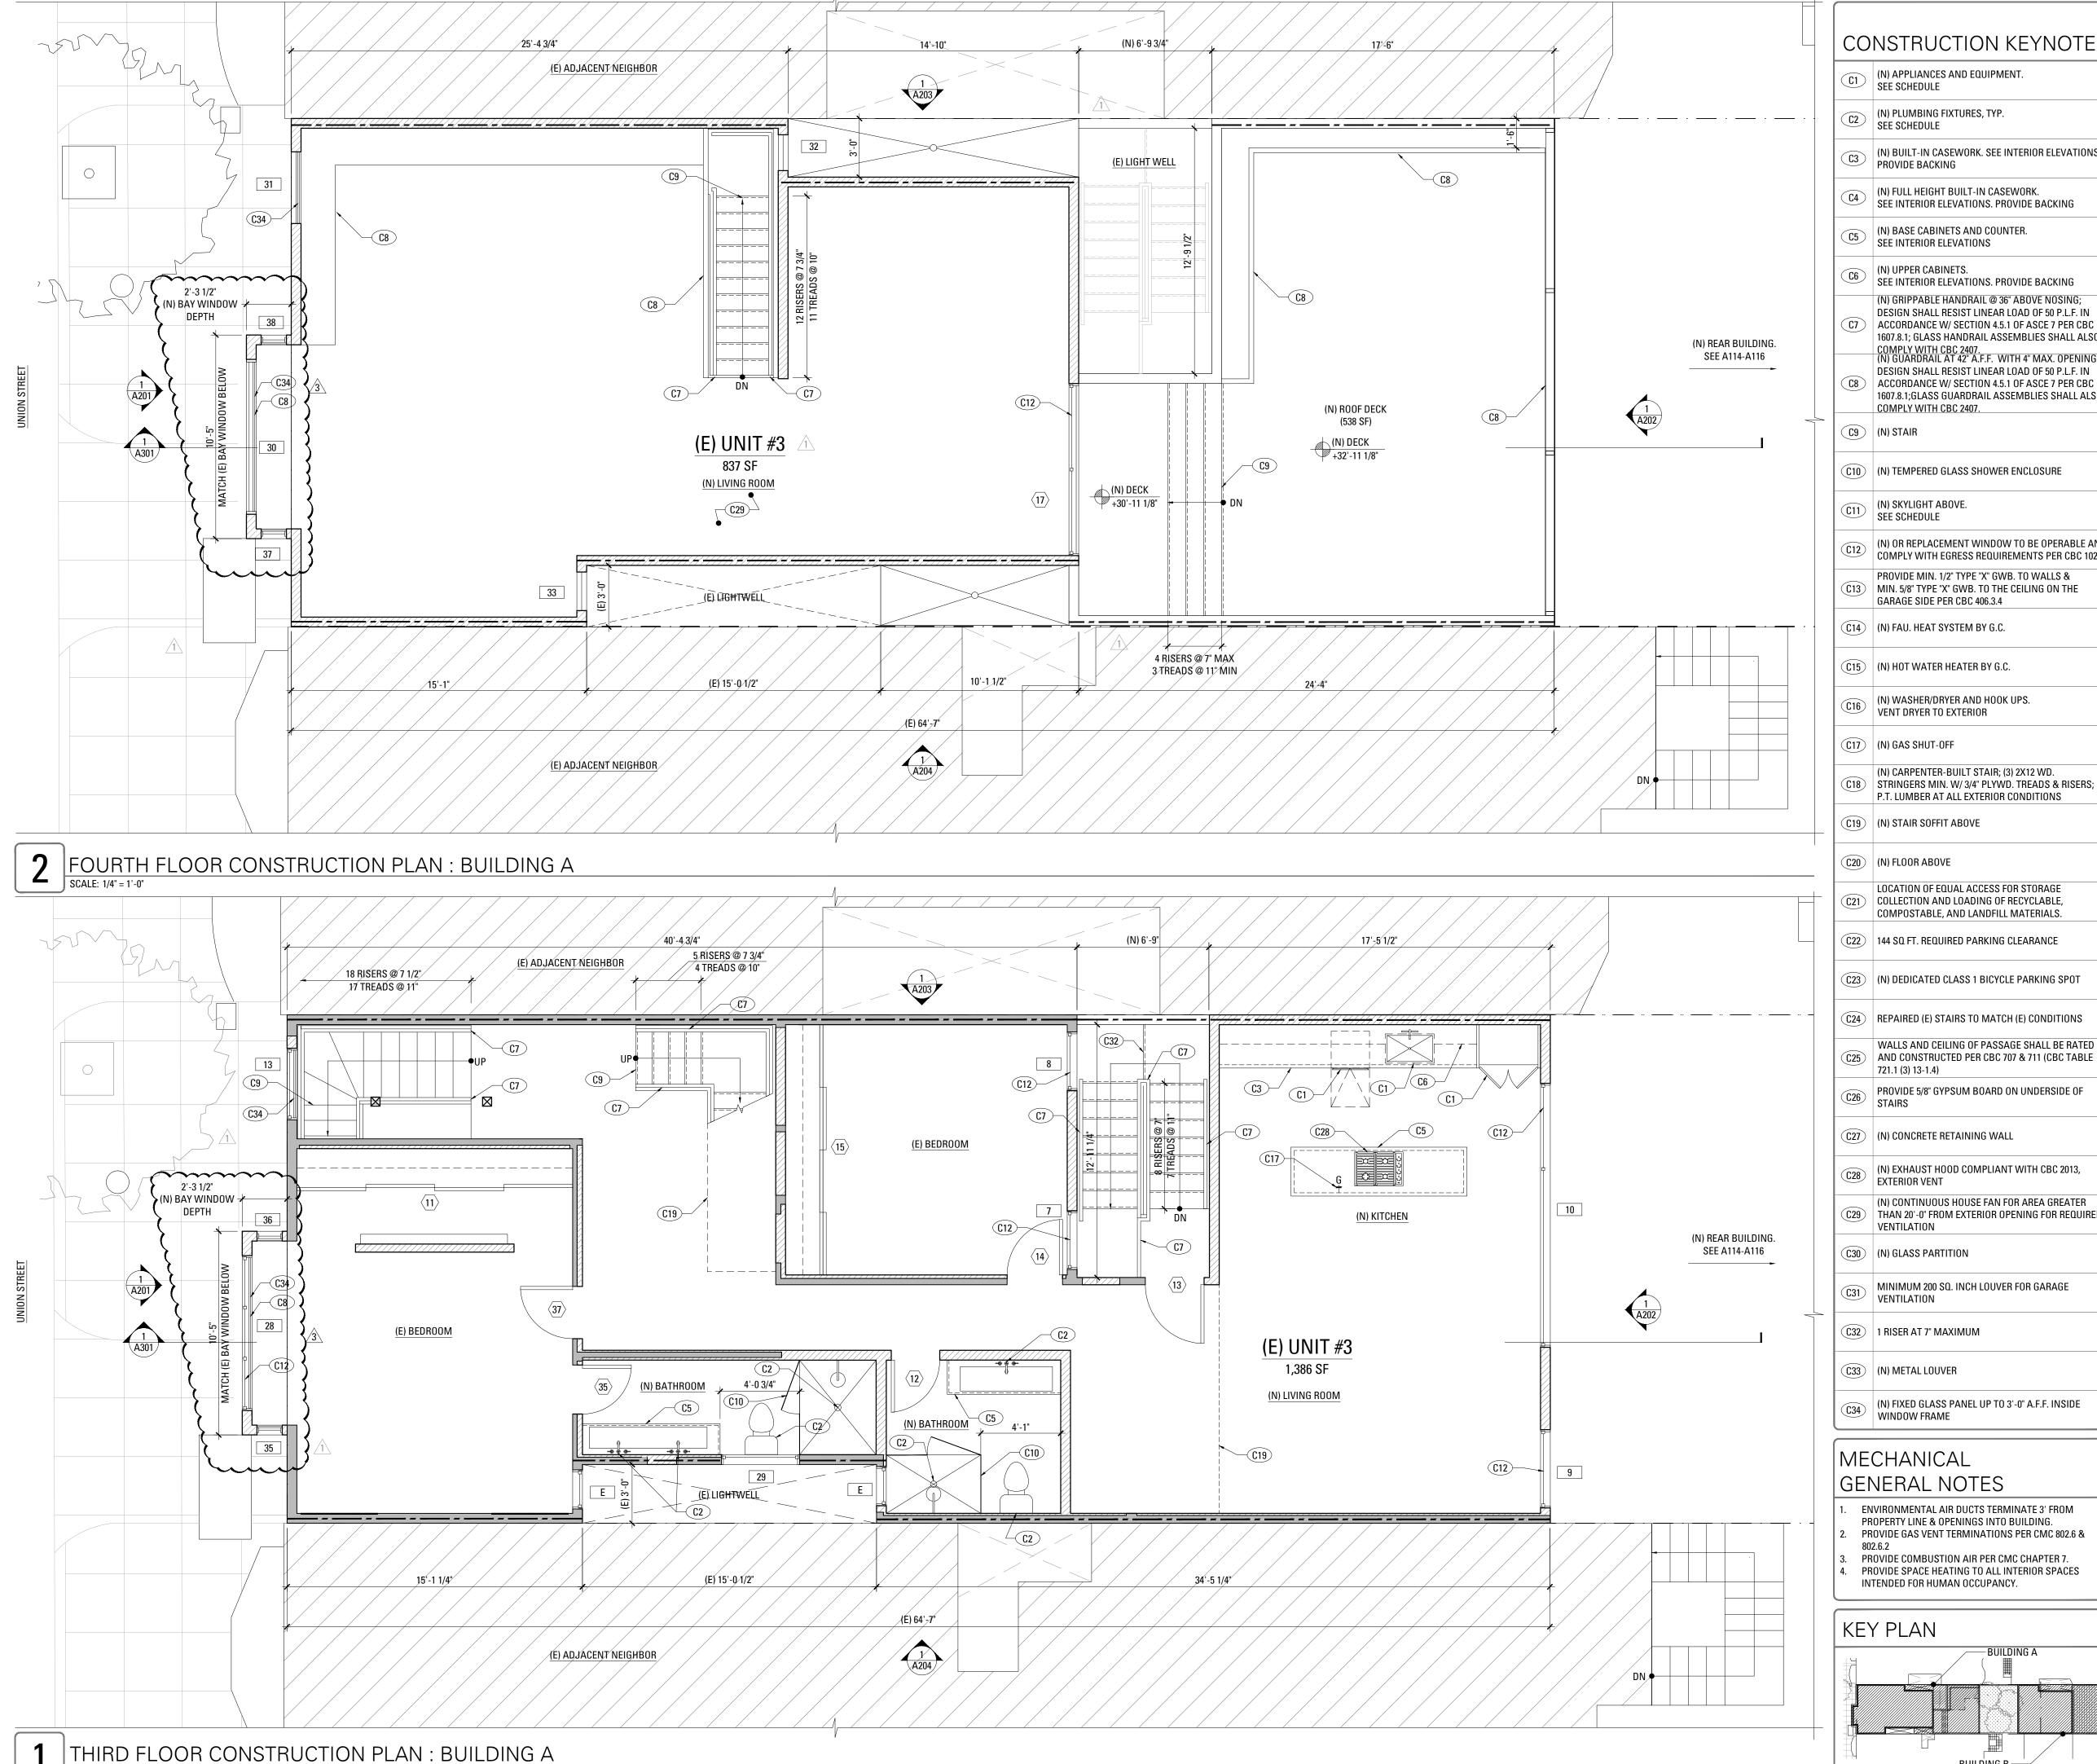

- (N) APPLIANCES AND EQUIPMENT. SEE SCHEDULE
- (N) PLUMBING FIXTURES, TYP. SEE SCHEDULE
- (N) BUILT-IN CASEWORK. SEE INTERIOR ELEVATIONS. PROVIDE BACKING
- (N) FULL HEIGHT BUILT-IN CASEWORK.
 SEE INTERIOR ELEVATIONS. PROVIDE BACKING
- (N) BASE CABINETS AND COUNTER. SEE INTERIOR ELEVATIONS
- (N) UPPER CABINETS.
 SEE INTERIOR ELEVATIONS. PROVIDE BACKING (N) GRIPPABLE HANDRAIL @ 36" ABOVE NOSING;
- DESIGN SHALL RESIST LINEAR LOAD OF 50 P.L.F. IN (C7) ACCORDANCE W/ SECTION 4.5.1 OF ASCE 7 PER CBC 1607.8.1; GLASS HANDRAIL ASSEMBLIES SHALL ALSO
- DESIGN SHALL RESIST LINEAR LOAD OF 50 P.L.F. IN (C8) ACCORDANCE W/ SECTION 4.5.1 OF ASCE 7 PER CBC 1607.8.1; GLASS GUARDRAIL ASSEMBLIES SHALL ALSO COMPLY WITH CBC 2407.
- (C10) (N) TEMPERED GLASS SHOWER ENCLOSURE
- (N) OR REPLACEMENT WINDOW TO BE OPERABLE AND COMPLY WITH EGRESS REQUIREMENTS PER CBC 1029
- PROVIDE MIN. 1/2" TYPE "X" GWB. TO WALLS & (C13) | MIN. 5/8" TYPE "X" GWB. TO THE CEILING ON THE GARAGE SIDE PER CBC 406.3.4
- (C14) (N) FAU. HEAT SYSTEM BY G.C.
- (C15) (N) HOT WATER HEATER BY G.C.
- (N) WASHER/DRYER AND HOOK UPS. VENT DRYER TO EXTERIOR
- (N) GAS SHUT-OFF
- (N) CARPENTER-BUILT STAIR; (3) 2X12 WD. (C18) | STRINGERS MIN. W/ 3/4" PLYWD. TREADS & RISERS; P.T. LUMBER AT ALL EXTERIOR CONDITIONS
- (C19) (N) STAIR SOFFIT ABOVE
- (C20) (N) FLOOR ABOVE
- LOCATION OF EQUAL ACCESS FOR STORAGE C21 COLLECTION AND LOADING OF RECYCLABLE,
- (C23) (N) DEDICATED CLASS 1 BICYCLE PARKING SPOT
- (C24) REPAIRED (E) STAIRS TO MATCH (E) CONDITIONS
- WALLS AND CEILING OF PASSAGE SHALL BE RATED (C25) AND CONSTRUCTED PER CBC 707 & 711 (CBC TABLE
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- (C27) (N) CONCRETE RETAINING WALL
- (N) EXHAUST HOOD COMPLIANT WITH CBC 2013, EXTERIOR VENT
- (N) CONTINUOUS HOUSE FAN FOR AREA GREATER (C29) THAN 20'-0" FROM EXTERIOR OPENING FOR REQUIRED
- (C30) (N) GLASS PARTITION
- MINIMUM 200 SQ. INCH LOUVER FOR GARAGE VENTILATION
- (C32) | 1 RISER AT 7" MAXIMUM
- (C33) (N) METAL LOUVER
- (N) FIXED GLASS PANEL UP TO 3'-0" A.F.F. INSIDE WINDOW FRAME

GENERAL NOTES

- ENVIRONMENTAL AIR DUCTS TERMINATE 3' FROM PROPERTY LINE & OPENINGS INTO BUILDING. PROVIDE GAS VENT TERMINATIONS PER CMC 802.6 &
- PROVIDE COMBUSTION AIR PER CMC CHAPTER 7.
- PROVIDE SPACE HEATING TO ALL INTERIOR SPACES INTENDED FOR HUMAN OCCUPANCY.

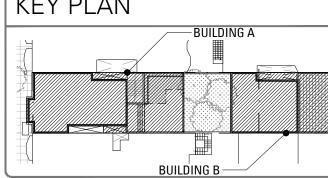

LEGEND

(E) WALL CONSTRUCTION



INDICATES RATED ASSEMBLY. SEE SHEET A901.

(N) SOUND ATTENUATION BATT INSULATION

(N) GAS SHUT OFF; LOCATE IN ACCESSIBLE AREA IN CABINET [CMC 1312.3]

NOTE: ALL (N) WALLS TYPE "A" U.O.N.

CONSTRUCTION GENERAL NOTES

- ALL (N) WALLS TYPE "A" U.O.N. SEE SCHEDULE, A901. ALL DIMENSIONS ARE TO FACE OF FINISH, CENTERLINE OF OPENING OR EDGE OF JAMB FRAME, U.O.N. DOORS NOT LOCATED BY DIMENSION SHALL BE
- PLACED 3" OFF JAMB, U.O.N. ALL REQUIRED HANDRAILS SHALL COMPLY WITH
- HANDRAIL GRASPABILITY PER CBC 1012.3. PROVIDE & INSTALL FLASHING, COUNTERFLASHING, CAP FLASHING, METAL TRIM, OTHER FABRICATED ITEMS AND MISCELLANEOUS SHEET METALWORK AT JUNCTIONS OF A ROOF AND WALL, AT CHIMNEYS, OVER EXPOSED DOORS AND WINDOWS, AT CHANGES OF SIDING MATERIAL IN ROOF VALLEYS OR WHERE REQUIRED TO PROVIDE COMPLETE WATERTIGHT AND
- WATERPROOF CONSTRUCTION. PROVIDE & INSTALL ONE PIECE GSM PAN FLASHING AT ALL NEW AND REPLACEMENT EXTERIOR DOORS. COMPLY WITH ASTM E2112-07, STANDARD PRACTICE FOR INSTALLATION OF EXTERIOR WINDOWS, DOORS, AND SKYLIGHTS.
- WATERPROOFING SHALL OVERLAP FLASHINGS FOR POSITIVE DRAINAGE AT ALL CONDITIONS. FLASHING & SHEET METALWORK SHALL BE
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- CONTACT WITH EACH OTHER BY APPLYING SPECIFIED ISOLATION MATERIAL TO CONTACT SURFACES. PROTECT SURFACES OF SHEET METAL IN CONTACT WITH CONCRETE, TREATED WOOD, OR ALUMINUM WITH A HEAVY COATING OF BITUMINOUS PAINT AS RECOMMENDED BY MANUFACTURER/FABRICATOR.
- FLASHING & SHEET METALWORK WILL NOT BE MEASURED SEPARATELY FOR PAYMENT BUT WILL BE PAID FOR AS PART OF THE CONTRACT LUMP SUM PRICE FOR ARCHITECTURAL WORK.

PROVIDE MINIMUM OF R-13 BATT INSULATION IN EXTERIOR WALLS ADJACENT TO (N) AND (E) LIVING

- SPACE, IN AREAS NOT ALREADY INSULATED PROVIDE CEMENT BOARD BACKING IN AREAS TO RECEIVE TILE FINISH
- 13. WOOD LOCATED NEARER THAN 6" TO EARTH SHALL BE TREATED WOOD
- 14. ALL DOORS AND WINDOWS NOT TAGGED ARE
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- S. STAIRWAYS SHALL HAVE A MINIMUM HEADROOM CLEARANCE OF 80 INCHES ABOVE THE FRONT EDGE OF
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- ARRESTORS (CPC 609.10) . ALL EXISTING NON-COMPLIANT AND NEW PLUMBING FIXTURES SHALL COMPLY WITH CALIFORNIA SB-407
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-). KITCHEN RANGES SHALL BE PROVIDED WITH A METAL VENTILATING HOOD. A VERTICAL CLEARANCE OF 24" MINIMUM BETWEEN THE COOKTOP & METAL VENTILATING HOOD SHALL BE MAINTAINED. THE HOOD SHALL BE AS WIDE AS THE RANGE AND CENTERED OVER THE UNIT. THE METAL HOOD SHALL BE
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- 22. ALL EXHAUST FAN DUCTING, INCLUDING BUT NOT LIMITED TO TO KITCHEN AND BATHROOM EXHAUST FANS, SHALL BE SIZED ACCORDING TO ASHRAE STANDARD 62.2 TABLE 7.1.
- APPLIANCES IN ATTIC AND UNDER-FLOOR SPACES SHALL BE ACCESSIBLE THROUGH AN OPENING AND PASSAGEWAY AT LEAST AS LARGE AS THE LARGEST COMPONENT OF THE APPLIANCE, AND NOT LESS THAN 22 INCHES BY 30 INCHES. (CPC 508.4) APPLIANCES IN ATTIC AND UNDER-FLOOR SPACES SHALL HAVE A SOLID FLOOR PASSAGEWAY OF NOT
- LESS THAN 24 INCHES AND A WORK PLATFORM OF NOT LESS THAN 30 INCHES BY 30 INCHES IN FRONT OF THE SERVICE SIDE OF THE APPLIANCE. (CPC 508.4.2 & 5. APPLIANCES IN ATTIC AND UNDER-FLOOR SPACES
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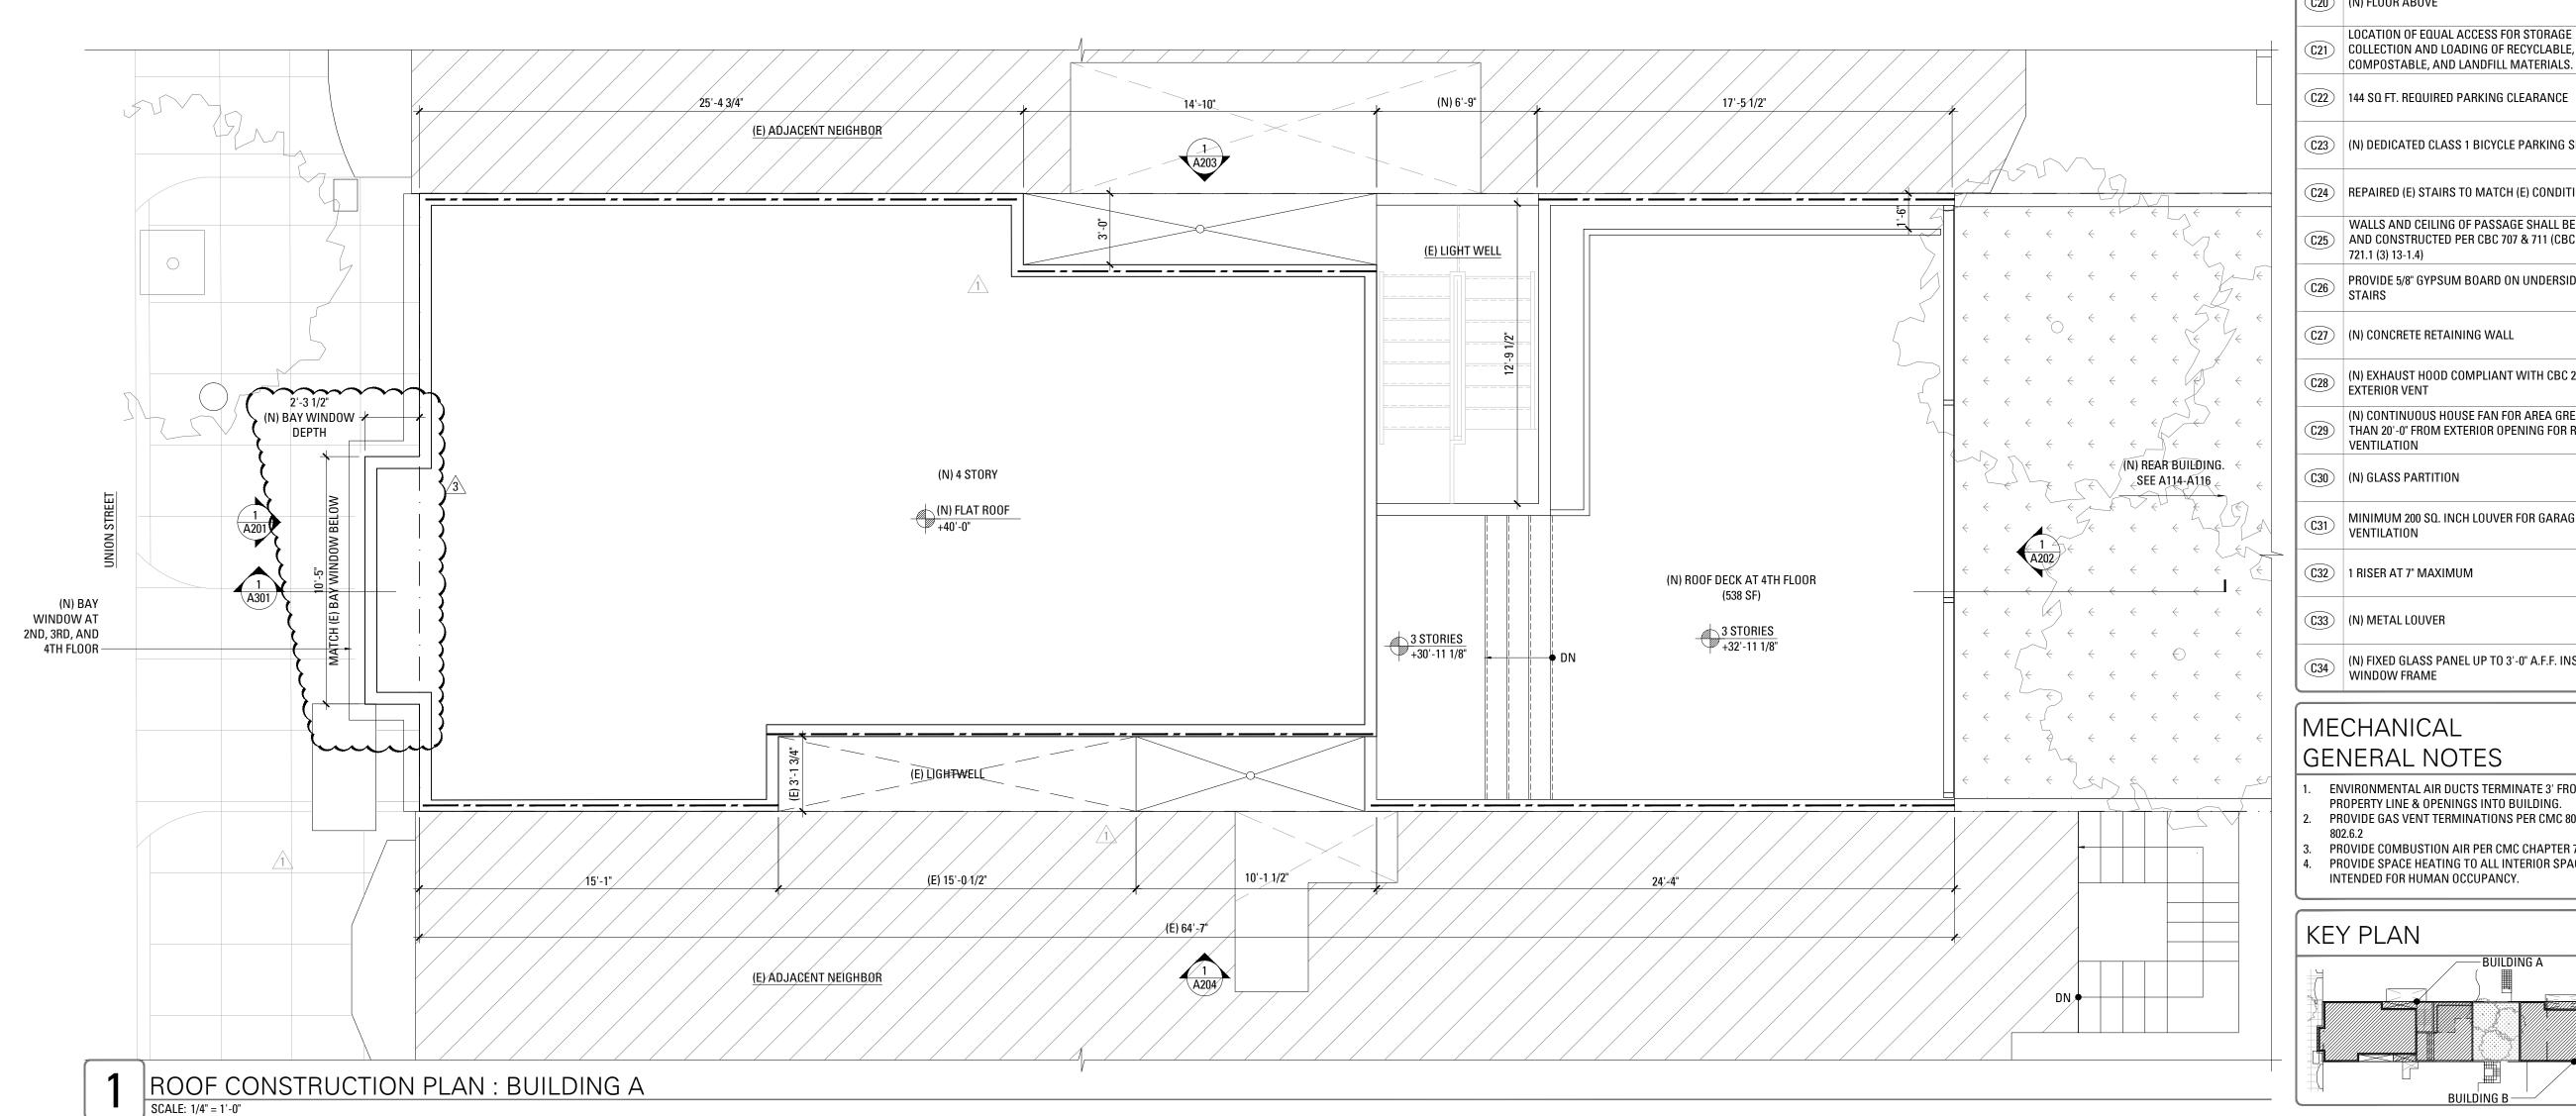
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SITE PERMIT SET **REVISION 3** Drawn By: S.A. Checked By: B.M. Project Number: 1554.1


Construction Plan



- (N) APPLIANCES AND EQUIPMENT. SEE SCHEDULE
- (N) PLUMBING FIXTURES, TYP. SEE SCHEDULE
- (N) BUILT-IN CASEWORK. SEE INTERIOR ELEVATIONS. PROVIDE BACKING
- (N) FULL HEIGHT BUILT-IN CASEWORK.
 SEE INTERIOR ELEVATIONS. PROVIDE BACKING
- (N) BASE CABINETS AND COUNTER.
 SEE INTERIOR ELEVATIONS
- (N) UPPER CABINETS.
 SEE INTERIOR ELEVATIONS. PROVIDE BACKING (N) GRIPPABLE HANDRAIL @ 36" ABOVE NOSING;
- DESIGN SHALL RESIST LINEAR LOAD OF 50 P.L.F. IN C7 ACCORDANCE W/ SECTION 4.5.1 OF ASCE 7 PER CBC 1607.8.1; GLASS HANDRAIL ASSEMBLIES SHALL ALSO COMPLY WITH CBC 2407. (N) GUARDRAIL AT 42" A.F.F. WITH 4" MAX. OPENING;
- DESIGN SHALL RESIST LINEAR LOAD OF 50 P.L.F. IN (C8) ACCORDANCE W/ SECTION 4.5.1 OF ASCE 7 PER CBC 1607.8.1;GLASS GUARDRAIL ASSEMBLIES SHALL ALSO COMPLY WITH CBC 2407.
- (N) STAIR
- (C10) (N) TEMPERED GLASS SHOWER ENCLOSURE
- (N) SKYLIGHT ABOVE. SEE SCHEDULE
- (N) OR REPLACEMENT WINDOW TO BE OPERABLE AND COMPLY WITH EGRESS REQUIREMENTS PER CBC 1029
- PROVIDE MIN. 1/2" TYPE "X" GWB. TO WALLS & (C13) MIN. 5/8" TYPE "X" GWB. TO THE CEILING ON THE GARAGE SIDE PER CBC 406.3.4
- (C14) (N) FAU. HEAT SYSTEM BY G.C.
- (N) HOT WATER HEATER BY G.C.
- (N) WASHER/DRYER AND HOOK UPS. VENT DRYER TO EXTERIOR
- (N) GAS SHUT-OFF
- (N) CARPENTER-BUILT STAIR; (3) 2X12 WD. (C18) STRINGERS MIN. W/ 3/4" PLYWD. TREADS & RISERS; P.T. LUMBER AT ALL EXTERIOR CONDITIONS
- (N) STAIR SOFFIT ABOVE
- (C20) (N) FLOOR ABOVE
- LOCATION OF EQUAL ACCESS FOR STORAGE C21 COLLECTION AND LOADING OF RECYCLABLE,
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- (C27) (N) CONCRETE RETAINING WALL
- (N) EXHAUST HOOD COMPLIANT WITH CBC 2013, EXTERIOR VENT
- (N) CONTINUOUS HOUSE FAN FOR AREA GREATER (C29) THAN 20'-0" FROM EXTERIOR OPENING FOR REQUIRED VENTILATION
- MINIMUM 200 SQ. INCH LOUVER FOR GARAGE VENTILATION
- (C32) 1 RISER AT 7" MAXIMUM
- (C33) (N) METAL LOUVER
- (N) FIXED GLASS PANEL UP TO 3'-0" A.F.F. INSIDE WINDOW FRAME


MECHANICAL GENERAL NOTES

- ENVIRONMENTAL AIR DUCTS TERMINATE 3' FROM PROPERTY LINE & OPENINGS INTO BUILDING. PROVIDE GAS VENT TERMINATIONS PER CMC 802.6 &
- PROVIDE COMBUSTION AIR PER CMC CHAPTER 7. PROVIDE SPACE HEATING TO ALL INTERIOR SPACES INTENDED FOR HUMAN OCCUPANCY.

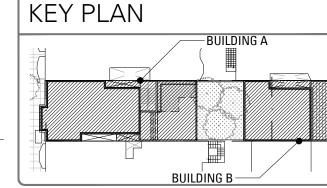

LEGEND

(E) WALL CONSTRUCTION PARTITION TYPE SYMBOL

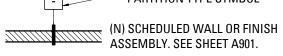

INDICATES RATED ASSEMBLY. SEE SHEET A901.

(N) SOUND ATTENUATION BATT INSULATION

(N) GAS SHUT OFF; LOCATE IN ACCESSIBLE AREA IN CABINET [CMC 1312.3]

NOTE: ALL (N) WALLS TYPE "A" U.O.N.

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- PROVIDE & INSTALL ONE PIECE GSM PAN FLASHING AT ALL NEW AND REPLACEMENT EXTERIOR DOORS. COMPLY WITH ASTM E2112-07, STANDARD PRACTICE FOR INSTALLATION OF EXTERIOR WINDOWS, DOORS, AND SKYLIGHTS.
- WATERPROOFING SHALL OVERLAP FLASHINGS FOR POSITIVE DRAINAGE AT ALL CONDITIONS.
- FLASHING & SHEET METALWORK SHALL BE FABRICATED AND INSTALLED IN ACCORDANCE WITH SHEET METAL & AIR CONDITIONING CONTRACTORS' NATIONAL ASSOCIATION (SMACNA) ARCHITECTURAL SHEET METAL MANUAL. COMPLY WITH MINIMUM THICKNESS OR GAGE REQUIREMENTS AS SPECIFIED IN SMACNA ARCHITECTURAL SHEET METAL MANUAL.
- ISOLATE AND PROTECT DISSIMILAR METALS FROM CONTACT WITH EACH OTHER BY APPLYING SPECIFIED ISOLATION MATERIAL TO CONTACT SURFACES. PROTECT SURFACES OF SHEET METAL IN CONTACT WITH CONCRETE, TREATED WOOD, OR ALUMINUM WITH A HEAVY COATING OF BITUMINOUS PAINT AS RECOMMENDED BY MANUFACTURER/FABRICATOR.
- D. FLASHING & SHEET METALWORK WILL NOT BE MEASURED SEPARATELY FOR PAYMENT BUT WILL BE PAID FOR AS PART OF THE CONTRACT LUMP SUM PRICE FOR ARCHITECTURAL WORK. PROVIDE MINIMUM OF R-13 BATT INSULATION IN
- SPACE, IN AREAS NOT ALREADY INSULATED PROVIDE CEMENT BOARD BACKING IN AREAS TO RECEIVE TILE FINISH

EXTERIOR WALLS ADJACENT TO (N) AND (E) LIVING

- 13. WOOD LOCATED NEARER THAN 6" TO EARTH SHALL BE TREATED WOOD
- 14. ALL DOORS AND WINDOWS NOT TAGGED ARE
- EXISTING TO REMAIN U.O.N. 15. ALL TOILETS TO HAVE A MINIMUM CLEARANCE OF 24" IN FRONT AND 15" FROM CENTERLINE OF THE TOILET TO
- EACH SIDE. i. STAIRWAYS SHALL HAVE A MINIMUM HEADROOM CLEARANCE OF 80 INCHES ABOVE THE FRONT EDGE OF
- THE NOSING. ALL APPLIANCES WITH QUICK-ACTING VALVES, INCLUDING BUT NOT LIMITED TO DISHWASHERS & CLOTHES WASHERS, SHALL HAVE WATER HAMMER
- ARRESTORS (CPC 609.10) . ALL EXISTING NON-COMPLIANT AND NEW PLUMBING FIXTURES SHALL COMPLY WITH CALIFORNIA SB-407
- WATER HEATERS SHALL HAVE SEISMIC STRAPPING AT A POINT WITHIN THE UPPER 1/3 AND THE LOWER 1/3 OF THE WATER HEATER'S VERTICAL DIMENSIONS. AT THE LOWER POINT, A MINIMUM DISTANCE OF FOUR (4) INCHES SHALL BE MAINTAINED ABOVE THE CONTROLS TO THE STRAP. (CPC 507.2)
-). KITCHEN RANGES SHALL BE PROVIDED WITH A METAL VENTILATING HOOD. A VERTICAL CLEARANCE OF 24" MINIMUM BETWEEN THE COOKTOP & METAL VENTILATING HOOD SHALL BE MAINTAINED. THE HOOD SHALL BE AS WIDE AS THE RANGE AND CENTERED OVER THE UNIT. THE METAL HOOD SHALL BE
- 0.0122" MINIMUM THICK (2013 CMC 920.3) EACH KITCHEN IS REQUIRED TO HAVE AN EXHAUST FAN DUCTED TO THE OUTSIDE WITH A MINIMUM VENTILATION RATE OF 100 CFM.
- 22. ALL EXHAUST FAN DUCTING, INCLUDING BUT NOT LIMITED TO TO KITCHEN AND BATHROOM EXHAUST FANS, SHALL BE SIZED ACCORDING TO ASHRAE STANDARD 62.2 TABLE 7.1.
- . APPLIANCES IN ATTIC AND UNDER-FLOOR SPACES SHALL BE ACCESSIBLE THROUGH AN OPENING AND PASSAGEWAY AT LEAST AS LARGE AS THE LARGEST COMPONENT OF THE APPLIANCE, AND NOT LESS THAN 22 INCHES BY 30 INCHES. (CPC 508.4) APPLIANCES IN ATTIC AND UNDER-FLOOR SPACES SHALL HAVE A SOLID FLOOR PASSAGEWAY OF NOT
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- SHALL HAVE A PERMANENT 120-VOLT RECEPTACLE OUTLET AND A LIGHTING FIXTURE NEAR THE APPLIANCE. (CPC 508.4.4)


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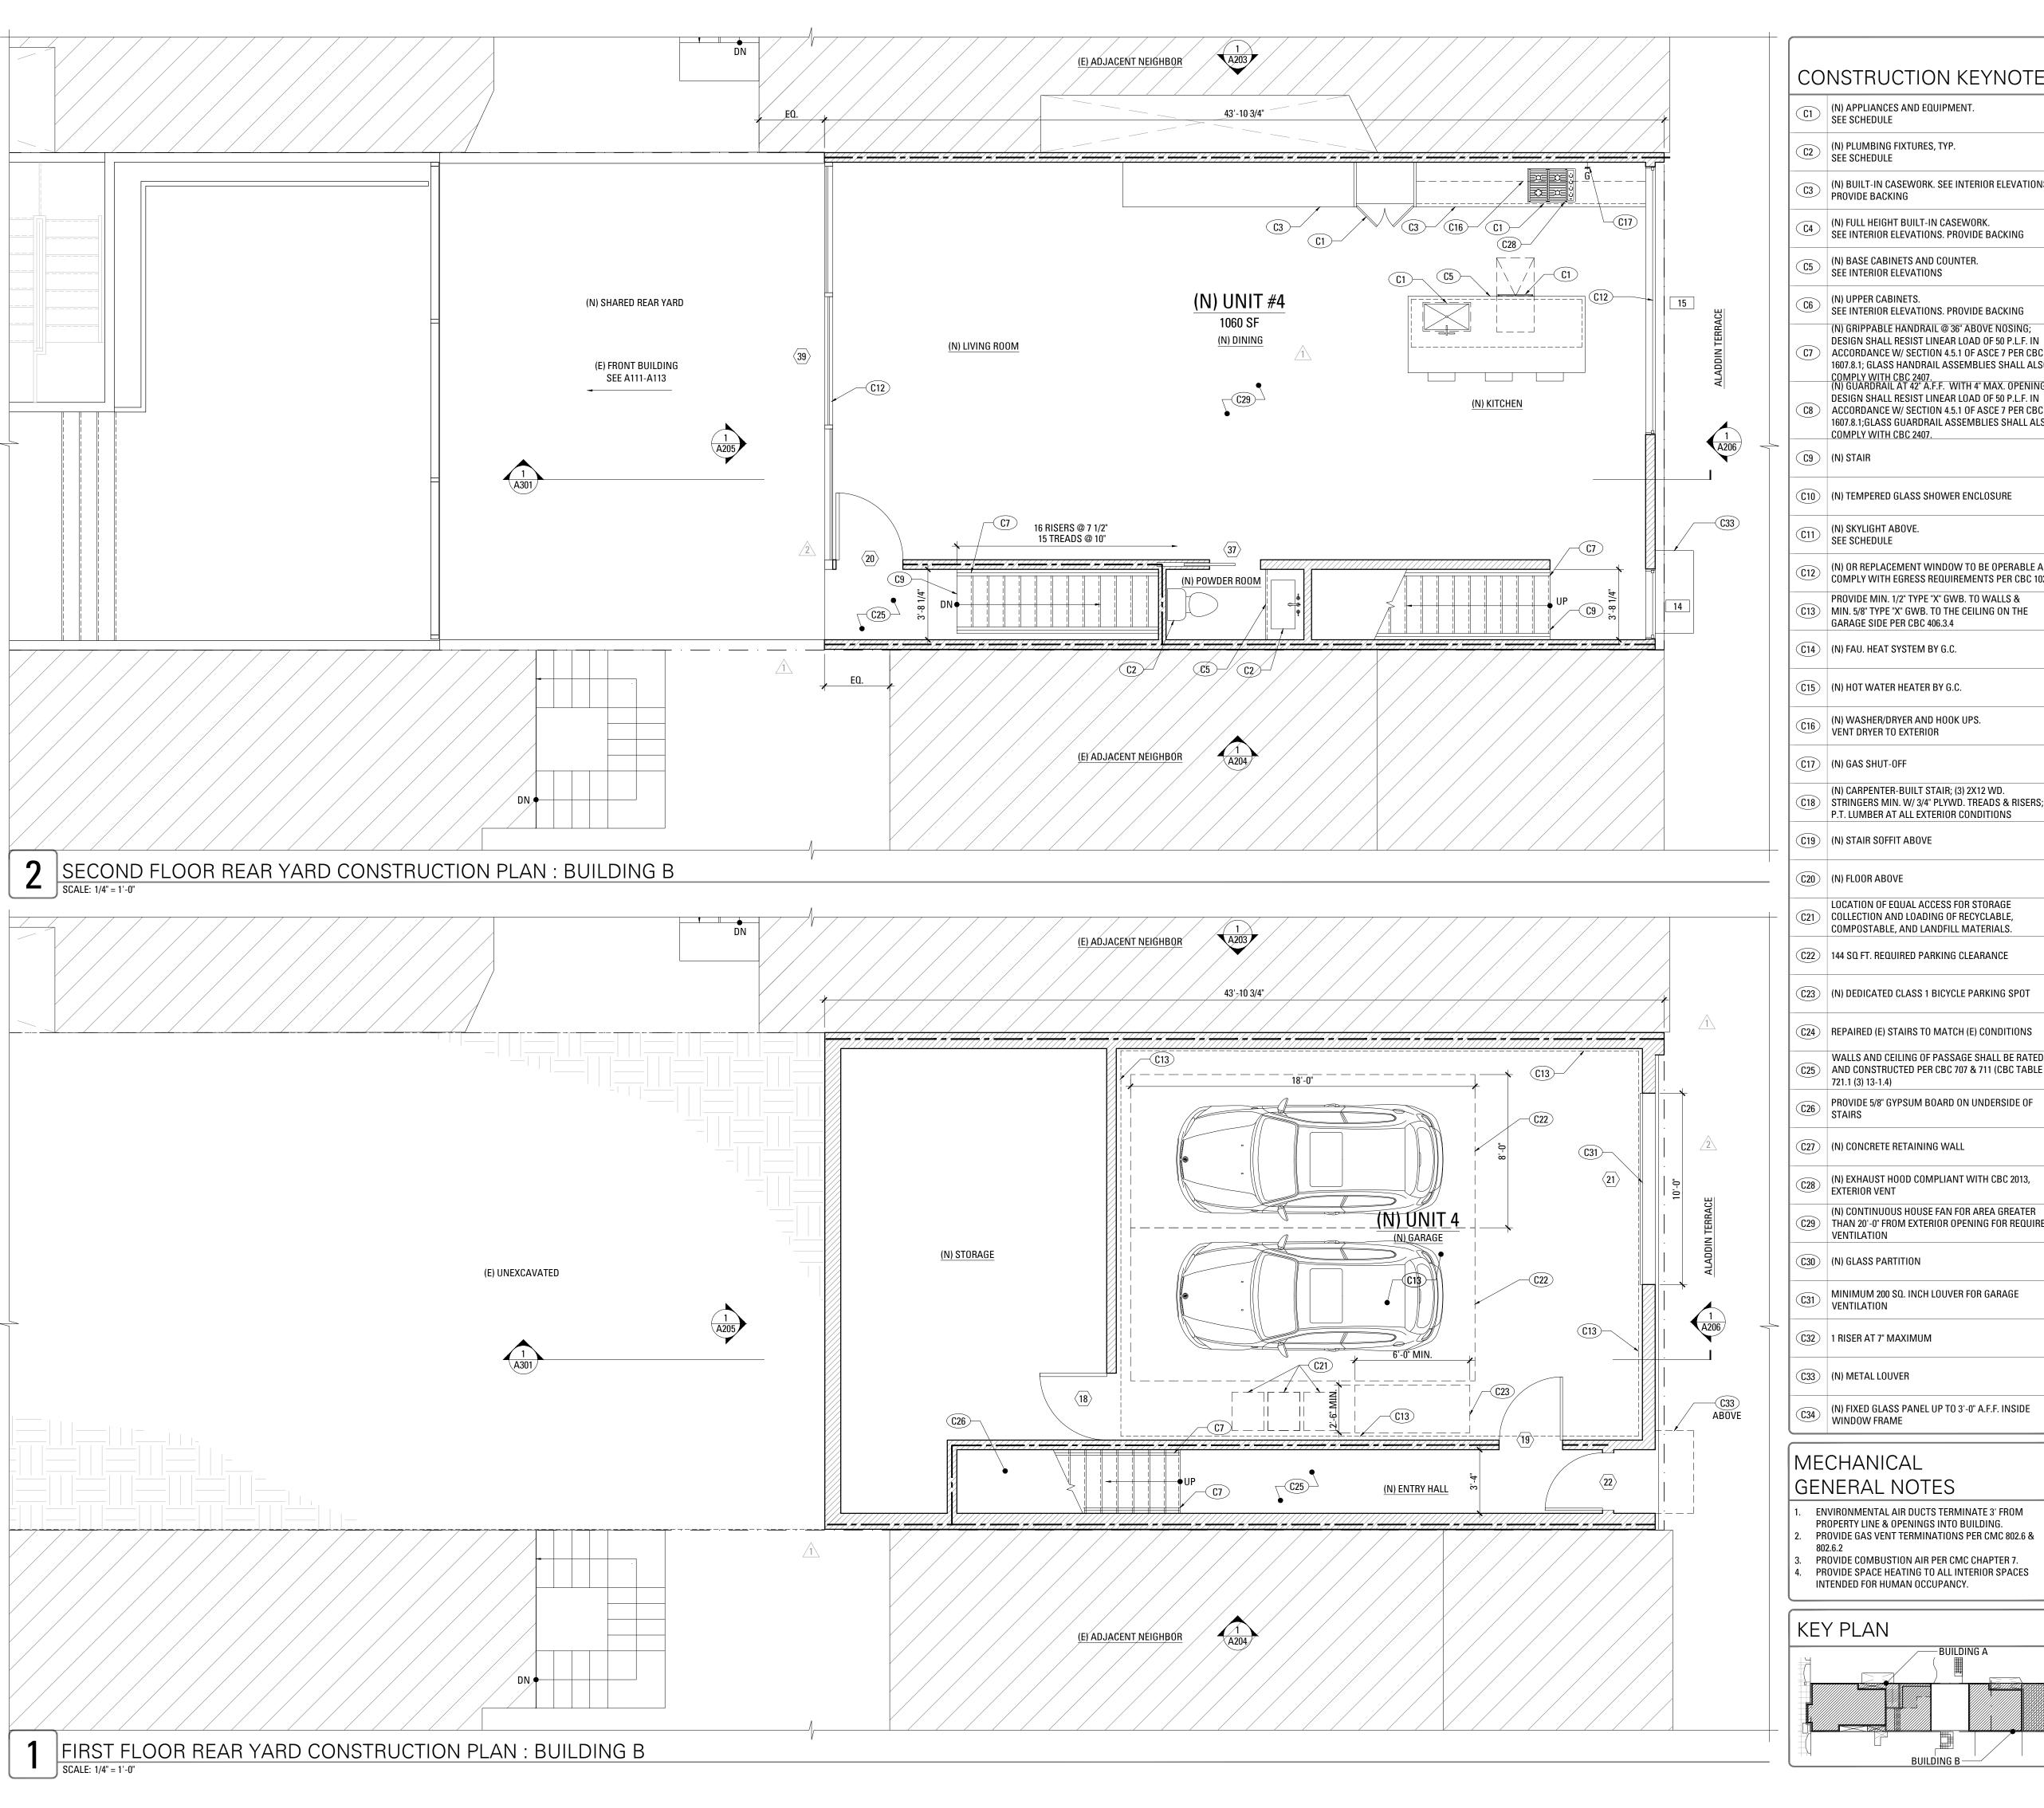
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SITE PERMIT SET **REVISION 3** Drawn By: S.A. Checked By: B.M. Project Number: 1554.1


Construction Plan



- (N) PLUMBING FIXTURES, TYP. SEE SCHEDULE
- (N) BUILT-IN CASEWORK. SEE INTERIOR ELEVATIONS. PROVIDE BACKING
- (N) FULL HEIGHT BUILT-IN CASEWORK.
 SEE INTERIOR ELEVATIONS. PROVIDE BACKING
- (N) BASE CABINETS AND COUNTER. SEE INTERIOR ELEVATIONS
- SEE INTERIOR ELEVATIONS. PROVIDE BACKING (N) GRIPPABLE HANDRAIL @ 36" ABOVE NOSING;
- (C7) ACCORDANCE W/ SECTION 4.5.1 OF ASCE 7 PER CBC 1607.8.1; GLASS HANDRAIL ASSEMBLIES SHALL ALSO COMPLY WITH CBC 2407. (N) GUARDRAIL AT 42" A.F.F. WITH 4" MAX. OPENING:
- DESIGN SHALL RESIST LINEAR LOAD OF 50 P.L.F. IN (C8) ACCORDANCE W/ SECTION 4.5.1 OF ASCE 7 PER CBC 1607.8.1;GLASS GUARDRAIL ASSEMBLIES SHALL ALSO
- (C10) (N) TEMPERED GLASS SHOWER ENCLOSURE
- (N) OR REPLACEMENT WINDOW TO BE OPERABLE AND COMPLY WITH EGRESS REQUIREMENTS PER CBC 1029
- PROVIDE MIN. 1/2" TYPE "X" GWB. TO WALLS & (C13) | MIN. 5/8" TYPE "X" GWB. TO THE CEILING ON THE GARAGE SIDE PER CBC 406.3.4
- (C14) (N) FAU. HEAT SYSTEM BY G.C.
- (C15) (N) HOT WATER HEATER BY G.C.
- (N) WASHER/DRYER AND HOOK UPS. VENT DRYER TO EXTERIOR
- (N) CARPENTER-BUILT STAIR; (3) 2X12 WD. (C18) | STRINGERS MIN. W/ 3/4" PLYWD. TREADS & RISERS;
- (C19) (N) STAIR SOFFIT ABOVE
- LOCATION OF EQUAL ACCESS FOR STORAGE C21 COLLECTION AND LOADING OF RECYCLABLE,
- (C23) (N) DEDICATED CLASS 1 BICYCLE PARKING SPOT
- (C24) REPAIRED (E) STAIRS TO MATCH (E) CONDITIONS
- WALLS AND CEILING OF PASSAGE SHALL BE RATED (C25) AND CONSTRUCTED PER CBC 707 & 711 (CBC TABLE
- PROVIDE 5/8" GYPSUM BOARD ON UNDERSIDE OF
- (C27) (N) CONCRETE RETAINING WALL
- (N) EXHAUST HOOD COMPLIANT WITH CBC 2013, EXTERIOR VENT
- (N) CONTINUOUS HOUSE FAN FOR AREA GREATER (C29) THAN 20'-0" FROM EXTERIOR OPENING FOR REQUIRED
- (C30) (N) GLASS PARTITION
- MINIMUM 200 SQ. INCH LOUVER FOR GARAGE VENTILATION
- (C32) | 1 RISER AT 7" MAXIMUM
- (N) FIXED GLASS PANEL UP TO 3'-0" A.F.F. INSIDE

MECHANICAL

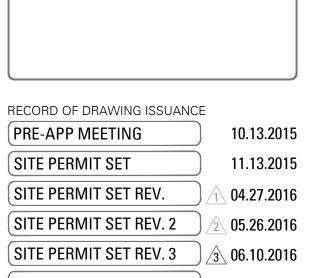- ENVIRONMENTAL AIR DUCTS TERMINATE 3' FROM PROPERTY LINE & OPENINGS INTO BUILDING.
- PROVIDE COMBUSTION AIR PER CMC CHAPTER 7. PROVIDE SPACE HEATING TO ALL INTERIOR SPACES

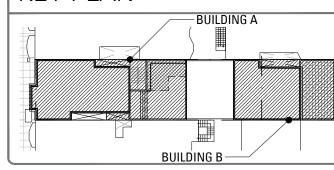

LEGEND

(E) WALL CONSTRUCTION



INDICATES RATED ASSEMBLY.
SEE SHEET A901.

(N) SOUND ATTENUATION BATT INSULATION

(N) GAS SHUT OFF; LOCATE IN ACCESSIBLE AREA IN CABINET [CMC 1312.3]

NOTE: ALL (N) WALLS TYPE "A" U.O.N.

CONSTRUCTION GENERAL NOTES

- ALL (N) WALLS TYPE "A" U.O.N. SEE SCHEDULE, A901. ALL DIMENSIONS ARE TO FACE OF FINISH, CENTERLINE OF OPENING OR EDGE OF JAMB FRAME, U.O.N. DOORS NOT LOCATED BY DIMENSION SHALL BE
- PLACED 3" OFF JAMB, U.O.N. ALL REQUIRED HANDRAILS SHALL COMPLY WITH
- HANDRAIL GRASPABILITY PER CBC 1012.3. PROVIDE & INSTALL FLASHING, COUNTERFLASHING, CAP FLASHING, METAL TRIM, OTHER FABRICATED ITEMS AND MISCELLANEOUS SHEET METALWORK AT JUNCTIONS OF A ROOF AND WALL, AT CHIMNEYS, OVER EXPOSED DOORS AND WINDOWS, AT CHANGES OF SIDING MATERIAL IN ROOF VALLEYS OR WHERE REQUIRED TO PROVIDE COMPLETE WATERTIGHT AND
- WATERPROOF CONSTRUCTION. PROVIDE & INSTALL ONE PIECE GSM PAN FLASHING AT ALL NEW AND REPLACEMENT EXTERIOR DOORS. COMPLY WITH ASTM E2112-07, STANDARD PRACTICE FOR INSTALLATION OF EXTERIOR WINDOWS, DOORS, AND SKYLIGHTS.
- WATERPROOFING SHALL OVERLAP FLASHINGS FOR POSITIVE DRAINAGE AT ALL CONDITIONS.
- FLASHING & SHEET METALWORK SHALL BE FABRICATED AND INSTALLED IN ACCORDANCE WITH SHEET METAL & AIR CONDITIONING CONTRACTORS' NATIONAL ASSOCIATION (SMACNA) ARCHITECTURAL SHEET METAL MANUAL. COMPLY WITH MINIMUM THICKNESS OR GAGE REQUIREMENTS AS SPECIFIED IN SMACNA ARCHITECTURAL SHEET METAL MANUAL.
- ISOLATE AND PROTECT DISSIMILAR METALS FROM CONTACT WITH EACH OTHER BY APPLYING SPECIFIED ISOLATION MATERIAL TO CONTACT SURFACES. PROTECT SURFACES OF SHEET METAL IN CONTACT WITH CONCRETE, TREATED WOOD, OR ALUMINUM WITH A HEAVY COATING OF BITUMINOUS PAINT AS RECOMMENDED BY MANUFACTURER/FABRICATOR.
- FLASHING & SHEET METALWORK WILL NOT BE MEASURED SEPARATELY FOR PAYMENT BUT WILL BE PAID FOR AS PART OF THE CONTRACT LUMP SUM PRICE FOR ARCHITECTURAL WORK. PROVIDE MINIMUM OF R-13 BATT INSULATION IN
- SPACE, IN AREAS NOT ALREADY INSULATED PROVIDE CEMENT BOARD BACKING IN AREAS TO RECEIVE TILE FINISH

EXTERIOR WALLS ADJACENT TO (N) AND (F) LIVING

- 13. WOOD LOCATED NEARER THAN 6" TO EARTH SHALL BE
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- 8. ALL EXISTING NON-COMPLIANT AND NEW PLUMBING FIXTURES SHALL COMPLY WITH CALIFORNIA SB-407
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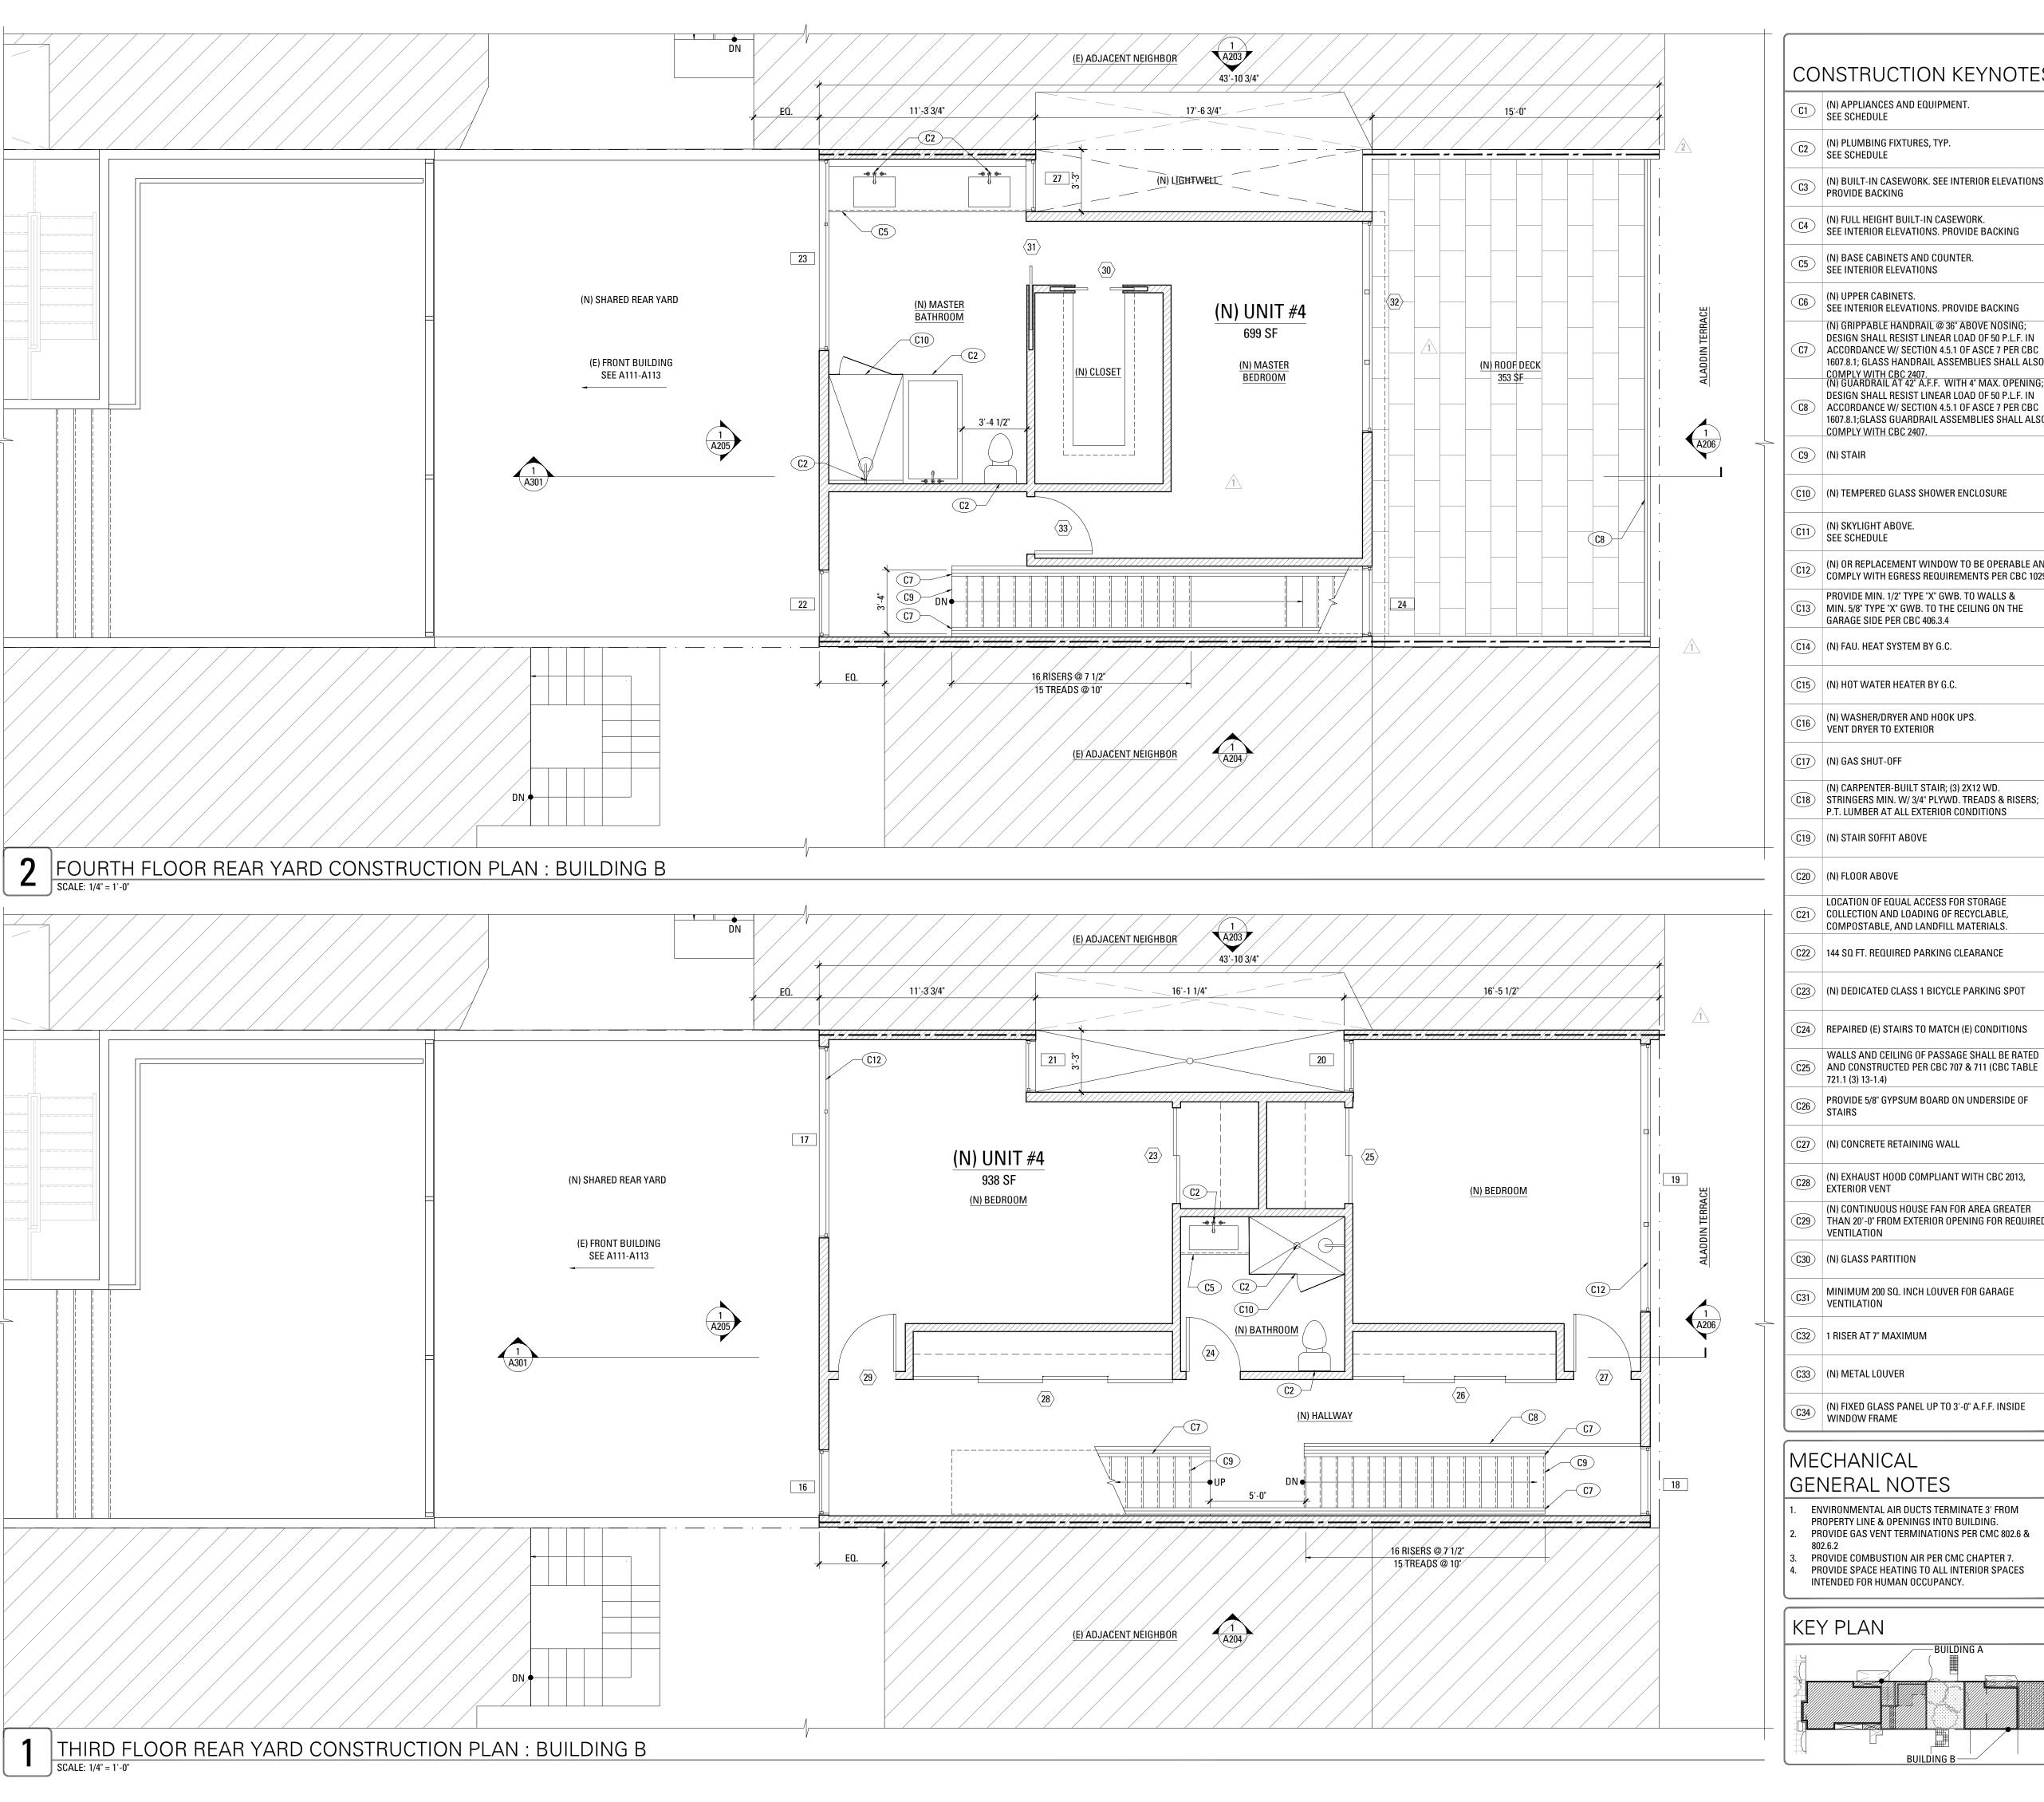
RECORD OF DRAWING ISSUANCE PRE-APP MEETING 10.13.2015 SITE PERMIT SET 11.13.2015 SITE PERMIT SET REV. 04.27.2016 SITE PERMIT SET REV. 2 05.26.2016 SITE PERMIT SET REV. 3 *∕*₃√ 06.10.2016

> SITE PERMIT SET **REVISION 3** Drawn By: S.A. Checked By: B.M.

Construction Plan

1554.1


Project Number:



- (N) BUILT-IN CASEWORK. SEE INTERIOR ELEVATIONS. PROVIDE BACKING
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- (C13) MIN. 5/8" TYPE "X" GWB. TO THE CEILING ON THE GARAGE SIDE PER CBC 406.3.4
- (C14) (N) FAU. HEAT SYSTEM BY G.C.
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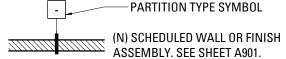
GENERAL NOTES

- PROPERTY LINE & OPENINGS INTO BUILDING.
- PROVIDE GAS VENT TERMINATIONS PER CMC 802.6 &
- PROVIDE SPACE HEATING TO ALL INTERIOR SPACES INTENDED FOR HUMAN OCCUPANCY.

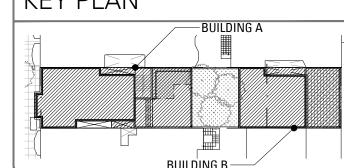

LEGEND

(E) WALL CONSTRUCTION



INDICATES RATED ASSEMBLY.
SEE SHEET A901.

(N) SOUND ATTENUATION BATT INSULATION

(N) GAS SHUT OFF; LOCATE IN ACCESSIBLE AREA IN

CABINET [CMC 1312.3] NOTE: ALL (N) WALLS TYPE "A" U.O.N.

CONSTRUCTION GENERAL NOTES

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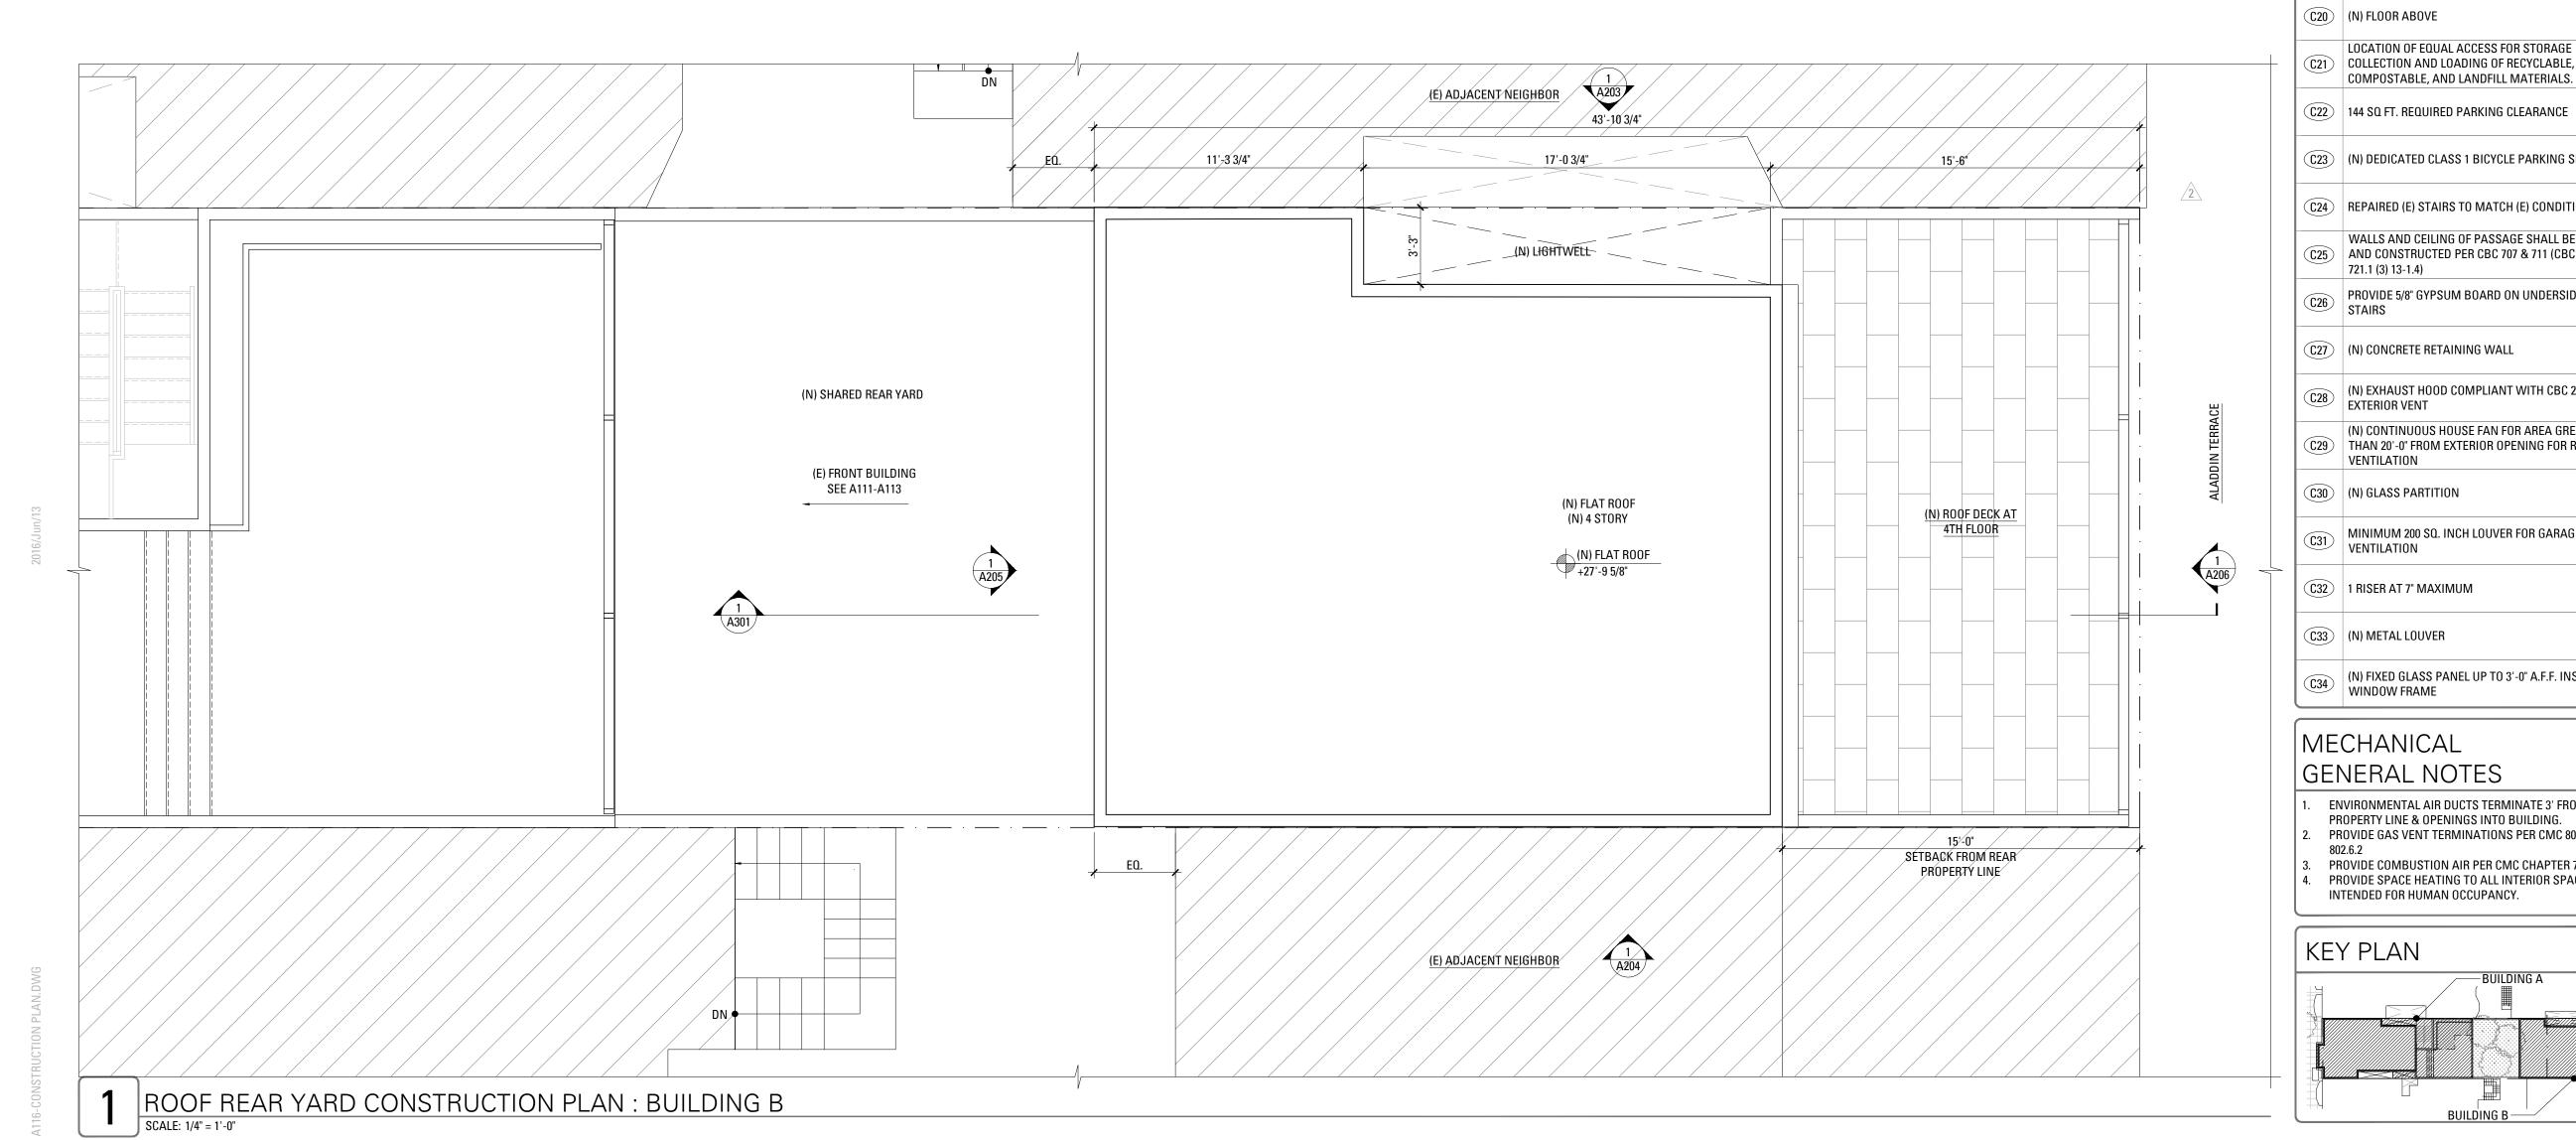
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SITE PERMIT SET **REVISION 3** Drawn By: S.A. Checked By: B.M. Project Number: 1554.1


Construction Plan



- (N) APPLIANCES AND EQUIPMENT. SEE SCHEDULE
- (N) PLUMBING FIXTURES, TYP. SEE SCHEDULE
- (N) BUILT-IN CASEWORK. SEE INTERIOR ELEVATIONS. PROVIDE BACKING
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 SEE INTERIOR ELEVATIONS. PROVIDE BACKING
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- (N) SKYLIGHT ABOVE. SEE SCHEDULE
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- PROVIDE MIN. 1/2" TYPE "X" GWB. TO WALLS & (C13) MIN. 5/8" TYPE "X" GWB. TO THE CEILING ON THE GARAGE SIDE PER CBC 406.3.4
- (C14) (N) FAU. HEAT SYSTEM BY G.C.
- (N) HOT WATER HEATER BY G.C.
- (N) WASHER/DRYER AND HOOK UPS. VENT DRYER TO EXTERIOR
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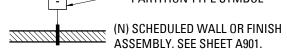
MECHANICAL GENERAL NOTES

- ENVIRONMENTAL AIR DUCTS TERMINATE 3' FROM PROPERTY LINE & OPENINGS INTO BUILDING. PROVIDE GAS VENT TERMINATIONS PER CMC 802.6 &
- PROVIDE COMBUSTION AIR PER CMC CHAPTER 7. PROVIDE SPACE HEATING TO ALL INTERIOR SPACES INTENDED FOR HUMAN OCCUPANCY.

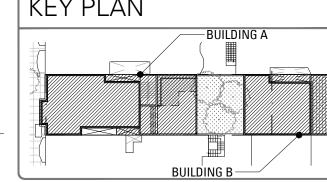

LEGEND

(E) WALL CONSTRUCTION PARTITION TYPE SYMBOL



INDICATES RATED ASSEMBLY. SEE SHEET A901.

(N) SOUND ATTENUATION BATT INSULATION

(N) GAS SHUT OFF; LOCATE IN ACCESSIBLE AREA IN CABINET [CMC 1312.3]

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- PLACED 3" OFF JAMB, U.O.N. ALL REQUIRED HANDRAILS SHALL COMPLY WITH
- HANDRAIL GRASPABILITY PER CBC 1012.3. PROVIDE & INSTALL FLASHING, COUNTERFLASHING, CAP FLASHING, METAL TRIM, OTHER FABRICATED ITEMS AND MISCELLANEOUS SHEET METALWORK AT JUNCTIONS OF A ROOF AND WALL, AT CHIMNEYS, OVER EXPOSED DOORS AND WINDOWS, AT CHANGES OF SIDING MATERIAL IN ROOF VALLEYS OR WHERE REQUIRED TO PROVIDE COMPLETE WATERTIGHT AND WATERPROOF CONSTRUCTION.
- PROVIDE & INSTALL ONE PIECE GSM PAN FLASHING AT ALL NEW AND REPLACEMENT EXTERIOR DOORS. COMPLY WITH ASTM E2112-07, STANDARD PRACTICE FOR INSTALLATION OF EXTERIOR WINDOWS, DOORS, AND SKYLIGHTS.
- WATERPROOFING SHALL OVERLAP FLASHINGS FOR POSITIVE DRAINAGE AT ALL CONDITIONS.
- FLASHING & SHEET METALWORK SHALL BE FABRICATED AND INSTALLED IN ACCORDANCE WITH SHEET METAL & AIR CONDITIONING CONTRACTORS' NATIONAL ASSOCIATION (SMACNA) ARCHITECTURAL SHEET METAL MANUAL. COMPLY WITH MINIMUM THICKNESS OR GAGE REQUIREMENTS AS SPECIFIED IN SMACNA ARCHITECTURAL SHEET METAL MANUAL.
- ISOLATE AND PROTECT DISSIMILAR METALS FROM CONTACT WITH EACH OTHER BY APPLYING SPECIFIED ISOLATION MATERIAL TO CONTACT SURFACES. PROTECT SURFACES OF SHEET METAL IN CONTACT WITH CONCRETE, TREATED WOOD, OR ALUMINUM WITH A HEAVY COATING OF BITUMINOUS PAINT AS RECOMMENDED BY MANUFACTURER/FABRICATOR.
- 0. FLASHING & SHEET METALWORK WILL NOT BE MEASURED SEPARATELY FOR PAYMENT BUT WILL BE PAID FOR AS PART OF THE CONTRACT LUMP SUM PRICE FOR ARCHITECTURAL WORK. PROVIDE MINIMUM OF R-13 BATT INSULATION IN
- SPACE, IN AREAS NOT ALREADY INSULATED 2. PROVIDE CEMENT BOARD BACKING IN AREAS TO RECEIVE TILE FINISH

EXTERIOR WALLS ADJACENT TO (N) AND (F) LIVING

- 13. WOOD LOCATED NEARER THAN 6" TO EARTH SHALL BE TREATED WOOD
- 14. ALL DOORS AND WINDOWS NOT TAGGED ARE
- EXISTING TO REMAIN U.O.N. 15. ALL TOILETS TO HAVE A MINIMUM CLEARANCE OF 24" IN FRONT AND 15" FROM CENTERLINE OF THE TOILET TO
- EACH SIDE. S. STAIRWAYS SHALL HAVE A MINIMUM HEADROOM CLEARANCE OF 80 INCHES ABOVE THE FRONT EDGE OF
- THE NOSING. ALL APPLIANCES WITH QUICK-ACTING VALVES, INCLUDING BUT NOT LIMITED TO DISHWASHERS & CLOTHES WASHERS, SHALL HAVE WATER HAMMER
- ARRESTORS (CPC 609.10) 8. ALL EXISTING NON-COMPLIANT AND NEW PLUMBING FIXTURES SHALL COMPLY WITH CALIFORNIA SB-407
- WATER HEATERS SHALL HAVE SEISMIC STRAPPING AT A POINT WITHIN THE UPPER 1/3 AND THE LOWER 1/3 OF THE WATER HEATER'S VERTICAL DIMENSIONS. AT THE LOWER POINT, A MINIMUM DISTANCE OF FOUR (4) INCHES SHALL BE MAINTAINED ABOVE THE CONTROLS
- TO THE STRAP. (CPC 507.2)). KITCHEN RANGES SHALL BE PROVIDED WITH A METAL VENTILATING HOOD. A VERTICAL CLEARANCE OF 24" MINIMUM BETWEEN THE COOKTOP & METAL VENTILATING HOOD SHALL BE MAINTAINED. THE HOOD SHALL BE AS WIDE AS THE RANGE AND
- CENTERED OVER THE UNIT. THE METAL HOOD SHALL BE 0.0122" MINIMUM THICK (2013 CMC 920.3) EACH KITCHEN IS REQUIRED TO HAVE AN EXHAUST FAN DUCTED TO THE OUTSIDE WITH A MINIMUM
- VENTILATION RATE OF 100 CFM. 22. ALL EXHAUST FAN DUCTING, INCLUDING BUT NOT LIMITED TO TO KITCHEN AND BATHROOM EXHAUST FANS, SHALL BE SIZED ACCORDING TO ASHRAE STANDARD 62.2 TABLE 7.1.
- . APPLIANCES IN ATTIC AND UNDER-FLOOR SPACES SHALL BE ACCESSIBLE THROUGH AN OPENING AND PASSAGEWAY AT LEAST AS LARGE AS THE LARGEST COMPONENT OF THE APPLIANCE, AND NOT LESS THAN 22 INCHES BY 30 INCHES. (CPC 508.4) APPLIANCES IN ATTIC AND UNDER-FLOOR SPACES
- SHALL HAVE A SOLID FLOOR PASSAGEWAY OF NOT LESS THAN 24 INCHES AND A WORK PLATFORM OF NOT LESS THAN 30 INCHES BY 30 INCHES IN FRONT OF THE SERVICE SIDE OF THE APPLIANCE. (CPC 508.4.2 &
- 5. APPLIANCES IN ATTIC AND UNDER-FLOOR SPACES SHALL HAVE A PERMANENT 120-VOLT RECEPTACLE OUTLET AND A LIGHTING FIXTURE NEAR THE APPLIANCE. (CPC 508.4.4)


870 Union Street Residence Addition and Remodel

> 870 UNION STREET, SAN FRANCISCO, CA 94133

MARTINKOVIC MILFORD ARCHITECT

101 Montgomery Street Suite 650 San Francisco, CA 94104 T 415 346 9990



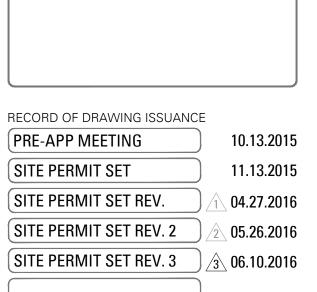

SITE PERMIT SET **REVISION 3** Drawn By: S.A. Checked By: B.M. Project Number: 1554.1

Construction Plan

HEIGHT LIMIT +40'-0"

(E) ROOF +35'-2 1/2"

(E) THIRD FLOOR +22'-4 1/4"

(E) SECOND FLOOR +11'-4 3/8"

(E) AVERAGE STREET GRADE

(E) FIRST FLOOR -2'-4 3/4"

ADJACENT NEIGHBOR

878, 880, 882 UNION ST

(D)

10'-5"

(E) BAY WINDOW

(E) STREET GRADE

(E)

PROPOSED FRONT ELEVATION : BUILDING A (SOUTH)

SCALE: 3/16" = 1'-0"

EXTERIOR ELEVATION KEYNOTES

- ADJACENT NEIGHBOR

864, 866, 868 UNION ST

(E) (E) DOOR OR WINDOW, TO REMAIN

(D) (E) DOOR OR WINDOW, TO BE REMOVED

(N) (N) DOOR OR WINDOW, SEE SCHEDULE A901 AND A902

(R) REPLACE (E) WINDOW OR DOOR IN KIND, SEE SCHEDULE A901 AND A902

(1) (E) PARTIAL HEIGHT WALL TO BE REMOVED

(E) PAINTED BRICK FINISH TO BE REMOVED

(N) WOOD SIDING

3 (E) WOOD FENCE

(5) (N) CONCRETE RETAINING WALL

(E) WOOD SIDING TO BE REMOVED

(E) WOOD FENCE TO BE REMOVED TO ACCOMMODATE (N) WORK

(E) LANDSCAPE RETAINING WALL TO BE REMOVED TO ACCOMMODATE (N) WORK

(E) WOOD STAIRS TO BE REMOVED

(N) WOOD DECK

(E) WOOD TRIM TO BE REMOVED

15 (N) GUARDRAIL

(16) (N) PAINTED PLASTER FINISH

(E) OPENING TO BE ENCLOSED

18 (E) BAY TO REMAIN

(N) EXIT CORRIDOR, OPEN TO BEYOND

(E) WOOD GUARDRAIL TO BE REMOVED

(E) AREA TO BE EXCAVATED TO ACCOMMODATE (N) WORK, SEE SECTIONS SHEET A301

REPAIR (E) EXTERIOR STAIRS TO MATCH (E) CONDITIONS

(N) ROOF LINE BEYOND PARAPET

(E) WOOD TRIM TO BE REMOVED TO PREPARE FOR (N) WORK

(E) EXTERIOR STAIRS TO BE REMOVED

(N) CONCRETE WALL

(E) RETAINING WALL TO BE REMOVED TO ACCOMMODATE (N) WORK

(E) LIGHT WELL BEYOND PROPERTY LINE WALL TO BE 29 ALTERED OR REMOVED, SEE CONSTRUCTION PLANS

(E) COLUMN TO BE REMOVED

(N) WOOD ROOF TRIM


(N) WOOD SIDING TO MATCH THE GARAGE DOOR FINISH

(N) DOORBELL

(N) RECESSED PEDESTRIAN ENTRANCE

(N) WALL SCONCE

(N) METAL AWNING (N) PAINTED BRICK FINISH

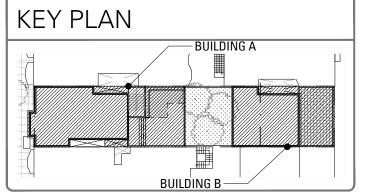

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(N) SMOOTH TROWLED, PAINTED PLASTER FINISH

RECORD OF DRAWING ISSUANCE PRE-APP MEETING 10.13.2015


11.13.2015 SITE PERMIT SET SITE PERMIT SET REV. 04.27.2016 SITE PERMIT SET REV. 2 05.26.2016 SITE PERMIT SET REV. 3 3 06.10.2016

SITE PERMIT SET REVISION 3 Drawn By: S.A. Checked By: B.M. 1554.1 Project Number:

Exterior Elevations





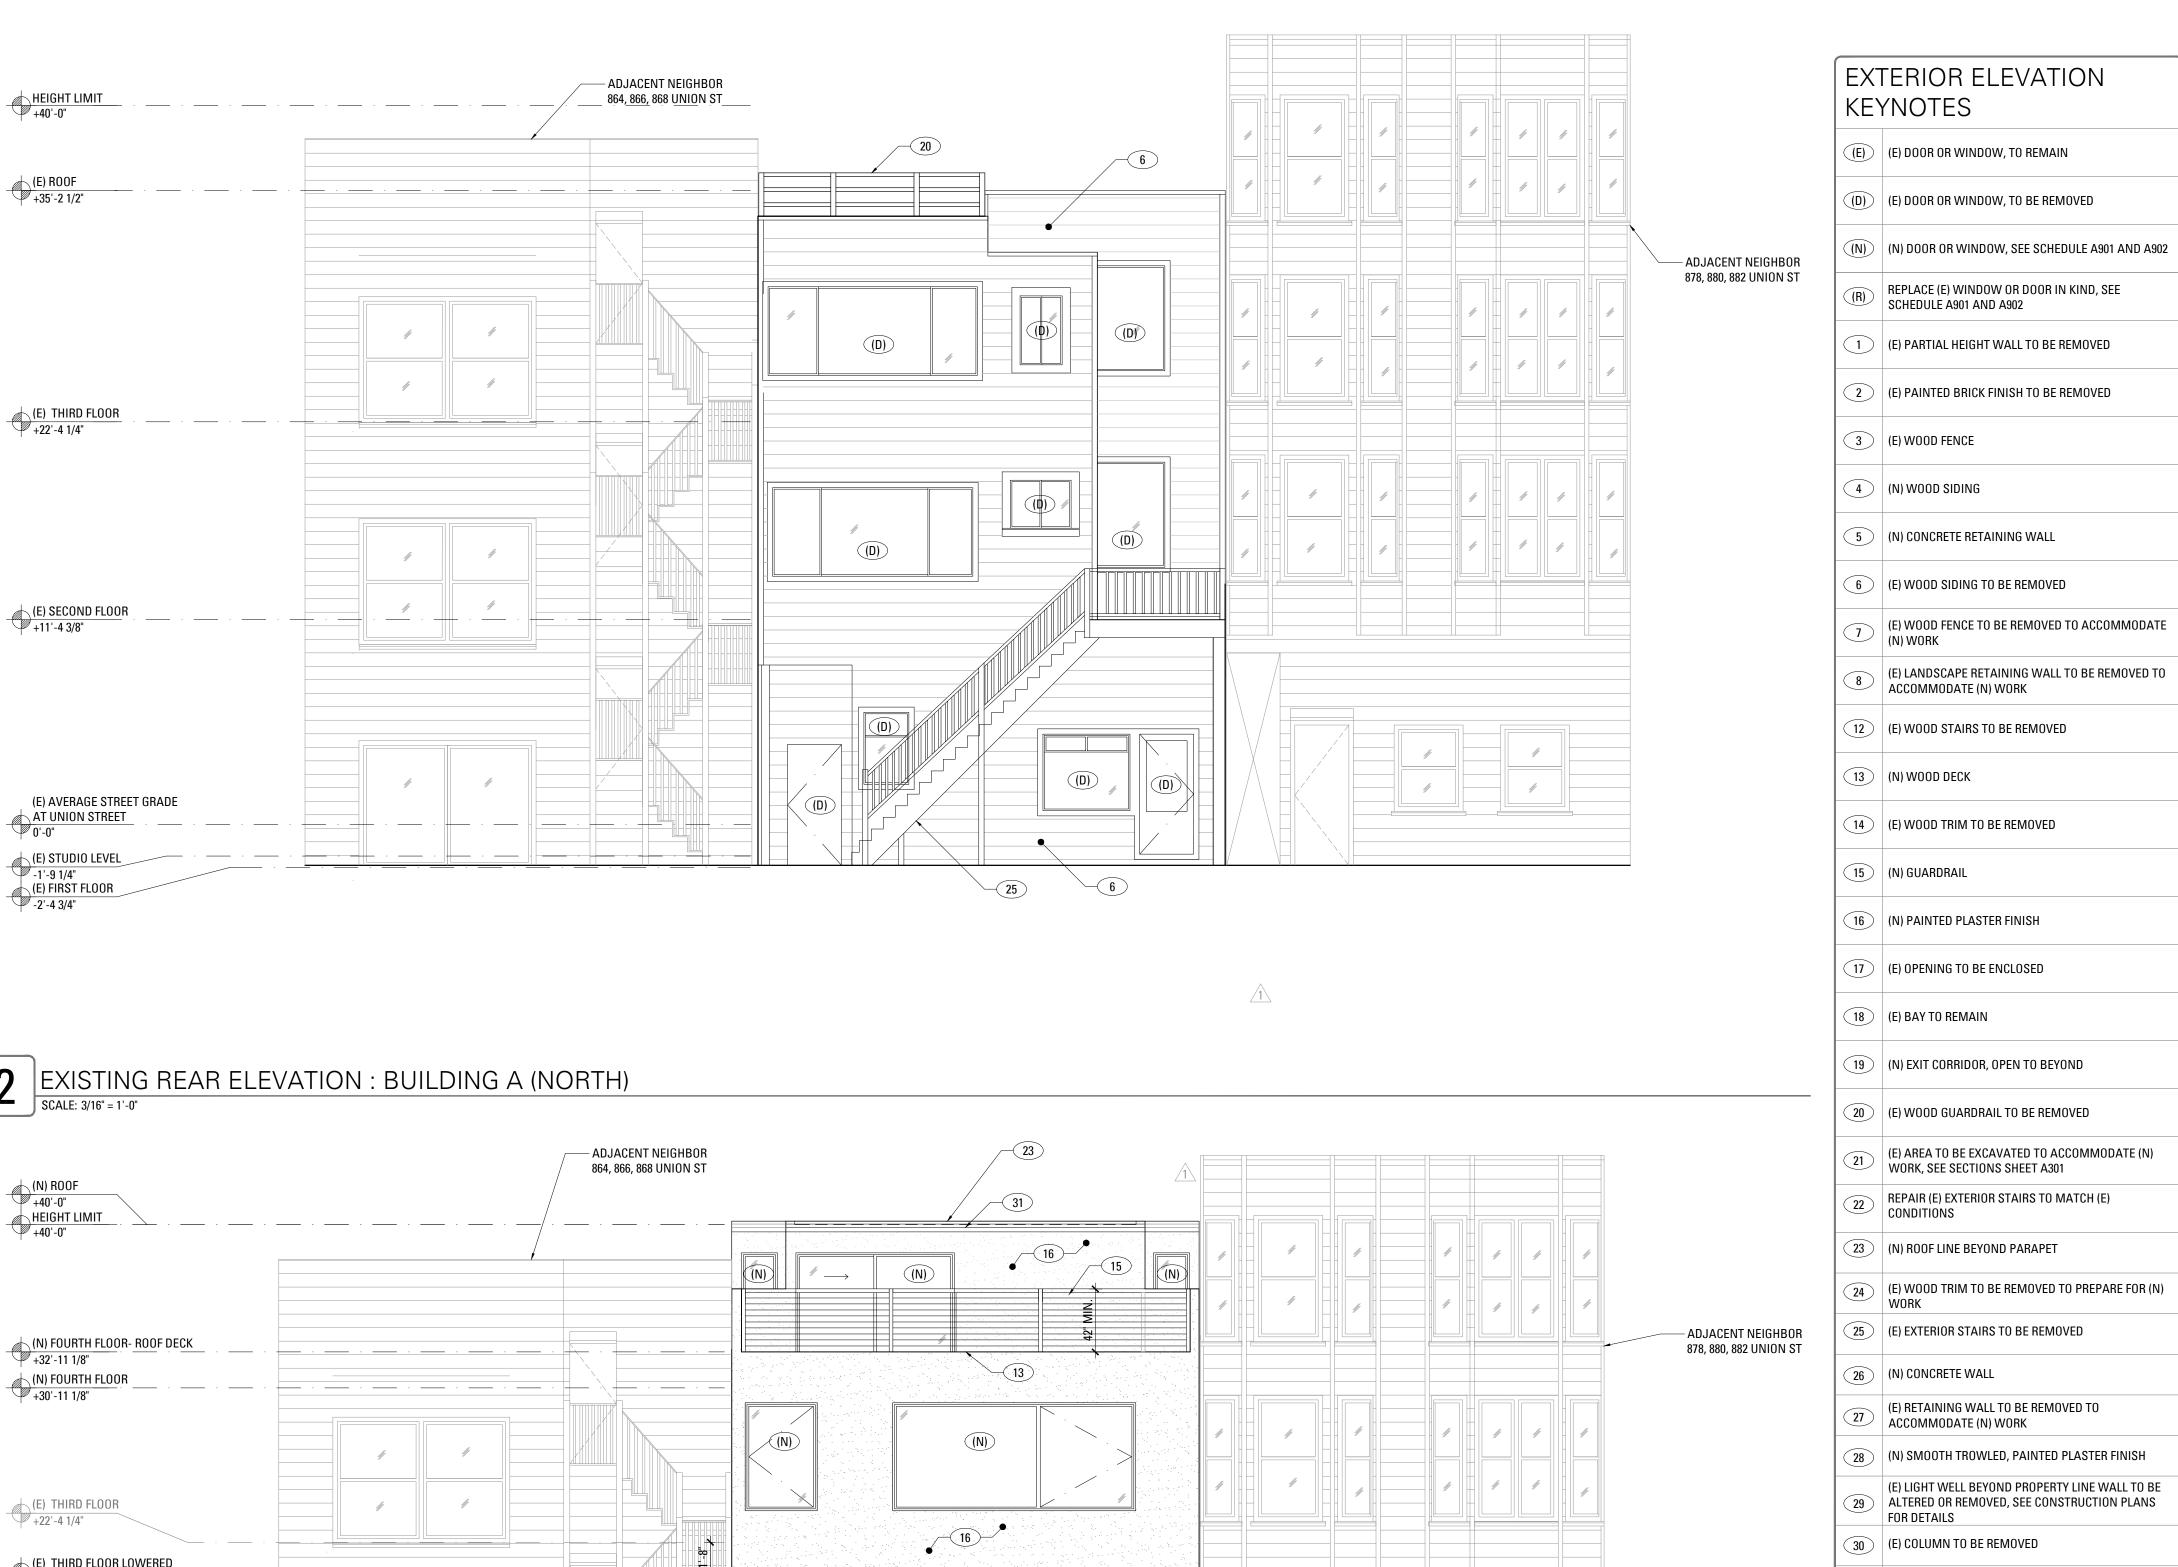

(N)

 $\overset{\text{(N)}}{\longrightarrow}$

(N)

19

31 (N) WOOD ROOF TRIM

32 (N) WOOD SIDING TO MATCH THE GARAGE DOOR FINISH

33 (N) DOORBELL

34 (N) RECESSED PEDESTRIAN ENTRANCE

35 (N) WALL SCONCE

36 (N) METAL AWNING

37 (N) PAINTED BRICK FINISH

PRE-APP MEETING

10.13.2015

SITE PERMIT SET

SITE PERMIT SET REV.

04.27.2016

SITE PERMIT SET REV. 2

05.26.2016

SITE PERMIT SET REV. 3

06.10.2016

870 Union Street

Residence Addition


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San Francisco, CA 94104 T 415 346 9990



SITE PERMIT SET
REVISION 3

Drawn By: S.A.
Checked By: B.M.
Project Number: 1554.1

Exterior Elevations

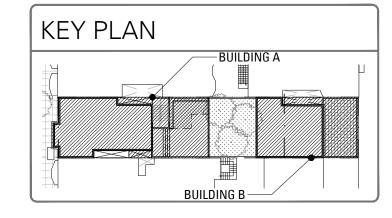A202

SHEET NUMBER

(E) THIRD FLOOR LOWERED +20'-8 1/4"


(E) SECOND FLOOR +11'-4 3/8"


(E) SECOND FLOOR LOWERED +9'-8 3/8"

(E) AVERAGE STREET GRADE


AT UNION STREET
0'-0"

(E) FIRST FLOOR_ -2'-4 3/4"

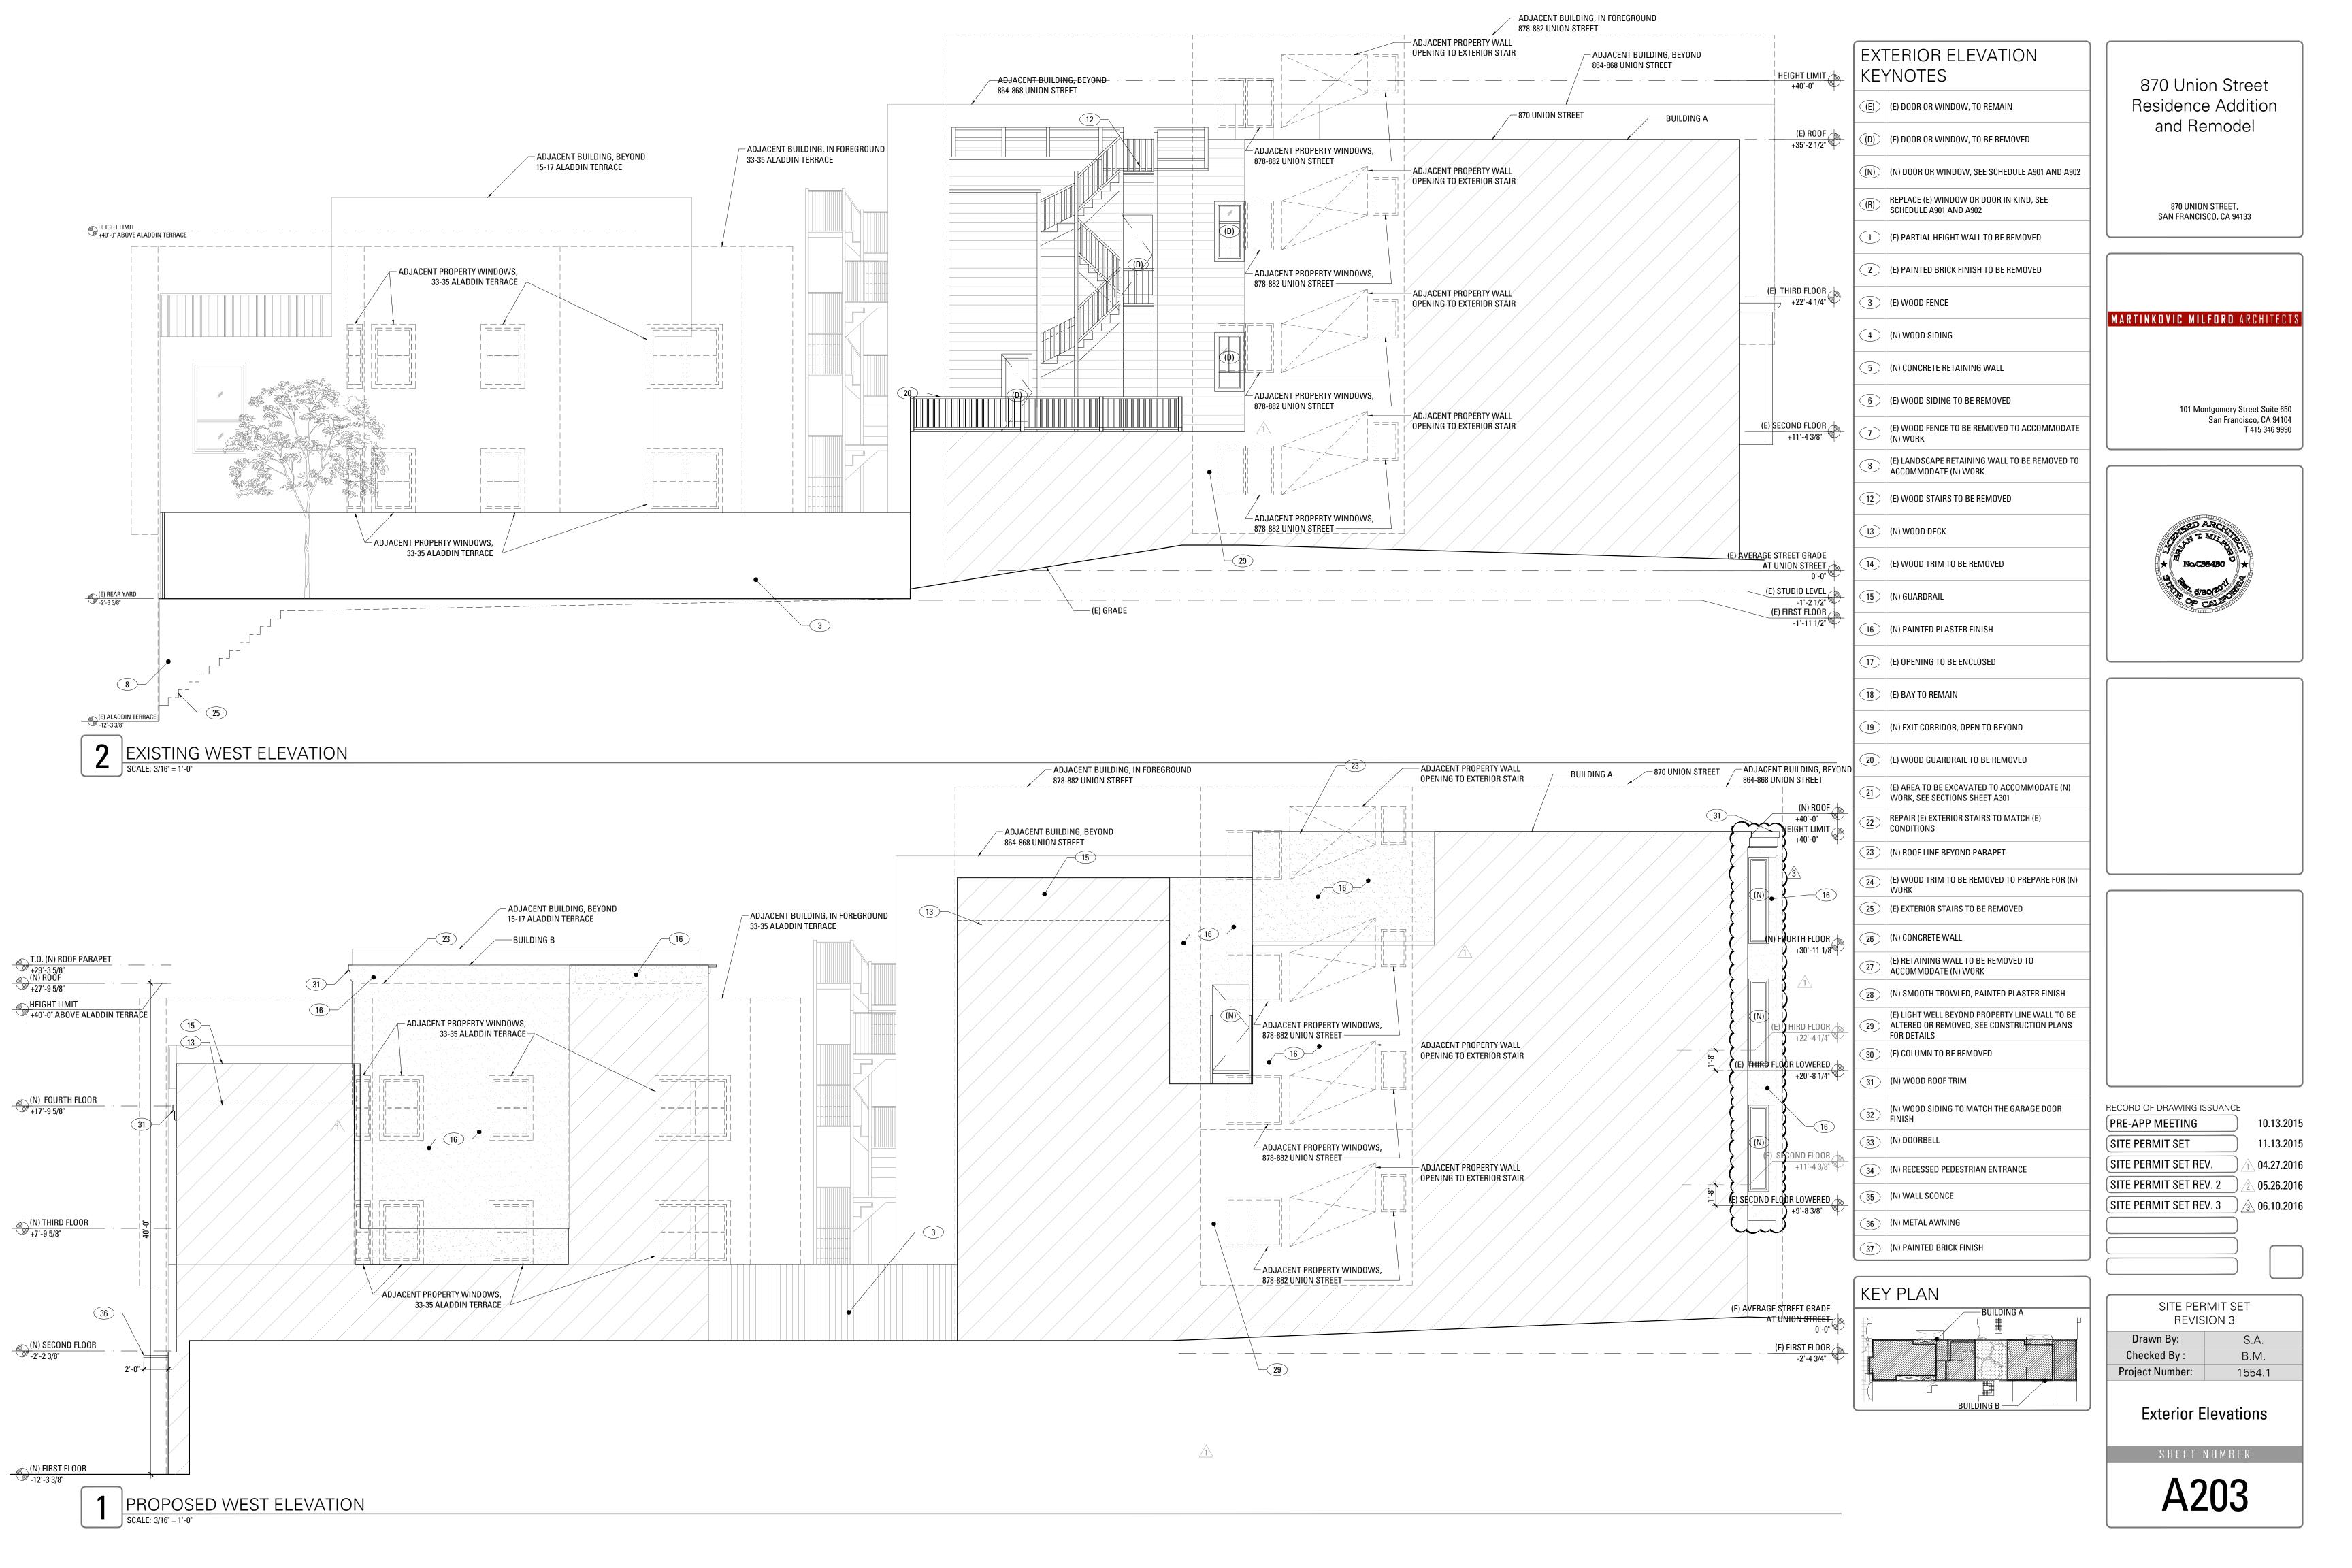


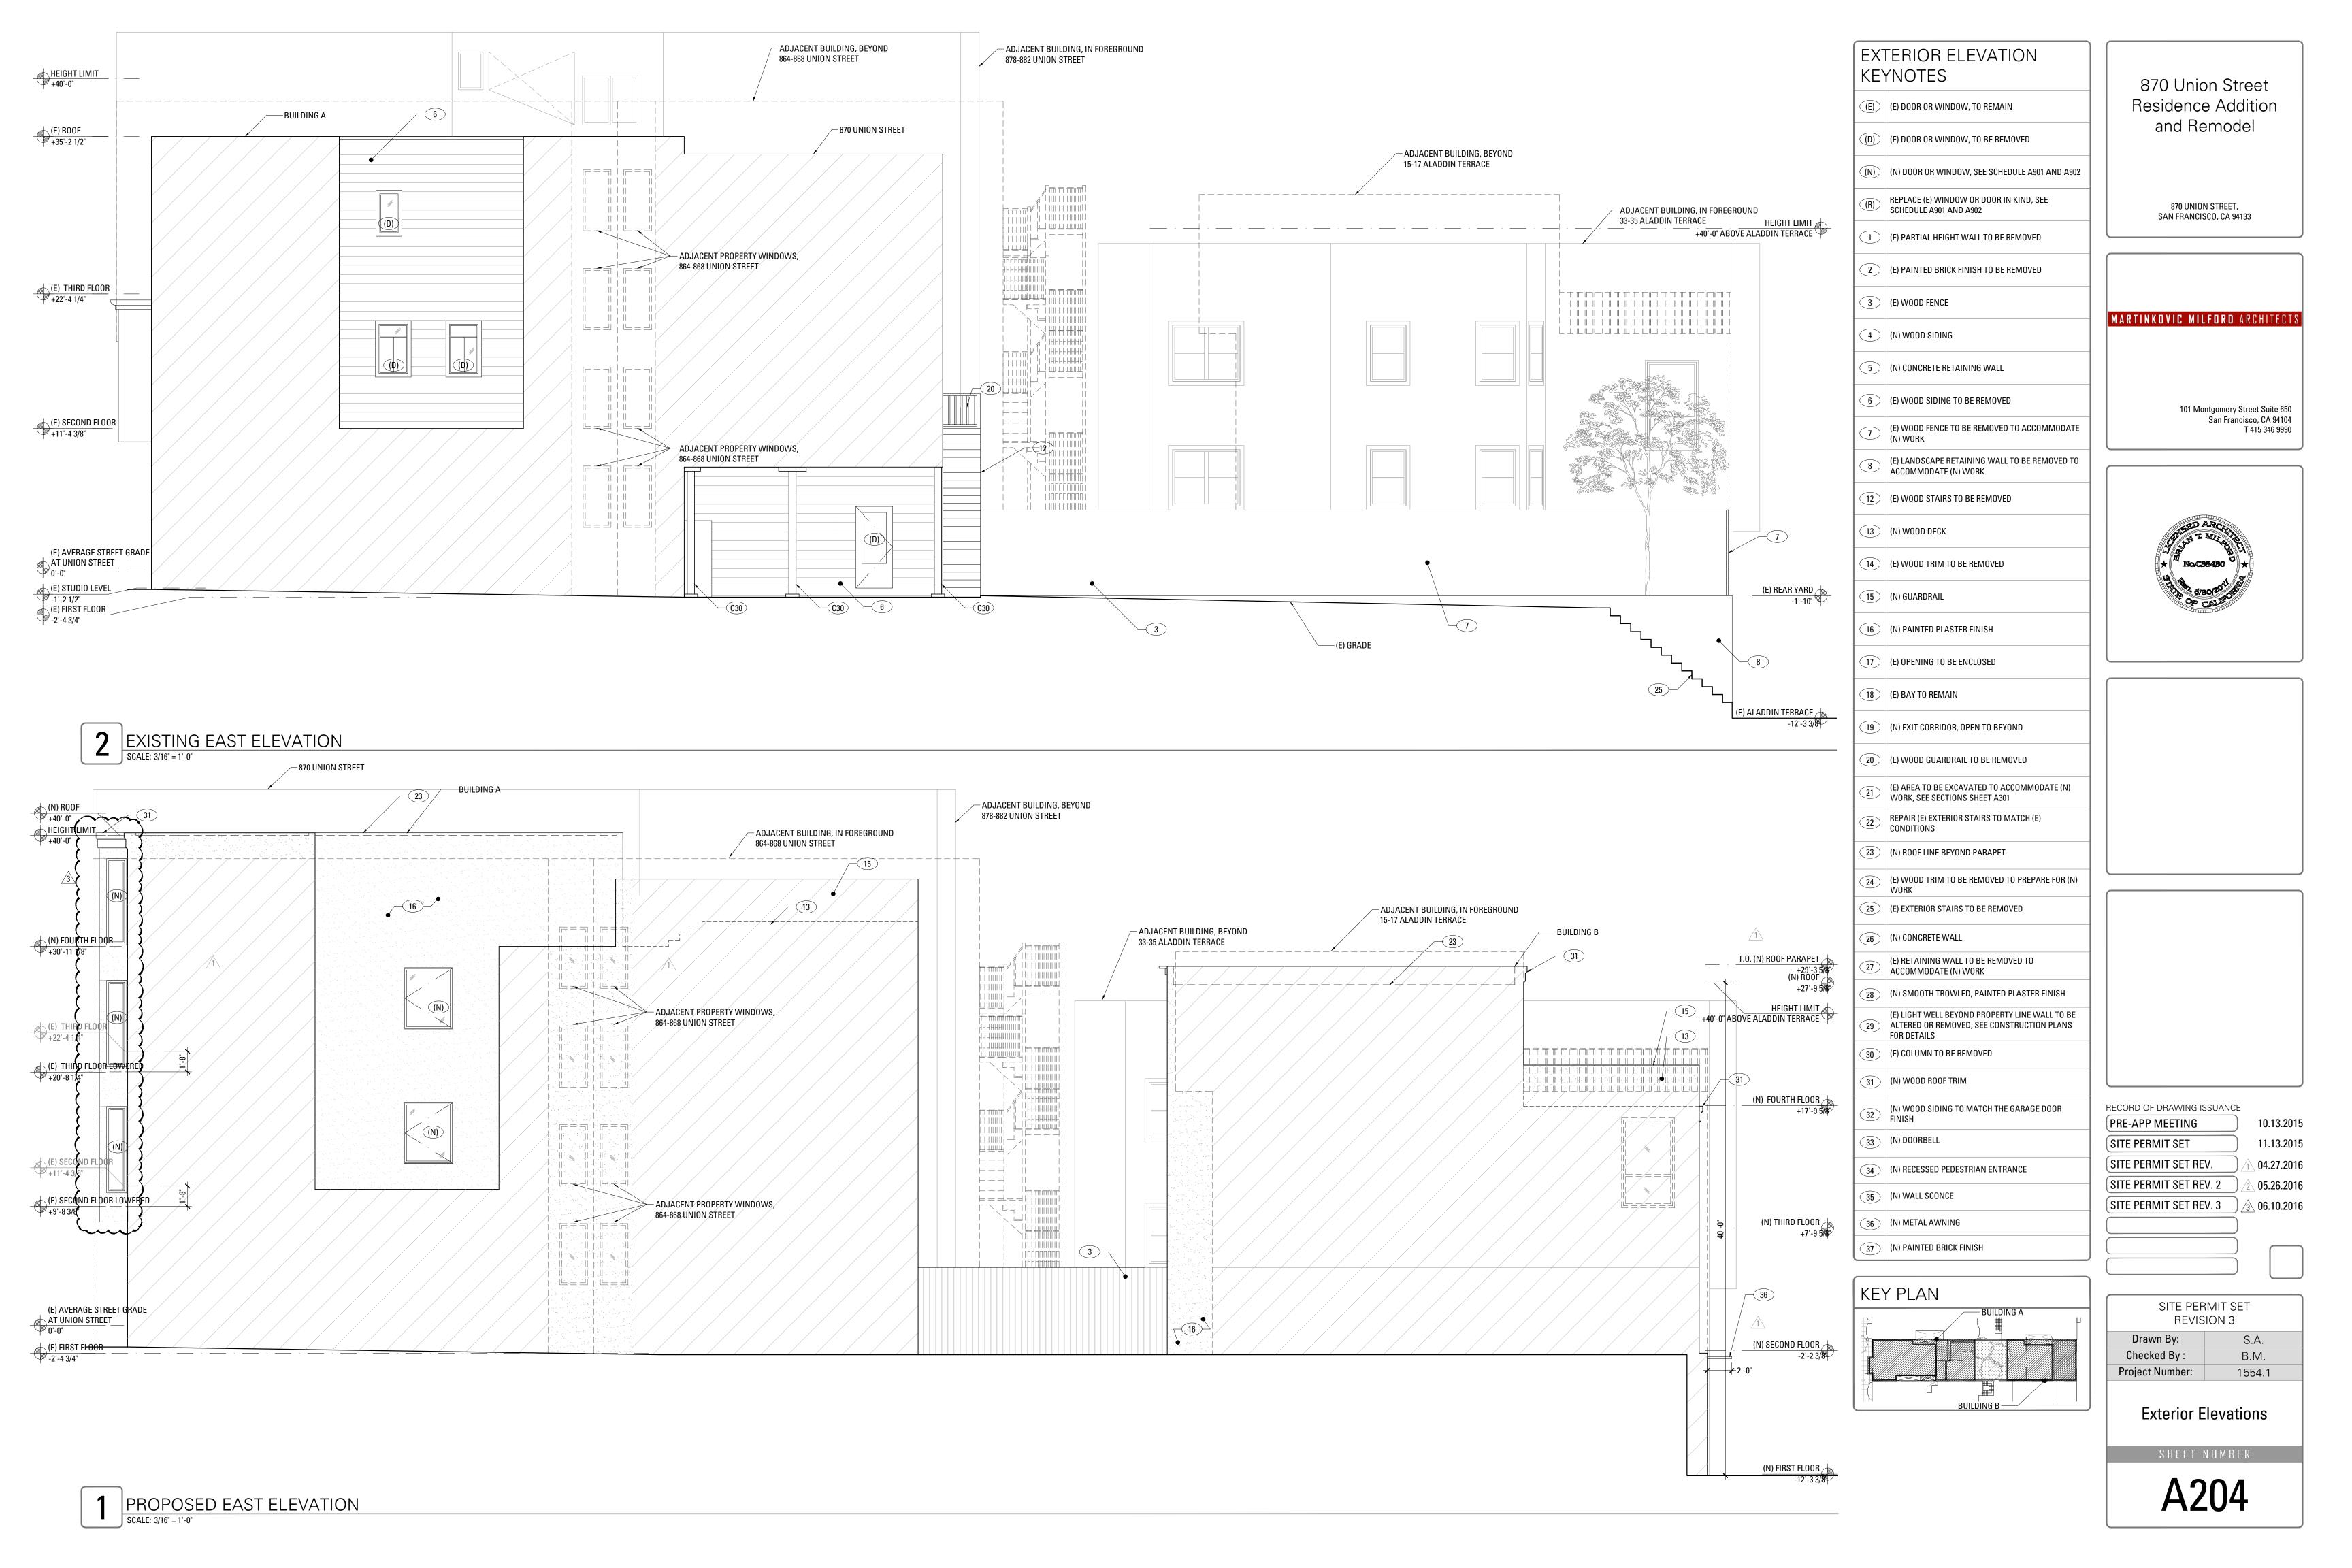

EXISTING REAR YARD BACK ELEVATION (SOUTH)

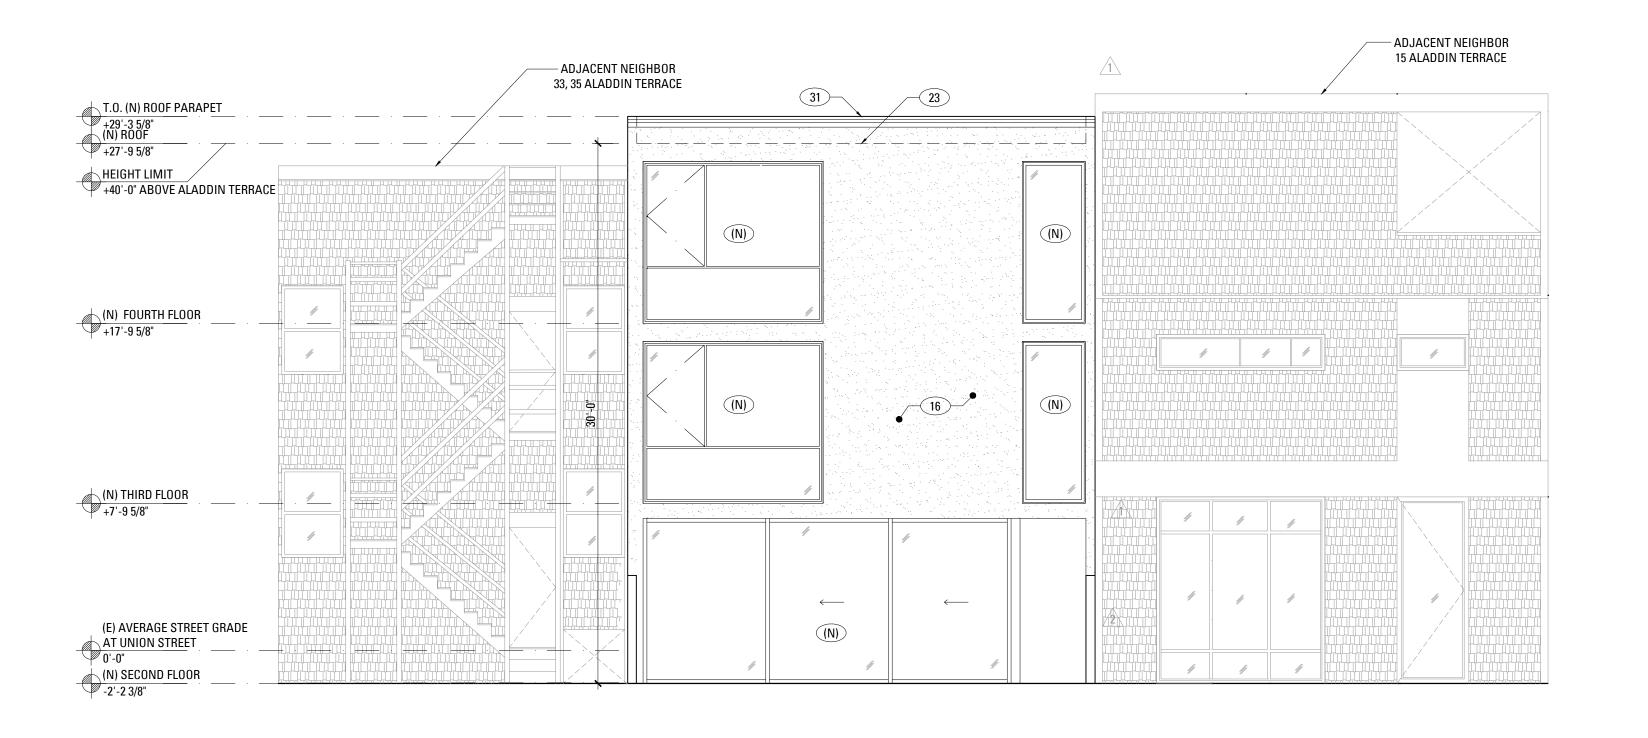

EXTERIOR ELEVATION KEYNOTES 870 Union Street Residence Addition (E) DOOR OR WINDOW, TO REMAIN and Remodel (D) (E) DOOR OR WINDOW, TO BE REMOVED (N) DOOR OR WINDOW, SEE SCHEDULE A901 AND A902 (R) REPLACE (E) WINDOW OR DOOR IN KIND, SEE SCHEDULE A901 AND A902 870 UNION STREET, SAN FRANCISCO, CA 94133 1 (E) PARTIAL HEIGHT WALL TO BE REMOVED (E) PAINTED BRICK FINISH TO BE REMOVED (E) WOOD FENCE MARTINKOVIC MILFORD ARCHITECT 4 (N) WOOD SIDING 5 (N) CONCRETE RETAINING WALL 6 (E) WOOD SIDING TO BE REMOVED 101 Montgomery Street Suite 650 San Francisco, CA 94104 T 415 346 9990 (E) WOOD FENCE TO BE REMOVED TO ACCOMMODATE (N) WORK (E) LANDSCAPE RETAINING WALL TO BE REMOVED TO ACCOMMODATE (N) WORK (E) WOOD STAIRS TO BE REMOVED (N) WOOD DECK (E) WOOD TRIM TO BE REMOVED (N) GUARDRAIL (N) PAINTED PLASTER FINISH (E) OPENING TO BE ENCLOSED (E) BAY TO REMAIN (N) EXIT CORRIDOR, OPEN TO BEYOND (E) WOOD GUARDRAIL TO BE REMOVED (E) AREA TO BE EXCAVATED TO ACCOMMODATE (N) WORK, SEE SECTIONS SHEET A301 REPAIR (E) EXTERIOR STAIRS TO MATCH (E) CONDITIONS (N) ROOF LINE BEYOND PARAPET (E) WOOD TRIM TO BE REMOVED TO PREPARE FOR (N) WORK (E) EXTERIOR STAIRS TO BE REMOVED (N) CONCRETE WALL (E) RETAINING WALL TO BE REMOVED TO ACCOMMODATE (N) WORK (N) SMOOTH TROWLED, PAINTED PLASTER FINISH

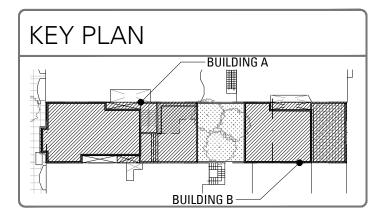

(E) LIGHT WELL BEYOND PROPERTY LINE WALL TO BE 29 ALTERED OR REMOVED, SEE CONSTRUCTION PLANS

(N) WOOD SIDING TO MATCH THE GARAGE DOOR FINISH

(N) RECESSED PEDESTRIAN ENTRANCE

FOR DETAILS

(N) WOOD ROOF TRIM

(N) DOORBELL


(N) WALL SCONCE

(N) METAL AWNING

(N) PAINTED BRICK FINISH

(E) COLUMN TO BE REMOVED

RECORD OF DRAWING ISSUANCE 10.13.2015 PRE-APP MEETING 11.13.2015 SITE PERMIT SET SITE PERMIT SET REV. 04.27.2016 SITE PERMIT SET REV. 2 05.26.2016 SITE PERMIT SET REV. 3 3 06.10.2016

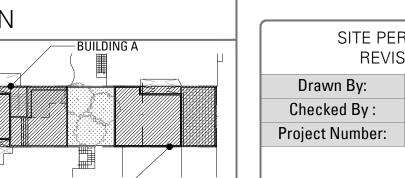


SITE PERMIT SET REVISION 3 S.A. B.M. 1554.1

Exterior Elevations

GAŔĎEN

2 EXISTING REAR YARD FRONT ELEVATION (NORTH)

SCALE: 3/16" = 1'-0"

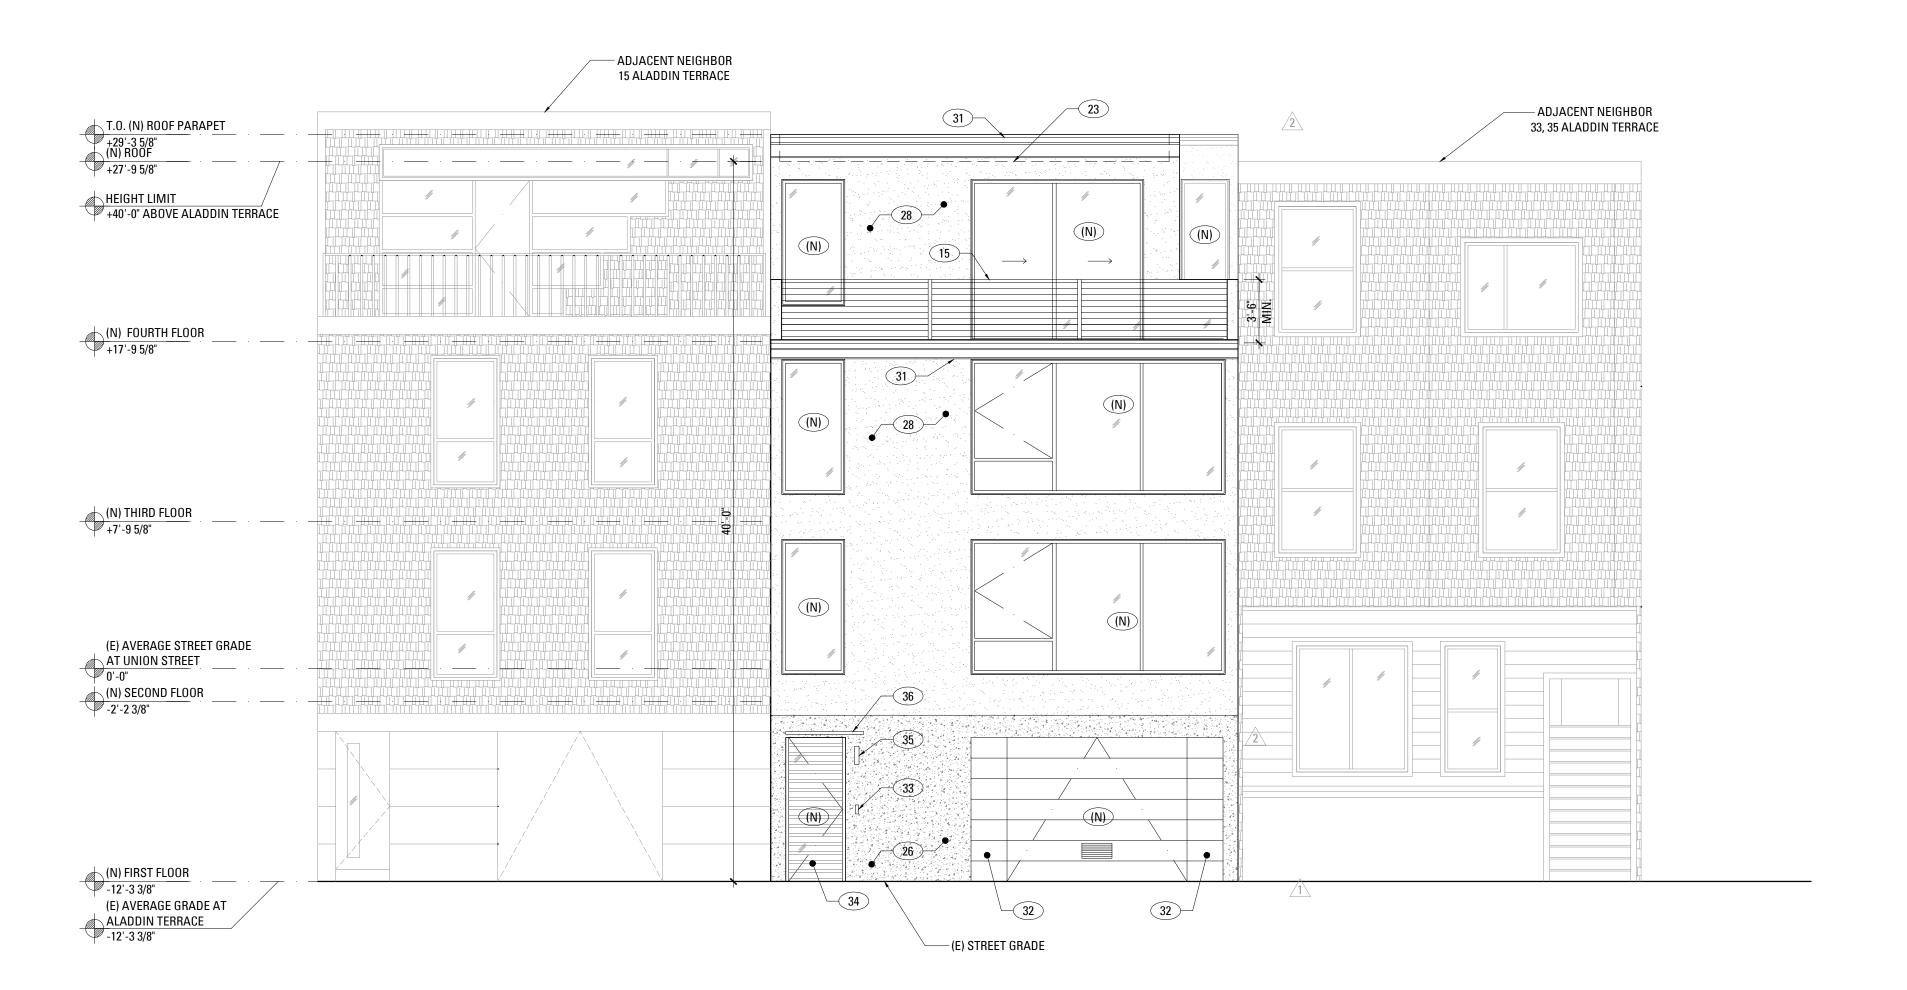

∕ 870 UNION STREET BEYOND

—(E) STREET GRADE

- ADJACENT NEIGHBOR

33, 35 ALADDIN TERRACE

PROPOSED REAR YARD FRONT ELEVATION : BUILDING B (NORTH)

SCALE: 3/16" = 1'-0"

EXTERIOR ELEVATION KEYNOTES

(E) CE DOOR OR WINDOW, TO REMAIN

(E) DOOR OR WINDOW, TO BE REMOVED

(N) DOOR OR WINDOW, SEE SCHEDULE A901 AND A902

(R) REPLACE (E) WINDOW OR DOOR IN KIND, SEE SCHEDULE A901 AND A902

(E) PARTIAL HEIGHT WALL TO BE REMOVED

(E) PAINTED BRICK FINISH TO BE REMOVED

(E) WOOD FENCE

(N) WOOD SIDING

(N) CONCRETE RETAINING WALL

6 (E) WOOD SIDING TO BE REMOVED

(E) WOOD FENCE TO BE REMOVED TO ACCOMMODATE (N) WORK

(E) LANDSCAPE RETAINING WALL TO BE REMOVED TO ACCOMMODATE (N) WORK

(E) WOOD STAIRS TO BE REMOVED

(N) WOOD DECK

(E) WOOD TRIM TO BE REMOVED

(N) GUARDRAIL

(N) PAINTED PLASTER FINISH

(E) OPENING TO BE ENCLOSED

(E) BAY TO REMAIN

(N) EXIT CORRIDOR, OPEN TO BEYOND

(E) WOOD GUARDRAIL TO BE REMOVED

(E) AREA TO BE EXCAVATED TO ACCOMMODATE (N) WORK, SEE SECTIONS SHEET A301

REPAIR (E) EXTERIOR STAIRS TO MATCH (E) CONDITIONS

(N) ROOF LINE BEYOND PARAPET

(E) WOOD TRIM TO BE REMOVED TO PREPARE FOR (N) WORK

(E) EXTERIOR STAIRS TO BE REMOVED

(N) CONCRETE WALL

(E) RETAINING WALL TO BE REMOVED TO ACCOMMODATE (N) WORK

(N) SMOOTH TROWLED, PAINTED PLASTER FINISH

(E) LIGHT WELL BEYOND PROPERTY LINE WALL TO BE ALTERED OR REMOVED, SEE CONSTRUCTION PLANS

FOR DETAILS

(E) COLUMN TO BE REMOVED

(N) WOOD ROOF TRIM

(N) WOOD SIDING TO MATCH THE GARAGE DOOR FINISH

(N) DOORBELL

(N) RECESSED PEDESTRIAN ENTRANCE

(N) WALL SCONCE

(N) METAL AWNING

(N) PAINTED BRICK FINISH

KEY PLAN

BUILDING A

RECORD OF DRAWING ISSUANCE
PRE-APP MEETING
SITE PERMIT SET
11.13.2015
SITE PERMIT SET REV.

O4.27.2016
SITE PERMIT SET REV.

2 05.26.2016

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SITE PERMIT SET
REVISION 3


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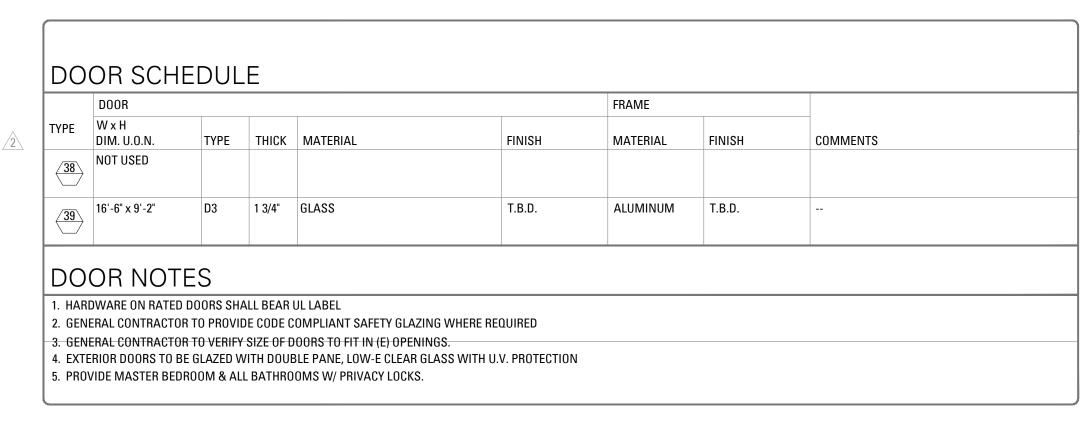
SITE PERMIT SET REV. 3


3 06.10.2016

Exterior Elevations

Δ206



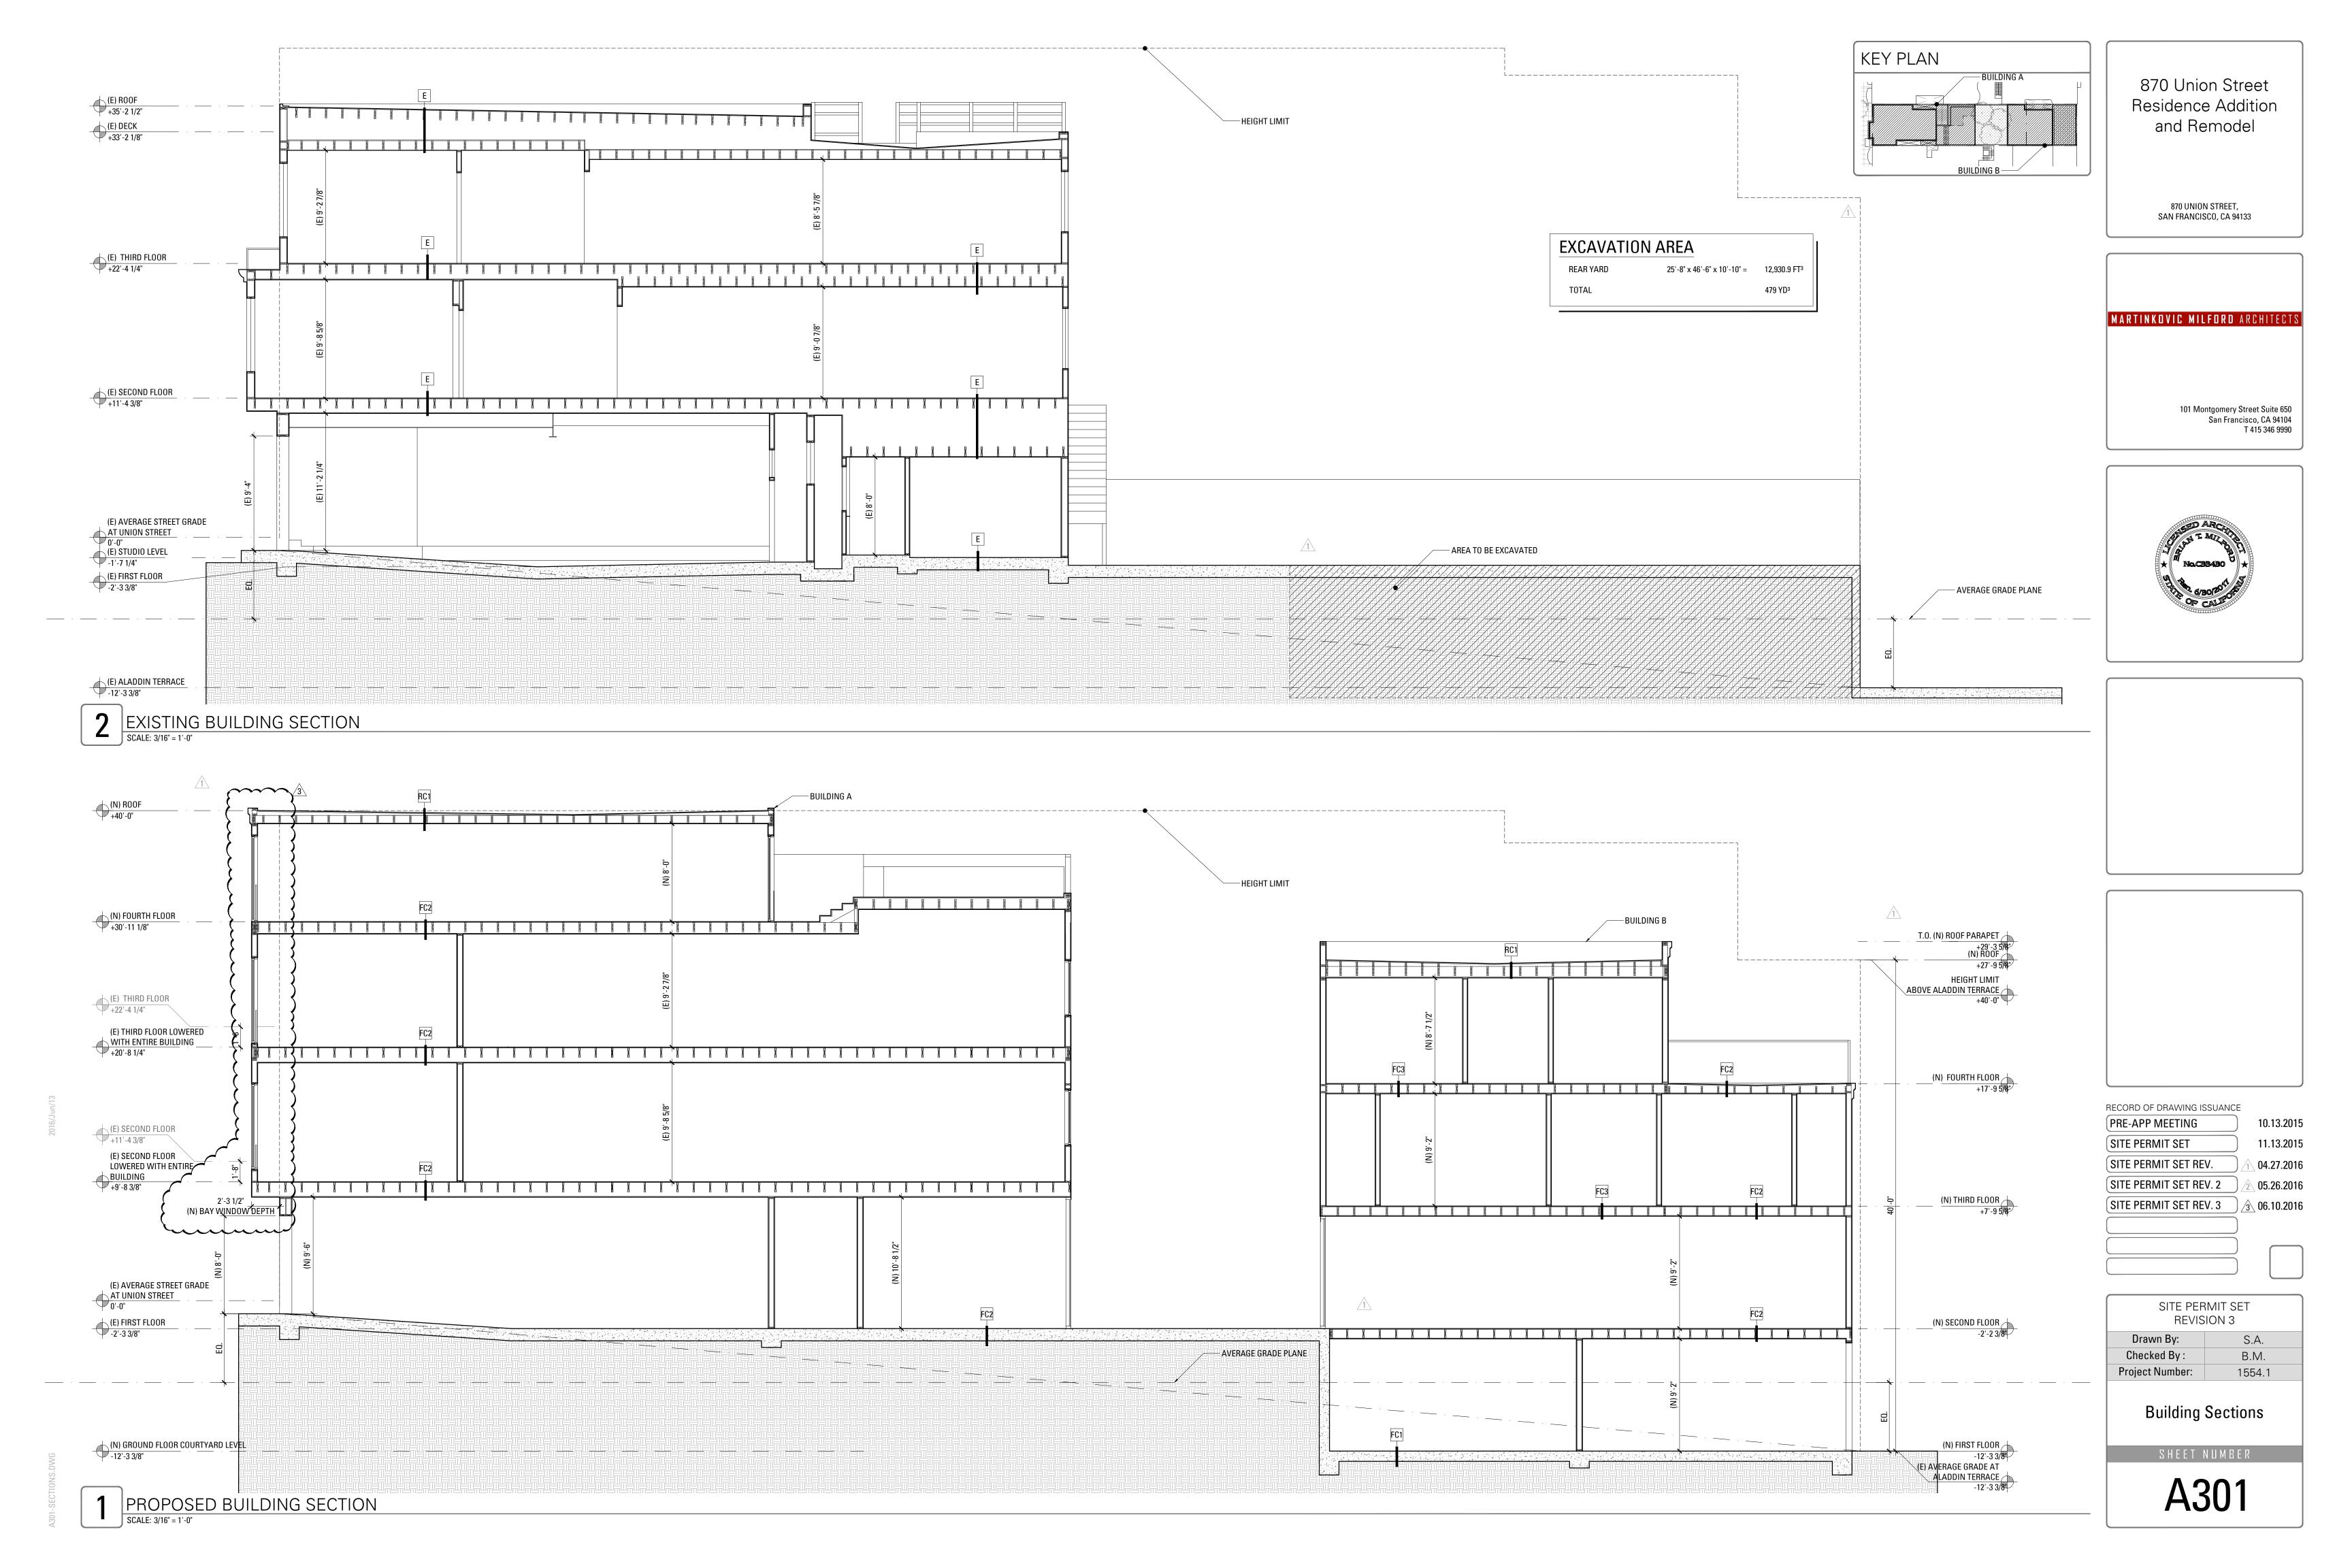

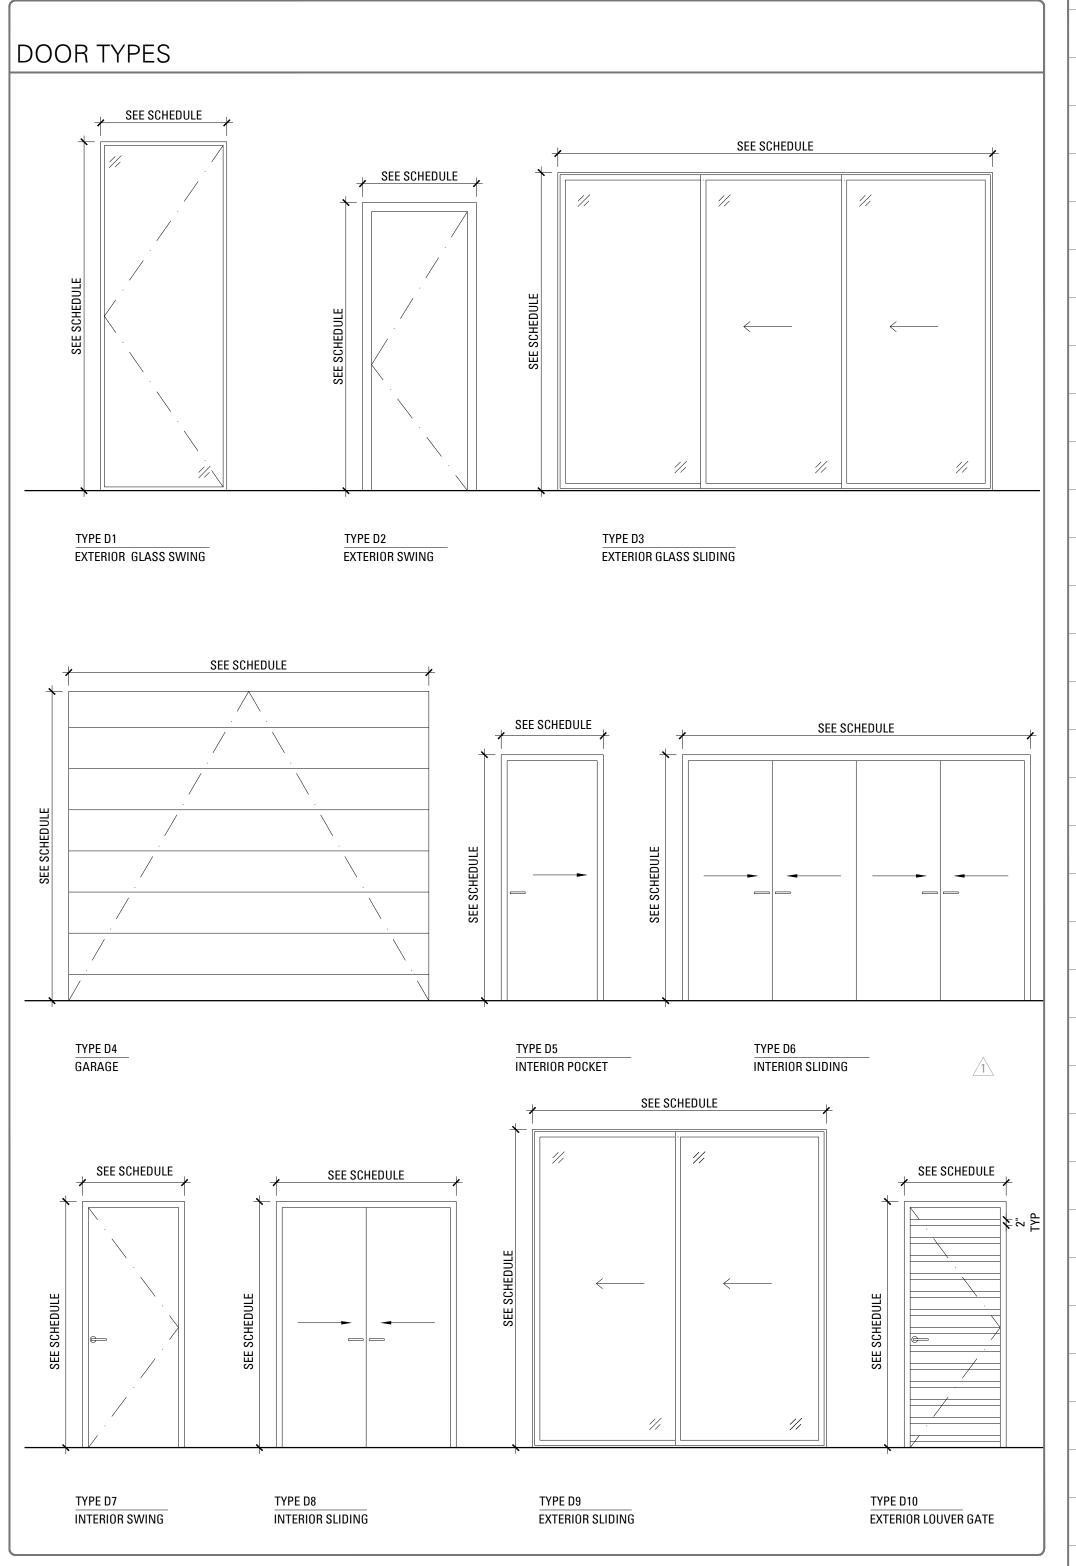

		DOOR			1		FRAME			
	TYPE E	W x H DIM. U.O.N. EXISTING	TYPE E	THICK	MATERIAL EXISTING	FINISH EXISTING	MATERIAL EXISTING	FINISH EXISTING	COMMENTS 	-
		MATCH (E)	MATCH (E)	MATCH (E)	MATCH (E)	MATCH (E)	MATCH (E)	MATCH (E)	DOOR TO BE REPLACED IN KIND	_
		14'-0" x 8'-0"	D4	2"	ALUMINUM	T.B.D.	ALUMINUM	T.B.D.	MINIMUM 200 SQ INCH LOUVER FOR VENTILATION	
	2	3'-0" x 9'-4"	D2	1 3/4"	SOLID CORE WOOD	T.B.D.	ALUMINUM	T.B.D.		_
	3	3'-6" x 7'-4"	D2	1 3/4"	SOLID CORE WOOD	T.B.D.	WOOD	T.B.D.	1-HOUR FIRE RATED DOOR AND FRAME WITH SMOKE GASKETING	_
	4	3'-6" x 7'-4"	D2	1 3/4"	SOLID CORE WOOD	T.B.D.	WOOD	T.B.D.	1-HOUR FIRE RATED DOOR AND FRAME WITH SMOKE GASKETING	_
	5	2'-8" x 6'-8"	D5	1 3/4"	SOLID CORE WOOD	T.B.D.	WOOD	T.B.D.		_
	6	3'-6" x 8'-0"	D2	1 3/4"	SOLID CORE WOOD	T.B.D.	WOOD	T.B.D.		
	7	14'-1 1/4" x 6'-8"	D6	1 3/4"	SOLID CORE WOOD	T.B.D.	WOOD	T.B.D.		_
		2'-8" x 6'-8"	D7	1 3/4"	SOLID CORE WOOD	T.B.D.	WOOD	T.B.D.		
	9	2'-10" x 6'-8"	D7	1 3/4"	SOLID CORE WOOD	T.B.D.	WOOD	T.B.D.		_
	<u></u>	NOT USED								
	<u></u>	2'-10" x 7'-4"	D2	1 3/4"	SOLID CORE WOOD	T.B.D.	WOOD	T.B.D.		
	<u></u>	2'-6" x 6'-8"	D7	1 3/4"	SOLID CORE WOOD	T.B.D.	WOOD	T.B.D.		
	<u></u>	3'-0" x 7'-0"	D2	1 3/4"	SOLID CORE WOOD	T.B.D.	WOOD	T.B.D.		_
	<u></u>	2'-10" x 6'-8"	D7	1 3/4"	SOLID CORE WOOD	T.B.D.	WOOD	T.B.D.		
	<u></u>	12'-9 3/4" x 6'-8"	D6	1 3/4"	SOLID CORE WOOD	T.B.D.	WOOD	T.B.D.		
	<u></u>	2'-8" x 6'-8"	D7	1 3/4"	SOLID CORE WOOD	T.B.D.	WOOD	T.B.D.		_
		8'-9" x 7'-0"	D9	1 3/4"	GLASS	T.B.D.	ALUMINUM	T.B.D.		_
		3'-6" x 6'-8"	D7	1 3/4"	SOLID CORE WOOD	T.B.D.	ALUMINUM	T.B.D.	45-MIN. FIRE RATED DOOR AND	
		3'-3" x 6'-8"	D7	1 3/4"	SOLID CORE WOOD	T.B.D.	WOOD	T.B.D.	1-HOUR FIRE RATED DOOR AND	_
	(19) (20)	3'-6" x 8'-0"	D7	1 3/4"	SOLID CORE WOOD	T.B.D.	WOOD	T.B.D.	1-HOUR FIRE RATED DOOR AND	_
	<u>20</u> <u>21</u>	10'-0" x 8'-0"	D4	1 3/4"	SOLID CORE WOOD	T.B.D.	ALUMINUM	T.B.D.	FRAME WITH SMOKE GASKETING	
		3'-0" x 8'-0"	D10	1 3/4"	WOOD LOUVER GATE	T.B.D.	WOOD	T.B.D.		_
	(22)	5'-0" x 6'-8"	D8	1 3/4"	SOLID CORE WOOD	T.B.D.	WOOD	T.B.D.		_
	(23)	2'-10" x 6'-8"	D7	1 3/4"	SOLID CORE WOOD	T.B.D.	WOOD	T.B.D.		
	24	5'-0" x 6'-8"	D8	1 3/4"	SOLID CORE WOOD	T.B.D.	WOOD	T.B.D.		_
	25	10'-7 1/2" x 6'-8"	D6	1 3/4"	SOLID CORE WOOD	T.B.D.	WOOD	T.B.D.		
	26	3'-0" x 6'-8"	D6	1 3/4"	SOLID CORE WOOD	T.B.D.	WOOD	T.B.D.		
	27									
	28	13'-6 1/2" x 6'-8"	D6	1 3/4"	SOLID CORE WOOD	T.B.D.	WOOD	T.B.D.		
	29	3'-0" x 6'-8"	D7	1 3/4"	SOLID CORE WOOD	T.B.D.	WOOD	T.B.D.		
	30	3'-0" x 6'-8"	D5	1 3/4"	SOLID CORE WOOD	T.B.D.	WOOD	T.B.D.		
	<u>√31</u>	3'-6" x 6'-8"	D5	1 3/4"	SOLID CORE WOOD	T.B.D.	WOOD	T.B.D.		
	32 →	9'-7" x 8'-9"	D9	1 3/4"	GLASS	T.B.D.	ALUMINUM	T.B.D.	2 EQUAL PANELS	
	33	3'-0" x 6'-8"	D7	1 3/4"	SOLID CORE WOOD	T.B.D.	WOOD	T.B.D.		
	34	2'-8" x 6'-8"	D7	1 3/4"	SOLID CORE WOOD	T.B.D.	WOOD	T.B.D.		
	35	2'-6" x 6'-8"	D7	1 3/4"	SOLID CORE WOOD	T.B.D.	WOOD	T.B.D.		
	36 √ 36	16'-6" x 10'-8"	D9	1 3/4"	GLASS	T.B.D.	ALUMINUM	T.B.D.		_
-	⟨37 ⟩	2'-8" x 6'-8"	D7	1 3/4"	SOLID CORE WOOD	T.B.D.	WOOD	T.B.D.		

1. HARDWARE ON RATED DOORS SHALL BEAR UL LABEL

2. GENERAL CONTRACTOR TO PROVIDE CODE COMPLIANT SAFETY GLAZING WHERE REQUIRED

4. EXTERIOR DOORS TO BE GLAZED WITH DOUBLE PANE, LOW-E CLEAR GLASS WITH U.V. PROTECTION

3. GENERAL CONTRACTOR TO VERIFY SIZE OF DOORS TO FIT IN (E) OPENINGS.

5. PROVIDE MASTER BEDROOM & ALL BATHROOMS W/ PRIVACY LOCKS.


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RECORD OF DRAWING ISSUANCE
PRE-APP MEETING

10.13.2015

SITE PERMIT SET

SITE PERMIT SET REV.

04.27.2016

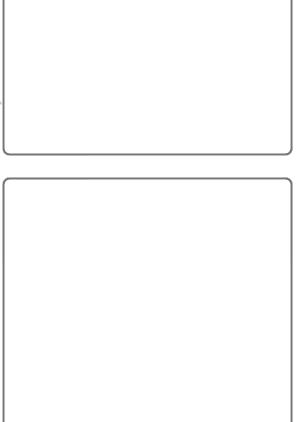SITE PERMIT SET REV. 2

05.26.2016


SITE PERMIT SET REV. 3


06.10.2016


SITE PERMIT SET REVISION 3					
Drawn By:	S.A.				
Checked By :	B.M.				
Project Number:	1554.1				

Schedule

Δ901

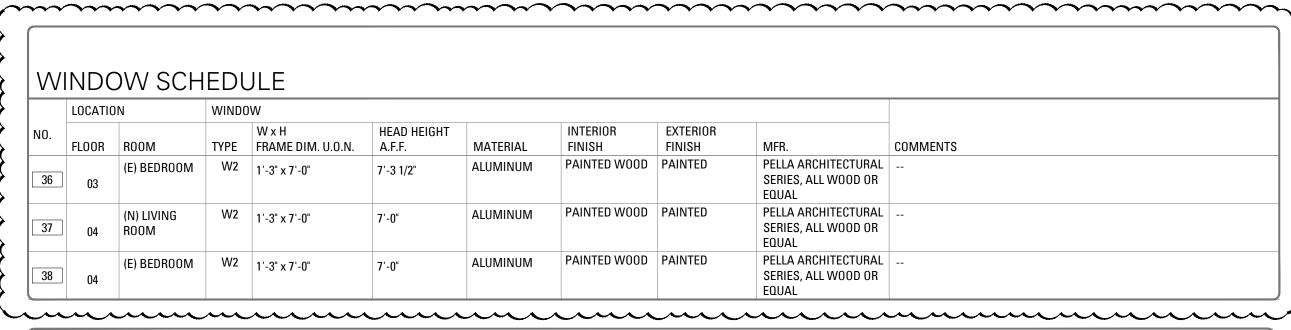

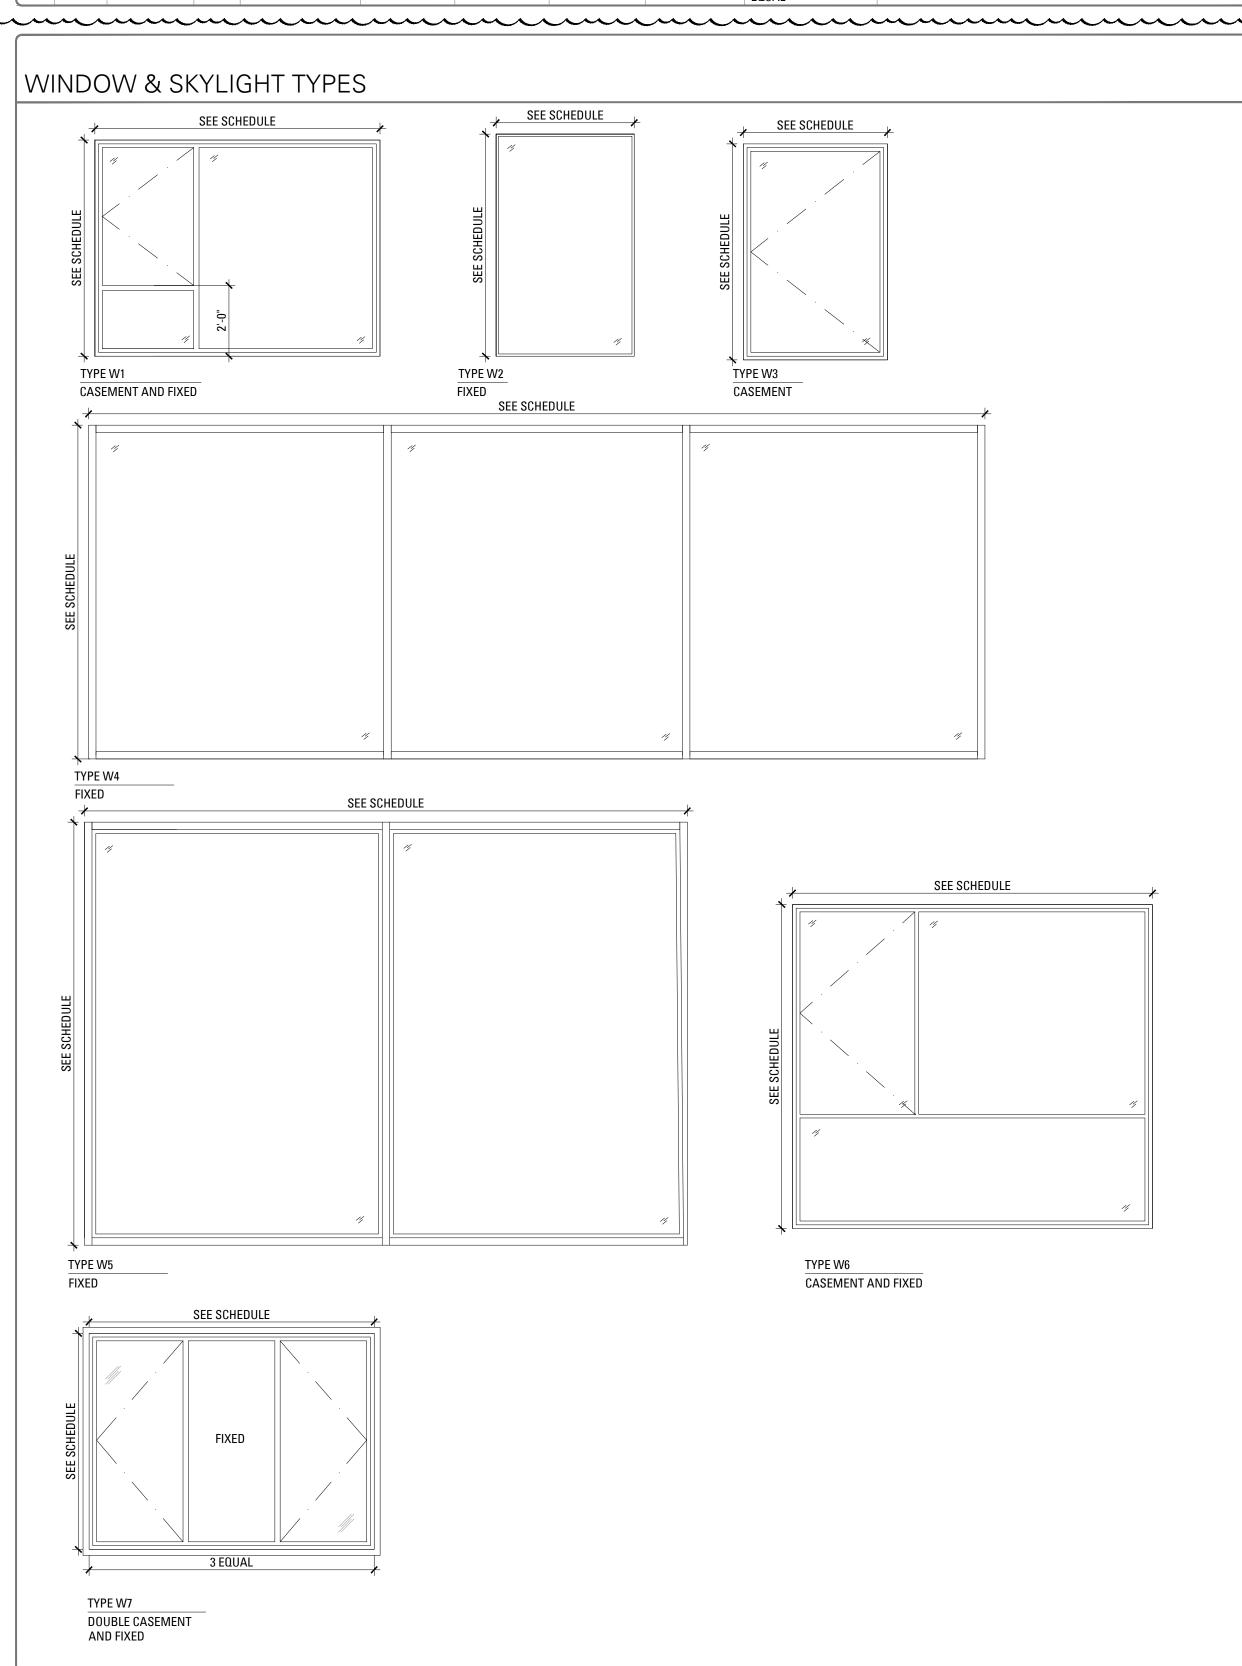

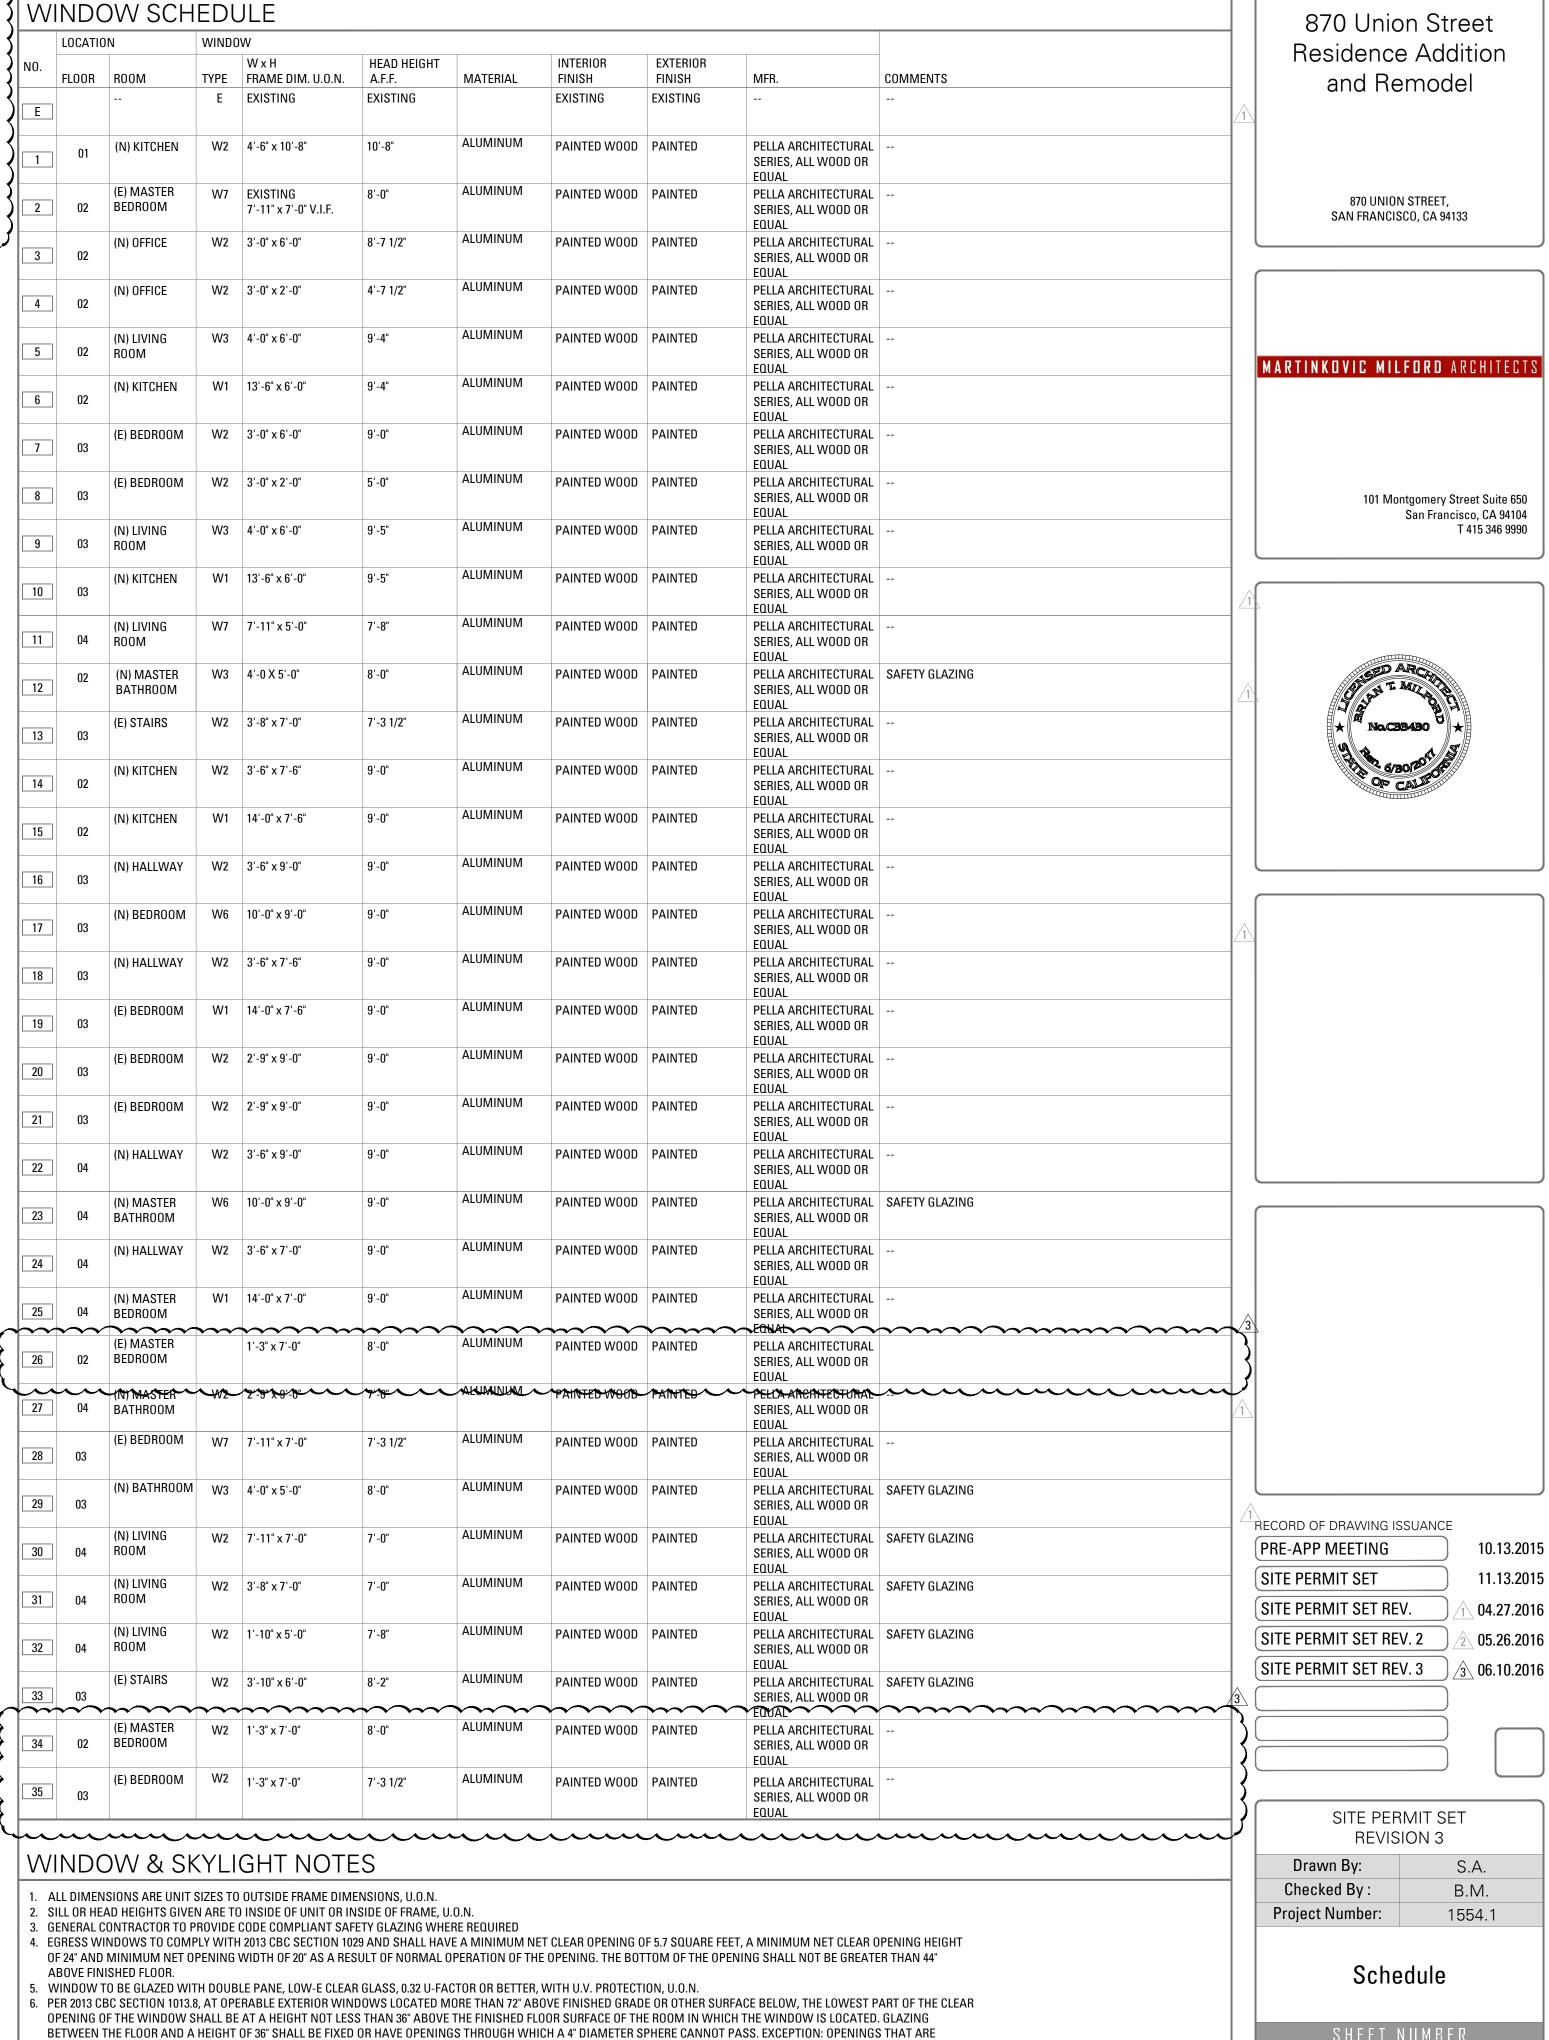

PROVIDED WITH WINDOW GUARDS THAT COMPLY WITH WINDOW GUARDS THAT COMPLY WITH ASTM F 2006, F 2090 OR 1013.8.1

10. ALL GAPS BETWEEN FRAMING AND EXTERIOR DOOR & WINDOW FRAMES TO BE FILLED WITH EXPANDING FOAM INSULATION

8. ALL EXTERIOR DOORS AND WINDOWS TO HAVE GALVANIZED SHEET METAL PAN FLASHING AND GALVANIZED METAL HEAD FLASHING, U.O.N.

ALL GLAZED EXTERIOR DOORS AND WINDOWS TO HAVE THERMAL SEAL GASKETING, U.O.N.

9. ALL EXTERIOR DOOR AND WINDOW OPENINGS SHALL HAVE SELF-ADHERED FLASHING

101 Montgomery Street Suite 650 San Francisco, CA 94104 T 415 346 9990

10.13.2015 11.13.2015 04.27.2016