

MARKET STREET MIXED-USE BUILDING

2201 MARKET STREET, SAN FRANCISCO, CA 94114

ISSUED FOR NOPDR #1 REVISED - FEBRUARY 19, 2016

PROJECT DIRECTORY:

CLIENT: CONTRACTOR:

2201 MARKET STREET LLC T.B.D. PO BOX 77081 SAN FRANCISCO, CA 94107-0081 T: (415) 975-0900

STRUCTURAL ENGINEER ARCHITECT:

EDMONDS + LEE ARCHITECTS, INC. T.B.D CONTACT: ROBERT EDMONDS 2601 MISSION STREET, 400A SAN FRANCISCO, CA 94110 T (415) 285-1300

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EXTERIOR ELEVATION (EXISTING) EXTERIOR ELEVATION (EXISTING) EXTERIOR ELEVATION (EXISTING) A2.00 A2.01 A2.02

EXTERIOR ELEVATION (NEW) EXTERIOR FLEVATION (NEW) EXTERIOR ELEVATION (NEW)

BUILDING SECTION BUILDING SECTION

PROJECT INFORMATION:

2201 MARKET STREET SAN FRANCISCO, CA 94114

BLOCK: 3559

I OT: 001

UPPER MARKET COMMERCIAL TRANSIT (NCT)

BUILDING CONSTRUCTION IS ALLOWED DURING THE HOURS OF 7:00 AM TO 8:00 PM, SEVEN DAYS A WEEK, INCLUDING HOLIDAYS. ANY WORK DONE BEFORE OR AFTER THESE HOURS MUST NOT EXCEED THE NOISE LEVEL OF FIVE DECIBELS AT THE NEAREST LOT LINE UNLESS A SPECIAL

ISSUED FOR NOPDR #1

NO: DATE: SUBMISSION

02 10.01.15 NOPDR #1

01 09.08.14 SITE PERMIT FILING

03 02.19.16 NOPDR #1 - REVISED

EDMONDS + LEE ARCHITECTS, INC.

2601 Mission St., #503 San Francisco, CA 94110 T 415 . 285 . 1300 www.edmondslee.com

PROJECT DESCRIPTION:

PERMIT HAS BEEN GRANTED.

THE PROPOSED PROJECT IS THE DEMOLITION AN (EXISTING) 2-STORY COMMERCIAL BUILDING AND THE CONSTRUCTION OF A (NEW) 6-STORY, MIXED-USE COMMERCIAL AND 9-UNIT RESIDENTIAL BUILDING.

SPECIFIC WORK CONSISTS OF THE FOLLOWING:

DEMOLITION

WORK HOURS:

1. DEMOLITION OF AN (EXISTING) 1-STORY COMMERCIAL BUILDING. 2. ADDITIONAL EXCAVATION REQUIRED FOR BASEMENT.

ARCHITECTURE INTERIOR:

1. (NEW) CONSTRUCTION OF ALL INTERIORS INCLUDING BEDROOMS, KITCHEN, BATHROOMS, LIVING AREAS, AND UTILITY AREAS.

ARCHITECTURE EXTERIOR:

. (NEW) CONSTRUCTION OF EXTERIORS INCLUDING CLADDING, FENESTRATION, EXTERIOR DECKS AND ROOFS.

STRUCTURAL:

I. (NEW) CONCRETE FOUNDATION, BASEMENT AND POST-TENSIONED CONCRETE STRUCTURE.

MECHANICAL, ELECTRICAL & PLUMBING:

1. (NEW) MEP FIXTURES AND FOUIPMENT THROUGHOUT STRUCTURE. 2. (NEW) MEP & FIRE SPRINKLERS TO BE DESIGN BUILD AND FILED UNDER A SEPARATE PERMIT.

APPLICABLE CODES:

MAXIMUM AREA:

2013 CALIFORNIA BUILDING CODE & SF AMENDMENTS 2013 CALIFORNIA RESIDENTIAL CODE & SF AMENDMENTS 2013 CALIFORNIA MESILENTIAL CODE & SF AMENDMENTS 2013 CALIFORNIA MECHANICAL CODE & SF AMENDMENTS 2013 CALIFORNIA PLUMBING CODE & SF AMENDMENTS 2013 CALIFORNIA ELECTRICAL CODE & SF AMENDMENTS 2013 CALIFORNIA ENERGY CODE

2013 SAN FRANCISCO HOUSING CODE 2013 SAN FRANCISCO ENERGY CODE

BUILDING LIMITATIONS (PER 2010 CBC TABLE 503):

OCCUPANCY: R2 / M CONSTRUCTION: TYPE IB FIRE SPRINKLERS: YES MAXIMUM HEIGHT: 12 STORIES*

INFORMATION BASED ON CBC TABLE 503
* ALLOWABLE HEIGHT INCREASE PER CBC 504.2 WHICH STATES THAT "WHERE A BUILDING IS FOUIPPED WITH AN APPROVED AUTOMATIC VALUE SPECIFIED IN TABLE 503 FOR MAXIMUM HEIGHT IS INCREASED BY 20 FEET AND THE MAXIMUM NUMBER OF STORIES IS INCREASED BY ONE.

UNLIMITED SF



PROJECT:

MARKET ST. MIXED-USE

DRAWING:

COVER SHEET

SCALE:	AS NOTED
DATE:	OCTOBER 1, 2015
JOB NO.	2013.10
DRAWN:	
CAD FILE:	

PROJECT SITE -





GENERAL CONDITIONS

THE GENERAL CONDITIONS OF THE CONTRACT ARE THE AMERICAN INSTITUTE OF ARCHITECTS DOCUMENT A201, "GENERAL CONDITIONS OF THE CONTRACT FOR CONSTRUCTION," CURRENT EDITION. WHERE THESE CONFLICT WITH THE FOLLOWING SUPPLEMENTARY GENERAL CONDITIONS, THE LATTER SHALL TAKE

SUMMARY OF WORK

THE WORK DESCRIBED IN THIS CONTRACT CONSISTS OF FOLLOWING CONSTRUCTION DOCUMENTS AND

CHANGE IN THE WORK

- 1. VERBAL INSTRUCTION: IT IS THE GENERAL CONTRACTOR'S RESPONSIBILITY TO ADVISE THE ARCHITECT REGARDING ANY ADDITIONAL COSTS RESULTING FROM THE ARCHITECT'S VERBAL INSTRUCTIONS; SUCH
- SUBMITTAL OF CHANGE ORDERS: CHANGE ORDERS SHALL BE PREPARED BY THE GENERAL
 CONTRACTOR; IF A CHANGE ORDER SUBMITTED TO THE ARCHITECT FOR APPROVAL AFTER THE WORK REFLECTED BY THE CHANGE ORDER HAS ALREADY BEEN EXECUTED. THE CHANGE ORDER WILL BE AUTOMATICALLY REJECTED. A WRITTEN EXPLANATION BY THE GENERAL CONTRACTOR OF THE EFFECT OF THE CHANGE ORDER ON THE PROJECT SCHEDULE MUST ACCOMPANY EACH CHANGE ORDER.
- FITTINGS, HARDWARE AND FINISHES: WHEN PLUMBING FAUCETS, DOOR HARDWARE, CERAMIC TILE ETC.
 ARE TO BE SPECIFIED BY CHANGE ORDER, THE COST SHALL CONSIST OF: 1. PRODUCT COST LESS
 TRADE DISCOUNT, 2. SUB CONTRACTOR'S OVERHEAD AND PROFIT, 3. DELIVERY COSTS AND TAXES.

- CONSIDERATION OF SUBSTITUTIONS: BURDEN OF PROOF OF THE MERIT OF PROPOSED SUBSTITUTION IS UPON THE PROPOSER.
- SUBMITTAL REQUIREMENTS: SUBSTITUTIONS SHALL BE SUBMITTED IN WRITING BY THE CONTRACTOR
 AND SHALL INCLUDE CONFIRMATION OF THE SUBSTITUTION'S EFFECT ON PROJECT COST, SCHEDULE AND INTERFACE WITH OTHER SPECIFIED PRODUCTS.

DRAWINGS AND SPECIFICATIONS

EXECUTION OF THE WORK INVOLVED.

- THE CONTRACTOR WILL RECEIVE NECESSARY NUMBER OF COPIES OF EACH OF THE ARCHITECTURAL, MECHANICAL, ELECTRICAL AND STRUCTURAL DRAWINGS AND SPECIFICATIONS FOR DISTRIBUTION TO SUBCONTRACTORS. 2. DRAWINGS AND SPECIFICATIONS ARE INTENDED TO BE COMPLEMENTARY, ANYTHING SHOWN IN THE
- DRAWING BUT NOT MENTIONED ION THE SPECIFICATIONS, OR VISA VERSA, SHALL BE FURNISHED AS IF SHOWN OR MENTIONED IN BOTH. LARGE SCALE DRAWINGS AND SPECIFICATIONS SHALL BE FURNISHED AS IF SHOWN OR MENTIONED IN BOTH. LARGE SCALE DRAWINGS AND SPECIFICATIONS SHALL TAKE PRECEDENCE OVER SMALL SCALE DRAWINGS. SUPPLEMENTAL DRAWINGS AND SPECIFICATIONS: AS DETAILS BECOME FURTHER DEVELOPED AND REFINED BY THE ARCHITECT, DRAWINGS AND SPECIFICATIONS WILL BE ISSUED DURING CONSTRUCTION. IN THE EVENT THAT THE CONTRACTOR FEELS THESE DRAWINGS AFFECT THE COST OF
- THE WORK THAT HAVE ALREADY BEEN BID, A CHANGE ORDER WILL BE NEGOTIATED PRIOR TO THE SHOP DRAWINGS: SUBMIT TWO PRINTS OF EACH SHOP DRAWINGS TO THE ARCHITECT; IF RE-SUBMITTAL IS REQUESTED REPEAT PROCESS.
- 4. SAMPLES: FULL-SIZE SAMPLES OF VARIOUS BUILDING COMPONENTS WILL BE REQUIRED FOR THE REVIEW OF KIND, COLOR, PATTERN AND TEXTURE, FOR A FINAL CHECK OF THESE CHARACTERISTICS WITH OTHER ELEMENTS, AND FOR A COMPARISON OF THESE CHARACTERISTICS BETWEEN THE FINAL SUBMITTAL AND THE ACTUAL COMPONENT AS DELIVERED AND INSTALLED. REFER TO SPECIFIC SECTIONS OF THE SPECIFICATIONS FOR FURTHER INFORMATION ON SAMPLE SUBMITTA

CONSTRUCTION SCHEDULES

- 1. FORM: THE CONTRACTOR MAY UTILIZE ANY BAR GRAPH OR CRITICAL PATH FORM HE WISHES.
- 2. SUBMITTAL: THE FIRST SCHEDULE SHALL BE SUBMITTED PRIOR TO THE START OF THE WORK: SUBMIT SUBSEQUENT SCHEDULE CHANGES AS THEY ARISE WITH THE NEAREST APPLICATION FOR PAYMENT
- PRIOR TO THE START OF CONSTRUCTION THE CONTRACTOR SHALL PROVIDE ARCHITECT WITH A SCHEDULE OF DATES FOR THE SUBMITTAL OF DRAWINGS AND DOCUMENTS REQUIRED IN ORDER TO CARRY OUT THE WORK.

PROJECT CLOSEOUT

- 1. SUBSTANTIAL COMPLETION: THE ARCHITECT SHALL ISSUE A CERTIFICATE OF SUBSTANTIAL COMPLETION AFTER THE PERMANENT LITH ITIES ARE IN OPERATING AND THE WORK HAS PROGRESSED COMPLETION AFTER THE PERMANENT OTHIES ARE IN OPERATING AND THE WORK HAS PROGRESSED TO THE POINT WHEN THE OWNER COULD OCCUPY THE PROJECT FOR ITS INTENDED USE; THE CERTIFICATE SHALL ESTABLISH RESPONSIBILITIES OF THE OWNER AND GENERAL CONTRACTOR FOR SECURITY, MAINTENANCE, UTILITIES, DAMAGE TO THE WORK, AND INSURANCE, AND SHALL FIX DEADLINE, NEGOTIATED BETWEEN GENERAL CONTRACTOR AND THE OWNER, FOR THE COMPLETION OF ALL PUNCH LIST ITEMS; ALL WARRANTIES REQUIRED BY THE CONTRACT DOCUMENT SHALL COMMENCE ON THE DATE OF THE CERTIFICATE OF SUBSTANTIAL COMPLETION
- 2 PLINCH LIST: THE ARCHITECT SHALL ATTACH TO THE CERTIFICATE OF SUBSTANTIAL COMPLETION A PUNCH LIST: THE ARCHITECT SHALL ATTRICT TO THE CERT INFOCATE OF SUBSTANTIAL COMPLETION. PUNCH LIST SETTING FORTH THE REMAINING WORK REQUIRED TO CLOSE OUT THE CONTRACT; THE PUNCH LIST AND DEADLINE MAY BE AMENDED REPEATEDLY AS FURTHER DEFICIENCY IN THE WORK ARISE; IF THE PUNCH LIST WORK IS NOT COMPLETED BY THE DEADLINE, THE OWNER MAY CARRY OUT THE WORK IN ACCORDANCE WITH GENERAL REQUIREMENTS.
- 3. OWNER'S MANUAL: ASSEMBLE THE FOLLOWING ITEMS IN A THREE RING BINDER. WITH TABBED DIVIDERS SEPARATING BASIC CATEGORIES: OWNER'S MANUAL AND PRODUCT WARRANTIES FOR EQUIPMENT, ALL APPLIANCES CEILING FANS ETC. ALSO INCLUDE A TYPEWRITTEN LIST OF ALL SUBCONTRACTORS AND THEIR PHONE NUMBERS; SUBMIT BINDER TO ARCHITECT.
- 4. FINAL PAYMENT: AFTER THE GENERAL CONTRACTOR HAS COMPLETED THE PUNCH LIST, SUBMITTED THE OWNER'S MANUAL, AND SUBMITTED A COMPLETE RELEASE OF LIENS TO THE ARCHITECT, THE FINAL PAYMENT SHALL BE DUE.

MISCELLANEOUS CONTRACTOR REQUIREMENTS

- ALL WORK SHALL COMPLY WITH ALL FEDERAL, STATE AND LOCAL CODES AND ORDINANCES, ALL
 UTILITY COMPANY RULES AND REGULATIONS, AND SHALL BE DONE TO THE HIGHEST STANDARDS OF CRAFTSMANSHIP BY JOURNEYMEN OF THE RESPECTIVE TRADES.
- CONTRACTOR SHALL FURNISH ALL NECESSARY LINES, LEVELS, LOCATIONS AND MEASUREMENTS TO ALL OF THE WORK, AND HE WILL BE HELD RESPONSIBLE FOR THEIR ACCURACY. NO DEPARTURE FROM THE TERMS OF THE CONTRACT WILL BE VALID UNLESS SUCH ORDERS OR DIRECTIONS ARE GIVEN OR CONFIRMED IN WRITING BY THE ARCHITECT.
- 3. CONTRACTOR SHALL OBTAIN AND PAY FOR ALL REQUIRED PERMITS, INSPECTIONS, ETC. ALL LANDFILL TAXES, USE TAXES, SALES TAXES AND ANY OTHER CHARGES RELATED TO CONSTRUCTION OF THIS PROJECT AND PAYMENT FOR THE SAME ARE THE RESPONSIBILITY OF THE CONTRACTOR. AT THE COMPLETION OF THE WORK, DELIVER TO OWNER ALL REQUIRED PERMITS, CERTIFICATES OF APPROVAL, ETC. BUILDING DEPT.& HEALTH DEPT. PERMITS SHALL BE PROVIDED AND PAID FOR BY THE OWNER.
- 4. SUPERVISION: THE CONTRACTOR SHALL BE PRESENT AT THE SITE WHENEVER THE WORK IS IN ROGRESS WHETHER BY HIS OWN OR HIS SUBCONTRACTOR'S FORCES.
- 5. OWNER'S RIGHT TO CARRY OUT WORK: IF THE CONTRACTOR NEGLECTS TO CARRY OUT THE WORK IN ACCORDANCE WITH THE CONTRACT DOCUMENTS AND FAILS TO COMMENCE AND CONTINUE CORRECTION OF SUCH NEGLECT WITH DILIGENCE WITHIN A SEVEN DAY PERIOD AFTER THE RECEIPT OF WRITTEN NOTICE FROM THE OWNER. THE OWNER MAY CORRECT SUCH DEFICIENCIES: IN SUCH CASE THE COST OF CORRECTING SUCH DEFICIENCIES: INCLUDING COMPENSATION FOR THE ARCHITECT'S THE COST OF CORRECTING SOUTH DEFICIENCIES; INCLUDING COMPENSATION FOR THE ARCHITECTS ADDITIONAL SERVICES MADE NECESSARY BY SUCH DEFAULT, SHALL BE DEDUCTED FROM PAYMENTS OWED TO THE CONTRACTOR; IF PAYMENTS DUE THE CONTRACTOR ARE NOT SUFFICIENT TO COVER SUCH AMOUNTS, THE CONTRACTOR SHALL PAY THE DIFFERENCE TO THE OWNER.
- 6. SUBSTANTIATION OF PAY REQUEST: APPLICATION FOR PAYMENT FOR MATERIALS AND EQUIPMENT NOT YET INCORPORATED INTO THE WORK SHALL BE SUPPORTED BY SUCH DATA AS THE OWNER MAY REQUIRE TO SUBSTANTIATE THE GENERAL CONTRACTOR'S RIGHT PAYMENT.

MISCELLANEOUS CONTRACTOR REQUIREMENTS CONTINUED

- 7. OWNER'S TITLE TO MATERIALS AND EQUIPMENT: BY HIS APPLICATION FOR PAYMENT THE CONTRACTOR OWNERS THE TO MATERIALS AND EQUIPMENT SHIPS APPLICATION FOR PAYMENT THE CONTRACT WARRANTS THAT TITLE TO ALL MATERIALS AND EQUIPMENT REFLECTED BY THE APPLICATION FOR PAYMENT BUT NOT YET INCORPORATED INTO THE WORK SHALL PASS TO THE OWNER AT THE TIME OF
- 8. WHERE ALLOWANCES ARE SPECIFIED, THE CONTRACTOR SHALL PURCHASE AND PAY FOR THE ITEMS SELECTED BY THE ARCHITECT. THE AMOUNT OF THE CONTRACT SHALL BE INCREASED OR DECREASED BY THE AMOUNT THAT THE TOTAL COST OF SUCH ITEMS EXCEED OR FALL UNDER THE COST ALLOWED.
- CONTRACTOR SHALL MAINTAIN THE JOB CLEAR OF TRASH AND DEBRIS. CONTRACTOR SHALL PRESENT THE BUILDING TO THE OWNER FOR ACCEPTANCE CLEAN AND READY FOR OCCUPANCY. ALL GLASS SHALL BE CLEANED AND POLISHED, FLOORS SWEPT BROOM CLEAN, FIXTURES WASHED, WITH ALL LABELS REMOVED. HEAT AND SNOW REMOVAL WILL BE THE CONTRACTOR'S RESPONSIBILITY. ALL SPACE HEATING SHALL BE DONE IN A SAFE MANNER, WITH PERIODIC CHECKS ON THE SYSTEM, AND SHALL COMPLY WITH STATE INDUSTRIAL COMMISSION AND OSHA REGULATIONS. TEMPORARY HEAT AT A TEMPERATURE OF NOT LESS THAN 45 DEGREES F. AS SOON AS CONDITIONS AT THE SITE PERMIT, THE BUILDING SHALL BE CAREFULLY LOCKED UP SO AS TO PREVENT VANDALISM, THEFT AND MALICIOUS MISCHIEF. IF THE GENERAL CONTRACTOR FAILS TO FULFILL HIS CLEANING REQUIREMENTS THE OWNER MAY CARRY OUT THE WORK IN ACCORDANCE WITH GENERAL REQUIREMENTS.
- 10. GENERAL CONTRACTOR'S FEE: ON APPLICATION FOR PAYMENT THE GENERAL CONTRACTOR'S FEE SHALL BE INDICATED AS A SEPARATE LINE ITEM.
- 11. SAMPLES: FULL-SIZE SAMPLES OF VARIOUS BUILDING COMPONENTS WILL BE REQUIRED FOR THE REVIEW OF KIND, COLOR, PATTERN AND TEXTURE, FOR A FINAL CHECK OF THESE CHARACTERISTICS WITH OTHER ELEMENTS, AND FOR A COMPARISON OF THESE CHARACTERISTICS BETWEEN THE FINAL SUBMITTAL AND THE ACTUAL COMPONENT AS DELIVERED AND INSTALLED, REFER TO SPECIFIC SECTIONS OF THE SPECIFICATIONS FOR FURTHER INFORMATION ON SAMPLE SUBMITTAL.

GENERAL NOTES

- ALL CONTRACTORS AND SUBCONTRACTORS SHALL OBTAIN ALL REQUIRED PERMITS AND/OR APPROVALS BEFORE COMMENCING WORK AND SHALL PROVIDE ALL REQUIRED CERTIFICATES OF COMPLIANCE TO THE OWNER UPON COMPLETION OF THE WORK. FEES FOR SECURING PERMITS SHALL BE THE SOLE RESPONSIBILITY OF THE CONTRACTOR AND/OR SUBCONTRACTOR.
- 2. ALL WORK SHALL COMPLY WITH ALL APPLICABLE BUILDING CODES. RULES AND REGULATIONS
- 3 ALL CONTRACTORS AND SUBCONTRACTORS SHALL CARRY WORKMEN'S COMPENSATION DISABILITY LIABILITY AND OTHER INSURANCES REQUIRED BY LAW AND THE OWNER. SUBMIT EVIDENCE OF SAID INSURANCES TO THE OWNER.
- 4. ALL CONTRACTORS AND SUBCONTRACTORS SHALL FAMILIARIZE THEMSELVES WITH THE EXISTING PROJECT CONDITIONS AND THE PROPOSED WORK PRIOR TO BIDDING.
- 5. ALL CONTRACTORS AND SUBCONTRACTORS SHALL VERIFY ALL EXISTING CONDITIONS AND DIMENSIONS ALL CONTRACTORS AND SUBCONTRACTORS SHALL VERIFY ALL EXISTING CONDITIONS AND DIMENSION AT THE JOB SITE AND INFORM THE ARCHITECT OF ANY AND ALL ERRORS, OMISSIONS AND CLARIFICATIONS IN WRITING PRIOR TO COMMENCING WORK. WITHIN 24 HOURS, THE CONTRACTOR MUST NOTIFY THE ARCHITECT IN WRITING OF ANY CONDITION DISCOVERED WHICH MAY CAUSE DELAY IN COMPLETION AND STATE THE PROBLEMIS) AND RECOMMENDED SOLUTION FOR RESOLVING THE CONDITION(S) DISCOVERED. THE ARCHITECT WILL RESPOND BASED ON THE DATA PROVIDED BY THE CONTRACTOR
- 6. THE CONTRACTOR SHALL BE RESPONSIBLE FOR ALL CONSTRUCTION SURVEYS INCLUDING BUT NOT LIMITED TO EXISTING HVAC DUCTS, PLUMBING AND ELECTRICAL LINES.
- ACTUAL FIELD DIMENSIONS OF THE WORK IN PLACE SHALL BE THE CONTRACTOR'S RESPONSIBILITY
- 8. DO NOT SCALE DRAWINGS, USE DIMENSIONS ONLY.
- 9. CONTRACTOR (G.C.) SHALL SCHEDULE AND COORDINATE WORK OF ALL SUBCONTRACTORS SUBCONTRACTORS SHALL COORDINATE THEIR WORK WITH ALL OTHER SUBCONTRACTORS
- 10. ALL WORK SHALL BE DONE BY SKILLED TRADES PEOPLE AND PERFORMED IN A WORKMAN LIKE MANNER IN ACCORDANCE WITH PROFESSIONALLY ACCEPTED INDUSTRY STANDARDS.
- 11. ALL MATERIAL AND EQUIPMENT PROVIDED BY THE CONTRACTOR AND/OR OWNER SHALL BE INSTALLED PER THE MANUFACTURER'S RECOMMENDATIONS AND SPECIFICATIONS
- 12. CONTRACTOR SHALL PROVIDE ALL LABOR AND MATERIAL NECESSARY FOR A COMPLETE JOB WHETHER EXPLICITLY INDICATED ON THE DRAWINGS OR NOT.
- 13. ALL WORK SHALL BE FINISHED AND IN PROPER WORKING ORDER AND SHALL BE GUARANTEED FOR A PERIOD OF ONE (1) YEAR FROM THE DATE OF THE OWNER'S ACCEPTANCE, COINCIDENT WITH THE DATE OF SUBSTANTIAL COMPLETION OR AS OTHERWISE INDICATED.

FP FT FTG

GL GRND

GWB

FOOTING

GALIGE

GLASS

GROUND

HORIZONTAL HOUR

GALVANIZED GYPSUM BOARD GENERAL CONTRACTOR

GYPSUM WALL BOARD

14. THE WORK SHALL BE PERFORMED ONLY DURING THE DAYS AND TIMES ESTABLISHED BY THE OWNER AND IN ACCORDANCE WITH THE LOCAL GOVERNING RULES AND REGULATIONS.

<u>ABBREVIATIONS</u>						
AB	ANCHOR BOLT	ID	INSIDE DIAMETER			
ABV	ABOVE	IN	INCH			
AC ACOUST	AIR CONDITIONING ACOUSTICAL	INFO	INFORMATION			
AD	ACCESS DOOR, AREA DRAIN	J-BOX	JUNCTIONBOX			
ADA ADDL	AMERICANS WITH DISABILITIES ACT ADDITIONAL	JT	JOINT			
AFF	ABOVE FINISHED FLOOR	LAM	LAMINATE			
AIA	AMERICAN INSTITUTE OF ARCHITECTS	LOC	LOCATE			
AISC AL	AMERICAN INSTITUTE OF STEEL CONSTRUCTION ALUMINUM	LTWT	LIGHTWEIGHT			
ALT	ALTERNATE	MAINT	MAINTENANCE			
ALUM ANOD	ALUMINUM ANODIZED	MAS MAT	MASONRY MATERIAL			
APPD	APPROVED	MATL	MATERIAL			
APPROX	APPROXIMATE	MAX	MAXIMUM			
ARCH AUTO	ARCHITECT AUTOMATIC	MECH MET	MECHANICAL METAI			
AUTO	AVERAGE	MFG	MANUFACTURER			
•		MISC	MISCELLANEOUS			
BDRM BEL	BEDROOM BELOW	MO	MASONRY OPENING			
BTWN	BETWEEN	NAT	NATURAL			
BLDG	BUILDING	(N)	NEW			
BLK BLKG	BLOCK BLOCKING	NOM	NOMINAL			
DLING	BEGGINING	ОС	ON CENTER			
CB CCW	CATCH BASIN COUNTER CLOCKWISE	OD OF	OUTSIDE DIAMETER OUTSIDE FACE			
CEM	CEMENT	OHD	OVER HEAD			
CER	CERAMIC	OPNG	OPENING			
CFT CIP	CUBIC FOOT CAST-IN-PLACE	OPP	OPPOSITE HAND			
CJ	CONTROL JOINT	PLAM	PLASTICLAMINATE			
CL	CENTERLINE	PTTN	PARTITION			
CLG CLR	CEILING CLEAR	PERP PLMBG	PERPENDICULAR PLUMBING			
CMU	CONCRETE MASONRY UNIT	PLTF	PLATFORM			
CONC	CONCRETE	PLWD PNT	PLYWOOD PAINT			
CONT	CONTINUOUS CARPET	PREFAB	PREFABRICATED			
551	BOURLE	077/				
DBL DEG	DOUBLE DEGREE	QTY	QUANTITY			
DEM	DEMOLISH	RA	RETURN AIR			
DEMO DEPT	DEMOLITION DEPARTMENT	RAD REBAR	RADIUS REINFORCING BAR			
DEPT	DETAIL	REBAR	REFERENCE			
DIAG	DIAGONAL	REQD	REQUIRED			
DIA DIM	DIAMETER DIMENSION	REV RO	REVISION ROUGH OPENING			
DN	DOWN	RWD	REDWOOD			
DTL	DETAIL	COUED	COMEDINE			
DWG DS	DRAWING DOWNSPOUT	SCHED SC	SCHEDULE SOLID CORE			
		SECT	SECTION			
EA EIFS	EACH EXTERIOR INSULATION AND FINISH SYSTEM	SF SHT	SQUAREFOOT SHEET			
EJ	EXPANSION JOINT	SIM	SIMILAR			
ELECT	ELECTRICAL	SPECS	SPECIFICATIONS			
ENGR EQ	ENGINEER EQUAL	SQ SSTL	SQUARE STAINLESS STEEL			
EQUIP	EQUIPMENT	STD	STANDARD			
(E)	EXISTING	STL	STEEL			
FDTN	FOUNDATION	STRUCT	STRUCTURAL			
FE	FIRE EXTINGUISHER	T&B	TOP AND BOTTOM			
FEC FF	FIRE EXTINGUISHER CABINET FINISHED FLOOR	T&G TBD	TONGUE & GROOVE TO BE DETERMINED			
FF&E	FIXTURES, FURNISHINGS & EQUIPMENT	TD	TRENCH DRAIN			
FHC	FIRE HOSE CABINET	TRD	TREAD			
FLR FOS	FLOOR FACE OF STUDS	TSLAB TS	TOP OF SLAB TOP OF STEEL			
FP	FIREPROOF	TW	TOP OF WALL			
CT	FEET	(TVD)	TVDICAL			

(TYP)

UNO

UON

W/O WC WD WWM

TYPICAL

LINDERWRITERS LAB

WOOD WELDED WIRE MESH

VERTICAL VERIFY IN FIELD

WITHOLIT WATER CLOSET

LINI ESS NOTED OTHERWISE

DRAWING SYMBOLS

	BREAK LINE	10 ROOM#	ROOM IDENTIFICATION
3RD FLOOR +32'-0"	ELEVATION MARKER	102	WINDOW NUMBER
	HIDDEN OR OVERHEAD LINE		
2'-0"	DIMENSION LINE	(01)	DOOR NUMBER
\checkmark	ALIGNMENT	— • • • •	BOOK NOWBER
01 A3.0	DETAIL SYMBOL	<u>03</u>	PARTITION TYPE
01 A3.0	SECTION DETAIL		REVISION SYMBOL
01 A3.0	BUILDING SECTION	D 01 B	ELEVATION SYMBOL

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02 10.01.15 NOPDR #1 03 02.19.16 NOPDR #1 - REVISED

01 09 08 14 SITE PERMIT FILING

EDMONDS + LEE ARCHITECTS, INC.

2601 Mission St., #503 San Francisco, CA 94110 T 415 . 285 . 1300 www.edmondslee.com



PROJECT:

MARKET ST. MIXED-USE SAN FRANCISCO, CA 94114

DRAWING:

SYMBOLS AND **ABBREVIATIONS**

SCALE:	NONE
DATE:	FEBRUARY 19, 2016
JOB NO.	2013.10
DRAWN:	
CAD FILE:	

Green Building: Site Permit Submittal

BASIC INFORMATION:

These facts, plus the primary occupancy, determine which requirements apply. For details, see AB 093 Attachment A Table 1.

Project Name	Block/Lot	Address
MARKET STREET MIXED-USE	3559 / 001	2201 MARKET STREET, SAN FRANCISCO, CA 94114
Gross Project Area	Primary Occupancy	Number of occupied floors
23,457 SF	R-2 / M	6
Design Professional/Applicant: Sign & Da	ite O	

SEPTEMBER 8, 2014

windows STC 30, party walls and floor-ceilings STC 40.

Instructions:

As part of application for site permit, this form acknowledges the specific green building requirements that apply to a project under San Francisco Green Building Code, California Title 24 Part 11, and related codes. Attachment C3, C4, C5, C6, C7, or C8 will be due with the applicable addendum. To use the form:

(a) Provide basic information about the project in the box at left. This info determines which green building requirements apply.

(b) Indicate in one of the columns below which type of project is proposed. If applicable, fill in the blank lines below to identify the number of points the project must meet or exceed. A LEED or GreenPoint checklist is not required to be submitted with the site permit application, but using such tools as early as possible is strongly recommended.

Solid circles in the column indicate mandatory measures required by state and local codes. For projects applying LEED or GreenPoint Rated, prerequisites of those systems are mandatory. See relevant codes for details.

Attachment C-2: Green Building:

Permit Submittal Site

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•		ĺ
Construction activity stormwater pollution prevention and site runoff controls - Provide a construction site Stormwater Pollution Prevention Plan and implement SFPUC Best Management Practices.	•	
Stormwater Control Plan: Projects disturbing ≥5,000 square feet must implement a Stormwater Control Plan meeting SFPUC Stormwater Design Guidelines	•	
Water Efficient Irrigation - Projects that include ≥ 1,000 square feet of new or modified landscape must comply with the SFPUC Water Efficient Irrigation Ordinance.	•	
Construction Waste Management – Comply with the San Francisco Construction & Demolition Debris Ordinance	•	l
Recycling by Occupants: Provide adequate space and equal access for storage, collection and loading of compostable, recyclable and landfill materials. See Administrative Bulletin 088 for details.	•	,

ALL PROJECTS, AS APPLICABLE

GREENPOINT RATED PROJECTS

Proposing a GreenPoint Rated Project (Indicate at right by checking the box.)			
Base number of required Greenpoints:	75		
Adjustment for retention / demolition of historic features / building:			
Final number of required points (base number +/-adjustment)			
GreenPoint Rated (i.e. meets all prerequisites)	•		
Energy Efficiency: Demonstrate a 10% energy use reduction compared to Title 24, Part 6 (2013).	•		
Meet all California Green Building Standards			
Code requirements			
(CalGreen measures for residential projects have			
been integrated into the GreenPoint Rated system.)			

Notes

1) New residential projects of 4 or more occupied floors must use the "New Residential High-Rise" column. New residential with 3 or fewer occupied floors must use the "New Residential Low Rise" column. 2) LEED for Homes Mid-Rise projects must meet the "Silver" standard including all prerequisites. The number of points required to achieve Silver depends on unit size. See LEED for Homes Mid-Rise Rating System to confirm the base number of points required.

		LDIN	OULUI	0			
		New Large Com- mercial	New Low Rise Residential	New High Rise Residential	Large First Time Commerical Interior	Commercial Major Alteration	Residential Major Alteration
	Type of Project Proposed (Indicate at right)						
	Overall Requirements:			9			
	LEED certification level (includes prerequisites):	GOLD	SILVER	SILVER	GOLD	GOLD	GOLD
	Base number of required points:	60	2	50	60	60	60
	Adjustment for retention / demolition of historic features / building:				n/a		
\exists	Final number of required points (base number +/- adjustment)				50		
	Specific Requirements: (n/r indicates a measure is no	ot required)					
	Construction Waste Management – 75% Diversion AND comply with San Francisco Construction & Demolition Debris Ordinance - LEED MR 2, 2 points	•	•	•	•	Meet C&D ordinance only	•
	Energy Use Comply with California Title-24 Part 6 (2013) and meet LEED minimum energy performance (LEED EA p2)	•	LEED prerequisite	•	•		ED isite only
	Renewable Energy or Enhanced Energy Efficiency Effective 1/1/2012: Generate renewable energy on-site ≥1% of total annual energy cost (LEED EAc2), OR Demonstrate at least 10% energy use reduction (compared to Title 24 Part 6 2013), OR Purchase Green-E certified renewable energy credits for 35% of total electricity use (LEED EAc6).	•	n/r	n/r	n/r	n/r	n/r
	Enhanced Commissioning of Building Energy Systems LEED EA 3	•		Mee	t LEED prerequi	sites	
\neg	Water Use - 30% Reduction LEED WE 3, 2 points	•	Meet LEED prerequisite	•	Mee	et LEED prerequ	ilsite
4	Enhanced Refrigerant Management LEED EA4	•	n/r	n/r	•	•	n/r
-	Indoor Air Quality Management Plan LEED IEQ 3.1	•	CalGreen 4.504.1	CalGreen 4.504.1	CalGreen 5.504.3	CalGreen 5.504.3	CalGreen 4.504.1
4	Low-Emitting Materials LEED IEQ 4.1, 4.2, 4.3, and 4.4	•	•	•	•	•	•
	Bicycle parking: Provide short-term and long-term bicycle parking for 5% of total motorized parking capacity each, or meet San Francisco Planning Code Sec 155, whichever is greater, or meet LEED credit SSc4.2.	•		cisco Planning	•		cisco Planning e 155
	Designated parking: Mark 8% of total parking stalls for low-emitting, fuel efficient, and carpool/van pool vehicles.	•			•	n/r	n/r
	Water Meters: Provide submeters for spaces projected to consume more than 1,000 gal/day, or more than 100 gal/day if in building over 50,000 sq. ft.	•	n/r	n/r	•	(addition only)	n/r
ne er	Air Filtration: Provide at least MERV-8 filters in regularly occupied spaces of mechanically ventilated buildings (or LEED credit IEQ 5).	•	n/r	n/r	•	•	n/r
ard,	Air Filtration: Provide MERV-13 filters in residential buildings in air-quality hot-spots (or LEED credit IEQ 5). (SF Health Code Article 38 and SF Building Code 1203.5)	n/r	•	•	n/r	n/r	•
-	Acoustical Control: Wall and roof-ceilings STC 50, exterior	•	See CE	3C 1207	•	(anyolone alteration	n/r

LEED PROJECTS

Requirements below only apply when the measure is applicable to the project. Code references below are applicable to New Non-Residential buildings. Corresponding requirements for additions and alterations can be found in Title 24 Part 11, Division 5.7. Requirements for additions or alterations apply to applications received July 1, 2012 or after. ³	Other New Non- Residential	Addition ≥1,000 sq ft OR Alteration ≥\$200,000³
Type of Project Proposed (Check box if applicable)		
Energy Efficiency: Comply with California Energy Code, Title 24, Part 6 (2013).	•	•
Bicycle parking: Provide short-term and long-term bicycle parking for 5% of total motorized parking capacity each, or meet San Francisco Planning Code Sec 155, whichever is greater (or LEED credit SSc4.2).	•	•
Fuel efficient vehicle and carpool parking: Provide stall marking for low-emitting, fuel efficient, and carpool/van pool vehicles; approximately 8% of total spaces.	•	•
Water Meters: Provide submeters for spaces projected to consume >1,000 gal/day, or >100 gal/day if in buildings over 50,000 sq. ft.	•	Addition only
Indoor Water Efficiency: Reduce overall use of potable water within the building by 20% for showerheads, lavatories, kitchen faucets, wash fountains, water closets, and urinals.	•	•
Commissioning: For new buildings greater than 10,000 square feet, commissioning shall be included in the design and construction of the project to verify that the building systems and components meet the owner's project requirements. OR for buildings less than 10,000 square feet, testing and adjusting of systems is required.	•	(Testing & Balancing)
Protect duct openings and mechanical equipment during construction	•	•
Adhesives, sealants, and caulks: Comply with VOC limits in SCAQMD Rule 1168 VOC limits and California Code of Regulations Title 17 for aerosol adhesives.	•	•
Paints and coatings: Comply with VOC limits in the Air Resources Board Architectural Coatings Suggested Control Measure and California Code of Regulations Title 17 for aerosol paints. Carpet: All carpet must meet one of the following: 1. Carpet and Rug Institute Green Label Plus Program,	•	•
California Department of Public Health Standard Practice for the testing of VOCs (Specification 01350), NSF/ANSI 140 at the Gold level, Scientific Certifications Systems Sustainable Choice, OR California Collaborative for High Performance Schools EQ 2.2 and listed in the CHPS High Performance Product Database AND carpet cushion must meet Carpet and Rug Institute Green Label, AND indoor carpet adhesive & carpet pad adhesive must not exceed 50 g/L VOC content.	•	•
Composite wood: Meet CARB Air Toxics Control Measure for Composite Wood	•	•
Resilient flooring systems: For 80% of floor area receiving resilient flooring, install resilient flooring complying with the VOC-emission limits defined in the 2009 Collaborative for High Performance Schools (CHPS) criteria or certified under the Resilient Floor Covering Institute (RFCI) FloorScore program.	•	•
Environmental Tobacco Smoke: Prohibit smoking within 25 feet of building entries, outdoor air intakes, and operable windows.	•	•
Air Filtration: Provide at least MERV-8 filters in regularly occupied spaces of mechanically ventilated buildings.	•	•
Acoustical Control: Wall and roof-ceilings STC 50, exterior windows STC 30, party walls and floor-ceilings STC 40.	•	(envelope alteration addition only)
CFCs and Halons: Do not install equipment that contains CFCs or Halons.	•	•
Additional Requirements for New A, B, I, OR M Occupancy Projects 5	5,000 - 25,000	Square Feet
Construction Waste Management — Divert 75% of construction and demolition debris AND comply with San Francisco Construction & Demolition Debris Ordinance.	•	Meet C&D ordinance only
Renewable Energy or Enhanced Energy Efficiency Effective January 1, 2012: Generate renewable energy on-site equal to ≥1% of total annual energy cost (LEED EAc2), OR demonstrate a 10% energy use reduction compared to Title 24 Part 6 (2013), OR purchase Green-E certified renewable energy credits for 35% of total electricity use (LEED EAc6).	•	n/r

OTHER APPLICABLE NON-RESIDENTIAL PROJECTS

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MIXED-U


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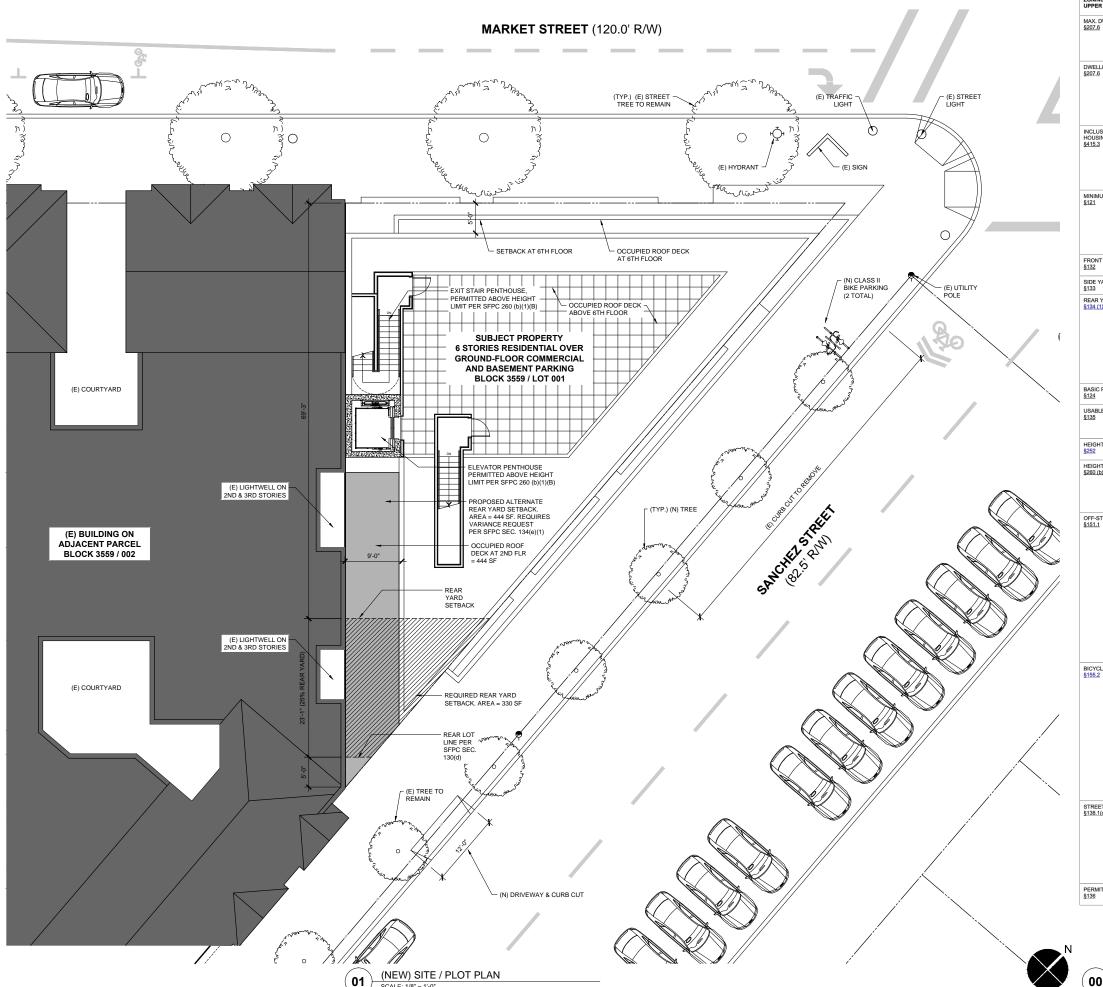
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MARKET ST. MIXED-USE

GREEN BUILDING SITE PERMIT SUBMITTAL


SCALE:	NONE
DATE:	FEBRUARY 19, 2016
JOB NO.	2013.10
DRAWN:	
CAD FILE:	



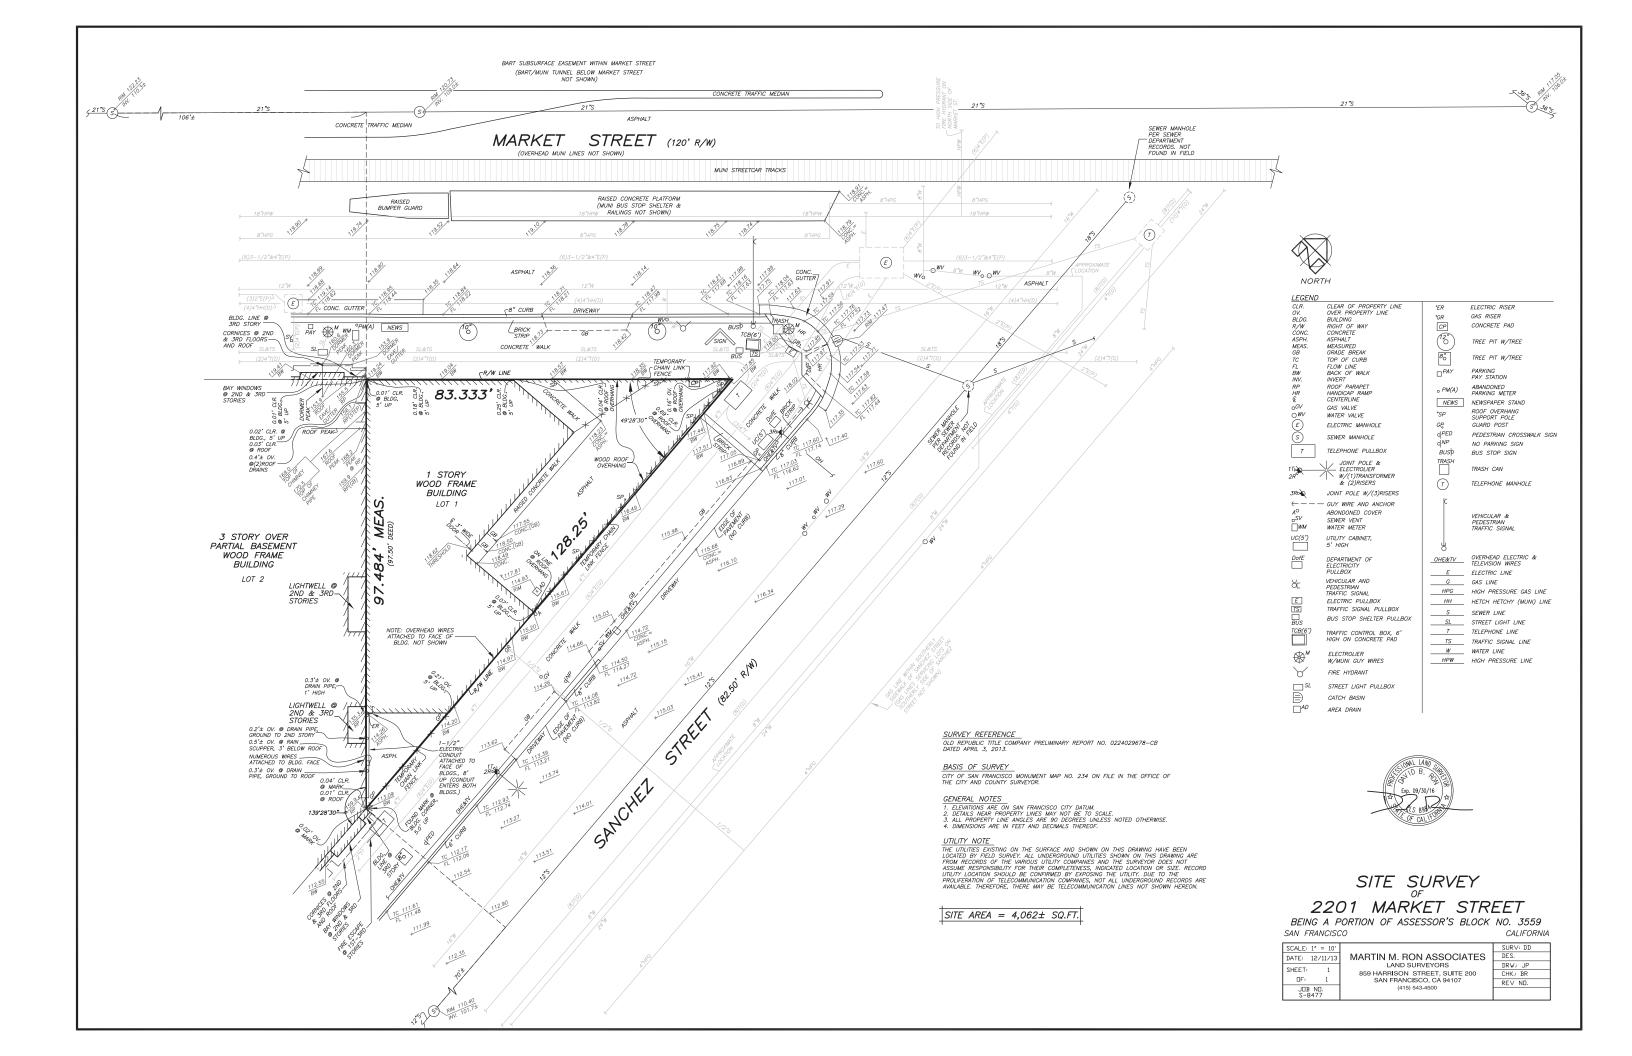

SCALE: 1/8" = 1'-0"

2007 10.01 15 NOPPOR #1 - REV	ZONING CALCULATIONS UPPER MARKET NEIGHBORHOOD	COMMERCIAL TRANSIT (NCT)	REQUIRED / ALLOWED	EXISTING	PROPOSED	NO:	DATE:	SUBMISSION:
PROPERTY OF THE PROPERTY OF		CONTROLLED BY HEIGHT, BULK, SETBACKS, OPEN SPACE AND DWELLING UNIT EXPOSURE.	UNLIMITED	0	14 UNITS	02	10.01.15	SITE PERMIT FILI NOPDR #1 NOPDR #1 - REVI
BA		PROPOSED DWELLING UNITS SHALL		1-BED UNITS 0 TOTAL (0%)				
PROJUCTORY OF PROPOSED PARTY				NA	2-BED UNITS 6 TOTAL (43%)			
MOURIST OF JOIN ADDRESS (LIVER'S B) MOURIST OF JOIN ADDRESS (LIVER		PROPOSED DWELLING UNITS SHALL	UNLIMITED	0 TOTAL UNITS	14 TOTAL UNITS			
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FROM TVADD BITTANCK NOME REQUIRED 10°C		LOT SIZE		83.33' MARKET ST. 128.25'	83.33' MARKET ST. 128.25'	-	ARCH 2601 Mi San Fran	SSION St., #503 cisco, CA 94110
SEC VARIO BETRACK NORTH ROAT NORTH ROAT NORTH ROAT NORTH ROAT SOUTH ROA		LOT FRONTAGE	16'-0" MIN.	211.58'	211.58'			
SOUTH FOR SOUTH		NONE REQUIRED	0'-0"	0'-0"	0'-0"			
REANY YARDS SHALL BE PROVIDED AT THE GRADE STANLAR BE PROVIDED AT THE GRADE STANLAR BE PROVIDED AT THE ALL PRIVATE AND THE PROPERTY MARKET NATIONAL PROVIDED AT THE STANLAR BE PROVIDED AS THE STANLAR BE PROVID		NONE REQUIRED						
USBBLE OPEN SPACE 0.5 SP PER UNIT IF ALL PRIVATE 0.5 SP PER UNIT IF ALL PUBLIC. 0.5 SP PER	REAR YARD SETBACK \$134 (1) (D)	THE GRADE LEVEL, AND AT EACH SUCCEEDING STORY OF THE BUILDING. FOR BUILDINGS IN THE UPPER MARKET NOT THAT DO NOT CONTROL USES AND THAT DO NOT CONTROL USES AND THAT DO NOT EXISTING AND THAT DO NOT SHAPPEN OF THE STORY OF THE ST			VARIANCE REQUIRED FOR 5'-0" REAR YARD SETBACK PER SUBSECTION			
### 1535 ### 15			N/A	N/A	N/A			
### SECOND STATE AND MECHANICAL PROVINCINGS FIRST TOWERS, STATE AND MECHANICAL PROVINCING FIRST TOWERS, STATE AND MECHANICAL MITTS OF THE WORK FIRST TOWERS FIRST T		60 SF PER UNIT IF ALL PRIVATE. 80 SF PER UNIT IF ALL PUBLIC.	(80 SF * 9	0 SF	720 SF			
SEQUIDITION SPENTIOUSES, FIRE TOWERS, SPENTIONES, SPENTIONES, SPENTIONES, SPENTIONES, SPENTIONES, SPENTIONES, SPENTIONES, SPENTIONES, SPENTING SPENTING SPENTING SIBILITY OF 10 FEET OF SUCH FEATURES WHERE THE HEIGHT LIMIT IS 65 FEET OF 10 SECONDER VISIONES OF SECONDES SPENTING SIBILITY OF 10 FEET OF 10 SECONDES OF SECONDES SPENTING SPE		USE DISTRICT HEIGHT LIMIT 65'-0" MAX	65'-0" MAX	0'-0"	65'-0"			
P UP TO ONE CARP FOR EACH TWO PRELIANG LINTS, CUP TO 3T CARS FOR EACH WELLING LINT, SUBJECT TO THE CRITERIA FOR PACE AND PROCEDURES OF SECTION 191.1(G), NP ABOVE 0.75 CARS FOR EACH WELLING LINT; NON-RESIDENTIAL USE: NON-RESIDENTIAL USE: POR USES IN TABLE 151 THAT ARE DESCRIBED AS A RATIO OF OCCUPIED FLOOR AREA, P UP TO 1 SHACE PER FLOOR AREA F	HEIGHT LIMIT EXEMPTIONS \$260 (b)(1)(B)	PENTHOUSES, FIRE TOWERS, SKYLIGHTS AND DORMER WINDOWS EXEMPT FROM HEIGHT LIMITS FOR THE TOP 10 FEET OF SUCH FEATURES WHERE THE HEIGHT LIMIT IS 65 FEET	ABOVE HEGHT	0'-0"	SEE DRAWINGS			
FOR USES IN TABLE 181 THAT ARE DESCRIBED AS A RATIO OF OCCUPIED FLOOR AREA PIP TOT 1 SPACE PER PIP TOTAL OFF-STREET PARKING: BICYCLE PARKING RESIDENTIAL USE: ONE CLASS I SPACE FOR EVERY DWELLING UNITS. 100 CLASS I SPACES ONE CLASS I SPACE FOR EVERY DWELLING UNITS. 100 CLASS I SPACES S155.2 RESIDENTIAL USE: ONE CLASS I SPACE FOR EVERY DWELLING UNITS. 100 CLASS I SPACES ONE CLASS I SPACE FOR EVERY POWELLING UNITS. 100 CLASS I SPACE FOR EVERY POUR DWELLING UNITS. 100 CLASS I SPACE FOR EVERY POUR DWELLING UNITS. 100 CLASS I SPACE FOR EVERY POUR DWELLING UNITS. 100 CLASS I SPACE FOR EVERY POUR DWELLING UNITS. 100 CLASS I SPACE FOR EVERY POUR DWELLING UNITS. 100 CLASS I SPACE FOR EVERY POUR DWELLING UNITS. 100 CLASS I SPACE FOR EVERY POUR DWELLING UNITS. 100 CLASS I SPACE FOR EVERY POUR DWELLING UNITS. 100 CLASS I SPACE FOR EVERY POUR DWELLING UNITS. 100 CLASS I SPACE FOR EVERY POUR DWELLING UNITS. 100 CLASS I SPACE FOR EVERY POUR DWELLING UNITS. 100 CLASS I SPACE FOR EVERY POUR DWELLING UNITS. 100 CLASS II DWENT DWE	OFF-STREET PARKING §151.1	P UP TO ONE CAR FOR EACH TWO DWELLING UNITS; C UP TO 0.75 CARS FOR EACH DWELLING UNIT; SUBJECT TO THE CRITERIA AND PROCEDURES OF SECTION 151.1(G); NP ABOVE 0.75 CARS	7 SPACES (.5 * 14 UNITS)	0 SPACES	6 SPACES			
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ONE CLASS I SPACE FOR EVERY DWELLING UNIT. FOR BUILDINGS CONTAINING MORE THAN 100 DWELLING UNITS, 100 CLASS I SPACES PLUS ONE CLASS I SPACE FOR EVERY FOUR DWELLING UNITS OVER 100. DWELLING UNITS THAT ARE ALSO CONSIDERED STUDENT HOUSING PER SECTION 102.38 SHALL PROVIDE 50 PERCENT MORE SPACES THAN WOULD OTHERWISE BE REQUIRED RETAIL SALES, INCLUDING GROCERY STORES: ONE CLASS II FOR EVERY 2,500 SF OF OCCUPPIED FLOOR AREA, 2 MINIMUM. STREET TREE STREET TREE STREET TREE SHALL BE REQUIRED UNDER THE FOLLOWING CONDITIONS; CONSTRUCTION OF A NEW BUILDING; RELOCATION OF A BUILDING; THE ADDITION OF GROSS FLOOR AREA EQUAL TO 20% OR MORE OF THE ADDITION OF A NEW BUILDING; RELOCATION OF A BUILDING; RETAIL SALES, INCLUDING; RETAIL SALES, INC			0 0171020				 ★ (2-30208 ★
RETAIL SALES, INCLUDING GROCERY STORES: ONE CLASS II FOR EVERY 2,500 SF OF OCCUPPIED FLOOR AREA, 2 MINIMUM. STREET TREE \$138.1(6)(1) STREET TREES SHALL BE REQUIRED UNDER THE FOLLOWING CONDITIONS: OCCUPPIED FLOOR AREA, 2 MINIMUM. PROVIDED THE FOLLOWING CONDITIONS: OCCUPANCE AND ADDITION OF GROSS FLOOR AREA OF A BUILDING: THE ADDITION OF GROSS FLOOR AREA OF AN EMBINING BUILDING: THE ADDITION OF A BUILDING: THE GROSS FLOOR AREA OF AN EMBINING BUILDING: THE ADDITION OF A MEMBINING BUILDING: THE ADDITION OF AN EMBINING BUILDING: THE ADDITION OF A MEMBINING BUILDING: THE ADDITION OF AN EMBINING BUILDING: THE ADDITION OF AN EMBINING BUILDING: THE ADDITION OF AN EMBINING BUILDING: THE ADDITION OF A MEMBINING BUILDING: THE ADDITION OF AN EMBINING BUILDING: THE ADDITION OF AN EMBINING BUILDING: THE ADDITION OF AN EMBINING BUILDING: THE ADDITION OF A MEMBINING BUILDING: THE ADDITION OF AN EMBINING B		ONE CLASS I SPACE FOR EVERY DWELLING UNIT. FOR BUILDINGS CONTAINING MORE THAN 100 DWELLING UNITS, 100 CLASS I SPACE FOR UNIT OF THE OWNER OF THE OWNER OF THE OWNER OWNE	14 SPACES (CLASS I)		14 SPACES (CLASS I)	MA	JECT:	OF CALIFORNIT
STREET I REE \$138_L1G(1)\$ UNDER THE FOLLOWING CONDITIONS: OUNDER THE FOLLOWING CONDITIONS: OUNDE THE FOLL		STORES: ONE CLASS II FOR EVERY 2,500 SF OF				SAN	FRANCISC	
GROSS FLOOR AREA OF AN EXISTING BUILDING. THE ADDITION OF A NEW DWELLING UNIT, A GAPAGE, OR ADDITIONAL PARKING; OR PAVING OR REPAVING MORE THAN 200 SQUARE FEET OF THE FRONT SETBACK PERMITTED OBSTRUCTIONS SEE DRAWINGS N/A N/A SEE DRAWINGS SCALE: 1/8" = 1'-0" DATE: FEBRUARY 19, 20 JOB NO. 2013.10		UNDER THE FOLLOWING CONDITIONS; CONSTRUCTION OF A NEW BUILDING; RELOCATION OF A BUILDING; THE ADDITION OF GROSS FLOOR AREA	???	???	???			
ADDITIONAL PARKING; OR PAVING OR REPAVING OR REPAVING MORE THAN 200 SQUARE FEET OF THE FRONT SETBACK PERMITTED OBSTRUCTIONS SEE DRAWINGS N/A N/A N/A SEE DRAWINGS DATE: FEBRUARY 19, 20 JOB NO. 2013.10		GROSS FLOOR AREA OF AN EXISTING BUILDING; THE ADDITION OF A NEW				SCAL	E:	1/8" = 1'-0"
PERMITTED OBSTRUCTIONS SEE DRAWINGS N/A N/A SEE DRAWINGS SEE DRAWINGS DRAWINGS		ADDITIONAL PARKING; OR PAVING OR REPAVING MORE THAN 200 SQUARE				DATE	:	FEBRUARY 19, 20
§136 DRAWN:			N/A	N/A		JOB	NO.	2013.10
	§136				DRAWINGS	DRA	NN:	

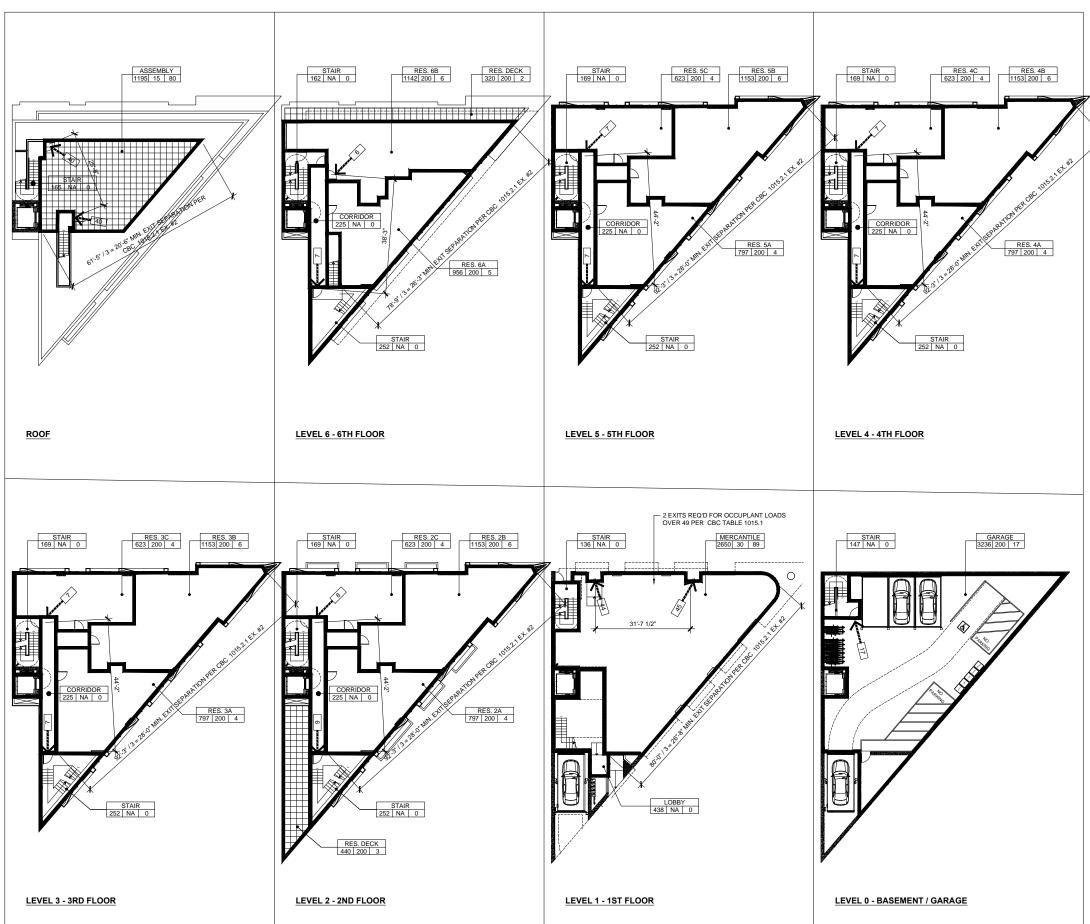

APPLICABLE CODES:

2013 CALIFORNIA BUILDING CODE & SF AMENDMENTS

2013 CALIFORNIA BUILDING CODE & SF AMENDMENTS
2013 CALIFORNIA RESIDENTIAL CODE & SF AMENDMENTS
2013 CALIFORNIA MECHANICAL CODE & SF AMENDMENTS
2013 CALIFORNIA PLUMBING CODE & SF AMENDMENTS
2013 CALIFORNIA ELECTRICAL CODE & SF AMENDMENTS
2013 CALIFORNIA ELECTRICAL CODE
2013 CALIFORNIA ENERGY CODE
2013 CALIFORNIA ENERGY CODE

AREA (SF) 1-BED

2-BED

3-BED

BATHROOMS

2013 SAN FRANCISCO HOUSING CODE 2013 SAN FRANCISCO ENERGY CODE

RESIDENTIAL UNIT MATRIX

01 09.08.14 SITE PERMIT FILING 02 10.01.15 NOPDR #1 03 02.19.16 NOPDR #1 - REVISED

NO: DATE: SUBMISSION

ISSUED FOR NOPDR #1

EDMONDS + LEE ARCHITECTS, INC.

2601 Mission St., #503 San Francisco, CA 94110 T 415 . 285 . 1300 www.edmondslee.com

UILDING	AREA	AND I	LIMITATI	ON S	SUMMAR'	Y:

FLOOR LEVEL	FIRE SPINKLERS	CONST. TYPE	OCCUPANCY TYPE	GROSS AREA (SF)	*ALLOWABLE AREA PER STORY (TABLE 503)	*ALLOWABLE HT. (TABLE 503)
LEVEL 0	YES	IB	S2	3,383	29,000	12 STORIES
LEVEL 1	YES	IB	M	3,224	UNLIMITED	12 STORIES
LEVEL 2	YES	IB	R2	3,659	UNLIMITED	12 STORIES
LEVEL 3	YES	IB	R2	3,219	UNLIMITED	12 STORIES
LEVEL 4	YES	IB	R2	3,219	UNLIMITED	12 STORIES
LEVEL 5	YES	IB	R2	3,219	UNLIMITED	12 STORIES
LEVEL 6	YES	IB	R2	2,737	UNLIMITED	12 STORIES
BUILDING TO	OTAL YES	IB	MIXED USE	22,660	UNLIMITED	12 STORIES

*ASSUMES AREA INCREASE AND 1 EXTRA STORY ALLOWED FOR FIRE SPRINKLERED AREAS PER 2010 CBC 504.2


OCCUPA	OCCUPANT LOAD CALCULATION (2013 CBC 1004.1):					
FLOOR LEVEL	2010 CBC CHPT. 3 OCC. GROUP	2010 CBC TABLE 1004.1.1 FUNCTION OF SPACE	GROSS AREA* (SF)	2010 CBC TABLE 1004.1.1 LOAD FACTOR	TOTAL OCCUPANTS	EXITS REQ'D
LEVEL 0	S-2	PARKING GARAGE	3,236	200	17	1
LEVEL 1	M	MERCANTILE	2,650	30	89	2
LEVEL 2	R2	RESIDENTIAL	2,573	200	14	2
LEVEL 3	R2	RESIDENTIAL	2,573	200	14	2
LEVEL 4	R2	RESIDENTIAL	2,573	200	14	2
LEVEL 5	R2	RESIDENTIAL	2,573	200	14	2
LEVEL 6	R2	RESIDENTIAL	2,098	200	13	2
ROOF	R2 (ACCESSORY USE)	ASSEMBLY	1,195	15	80	2
BUILDING	TOTAL	1	8,276 (EXCLUD ROOF)	ES	255	2

* PER CBC 1002.1, "FLOOR AREA GROSS IS THE AREA WITHIN THE INSIDE PERIMETER OF THE EXTERIOR WALLS OF THE BUILDING UNDER CONSIDERATION, EXCLUSIVE OF VENT SHAFTS AND COURTS, WITHOUT DEDUCTION FOR CORRIDORS, STAIRWAYS, CLOSETS, THE THICKNESS OF INTERIOR WALLS, COLUMNS OR OTHER FEATURES.

** PER CBC 1015.1: TWO EXITS OR EXITS ACCESS DOORWAYS FROM ANY SPACE SHALL BE PROVIDED WHERE THE OCCUPANT LOAD OF THE SPACE EXCEEDS THE VALUES IN TABLE 1015.1.

EXIT WIDTH CALCULATION (2013 CBC 1005.1):

- THE MINIMUM EXIT WIDTH SHALL BE AS DETERMINED IN THE EXIT WIDTH CALCULATION ABOVE PER 2010 CBC 1005.1, BUT AT NO TIME SHALL IT BE LESS THAN 44" PER 2010 CBC 1018.2.
- PER 2010 CBC 1016.1, THE MAXIMUM TRAVEL DISTANCE FROM THE MOST REMOTE POINT WITHIN A STORY TO AN EXIT SHALL NOT EXCEED 200 IN LENGTH. FOR BUILDINGS EQUIPPED WITH AN AUTOMATIC SPRINKLER SYSTEM, THE MAXIMUM TRAVEL DISTANCE SHALL NOT EXCEED 250 IN LENGTH PER TABLE 1016.1.
- PER 2010 CBC 1014.2: EGRESS THROUGH INTERVENING SPACES IS ALLOWED SO LONG AS THE FOLLOWING ARE TRUE
 - a FGRESS FROM A ROOM OR SPACE SHALL NOT PASS THROUGH ADJOINING OR INTERVENING ROOMS OR AREAS. EXCEPT WHERE SUCH ADJOINING ROOMS OR AREAS ARE ACCESSORY TO THE AREA SERVED, ARE NOT A HIGH-HAZARD OCCUPANCY AND PROVIDE A DISCERNIBLE PATH OF EGRESS TRAVEL TO AN EXIT.
 - b. THE EXIT ACCESS SHALL NOT PASS THROUGH A ROOM THAT CAN BE LOCKED TO PREVENT ACCESS.
- PER CBC 1024: EXITS SHALL DISCHARGE DIRECTLY TO THE EXTERIOR OF THE BUILDING. THE EXIT DISCHARGE SHALL BE AT GRADE OR SHALL PROVIDE DIRECT ACCESS TO GRADE. THE EXIT DISCHARGE SHALL NOT REENTER THE BUILDING.
- PER CBC 1024.6: WHERE ACCESS TO A PUBLIC WAY CANNOT BE PROVIDED A SAFE DISPERSAL AREA SHALL BE PROVIDED WHERE ALL CBC REQUIREMENTS ARE MET.
- PER 1026.1: IN ADDITION TO THE MEANS OF EGRESS REQUIRED, PROVISIONS SHALL BE MADE FOR EMERGENCY ESCAPE AND RESCUE IN GROUP R AND 1-1 OCCUPANCIES, BASEMENTS AND SLEEPING ROOMS BELOW THE FOURTH STORY ABOVE THE GRADE PLANE SHALL HAVE AT LEAST ONE EXTERIOR EMERGENCY ESCAPE AND RESCUE OPENING IN ACCORDANCE WITH THIS SECTION.
- PER 1026.1, EXCEPTION-4: EMERGENCY ESCAPE AND RESCUE OPENING ARE NOT REQUIRED FROM BASEMENTS OR SLEEPING ROOMS THAT HAVE A NEXT DOOR OR EXIT ACCESS DOOR THAT OPENS DIRECTLY INTO A PUBLIC WAY OR TO A YARD, COURT OR EXIT BALCONY THAT THAT PROVIDES ACCESS TO A PUBLIC WAY.
- PER SFBC 3403.4: STAIRWAYS THAT REPLACE EXISTING STAIRWAYS IN OCCUPANCIES AND WHICH COMPLIED WITH THE CODE IN EFFECT AT THE TIME THEY WERE CONSTRUCTED, AND WHICH HAVE BEEN ADEQUATELY MAINTAINED AND INCREASED IN RELATION TO MEN INCREASES IN OCCUPANT LOAD, ALTERATION OR ADDITION, OR ANY CHANGE IN OCCUPANCY, MAY BE RECONSTRUCTED IN THE SAME CONFIGURATION AND CONSTRUCTION AS THE EXISTING STARWAYS.

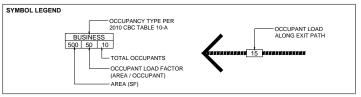



MARKET ST. MIXED-USE SAN FRANCISCO, CA 94114

AREA, EXITING AND **OCCUPANCY CALCULATIONS**

SCALE:	1/16" = 1'-0"
DATE:	FEBRUARY 19, 2016
JOB NO.	2013.10
DRAWN:	
CAD FILE:	



04 VIEW OF SUBJECT PROPERTY
SCALE: N.T.S.








VIEW OF SUBJECT PROPERTY
SCALE: N.T.S.



VIEW LOOKING SW FROM SANCHEZ STREET
SCALE: N.T.S.

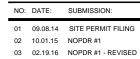

ISSUED FOR NOPDR #1

EDMONDS + LEE ARCHITECTS, INC.

2601 Mission St., #503 San Francisco, CA 94110 T 415 . 285 . 1300 www.edmondslee.com



PROJECT:

MARKET ST. MIXED-USE 2201 MARKET STREET SAN FRANCISCO, CA 94114

DRAWING:

SITE PHOTOS

SCALE:	AS NOTED
DATE:	FEBRUARY 19, 2016
JOB NO.	2013.10
DRAWN:	
CAD FILE:	



BIRDSEYE VIEW FROM SANCHEZ STREET SCALE: N.T.S.








BIRDSEYE VIEW FROM MARKET STREET
SCALE: N.T.S.



VIEW LOOKING NE FROM MARKET STREET

SCALE: N.T.S.

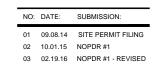

ISSUED FOR NOPDR #1

EDMONDS + LEE ARCHITECTS, INC.

2601 Mission St., #503 San Francisco, CA 94110 T 415 . 285 . 1300 www.edmondslee.com



PROJECT:

MARKET ST. MIXED-USE 2201 MARKET STREET SAN FRANCISCO, CA 94114


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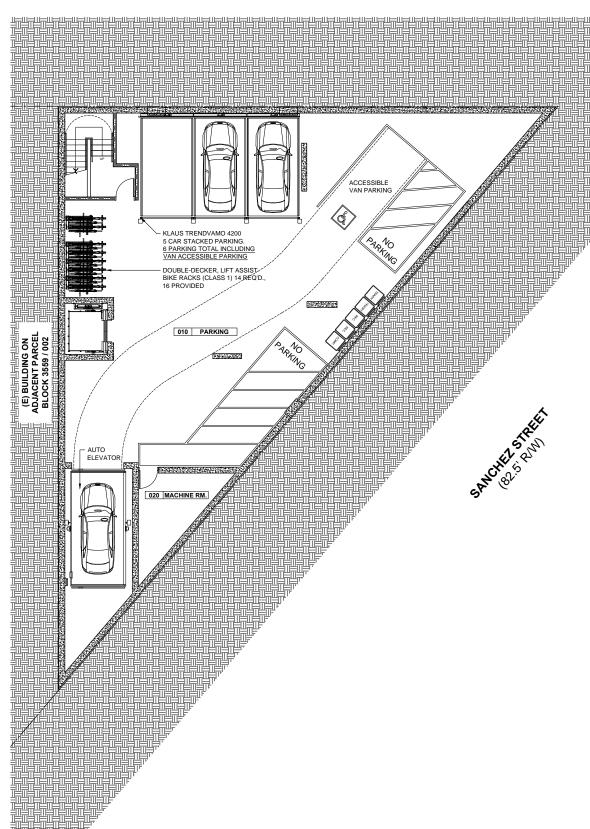
CONCEPT RENDERINGS

SCALE:	AS NOTED
DATE:	FEBRUARY 19, 2016
JOB NO.	2013.10
DRAWN:	
CAD FILE:	

NO: DATE: SUBMISSION:

01 09.08.14 SITE PERMIT FILING
02 10.01.15 NOPDR #1
03 02.19.16 NOPDR #1 - REVISED




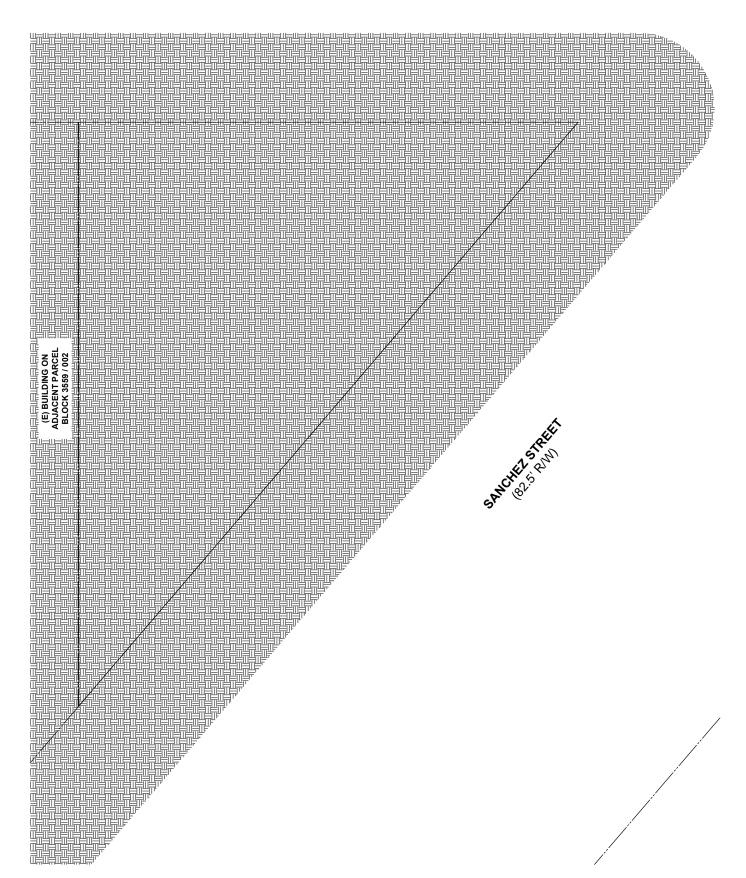

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PROJEC

MARKET ST. MIXED-USE 2201 MARKET STREET SAN FRANCISCO, CA 94114

DRAWING:

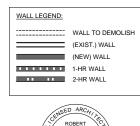FLOOR PLANS

SCALE:	1/8" = 1'-0"
DATE:	FEBRUARY 19, 2016
JOB NO.	2013.10
DRAWN:	
CAD FILE:	



A1.00

(E) COMMERCIAL BUILDING TO BE DEMOLISHED

OPEN, EXTERIOR SPACE

- (E) TELEPHONE PULLBO TO BE RELOCATED


(E) TRAFFIC SIGNAL CONTROL BOX AND ELECTRICAL PULLBOX TO BE RELOCATED

(E) TREE TO -REMAIN

MARKET STREET (

		NO:	DATE:	SUBIVIISSIUN:
		01	09.08.14	SITE PERMIT FIL
(120.0' R/W)		02	10.01.15	NOPDR #1
	 7	03	02.19.16	NOPDR #1 - REV




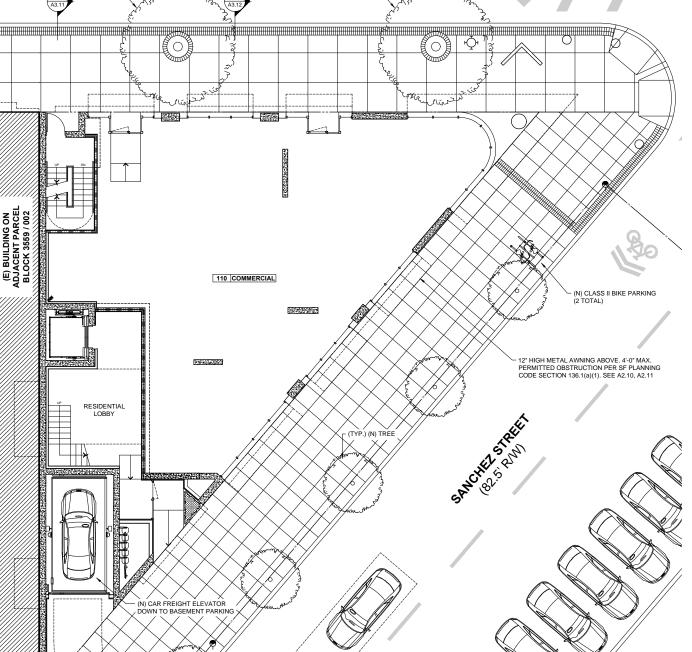

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C-30208 REN. 02/28/17

PROJECT:

MARKET ST. MIXED-USE 2201 MARKET STREET SAN FRANCISCO, CA 94114

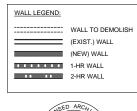
DRAWING:


FLOOR PLANS

SCALE:	1/8" = 1'-0"
DATE:	FEBRUARY 19, 2016
JOB NO.	2013.10
DRAWN:	
CAD FILE:	

(E) TREE TO REMAIN


- (N) DRIVEWAY & CURB CUT

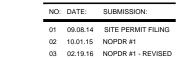

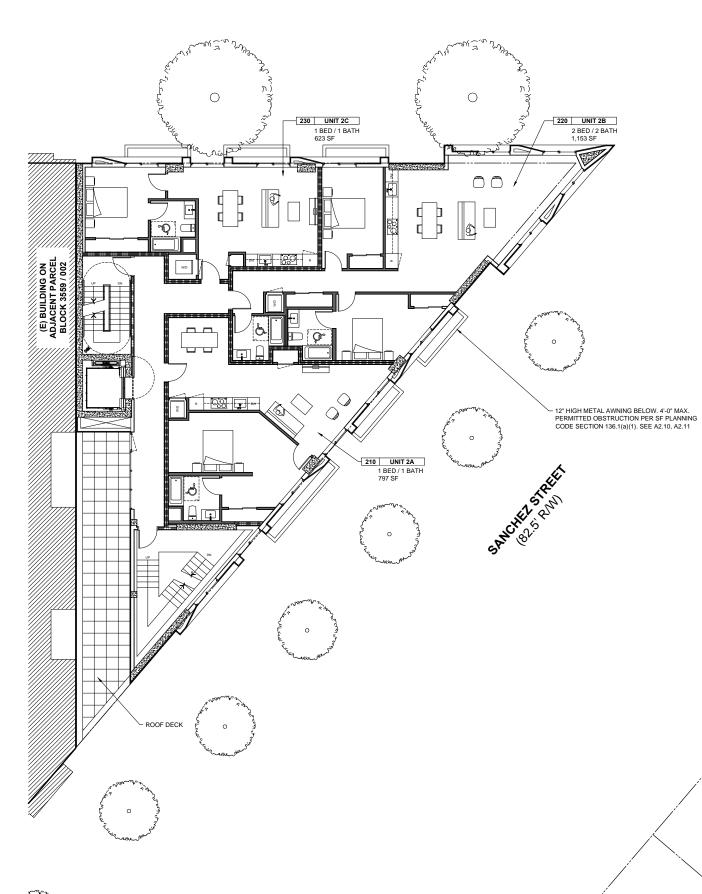

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PROJECT:

MARKET ST. MIXED-USE 2201 MARKET STREET SAN FRANCISCO, CA 94114

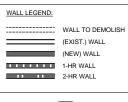DRAWING:

FLOOR PLANS

SCALE:	1/8" = 1'-0"
DATE:	FEBRUARY 19, 2016
JOB NO.	2013.10
DRAWN:	
CAD FILE:	

A1.02





 \circ

OPEN, EXTERIOR SPACE

(E) COMMERCIAL BUILDING TO BE DEMOLISHED


·	NO:	DATE:	SUBMISSION:
	01	09.08.14	SITE PERMIT FILING
	02	10.01.15	NOPDR #1
	03	02.19.16	NOPDR #1 - REVISED

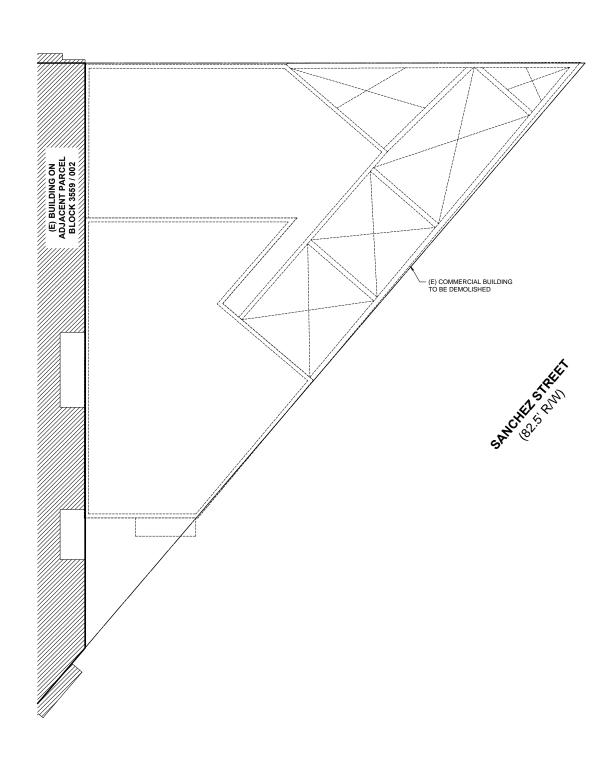

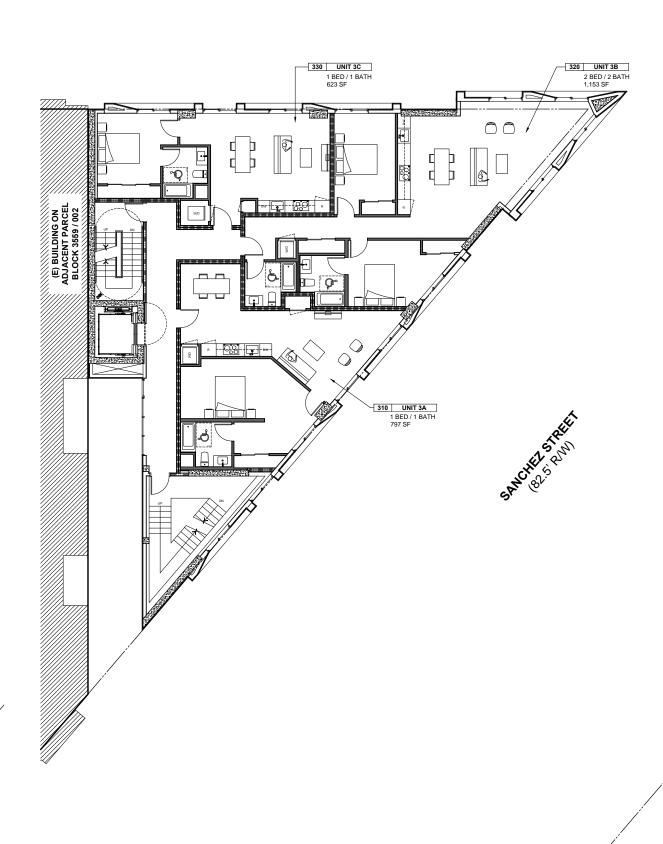

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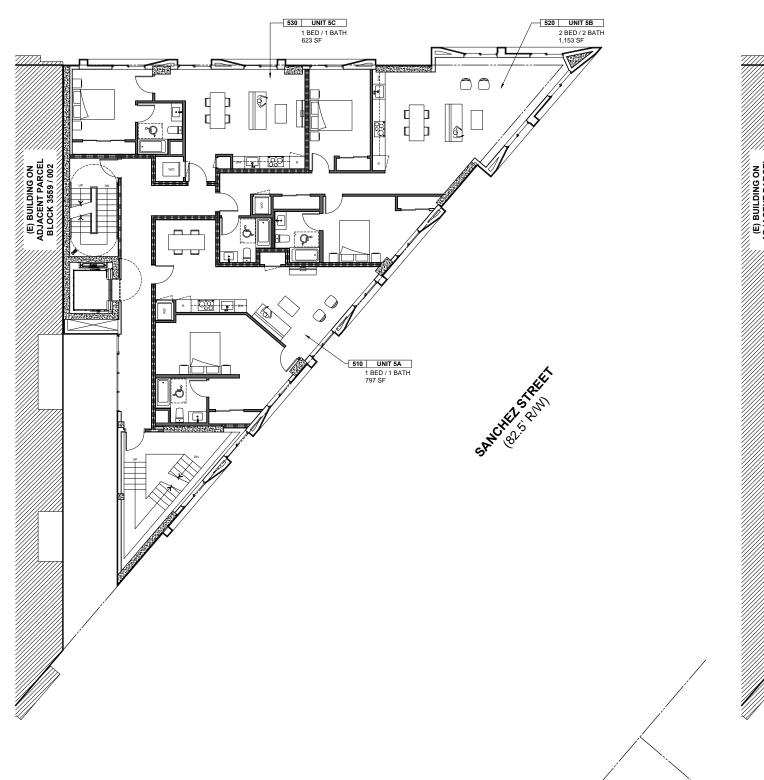
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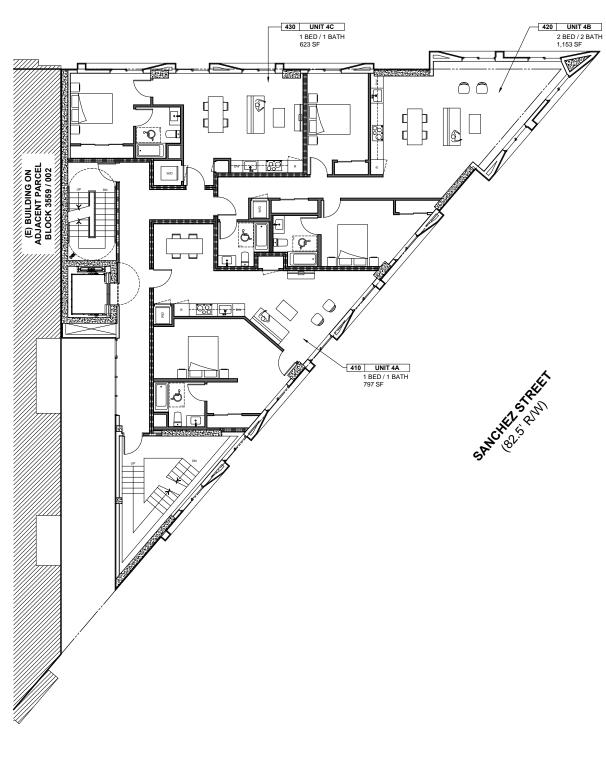
FLOOR PLANS

SCALE:	1/8" = 1'-0"
DATE:	FEBRUARY 19, 2016
JOB NO.	2013.10
DRAWN:	
CAD FILE:	

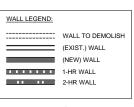


NO:	DATE:	SUBMISSION:
01	09.08.14	SITE PERMIT FILING
02	10.01.15	NOPDR #1
03	02.19.16	NOPDR #1 - REVISED





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PROJECT:

MARKET ST. MIXED-USE 2201 MARKET STREET SAN FRANCISCO, CA 94114

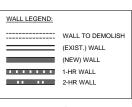DRAWING:


FLOOR PLANS

SCALE:	1/8" = 1'-0"
DATE:	FEBRUARY 19, 2016
JOB NO.	2013.10
DRAWN:	
CAD FILE:	




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NO:	DATE:	SUBMISSION:
01	09.08.14	SITE PERMIT FILING
02	10.01.15	NOPDR #1
03	02.19.16	NOPDR #1 - REVISED

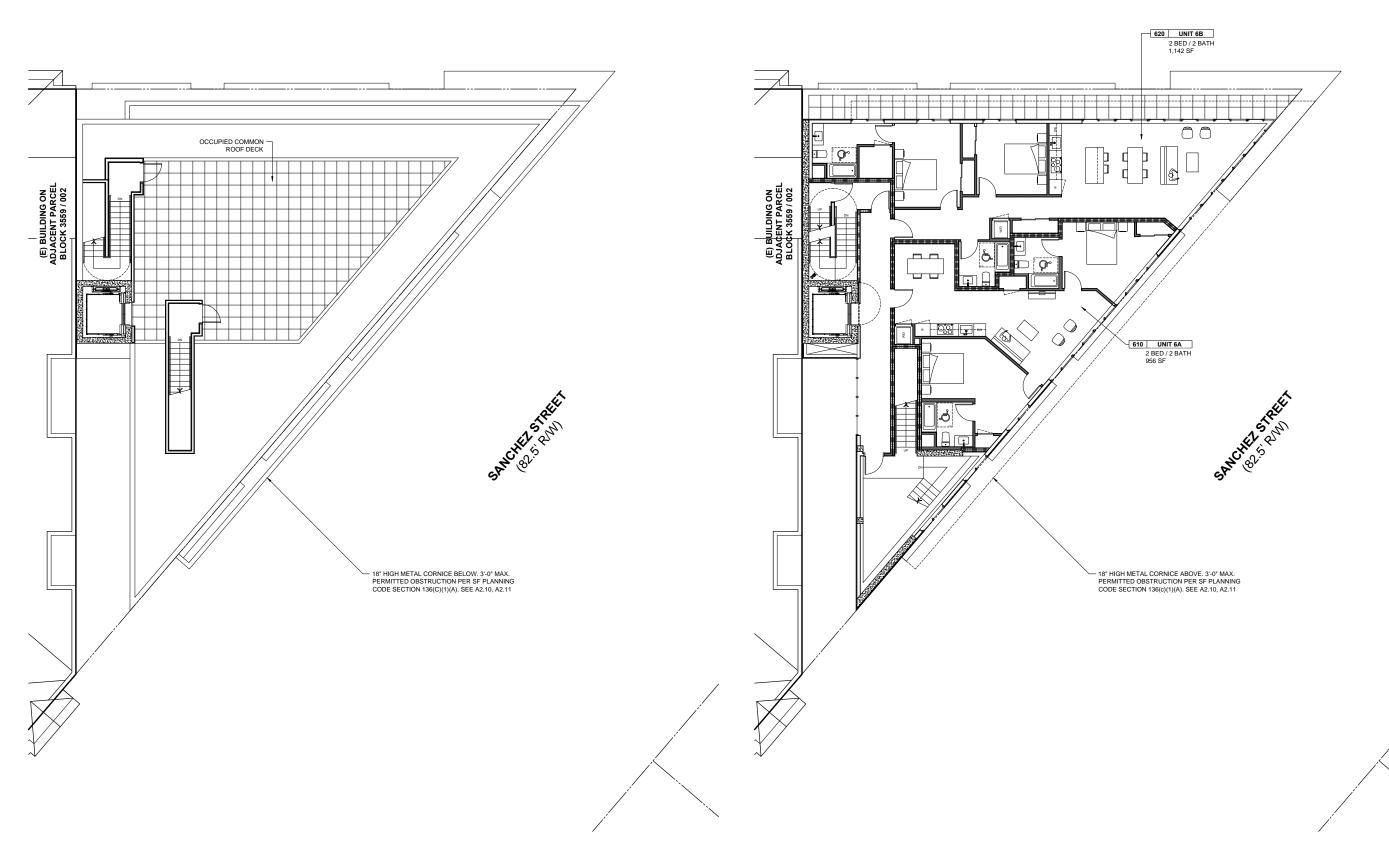

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PROJECT:


MARKET ST. MIXED-USE 2201 MARKET STREET SAN FRANCISCO, CA 94114

DRAWING:

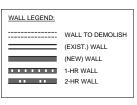FLOOR PLANS

SCALE:	1/8" = 1'-0"
DATE:	FEBRUARY 19, 2016
JOB NO.	2013.10
DRAWN:	
CAD FILE:	

A1.05

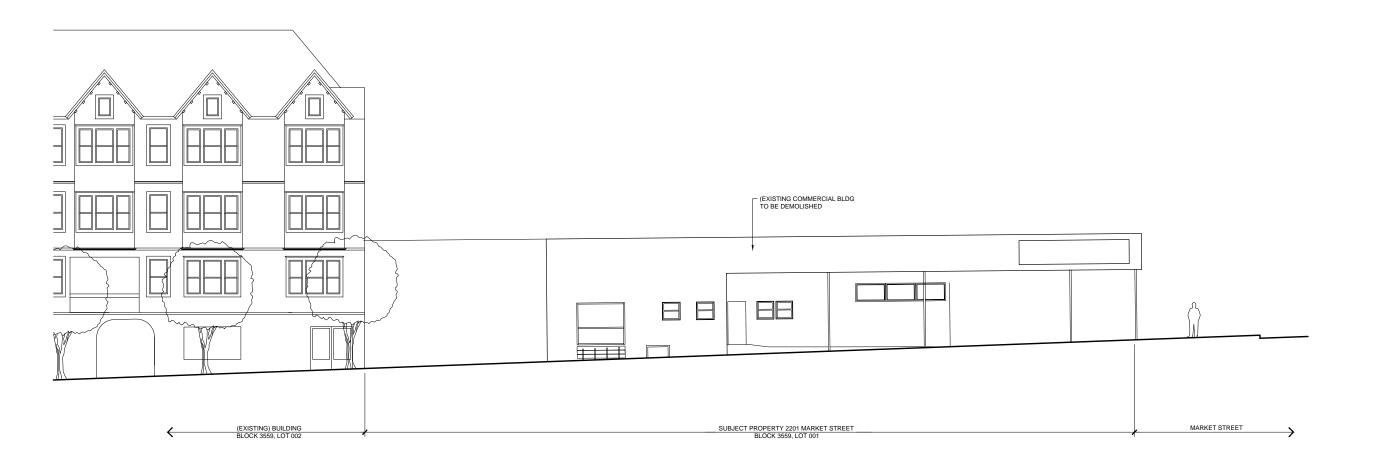

SOUTH EAST EXT. ELEVATION - SANCHEZ ST.

SCALE: 1/8" = 1'-0"

NO:	DATE:	SUBMISSION:
01	09.08.14	SITE PERMIT FILING
02	10.01.15	NOPDR #1
03	02.19.16	NOPDR #1 - REVISED

ISSUED FOR NOPDR #1

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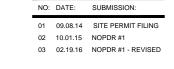
PROJECT:

MARKET ST. MIXED-USE 2201 MARKET STREET SAN FRANCISCO, CA 94114

DRAWING:

EXTERIOR ELEVATION (EXISTING)

SCALE:	1/8" = 1'-0"
DATE:	FEBRUARY 19, 2016
JOB NO.	2013.10
DRAWN:	
CAD FILE:	



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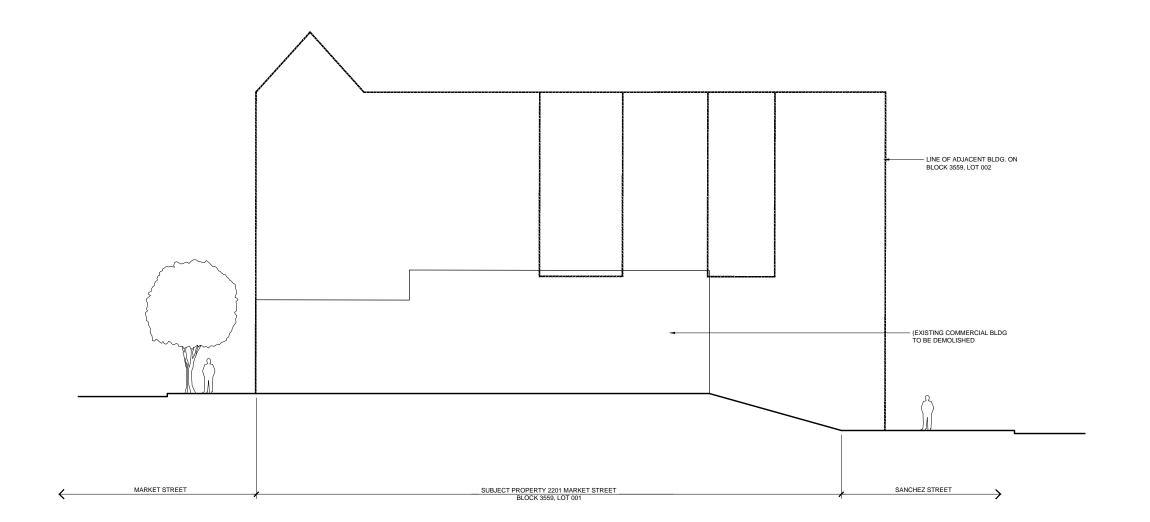
PROJECT:

MARKET ST. MIXED-USE 2201 MARKET STREET SAN FRANCISCO, CA 94114

DRAWING:

EXTERIOR ELEVATION (EXISTING)

SCALE:	1/8" = 1'-0"
DATE:	FEBRUARY 19, 2016
JOB NO.	2013.10
DRAWN:	
CAD FILE:	



NO: DATE: SUBMISSION:

01 09.08.14 SITE PERMIT FILING

02 10.01.15 NOPDR #1

03 02.19.16 NOPDR #1 - REVISED

ISSUED FOR NOPDR #1

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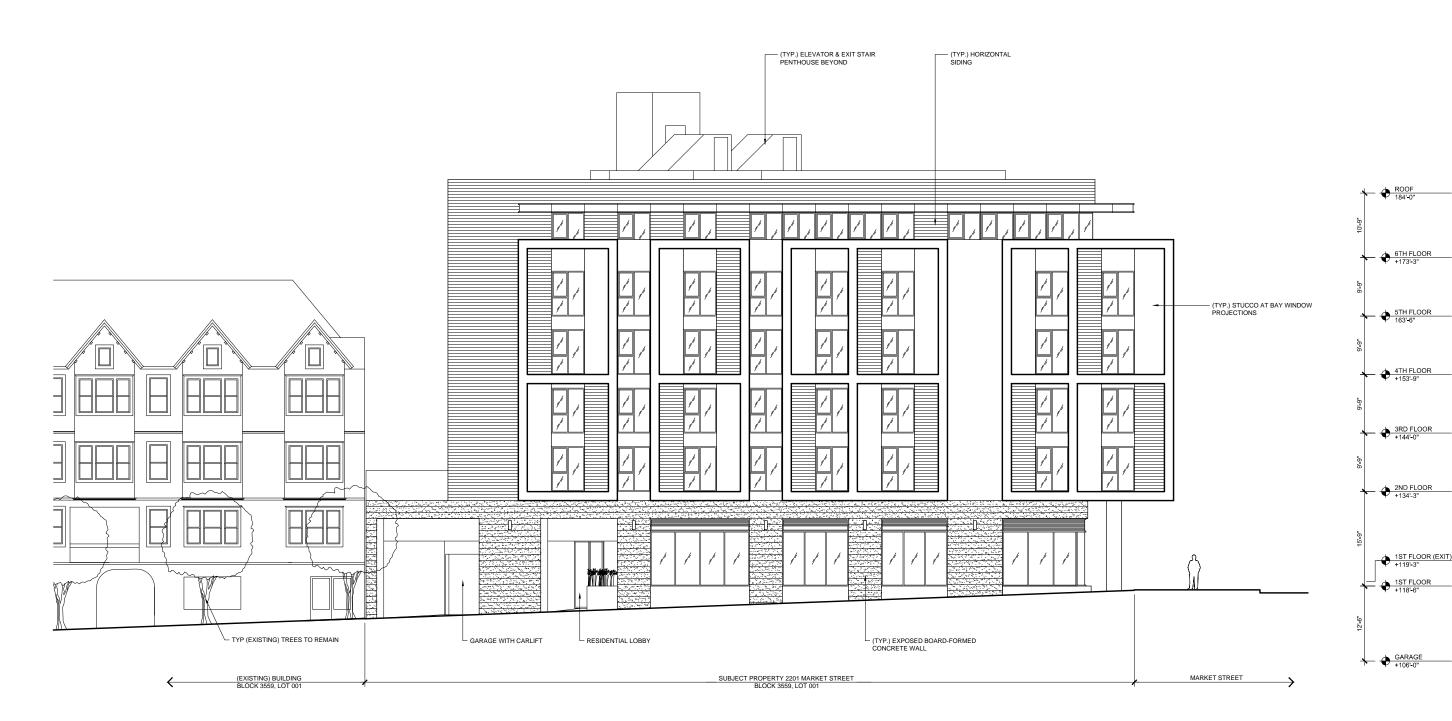
PROJECT:

MARKET ST. MIXED-USE 2201 MARKET STREET SAN FRANCISCO, CA 94114

DRAWING:


EXTERIOR ELEVATION (EXISTING)

SCALE:	1/8" = 1'-0"
DATE:	FEBRUARY 19, 2016
JOB NO.	2013.10
DRAWN:	
CAD FILE:	



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MARKET ST. MIXED-USE 2201 MARKET STREET SAN FRANCISCO, CA 94114

DRAWING:

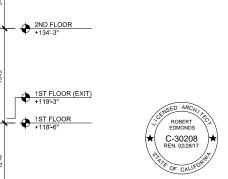EXTERIOR ELEVATION (NEW)

SCALE:	1/8" = 1'-0"
DATE:	FEBRUARY 19, 2016
JOB NO.	2013.10
DRAWN:	
CAD FILE:	



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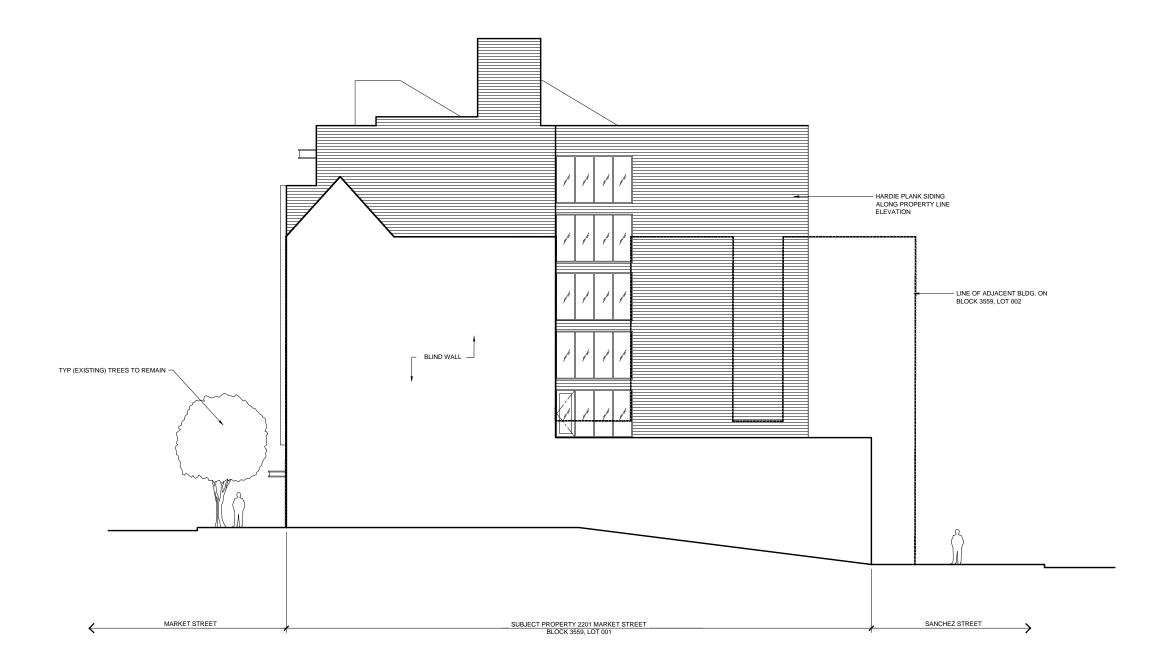
PROJEC

MARKET ST. MIXED-USE 2201 MARKET STREET SAN FRANCISCO, CA 94114

DRAWING:


EXTERIOR ELEVATION (NEW)


SCALE:	1/8" = 1'-0"
DATE:	FEBRUARY 19, 2016
JOB NO.	2013.10
DRAWN:	
CAD FILE:	



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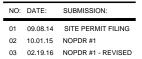


MARKET ST. MIXED-USE 2201 MARKET STREET SAN FRANCISCO, CA 94114

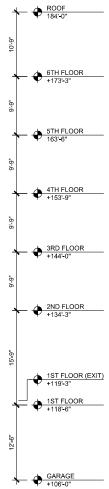DRAWING:

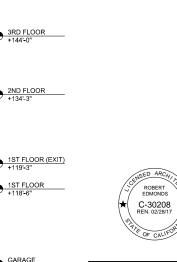
EXTERIOR ELEVATION (NEW)


SCALE:	1/8" = 1'-0"
DATE:	FEBRUARY 19, 2016
JOB NO.	2013.10
DRAWN:	
CAD FILE:	



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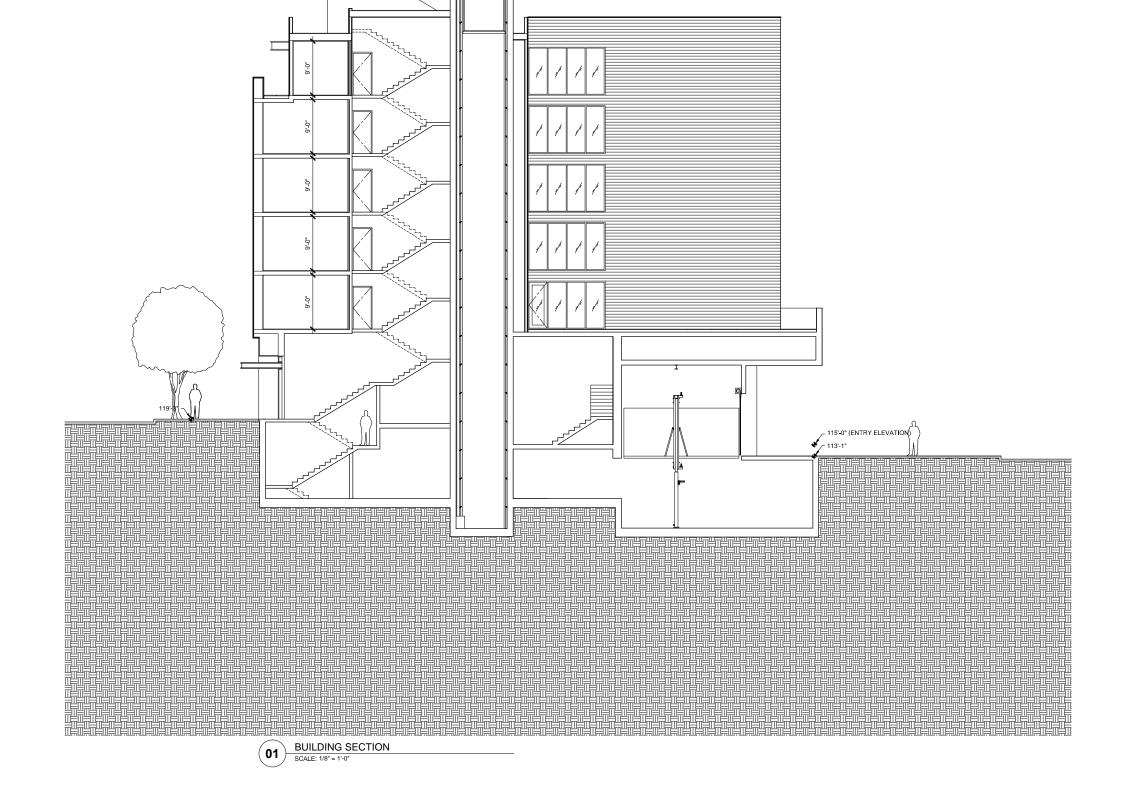
MARKET ST. MIXED-USE 2201 MARKET STREET SAN FRANCISCO, CA 94114


DRAWING:

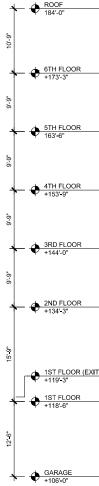BUILDING SECTION

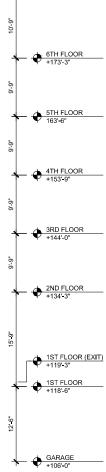SCALE:	1/8" = 1'-0"
DATE:	FEBRUARY 19, 2016
JOB NO.	2013.10
DRAWN:	
CAD FILE:	


A3.11



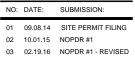

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MARKET ST. MIXED-USE 2201 MARKET STREET SAN FRANCISCO, CA 94114

DRAWING:

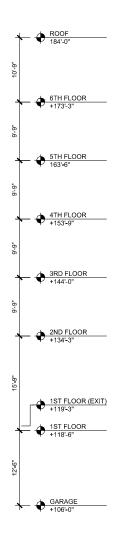BUILDING SECTION

SCALE:	1/8" = 1'-0"
DATE:	FEBRUARY 19, 2016
JOB NO.	2013.10
DRAWN:	
CAD FILE:	

A3.12

